# 344 W BROADWAY WHITEBOX - INTERIOR ALTERATION 344 W BROADWAY | WAUKESHA, WI 53186

	SHEET INDEX		
SHEET	DESCRIPTION		
T1.0	TITLE SHEET		
	ARCHITECTURAL		
SP1.0	SITE PLAN AND SITE DETAILS		
D1.0	DEMOLITION PLAN		
A1.0	FLOOR PLAN		
A2.0	EXTERIOR ELEVATIONS		
A9.0	CONCEPTUAL RENDERINGS		
	STRUCTURAL		
	FORTHCOMING		
PLLIME	ING, MECHANICAL AND ELECTRICAL PLANS TO BE A DEFERRED		
	REVIEW AND SUBMITTAL BY DESIGN-BUILD CONTRACTOR		

#### PROJECT NOTES

**ELECTRICAL NOTES:** 

1) ALL WORK TO BE BY DESIGN-BUILD ELECTRICAL CONTRACTOR.

1) ALL WORK TO BE BY DESIGN-BUILD HVAC CONTRACTOR.


1) ALL WORK TO BE BY DESIGN-BUILD PLUMBING CONTRACTOR.


BUILDING CODE SUMMARY				
BASED ON THE	WISCONSIN COMMERCIAL BUILDING CODE (2015 INTERNATIONAL BUILDING CODE w/ WI AMENDMENTS)			
	2015 INTERNATIONAL EXISTING BUILDING CODE			
	2009 ANSI A117.1 ACCESSIBILITY CODE			
	ALL OTHER CODES AND ORDINANCES AS REFERENCED BY THE ABOVE CODES			
AREA OF ALTERATION	TOTAL AREA OF ALTERATION: 1,358 SF			
FIRE ALARM:	EXISTING CONDITION TO REMAIN			
OCCUPANCY	B - BUSINESS (NO CHANGE IN USE)			
OCCUPANCY SEPARATION	NOT REQUIRED			
CONSTRUCTION TYPE	III B			
SPRINKLER SYSTEM	NOT SPRINKLERED			
NUMBER OF FLOOR LEVELS	1 STORY			
ALTERATION LEVEL	LEVEL 2			
FLAME SPREAD & SMOKE INDEX	CLASS C (ROOMS AND ENCLOSED SPACES) PER TABLE 803.11			
CODE EXCEPTION	BOTTLED WATER PROVIDED IN LIEU OF DRINKING FOUNTAIN			

#### GENERAL NOTES

- CONSTRUCTION IS TO BE IN COMPLIANCE WITH ALL GOVERNING CODES, ORDINANCES & STANDARDS. THE CONTRACTOR(S) SHALL BE RESPONSIBLE FOR INITIATING, MAINTAINING, & SUPERVISING ALL SAFETY PRECAUTIONS & PROGRAMS IN CONNECTION WITH THE PERFORMANCE OF THIS PROJECT.
- ARCHITECT/DESIGNER SHALL NOT BE RESPONSIBLE FOR ANY COST, SCHEDULE OR CONSTRUCTION ISSUES ARISING DUE GC/OWNERS FAILURE TO DISTRIBUTE ALL DOCS. SUBCONTRACTORS & SUPPLIERS SHOULD ENDEAVOR TO REVIEW A COMPLETE SET OF DOCS BEFORE BIDDING, FABRICATING & INSTALL.
- GC, SUBCONTRACTORS, MATERIAL SUPPLIERS, OWNER, ETC. MUST NOTIFY ARCHITECT OF ANY ERRORS, OMISSIONS, OF DEFECTS IN THE CONSTRUCTION DOCUMENTS PRIOR TO BIDDING, FABRICATING OR INSTALLING WORK. SITE DIMENSIONS ARE TO BE FIELD VERIFIED AND ADJUSTED ACCORDINGLY. THE ARCHITECT/DESIGNER SHALL BE NOTIFIED OF ANY VARIANCES BEFORE CONTRACTOR BEGINS OR PROCEEDS WORK.
- MECH, ELEC, PLUMB & FIRE PROTECTION ARE TO BE DESIGN BUILT, COMPLYING WITH ALL GOVERNING CODES ORDINANCES & STANDARDS, WHICH WILL BE THE FULL RESPONSIBILITY OF THE CONTRACTOR; THE ARCHITECT
- ALL MECH, ELEC, PLUMB & FIRE PROTECTION SYSTEMS/EQUIP. SHALL BE MAINTAINED ACCORDING TO MANUFACTURER'S STANDARDS. BLDG. OWNER SHALL ASSUME FULL RESPONSIBILITY FOR MAINTANANCE/OPPERATION
- THE INSTALLATION AND EXECUTION OF ALL MATERIALS SHALL BE IN ACCORDANCE WITH THE MANUFACTURER'S STANDARDS AND SPECIFICATIONS. ALL MEANS & METHODS OF CONSTRUCTION TO BE THE SOLE RESPONSIBILITY OF
- PORTABLE FIRE EXTINGUISHERS SHALL BE PROVIDED IN OCCUPANCIES AND LOCATIONS AS REQUIRED BY THE INTERNATIONAL FIRE CODE. INSTALLATION LOCATIONS SHALL HAVE A MAXIMUM TRAVEL DISTANCE OF 75' TO ANY EXTINGUISHER. EXTINGUISHERS SHALL BE LOCATED IN CONSPICUOUS LOCATIONS WERE THEY WILL BE READILY ACCESSIBLE AND IMMEDIATELY AVAILABLE FOR USE, TYPICALLY ALONG PATHS OF TRAVEL. EXTINGUISHERS SHALL NOT BE OBSTRUCTED FROM VIEW, IF VISUAL OBSTRUCTION CAN NOT BE AVOIDED ANOTHER MEANS SHALL BE PROVIDED TO INDICATE THE EXTINGUISHER LOCATIONS. EXTINGUISHERS NOT EXCEEDING 40" SHALL BE INSTALLED SO THAT ITS TOP IS NOT MORE THAT 5'-0" ABOVE THE FLOOR, EXTINGUISHERS EXCEEDING 40" SHALL BE INSTALLED SO THAT ITS TOP IS NOT MORE THAN 3'-6" ABOVE THE FLOOR. THE CLEARANCE BETWEEN THE FLOOR AND BOTTOM OF HAND HELD UNITS SHALL NOT BE LESS THAN 4". VERIFY EXTINGUISHER LOCATIONS W/ LOCAL FIRE DEPT. & OWNER
- ALL CONCRETE FLAT WORK MUST BE WET CURED PER ACI REQUIREMENTS AND/OR CURED USING A CURING COMPOUND. REFER TO STRUCTURAL NOTES FOR CURING COMPOUND SPECS. CONTRACTOR IS RESPONSIBLE FOR APPLYING CURING COMPOUNDS PER THE MANUFACTURER'S REQUIREMENTS.

TYPICAL ABBREVIATIONS							
ABV: Above	B/O: By Others	DW: Dishwasher	FTG: Footing	LB: Pound	NO, #: Number	REFR: Ref	TEMP: Tempered
ACOUS: Acoustical	BO: Bottom Of	DIV: Division	FND: Foundation	LAM: Laminate(d)		REG: Register	TK: Tight Knot
ADDL: Additional	BR: Bedroom	DR: Door	FRM: Fram(d), (ing)	LAV: Lavatory	O: Non-Operable Window	RE: Reinforced	T&G: Tongue and Groove
ADH: Adhesive		DH: Double Hung	FBO: Furnished by Others	LH: Left Hand	Section	REQ'D: Required	T/O: Top of
ADJ: Adjustable	CAB: Cabinet	DS: Downspout	FUR: Furred	L: Length	OBS: Obscure	RA: Return Air	TOC: Top of Concrete
FF: Above Finish Floor	CALC: Calculation	DRWR: Drawer		LOA: Length Overall	OC: On Center	REV: Revision	TOW: Top of Wall
AGG: Aggregate	CD: Cabinet Door	DT: Drain Tile	GA: Gage, Gauge	LT: Light	OP: Opaque	R: Riser	TB: Towel Bar
HJ: Authority Having	CG: Corner Guard	DWG: Drawing	GAL: Gallon	LF: Lineal Feet	OPG: Opening	RD: Rod	T: Tread
urisdiction	CIP: Cast-In-Place	D: Nail Size	GL: Glass, Glazing	LL: Live Load	OSB: Orientated Strand Board	R&S: Rod and Shelf	TS: Tubular Steel
VC: Air Conditioning	(Concrete)		GI: Galvanized Iron	LVL: Laminated Veneer	OD: Outside Diameter	RFG: Roofing	TYP: Typical
ALT: Alternate	CL: Cénterline	EW: Each Way	GLBK: Glass Block	Lumber		RM: Room	••
ALUM: Aluminum	CO: Clean Out	E: East	GLB: Glue Laminated Beam	LVR: Louver	PMT: Paint(ed)	RO: Rough Opening	UL: Underwriters Laboratory
ANC: Anchor, Anchorage	CONTR: Contract (or)	EL: Elevation	GT: Grout		PBD: Particle Board		UNF: Unfinished
AB: Anchor Bolt	COORD: Coordinate	ELEV: Elevation	GRD: Grade, Grading	MFR: Manufacturer	PRT: partition	SCH: Schedule	UNO: Unless Noted Otherwis
ANOD: Anodized	CRPT: Carpet	EQ: Equal	GWB: Gypsum Wall Board	MO: Masonry Opening	PVMT: Pavement	SCN: Screen	
APX: Approximate	CIP: cast-in-place	EQP: Equipment	• •	MAX: Maximum	PERF: Perforate(d)	SECT: Section	VB: Vapor Barrier
APT: Apartment	CLK: Caulking	EXCV: Excavate	HWD: Hardware	MAS: Masonry	PLAS: Plaster	SGD: Sliding Glass Door	VAR: Varnish
ARCH: Architect	CAS: Casement	EXH: Exhaust	HDR: Header	MECH: Mechanic(al)	PLAM: Plastic Laminate	SHTH: Sheathing	VIF: Verify In Field
architectural)	CB: Catch Basin	EXIST: Existing	HTG: Heating	MC: Medicine Cabinet	PLT: Plate	SHT: Sheet	VRN: Veneer
ASPH: Asphalt	CLG: Ceiling	EXT: Exterior	HVAC: Heating,	MED: Medium	PLYWD: Plywood	SH: Shelf, Shelving	VERT: Vertical
AUTO: Automatic	CT: Ceramic Tile		Ventilation—Air Conditioning	MDF: Medium Density	PCC: Precast Concrete	SIM: Similar	VG: Vertical Grain
AVE: Avenue	CIR: Circle	FOC: Face of Concrete	HT: Height	Fiberboard	PCF: Pounds Per Cubic Foot	SKL: Skylight	VIN: Vinyl Sheet
AVR: Average	CLR: Clear	FOF: Face of Finish	HC: Hollow Core	MDO: Medium Density Overlay	PLF: Pounds Per Linear Foot	S: South	,
AWN: Awning	COL: Column	FOM: Face of Masonry	HOR: Horizontal	MBR: Member	PSF: Pounds Per Square	SLB: Slab	WL: Wall
<b>g</b>	CONC: Concrete	FOS: Face of Studs	HB: Hose Bib	MMB: Membrane	Foot	SLD: Slider(ing)	WC: Water Closet
SSMT: Basement	CMU: Concrete Masonry	FOW: Face of Wall		MTI: Metal	PSI: Pounds Per Square Inch	SPEC: Specification	WH: Water Heater
BM: Beam	Unit	FBD: Fiberboard	IN: Inch	MWK: Millwork	PBF: Prefabricated	SQ: Square	WP: Water Proofing
VL: Beveled	CONST: CONSTruction	FCB: Fiber Cement Board	INCL: Include	MIN: Minimum	PRF: Preformed	STD: Standard	WR: Weather Resistant
BITUM: Bituminous	CONT: Continuous	FGL: Fiberglass	ID: Inside Diameter	MIR: Mirror	PT: Pressure Treated	STV: Stove	WRB: Weather Resistive
LK: Block	CJT: Control Joint	FIN: Finish	INS: Insulate	MISC: Miscellaneous	PL: Property Line	STL: Steel	Barrier
BLKG: Blocking	CORR: Corrugated	FFE: Finished Floor Elevation	INT: Interior	MOD: Module	PH: Toilet Paper Hanger	STR: Structural	WWF: Welded Wire Fabric
BLW: Below	CUFT: Cubic Foot	FA: Fire Alarm	INV: Invert	MLD: Moulding	The foliot rapor flatigor	SA: Supply Air	WWM: Welded Wire Mesh
BLDV: Boulevard	CUYD: Cubic Yord	FE: Fire Extinguisher		MLB: Micro Laminate Beam	QTY: Quantity	SC: Solid Core	W: West
BTW: Between	COID. Cubic laid	FPL: Fireplace	JNT: Joint		QT: Quarry Tile	SW: Shear Wall	WIN: Window
BD: Board	DP: Dampproofing	FLSH: Flashing	JST: Joist	NOM: Nominal	with equality file	SS: Stainless Steel	W/O: Without
BOT: Bottom	DTL: Detail	FLR: Floor		N: North	RAD: Radius	SYS: System	W/: With
BLDG: Building	DIA: Detail	FLOR: Fluorescent	KD: Kiln Dried	NIC: Not in Contract	REF: Reference	- · - / <del>- / - · · ·</del>	WD: Wood
BUR: Built Up Roofing	DIA: Didmeter DIM: Dimension	FT: Foot, Feet	KIT: Kitchen	NTS: Not To Scale		TEL: Telephone	WOOd
on. Built op Rooming	DIM: DIFFICUSION		(111011011	1415. 1400 TO Scale	RFL: Reflect(ed),(ive),(or)	:: 10.0p.10110	X: Operable Window Section

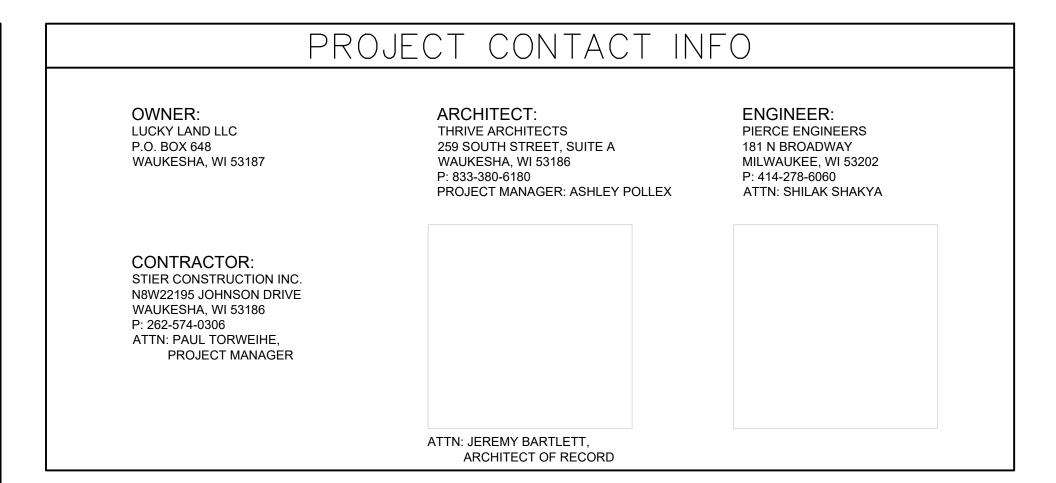

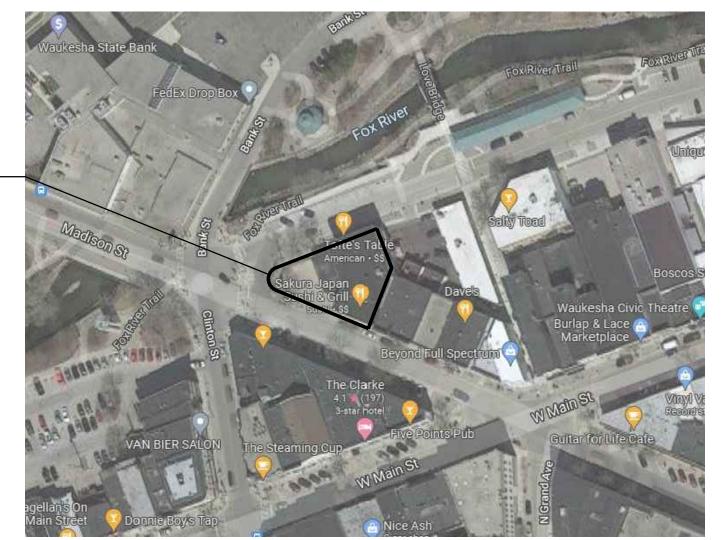

SCALE: N.T.S.



259 South Street, Suite A Waukesha, WI 53186 p: 833-380-6180

STIER CONSTRUCTION INC.

Contractor

N8 W22195 Johnson Drive Waukesha, WI 53186 p: 262-574-0306 e: ptorweihe@stierconstruct.com

■Project Info. — 23123 -

344 W Broadway Whitebox

INTERIOR ALTERATION


344 W Broadway Waukesha, WI 53186

**—**Sheet Title **—** 

Drawn by	Checked by
AMP	JDB

No. Date Description  10.12.23 PC Submittal		<b>_</b> Re	visions ——	
				Description
NSTRUCTION			10.12.23	PC Submittal
NSTRUCTIO	Z			
NSTRUCI	9			
NSTRU	CI			
LSZ SZ	RU			
Z	IST			

-Sheet No. 🗕

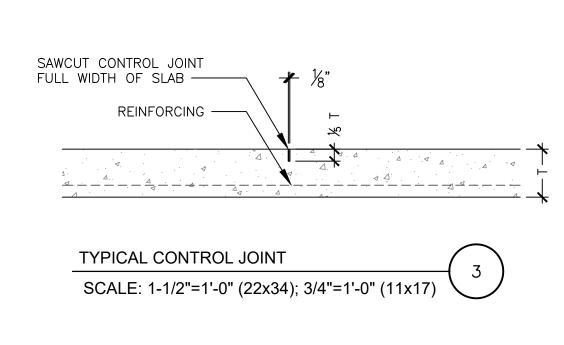


PROVIDE MIN. 1"
CLEARANCE BELOW
REINF. BARS

COMPACTED BASE
COURSE

5" THK. CONCRETE
PAD W/#4 REINF. BAR
@16" O.C. EA. WAY

POURED CONCRETE PATIO

SCALE: 1-1/2"=1'-0" (22x34); 3/4"=1'-0" (11x17)

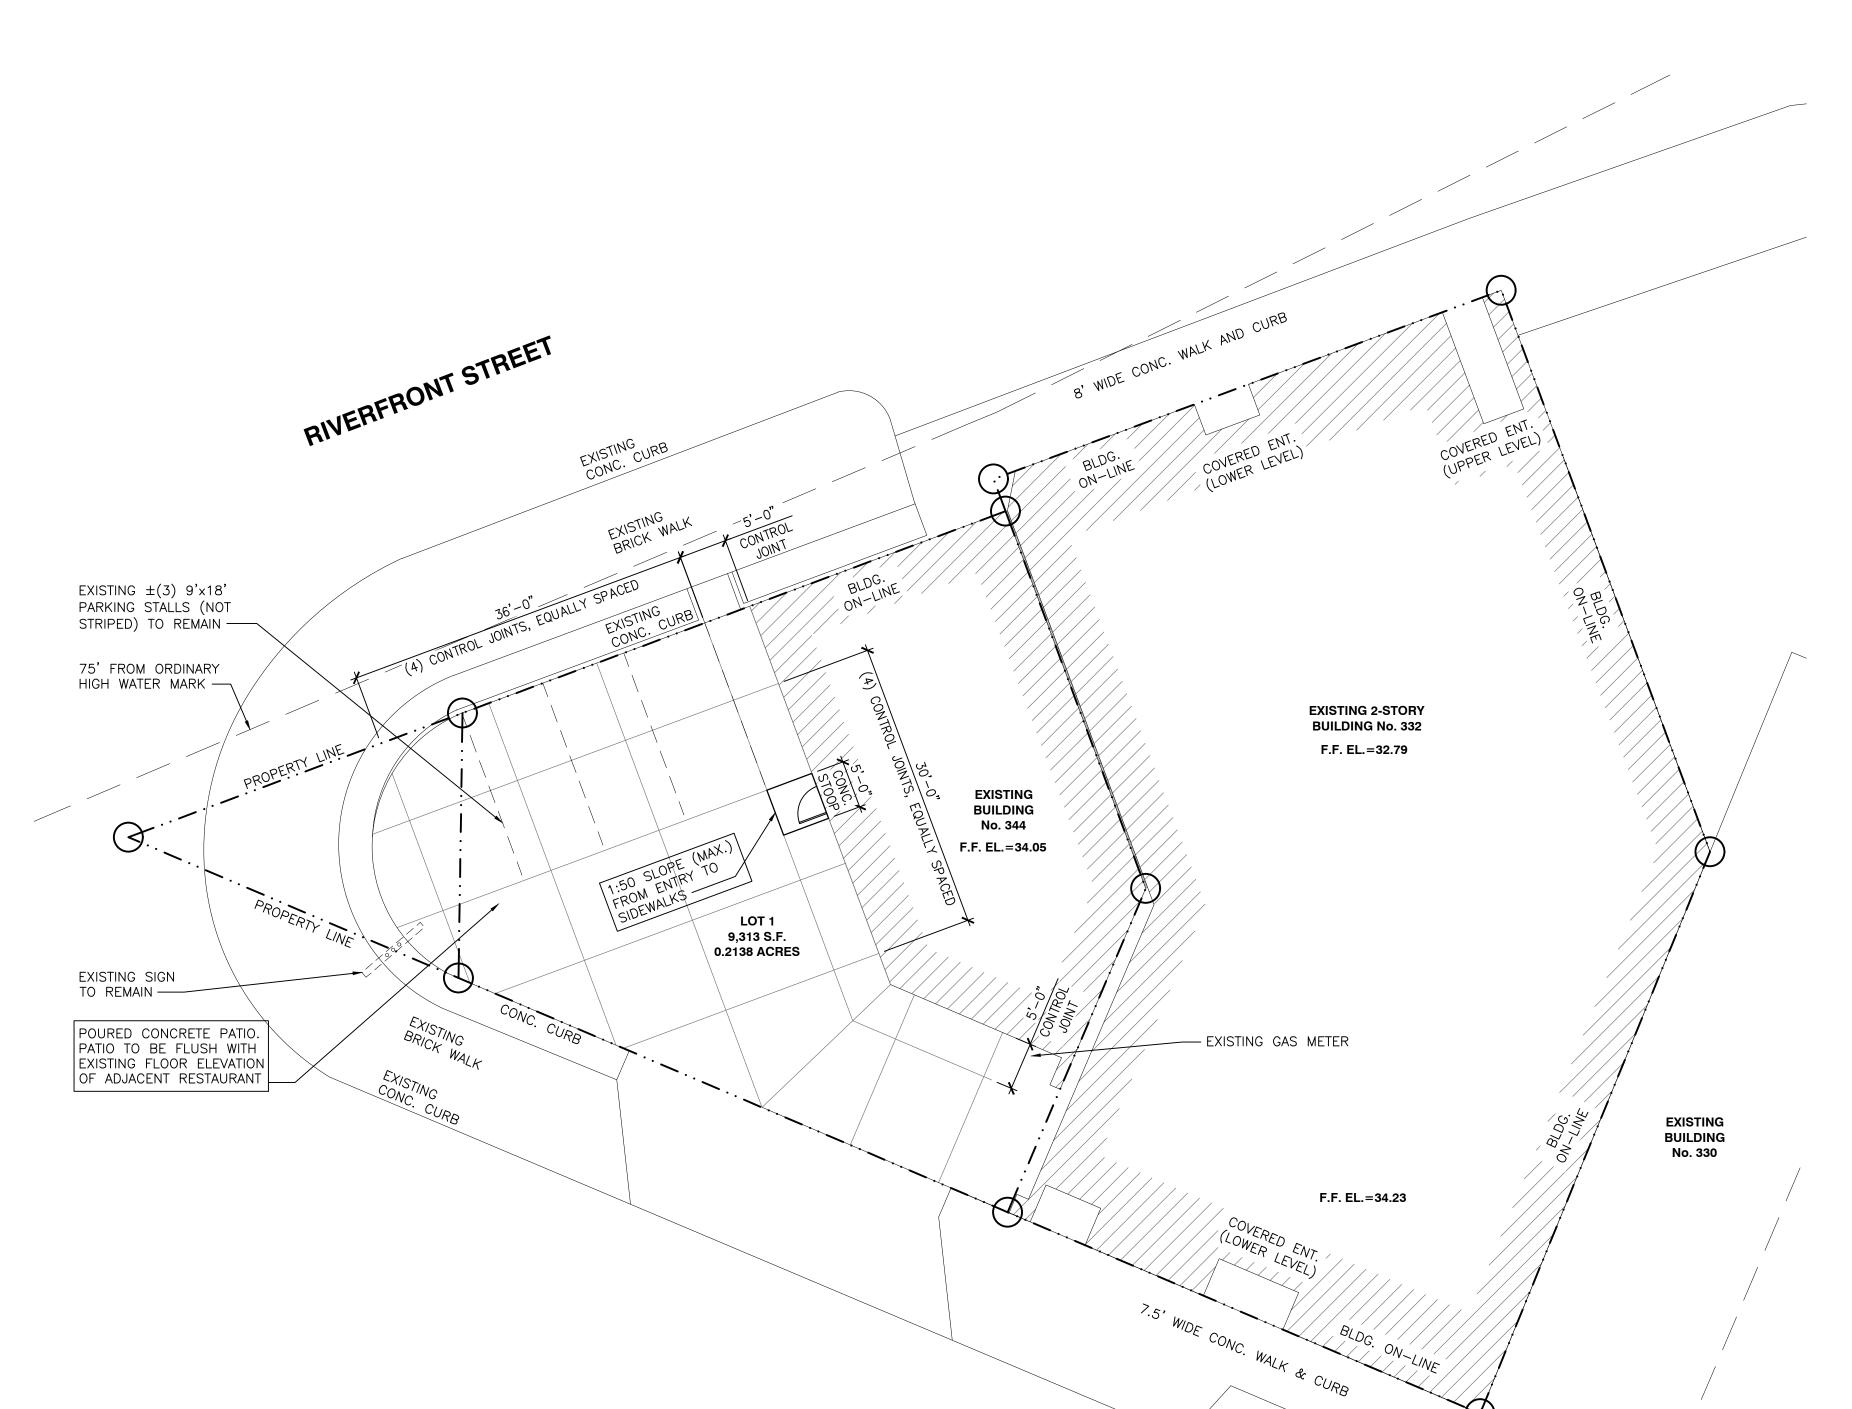

SITE PLAN

SCALE: 1"=10'-0" (22x34); 1"=20'-0" (11x17)

WEST BROADWAY



Architect

259 South Street, Suite A Waukesha, WI 53186 p: 833-380-6180



Contractor

N8 W22195 Johnson Drive Waukesha, WI 53186 p: 262-574-0306 e: ptorweihe@stierconstruct.com

hoProject Info. — 23123 —

### 344 W Broadway Whitebox

INTERIOR ALTERATION

344 W Broadway Waukesha, WI 53186

—Sheet Title

# SITE PLAN ANI SITE DETAILS


Drawn by	Checked by
AMP	JDB

No. Date Description

10.12.23 PC Submittal

Sheet No.

SP1.0

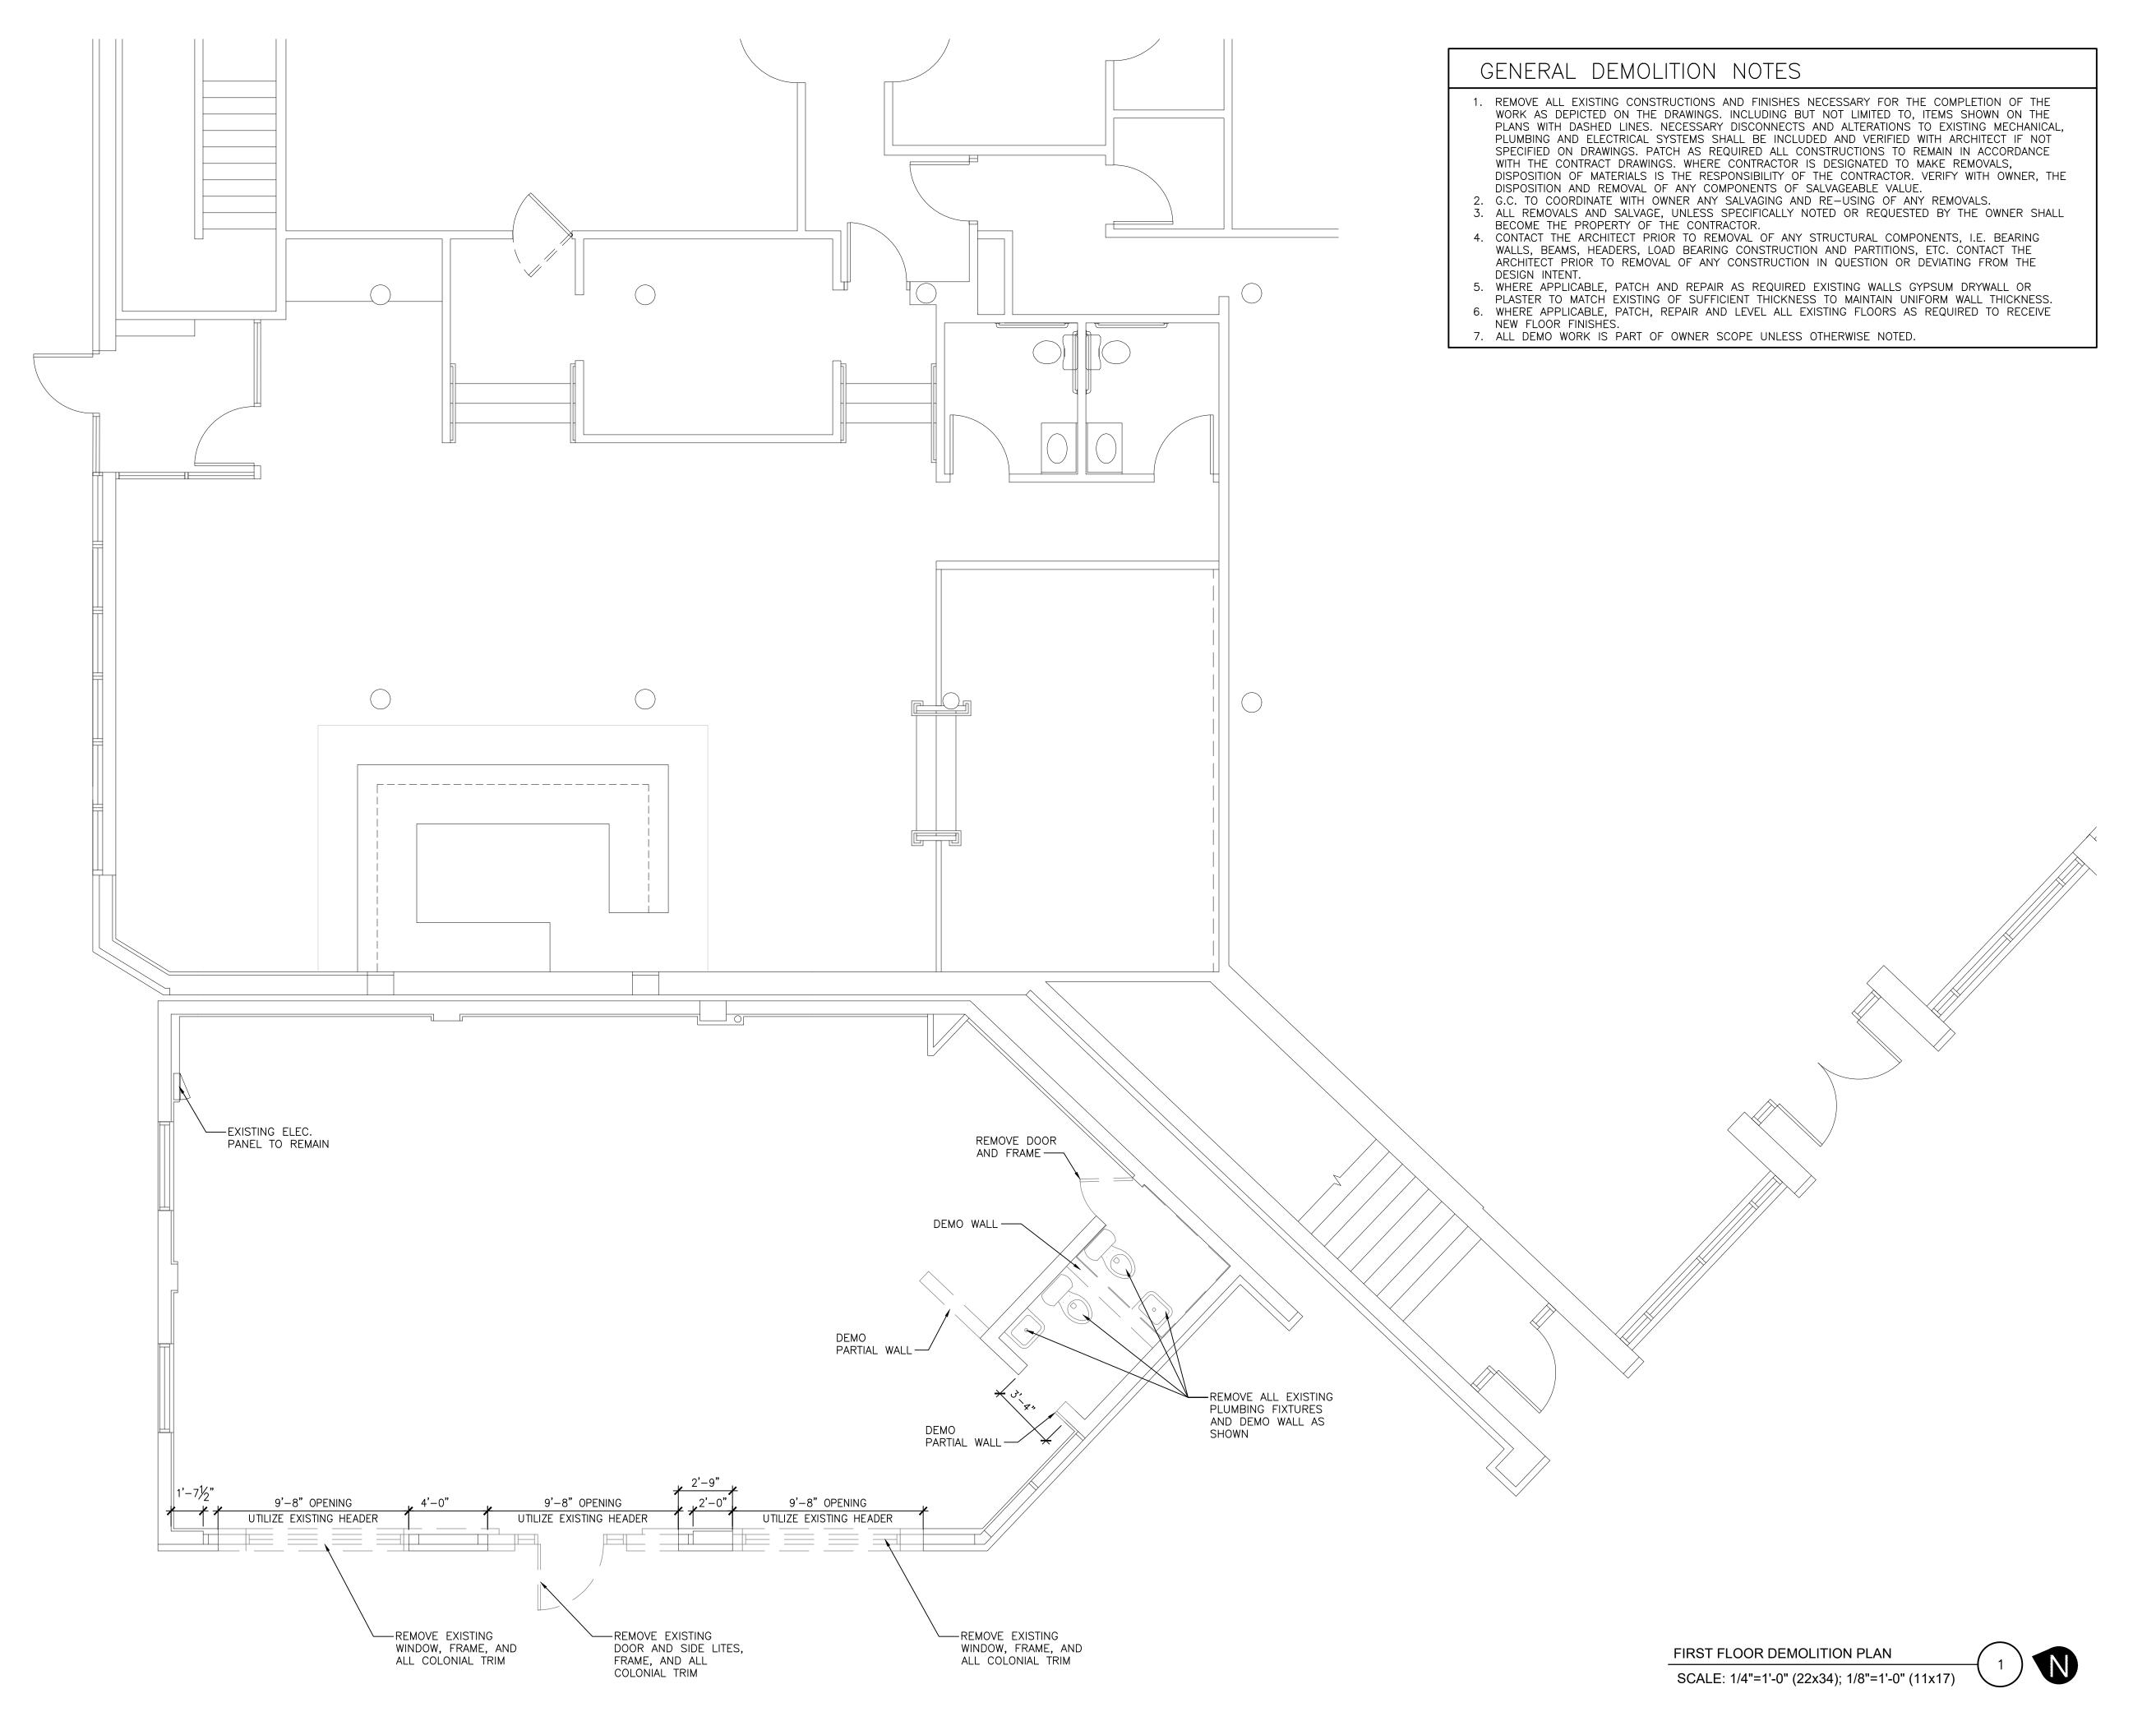

THR VE ARCH TECTS

Architect

259 South Street, Suite A Waukesha, WI 53186 p: 833-380-6180



Contractor

N8 W22195 Johnson Drive Waukesha, WI 53186 p: 262-574-0306 e: ptorweihe@stierconstruct.com

hoProject Info. — 23123 —

#### 344 W Broadway Whitebox

INTERIOR ALTERATION

344 W Broadway Waukesha, WI 53186

**—**Sheet Title —

EMOLITION


Drawn by	Checked by
AMP	JDB

No. Date Description

10.12.23 PC Submittal

**\_**Sheet No. -

D1.0

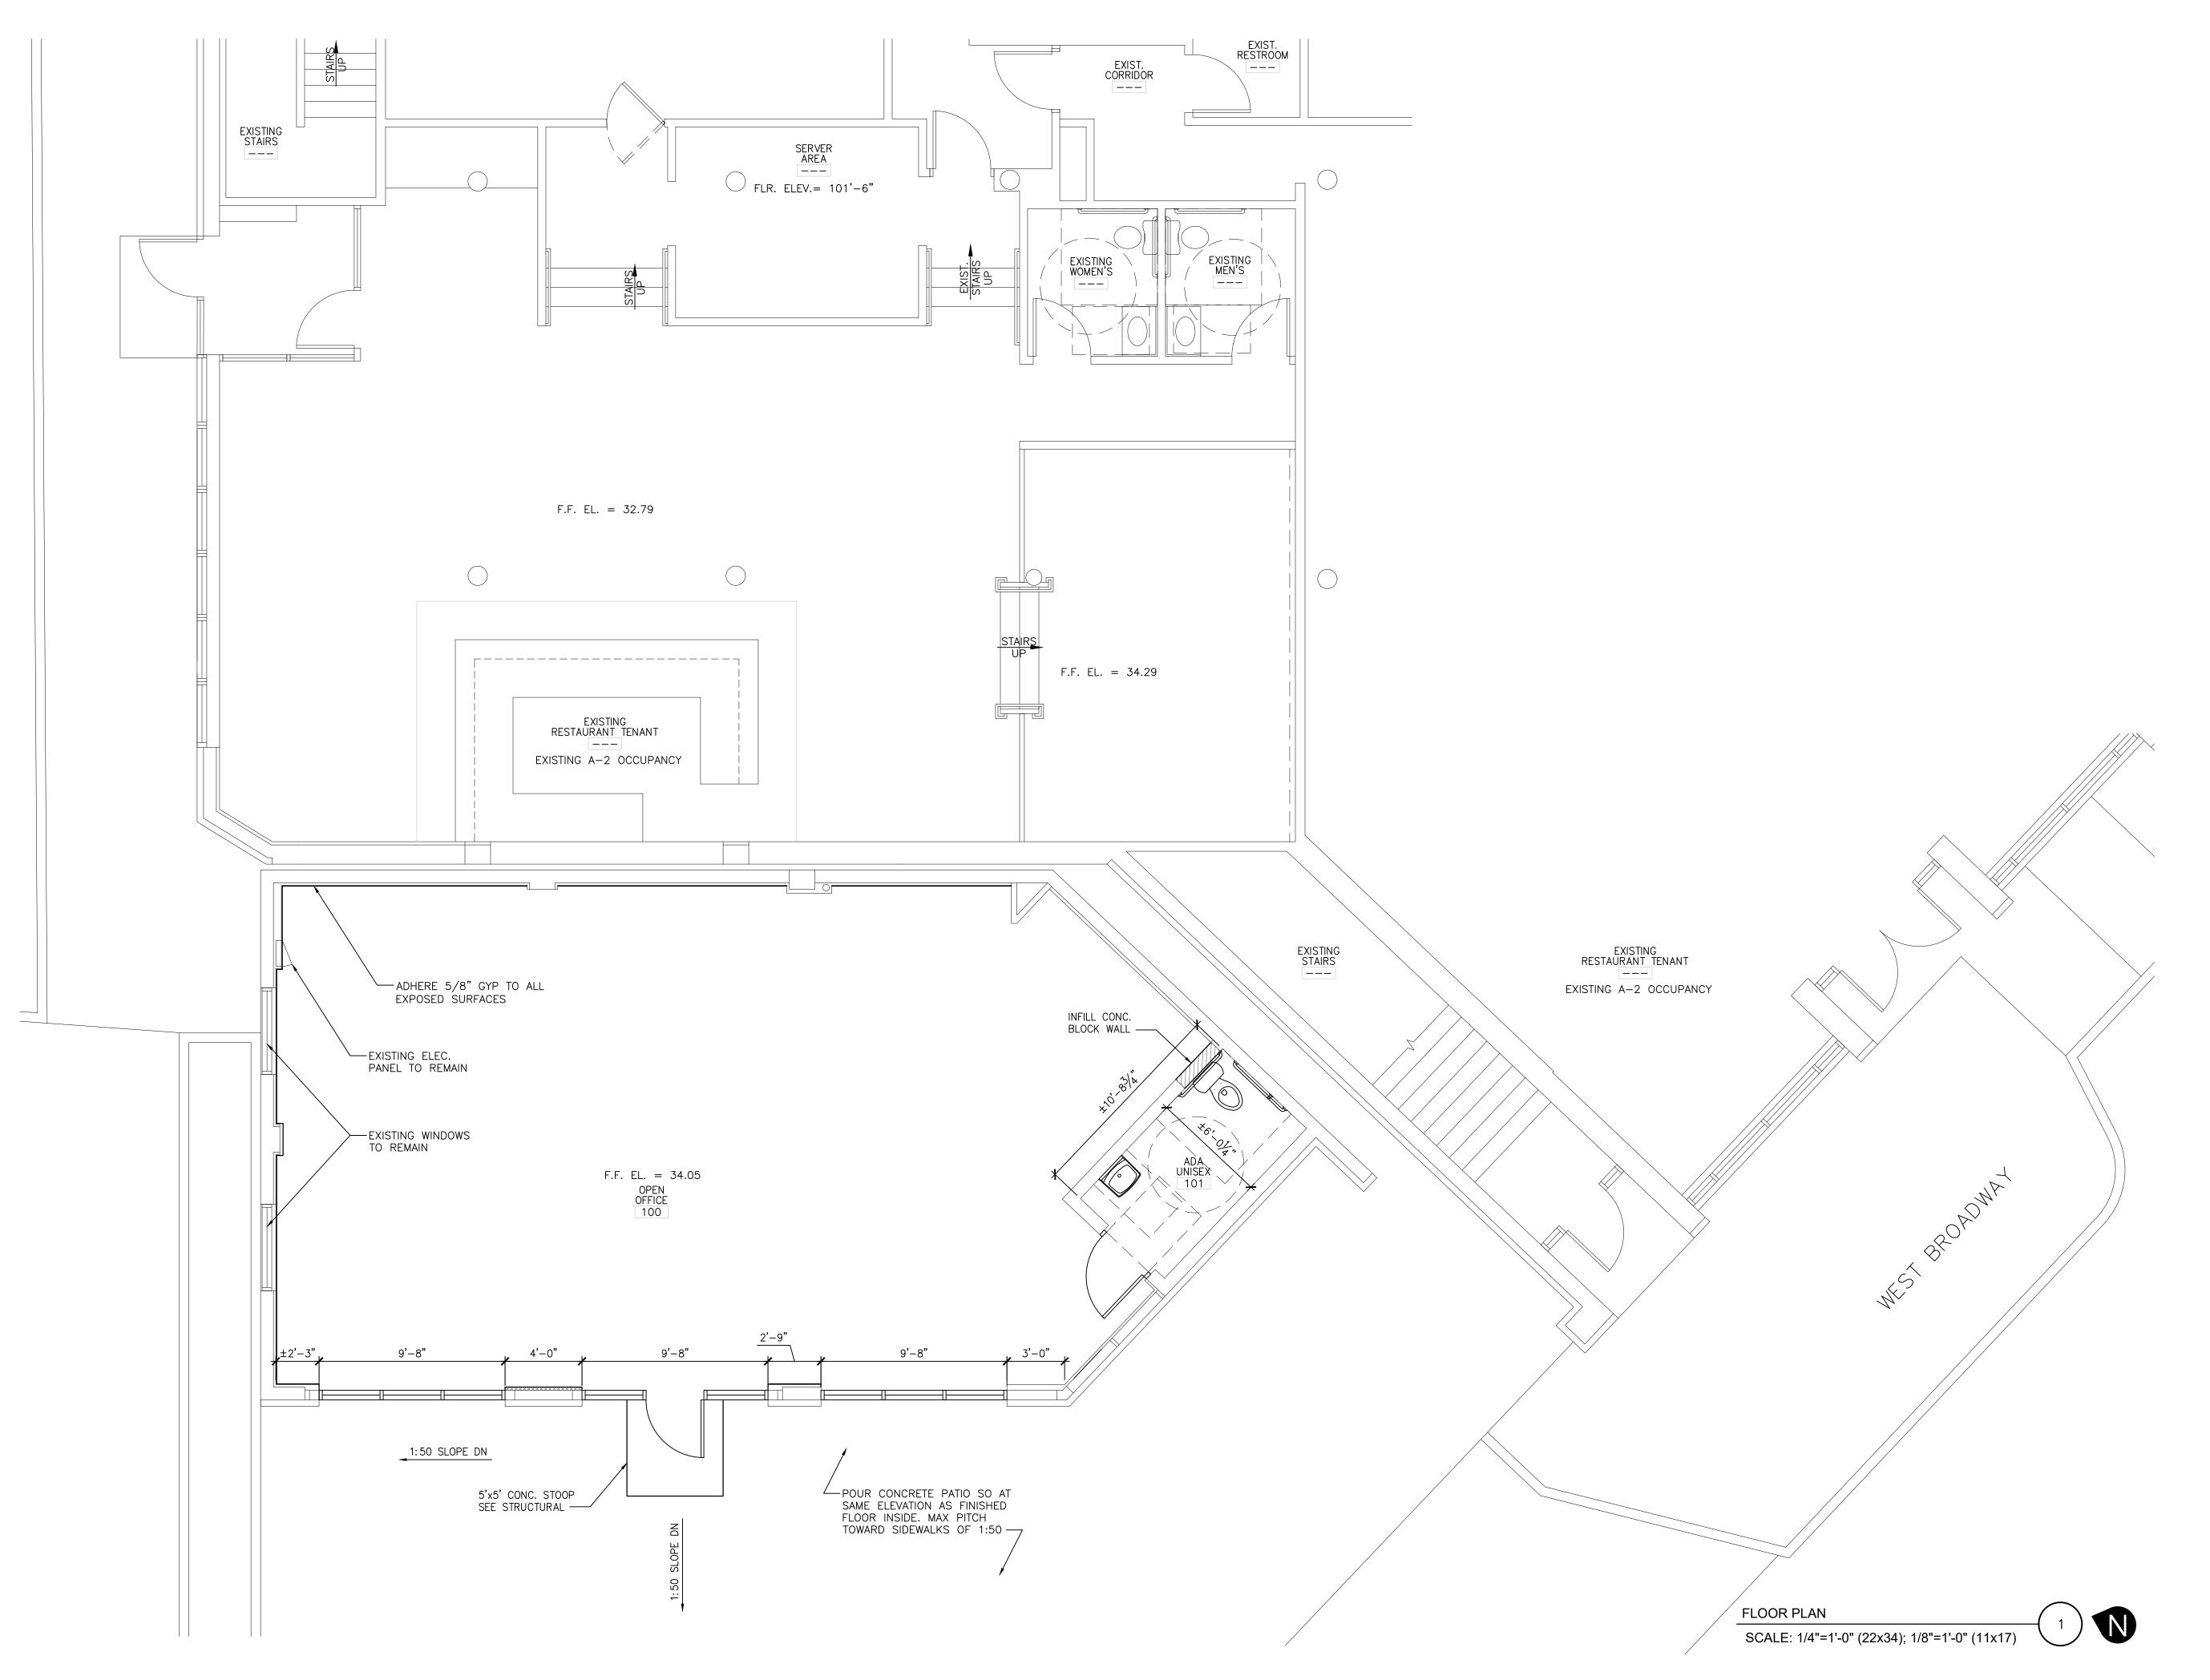



Architect

259 South Street, Suite A Waukesha, WI 53186 p: 833-380-6180



- Contractor

N8 W22195 Johnson Drive Waukesha, WI 53186 p: 262-574-0306 e: ptorweihe@stierconstruct.com

 $\blacksquare$  Project Info. — 23123 —

### 344 W Broadway Whitebox

INTERIOR ALTERATION

344 W Broadway Waukesha, WI 53186

**—**Sheet Title —

FLOOR PLAN


_		
	Drawn by	Checked by
	AMP	JDB


No. Date Description

10.12.23 PC Submittal

**\_**Sheet No. **\_** 


A1.0

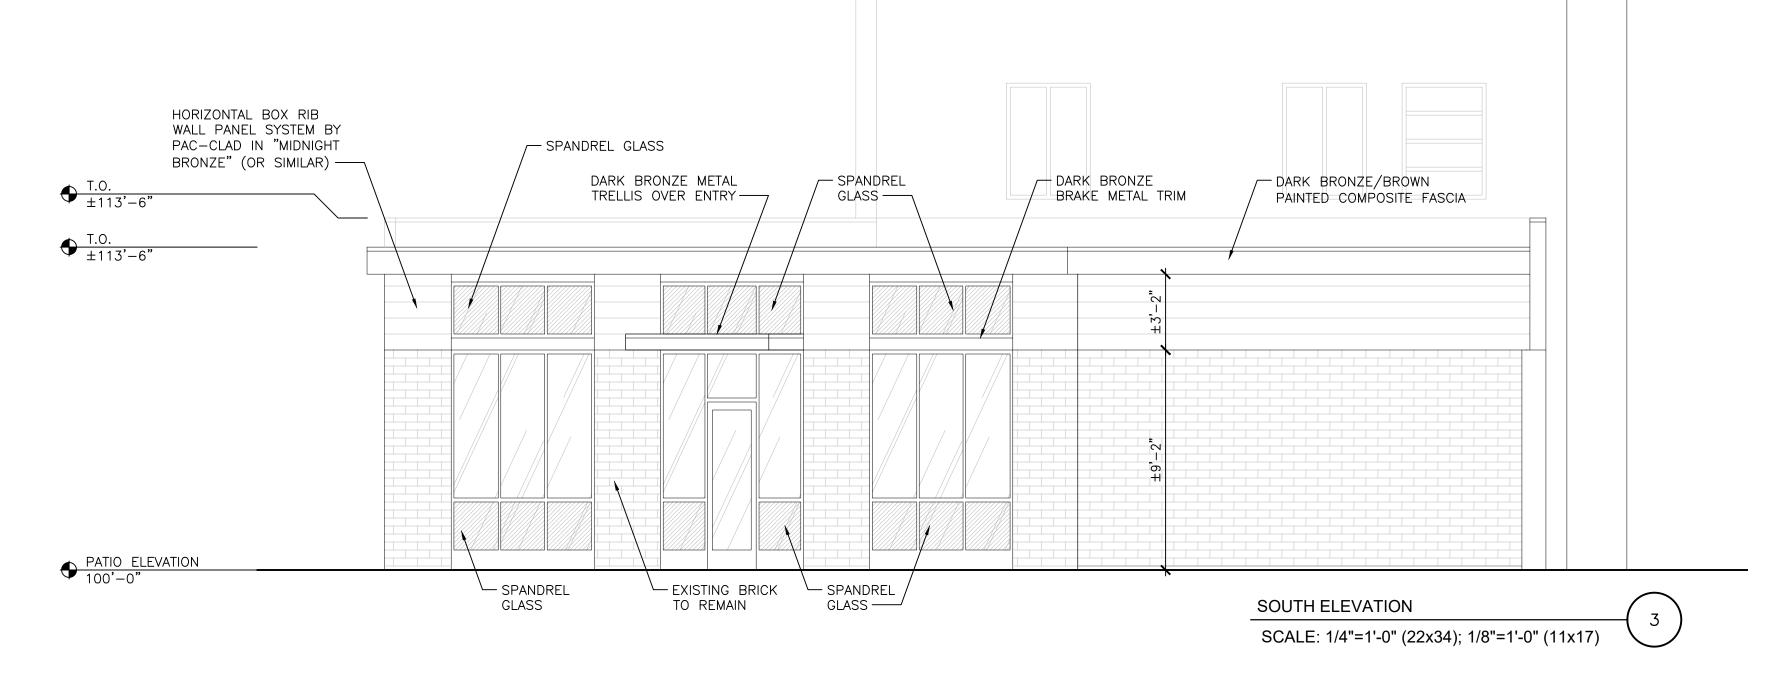

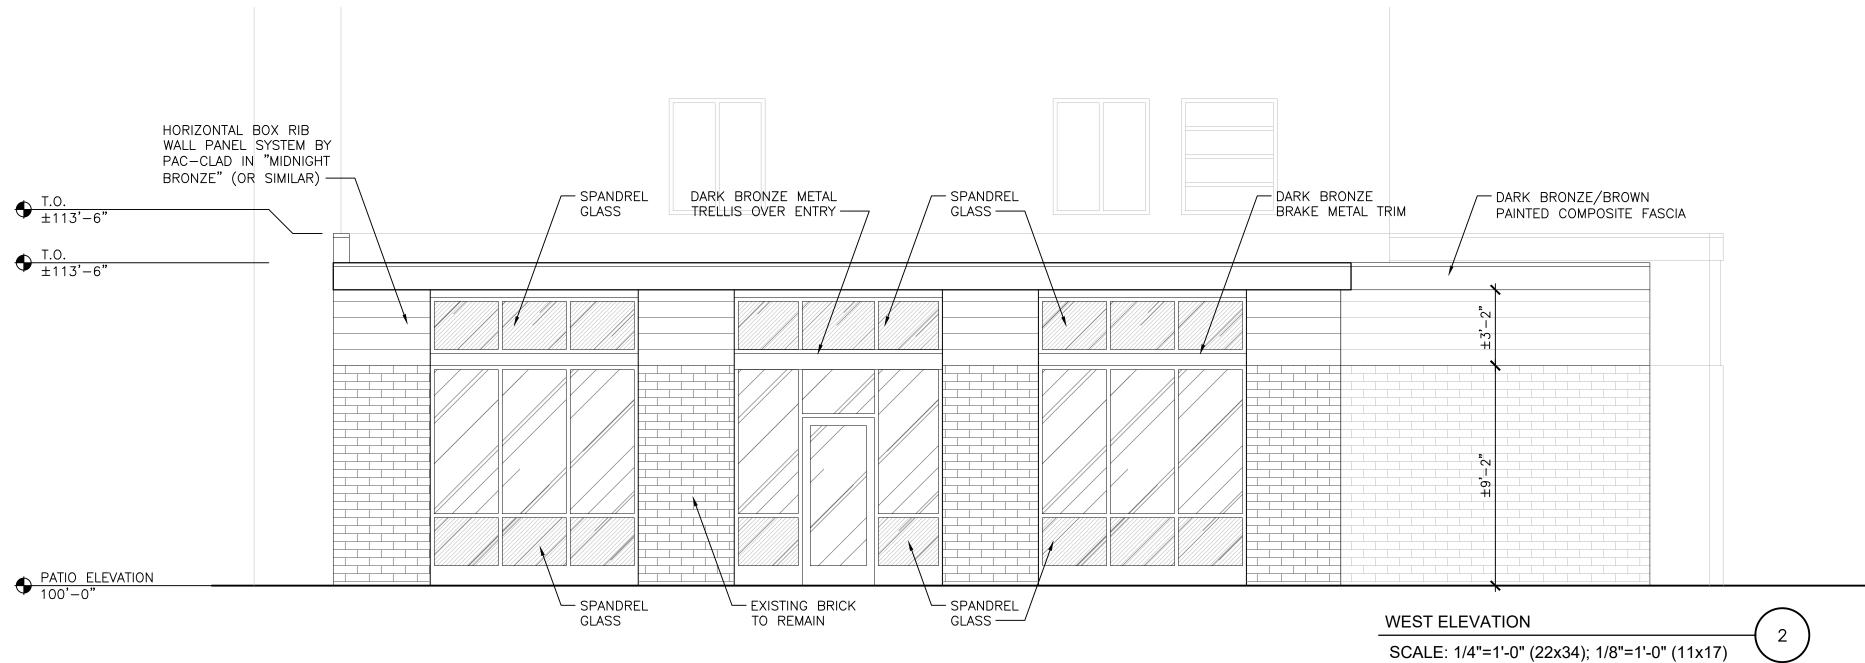





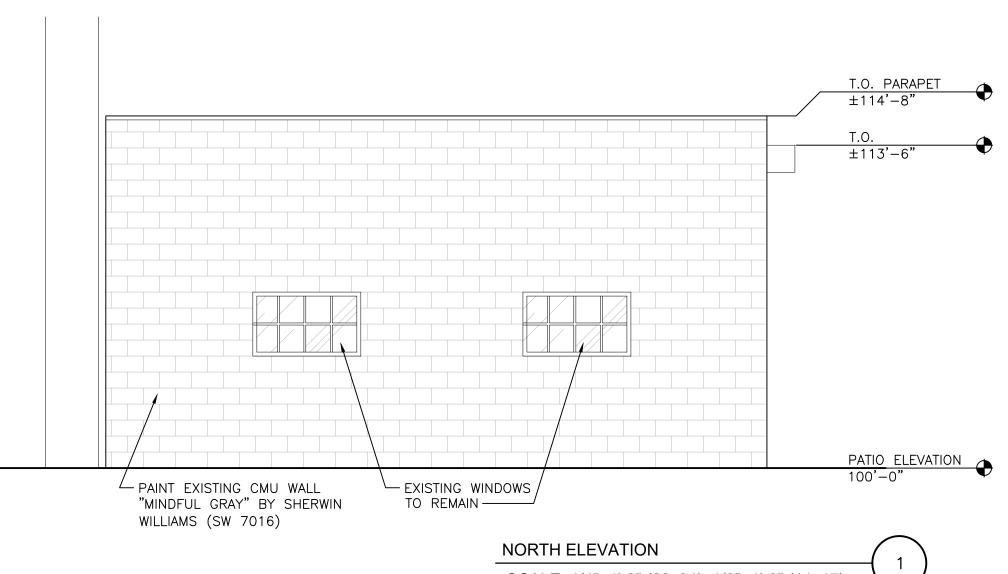

SCALE: 1/4"=1'-0" (22x34); 1/8"=1'-0" (11x17)



Architect

259 South Street, Suite A Waukesha, WI 53186 p: 833-380-6180



Contractor

N8 W22195 Johnson Drive Waukesha, WI 53186 p: 262-574-0306 e: ptorweihe@stierconstruct.com

hoProject Info. — 23123 —

### 344 W Broadway Whitebox

INTERIOR ALTERATION


344 W Broadway Waukesha, WI 53186


**—**Sheet Title —

Drawn by	Checked by
AMP	JDB

1	<b>_</b> Re	visions ——	
	No.	Date	Description
		10.12.23	PC Submittal
Z			
$\bigcirc$			
<b>NSTRUCTI</b>			
STF			
Z			
$\mathcal{O}_{\parallel}$			



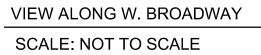

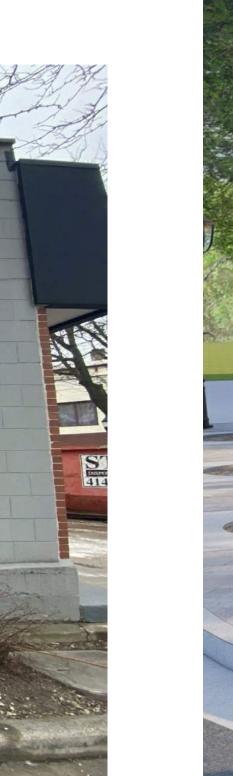

EXISTING NORTH FACADE TO BE PAINTED SCALE: NOT TO SCALE

SW 7016

LRV: 48 (i)

FULL DETAILS ^

**RGB**: 188 / 183 / 173

Hex Value: #BCB7AD

Location Number: 244-C2

Mindful Gray



SCALE: NOT TO SCALE

VIEW FROM INTERSECTION



Architect

259 South Street, Suite A Waukesha, WI 53186 p: 833-380-6180



Contractor N8 W22195 Johnson Drive Waukesha, WI 53186 p: 262-574-0306 e: ptorweihe@stierconstruct.com

■Project Info. — 23123 —

## 344 W Broadway Whitebox

INTERIOR ALTERATION

344 W Broadway Waukesha, WI 53186

Sheet Title —

Drawn by	Checked by
AMP	JDB

Revisions Description 10.12.23 PC Submittal

A9.0

**NOT FOR**