GENERAL NOTES

ALL WORK SHALL BE PERFORMED WITH ALL APPLICABLE LOCAL, STATE, AND NATIONAL CODES AND ORDINANCES AND ALL AUTHORITIES HAVING JURISDICTION

B. ALL WORK WILL BE PERFORMED IN A WORKMANLIKE MANNER

EACH CONTRACTOR SHALL INCLUDE LABOR, MATERIALS, TOOLS, EQUIPMENT, ETC, FOR THE COMPLETE CONSTRUCTION OF THE WORK INDICATED AS SPECIFIED BY THE DRAWINGS AND SPECIFICATIONS, UNLESS OTHER ARRANGEMENTS HAVE BEEN MADE BETWEEN CONTRACTOR AND

MATERIALS AS SPECIFIED ON DRAWINGS SHALL BE USED. SUBSTITUTIONS OF MATERIALS WILL NOT BE ALLOWED WITHOUT THE WRITTEN CONSENT OF SOMERSET HOME PLANNING LLC. THE CONTRACTOR SHALL BE RESPONSIBLE FOR ALL DETAILING IN CONJUNCTION WITH (AND ALI

SOMERSET HOME PLANNING LLC SHALL NOT BE RESPONSIBLE FOR CONSTRUCTION MEANS, METHODS, TECHNIQUES, SEQUENCES OR PROCEDURES, OR FOR SAFETY PRECAUTIONS AND PROGRAMS IN CONNECTION WITH THE WORK OR FOR THE ACTS OR OMISSIONS OF THE CONTRACTOR, SUB-CONTRACTORS, OR ANY OTHER PERSONS PERFORMING THE WORK OR FOR THE FAILURE OF ANY OF THEM TO CARRY OUT THE WORK IN ACCORDANCE WITH THE INTENT OF

ALL PLUMBING, MECHANICAL, AND ELECTRICAL WORK IS TO BE COORDINATED BETWEEN THE TRADES AS PART OF THEIR INSTALLATION LAYOUT.

CONTRACTOR SHALL PROVIDE ADEQUATE BRACING AND/OR SHARING TO INSURE STRUCTURAL STABILITY OF BUILDING DURING CONSTRUCTION

EACH CONTRACTOR SHALL AMEND AND MAKE GOOD AT HIS OWN COST, ANY DEFECTS OR OTHER FAULTS IN HIS/HER WORKMANSHIP AND/OR MATERIAL

ALL MATERIAL FINISHES AND STYLES INCLUDING BUT NOT LIMITED TO EXTERIOR SIDING, ROOFING, WINDOWS, EXTERIOR TRIM, AND INTERIOR AND EXTERIOR MILLWORK, ETC. SHALL BE APPROVED BY SOMERSET HOME PLANNING LLC.

DO NOT SCALE THE DRAWINGS, WRITTEN DIMENSIONS ALWAYS TAKE PRECEDENCE OVER SCALED DIMENSIONS.

THE CONTRACTOR SHALL VERIFY ALL DIMENSIONS AND/OR DISCREPANCIES IN PLAN AND REPORT ERROR(S) TO SOMERSET HOME PLANNING LLC PRIOR TO COMMENCEMENT OF THE WORK, OR TO BE RESPONSIBLE FOR SAME.

M. THESE PLANS, DETAILS, AND SPECIFICATIONS REMAIN THE PROPERTY OF SOMERSET HOME PLANNING LLC AND MAY NOT BE ALTERED IN ANY WAY WITHOUT THE WRITTEN CONSENT OF SOMERSET HOME PLANNING LLC.

PRIOR TO THE START OF CONSTRUCTION, THE CONTRACTOR SHALL VERIFY THE REQUIRED DESIGN LOADS WITH GOVERNING CODES AND SITE CONDITIONS. VERIFY WITH THE LOCAL BUILDING AGENCIES THE WIND, SEISMIC, SNOW, AND OTHER SPECIAL LOADING CONDITIONS. SOMERSET HOME PLANNING LLC SHALL BE NOTIFIED IN WRITING OF ALL DISCREPANCIES.

GREAT EFFORT HAS GONE INTO THE DESIGN AND ENGINEERING OF THESE PLANS. HOWEVER, DUE TO THE IMPOSSIBILITY OF PROVIDING ANY ON-SITE SUPERVISION OVER THE ACTUAL CONSTRUCTION, THE VARIANCE IN LOCAL CODE REQUIREMENTS AND OTHER LOCAL BUILDING AND WEATHER CONDITIONS. THE PURCHASER AND/OR BUILDER OF THIS PLAN RELEASES SOMERSET HOME PLANNING ASSOCIATES AND/OR THE DESIGNER OF THESE PLANS FROM ANY CLAIMS OR LAWSUITS THAT MAY ARISE DURING THE CONSTRUCTION OF THIS STRUCTURE OR ANYTIME IHEREAFTER FROM ANY DAMAGES, INCLUDING STRUCTURAL FAILURES DUE TO ANY DEFICIENCIES IN MATERIALS, OMISSIONS OR ERRORS IN THESE PLANS.

FABRICATION NOTES

TRUSS FABRICATION: THE TRUSS MANUFACTURER IS RESPONSIBLE TO DESIGN AND DETAIL THE ROOF TRUSS SYSTEM. THE ROOF TRUSS SYSTEM SHALL INCLUDE. BUT IS NOT LIMITED TO, A COMPLETE ROOF PLAN INDICATING ALL TRUSS SIZED, LOCATIONS, CONNECTIONS, IMPOSED LOADS, AND BEARING REQUIREMENTS. THE TRUSS SYSTEM SHALL BE DESIGNED MUNICIPAL CODES. TRUSS MANUFACTURER SHALL SUBMIT 2 SETS OF SEALED SHOP DRAWINGS TO BUILDER AND SOMERSET HOME PLANNING FOR APPROVAL OF ROOF TRUSSES AND BEAMS PRIOR TO SUBMITTAL TO CITY. IF MODIFICATIONS TO THESE CONSTRUCTION DOCUMENTS ARE REQUIRED, BUILDER AND SOMERSET HOME PLANNING LLC SHALL BE NOTIFIED IMMEDIATELY. REFER TO GENERAL NOTES FOR ADDITIONAL INSTRUCTION.


<u>WALL PANEL FABRICATION (OR LOOSE LUMBER SUPPLIER):</u> THE WALL PANEL MANUFACTURER OR LOOSE LUMBER SUPPLIER IS RESPONSIBLE TO DESIGN AND DETAIL THE

STRUCTURES WALL PANELS. THE WALL PANEL SYSTEM SHALL INCLUDE, BUT IS NOT LIMITED TO, A WALL PANEL PLAN INDICATING ALL STRUCTURAL HEADER AND BEAM SIZING, LOCATIONS, CONNECTIONS, IMPOSED LOADS, AND BEARING REQUIREMENTS. THE WALL PANEL SYSTEM SHALL BE DESIGNED TO ACCOMMODATE ALL LIVE, DEAD, WIND, AND SEISMIC LOADS AS REQUIRED BY ALL ALL APPLICABLE MUNICIPAL CODES. WALL PANEL MANUFACTURER SHALL SUBMIT 2 SETS OF SEALED BEAM AND HEADER CALCULATIONS WITH WALL PANEL SHOP DRAWINGS TO BUILDER AND SOMERSET HOME PLANNING LLC FOR APPROVAL OF WALL PANELS PRIOR TO SUBMITTAL TO CITY. IF MODIFICATIONS TO THESE CONSTRUCTION DOCUMENTS ARE REQUIRED, BUILDER AND SOMERSET HOME PLANNING LLC SHALL BE NOTIFIED IMMEDIATELY. REFER TO GENERAL NOTES FOR ADDITIONAL INSTRUCTION.


THE FLOOR JOIST MANUFACTURER/SUPPLIER IS RESPONSIBLE TO DESIGN AND DETAIL THE STRUCTURES FLOOR SYSTEM. THE FLOOR SYSTEM SHALL INCLUDE, BUT IS NOT LIMITED TO, A COMPLETE FLOOR JOIST PLAN INDICATING ALL STRUCTURAL BEAM SIZING, BLOCKING LOCATIONS, CONNECTIONS, IMPOSED LOADS, AND BEARING REQUIREMENTS. THE FLOOR JOISTS SHALL BE DESIGNED TO ACCOMMODATE ALL LIVE & DEAD LOADS AS REQUIRED BY ALL ALL APPLICABLE MUNICIPAL CODES. IN ADDITION, FLOOR JOISTS MUST BE SIZED FOR A LIVE LOAD MINIMUM DEFLECTION OF L/480. FLOOR JOIST MANUFACTURER/SUPPLIER SHALL SUBMIT 2 SETS OF SEALED BEAM CALCULATIONS WITH FLOOR JOIST PLAN DRAWINGS TO BUILDER AND SOMERSET HOME PLANNING LLC FOR APPROVAL OF FLOOR JOIST SYSTEM PRIOR TO SUBMITTAL TO CITY. IF MODIFICATIONS TO THESE CONSTRUCTION DOCUMENTS ARE REQUIRED. BUILDER AND SOMERSET HOME PLANNING SHALL BE NOTIFIED IMMEDIATELY. REFER TO GENERAL NOTES FOR


WAUKESHA WEST DUGOUTS

KAHLE BUILDERS

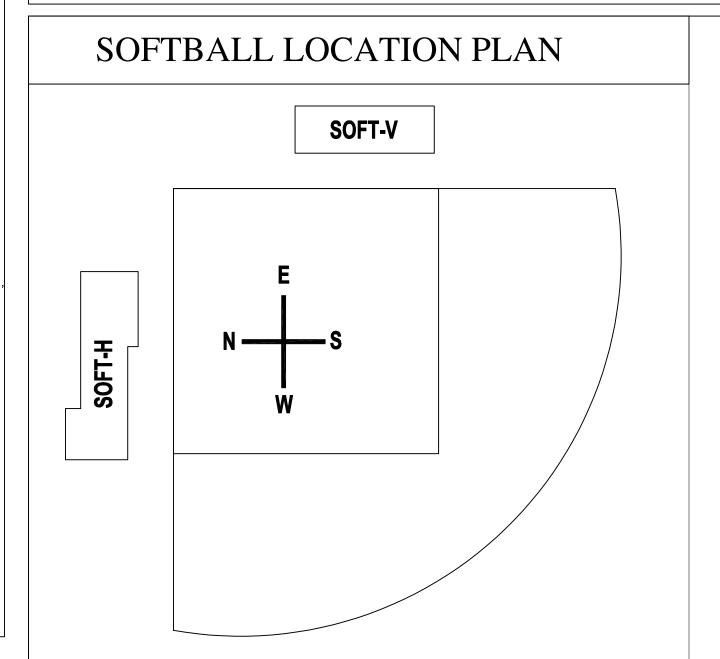

BASEBALL LOCATION PLAN

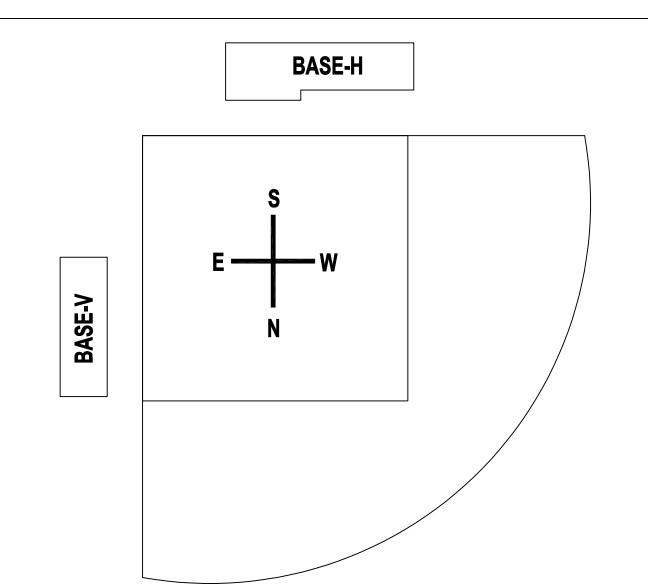

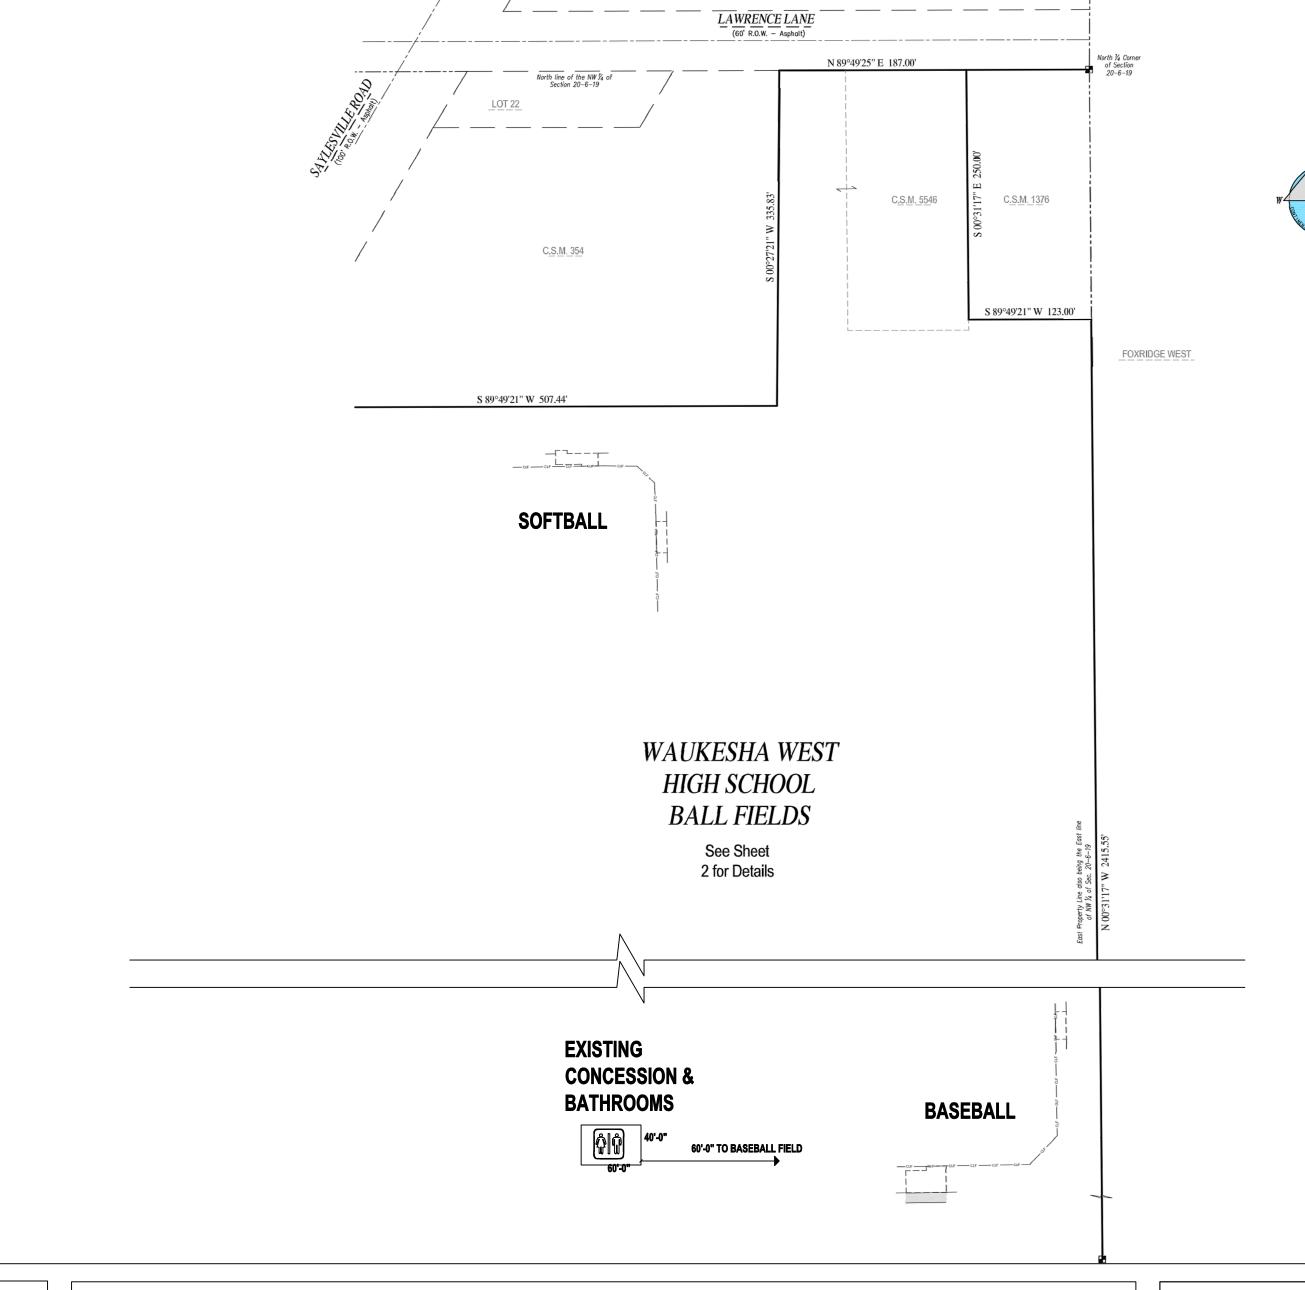

SITE LOCATION SCALE=N.T.S.

NOTE: SITE REFLECTS **EXISTING BATHROOM** FACILITIES ON SITE.

BUILDING SECTIONS

D2

APPLICABLE BUILDING CODES

THE FOLLOWING PLAN SET COMPLYS WITH THE FOLLOWING CODES AS APPLICABLE IN THE FOLLOWING STATES:

> STATE OF WISCONSIN WIS. ADMIN CODE SPS 305 WIS. AMID CODE SPS 360-366 2009 INTERNATIONAL BUILDING CODE 2009 MECHANICAL CODE 2009 IECC ENERGY CONSERVATION 2003 ACCESSIBILITY STANDARD ANSI A117.1







PROJECT INFORMATION

WAUKESHA WEST DUGOUTS

3301 SAYLESVILLE RD WAUKESHA, WI

OCCUPANCY GROUP: A-5 CONSTRUCTION TYPE: TYPE VB OCCUPANCY LOAD PER STRUCTURE:

- SOFTBALL HOME=21
- SOFTBALL VISTOR=13 BASEBALL HOME=36
- BASEBALL VISTOR=11


(SEE OCCUPANT LOAD WORKSHEET)

SHEET INDEX							
SHEET NO.	SHEET DESCRIPTION						
CS	COVER SHEET						
A1.0	SOFTBALL HOME DUGOUT ELEVATIONS & ROOF PLANS						
A1.1	SOFTBALL HOME DUGOUT FOUNDATION & FLOOR PLANS						
A1.2	SOFTBALL VISITOR DUGOUTS PLANS						
A2.0	BASEBALL HOME DUGOUT ELEVATIONS & ROOF PLANS						
A2.1	BASEBALL HOME DUGOUT FOUNDATION & FLOOR PLANS						
2.2	BASEBALL VISTOR DUGOUT PLANS						
E1.0	ELECTRICAL LAYOUTS						
D1	TYPICAL WALL SECTIONS						

7.17 PLAN SET 004
5.17 PLAN SET 003
9.17 PLAN SET 002 E
9.17 PLAN SET 001
DESCRIPTION OF REVIS


JOB NUMBER WW DUGOUT


SHEET NUMBER

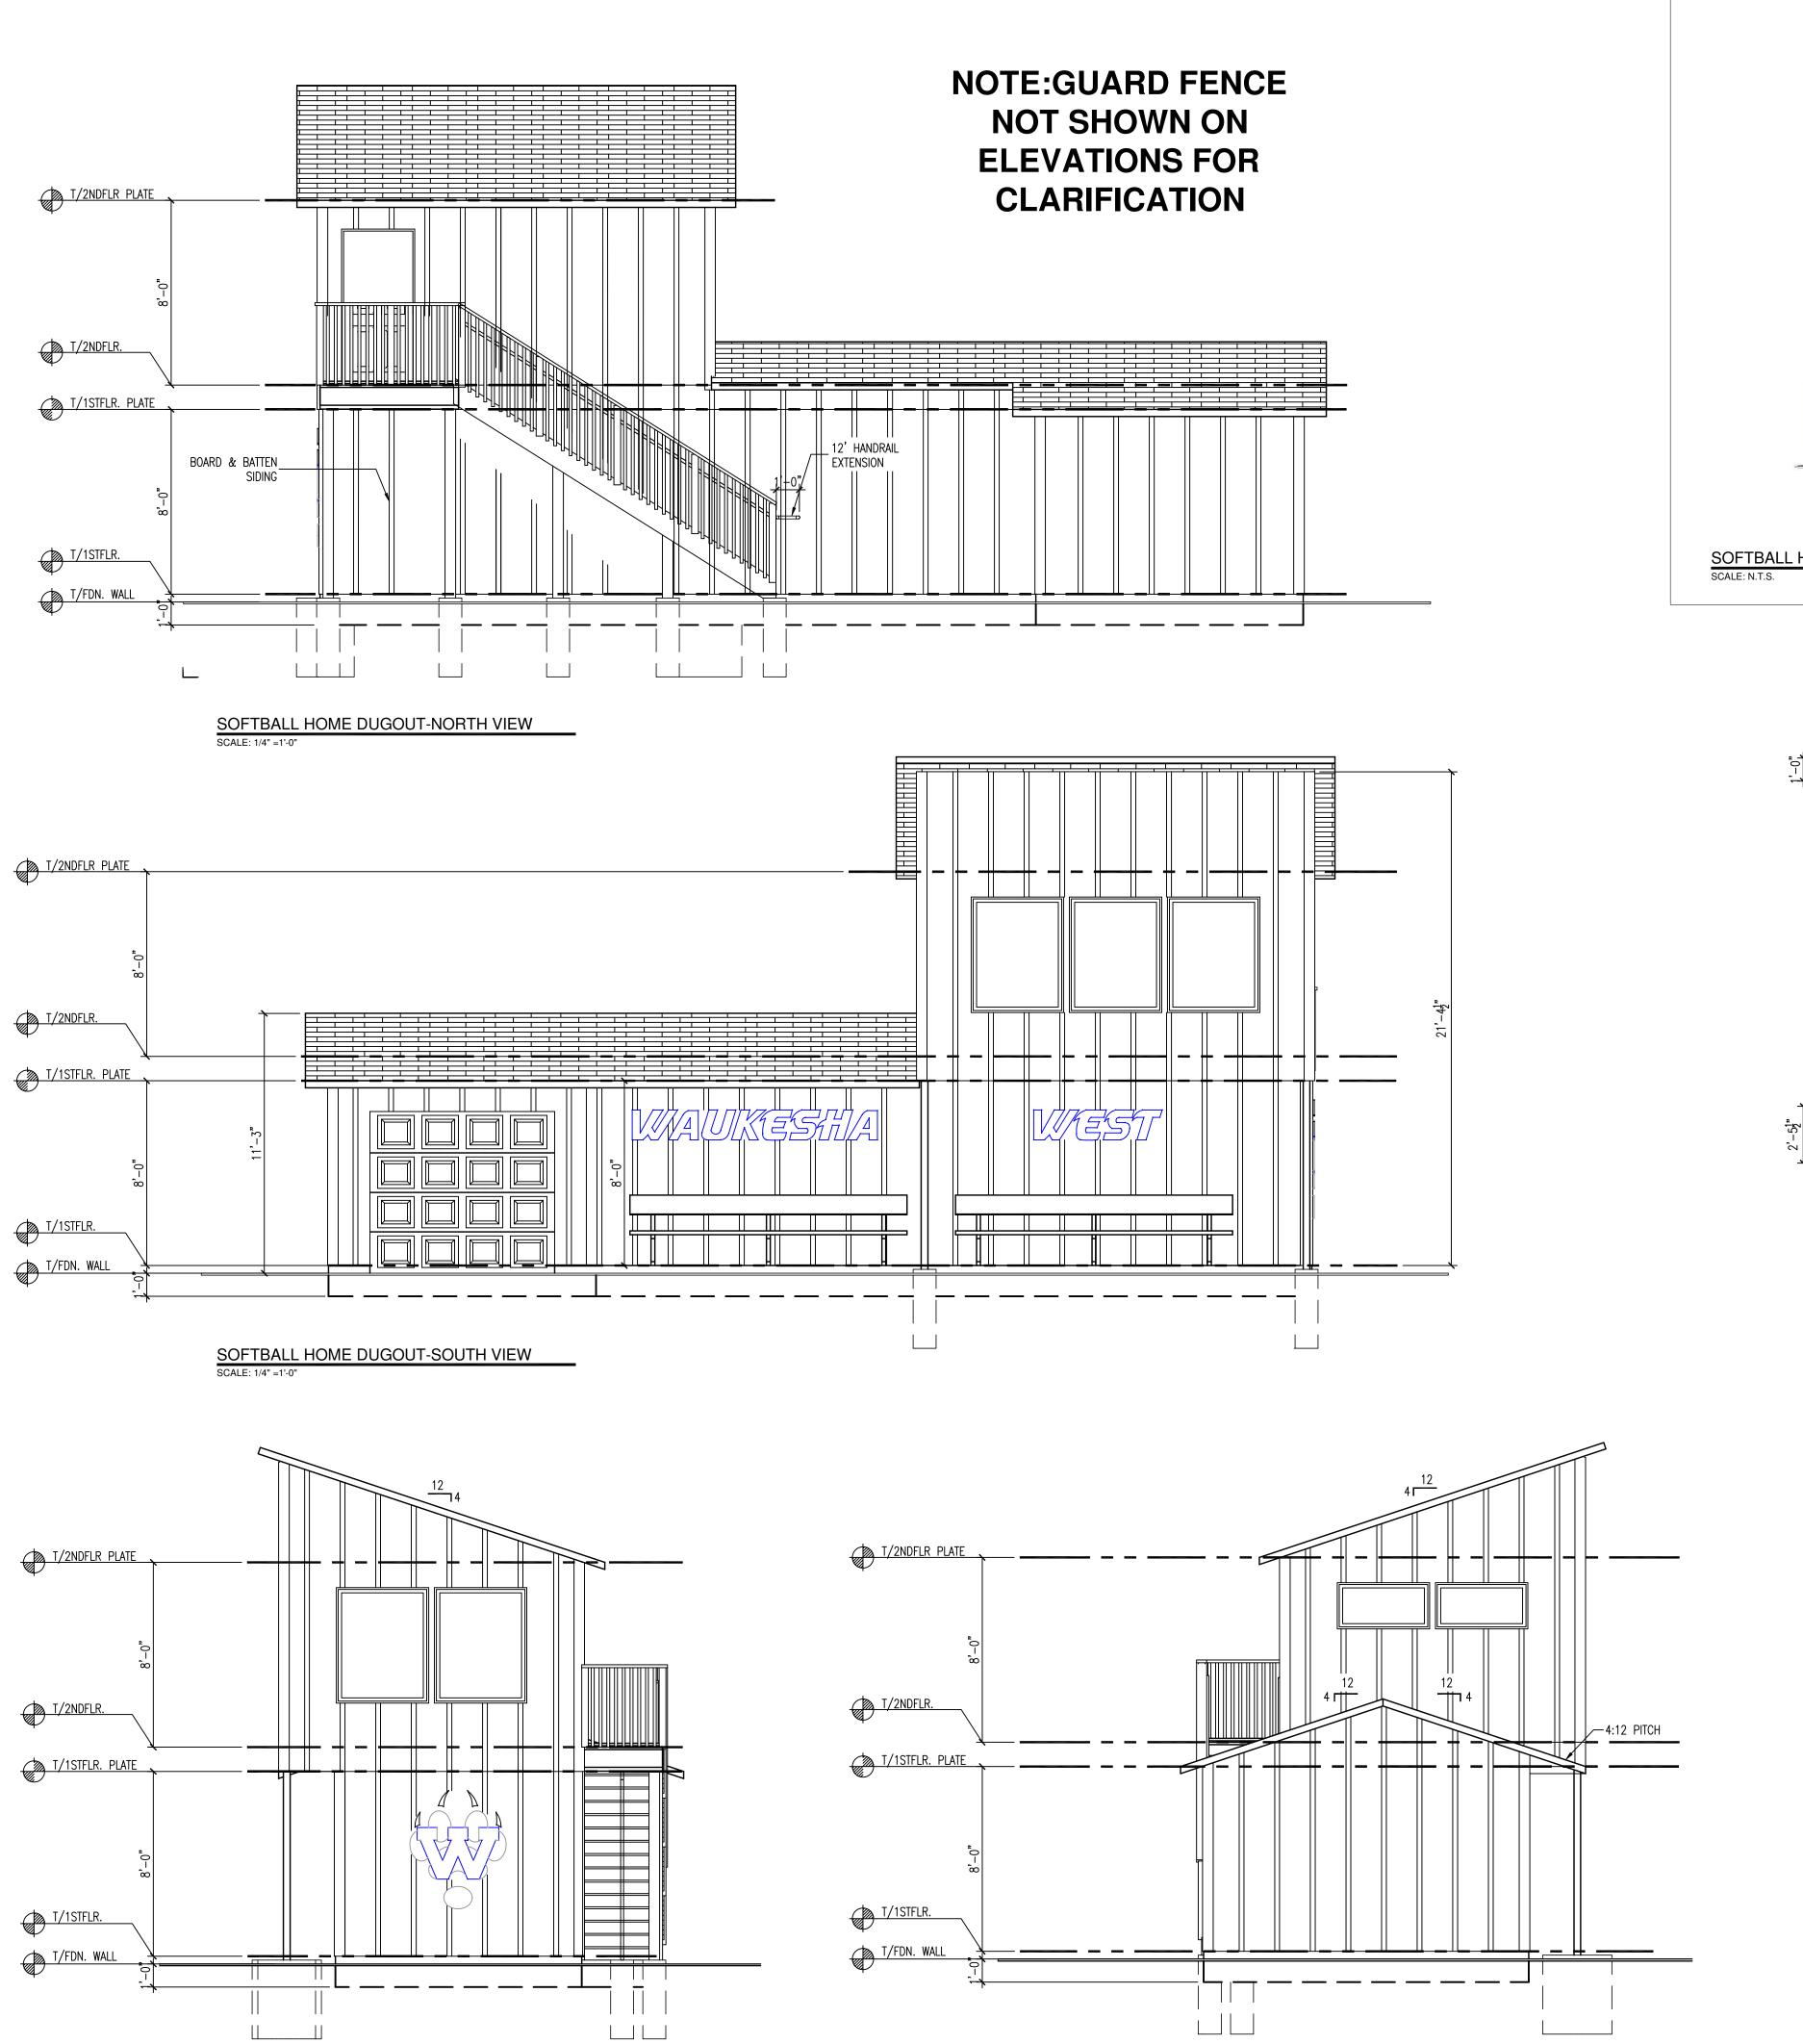


SOFTBALL HOME DUGOUT-EAST VIEW

SOFTBALL HOME DUGOUT-WEST VIEW
SCALE: 1/4" =1'-0"

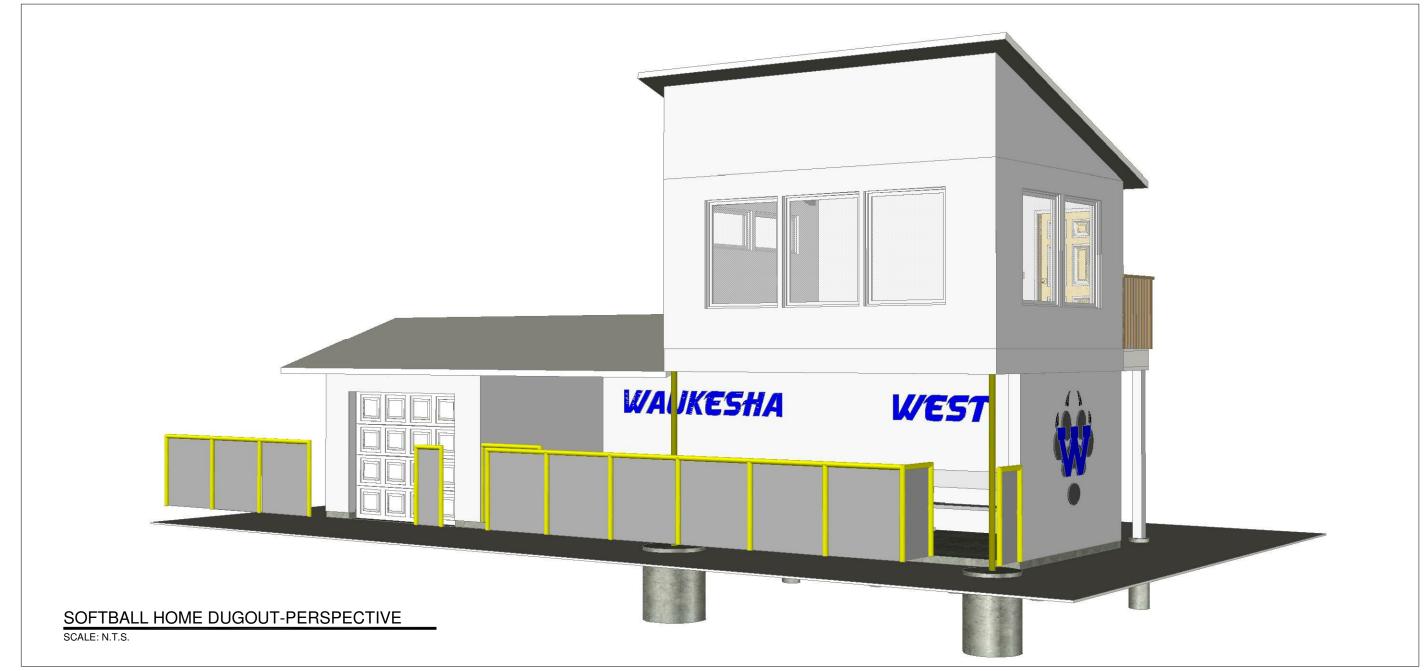

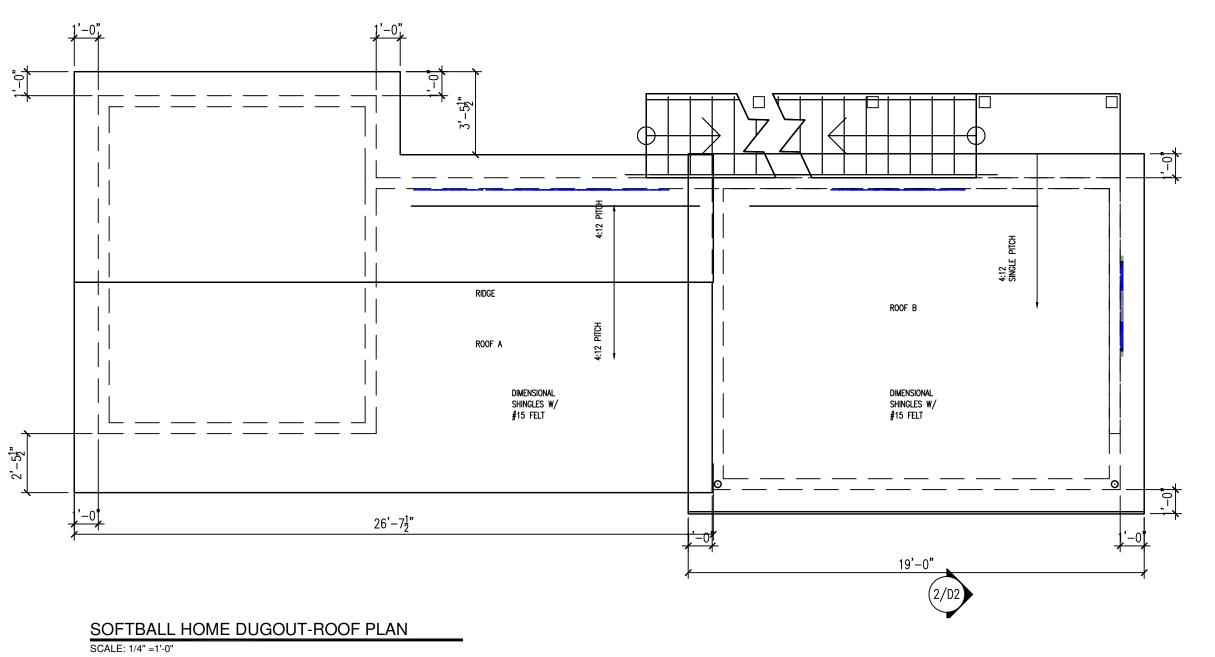

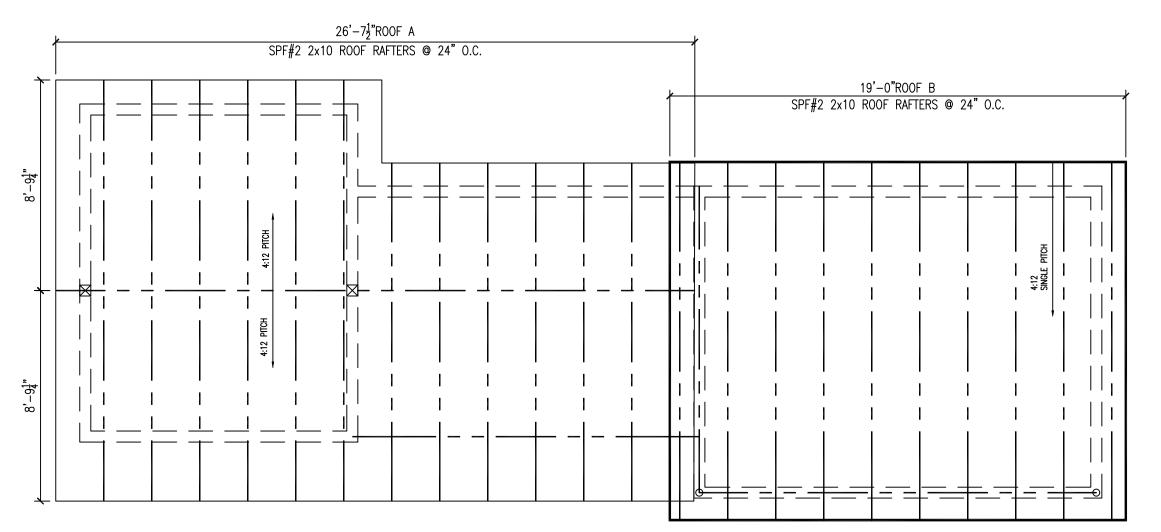


SOFTBALL HOME DUGOUT-ROOF FRAMING PLAN SCALE: 1/4" =1'-0"




SOFTBALL HOME DUGOUT ELEVATIONS & ROOF PLANS


JOB NUMBER


WW DUGOUT SHEET NUMBER

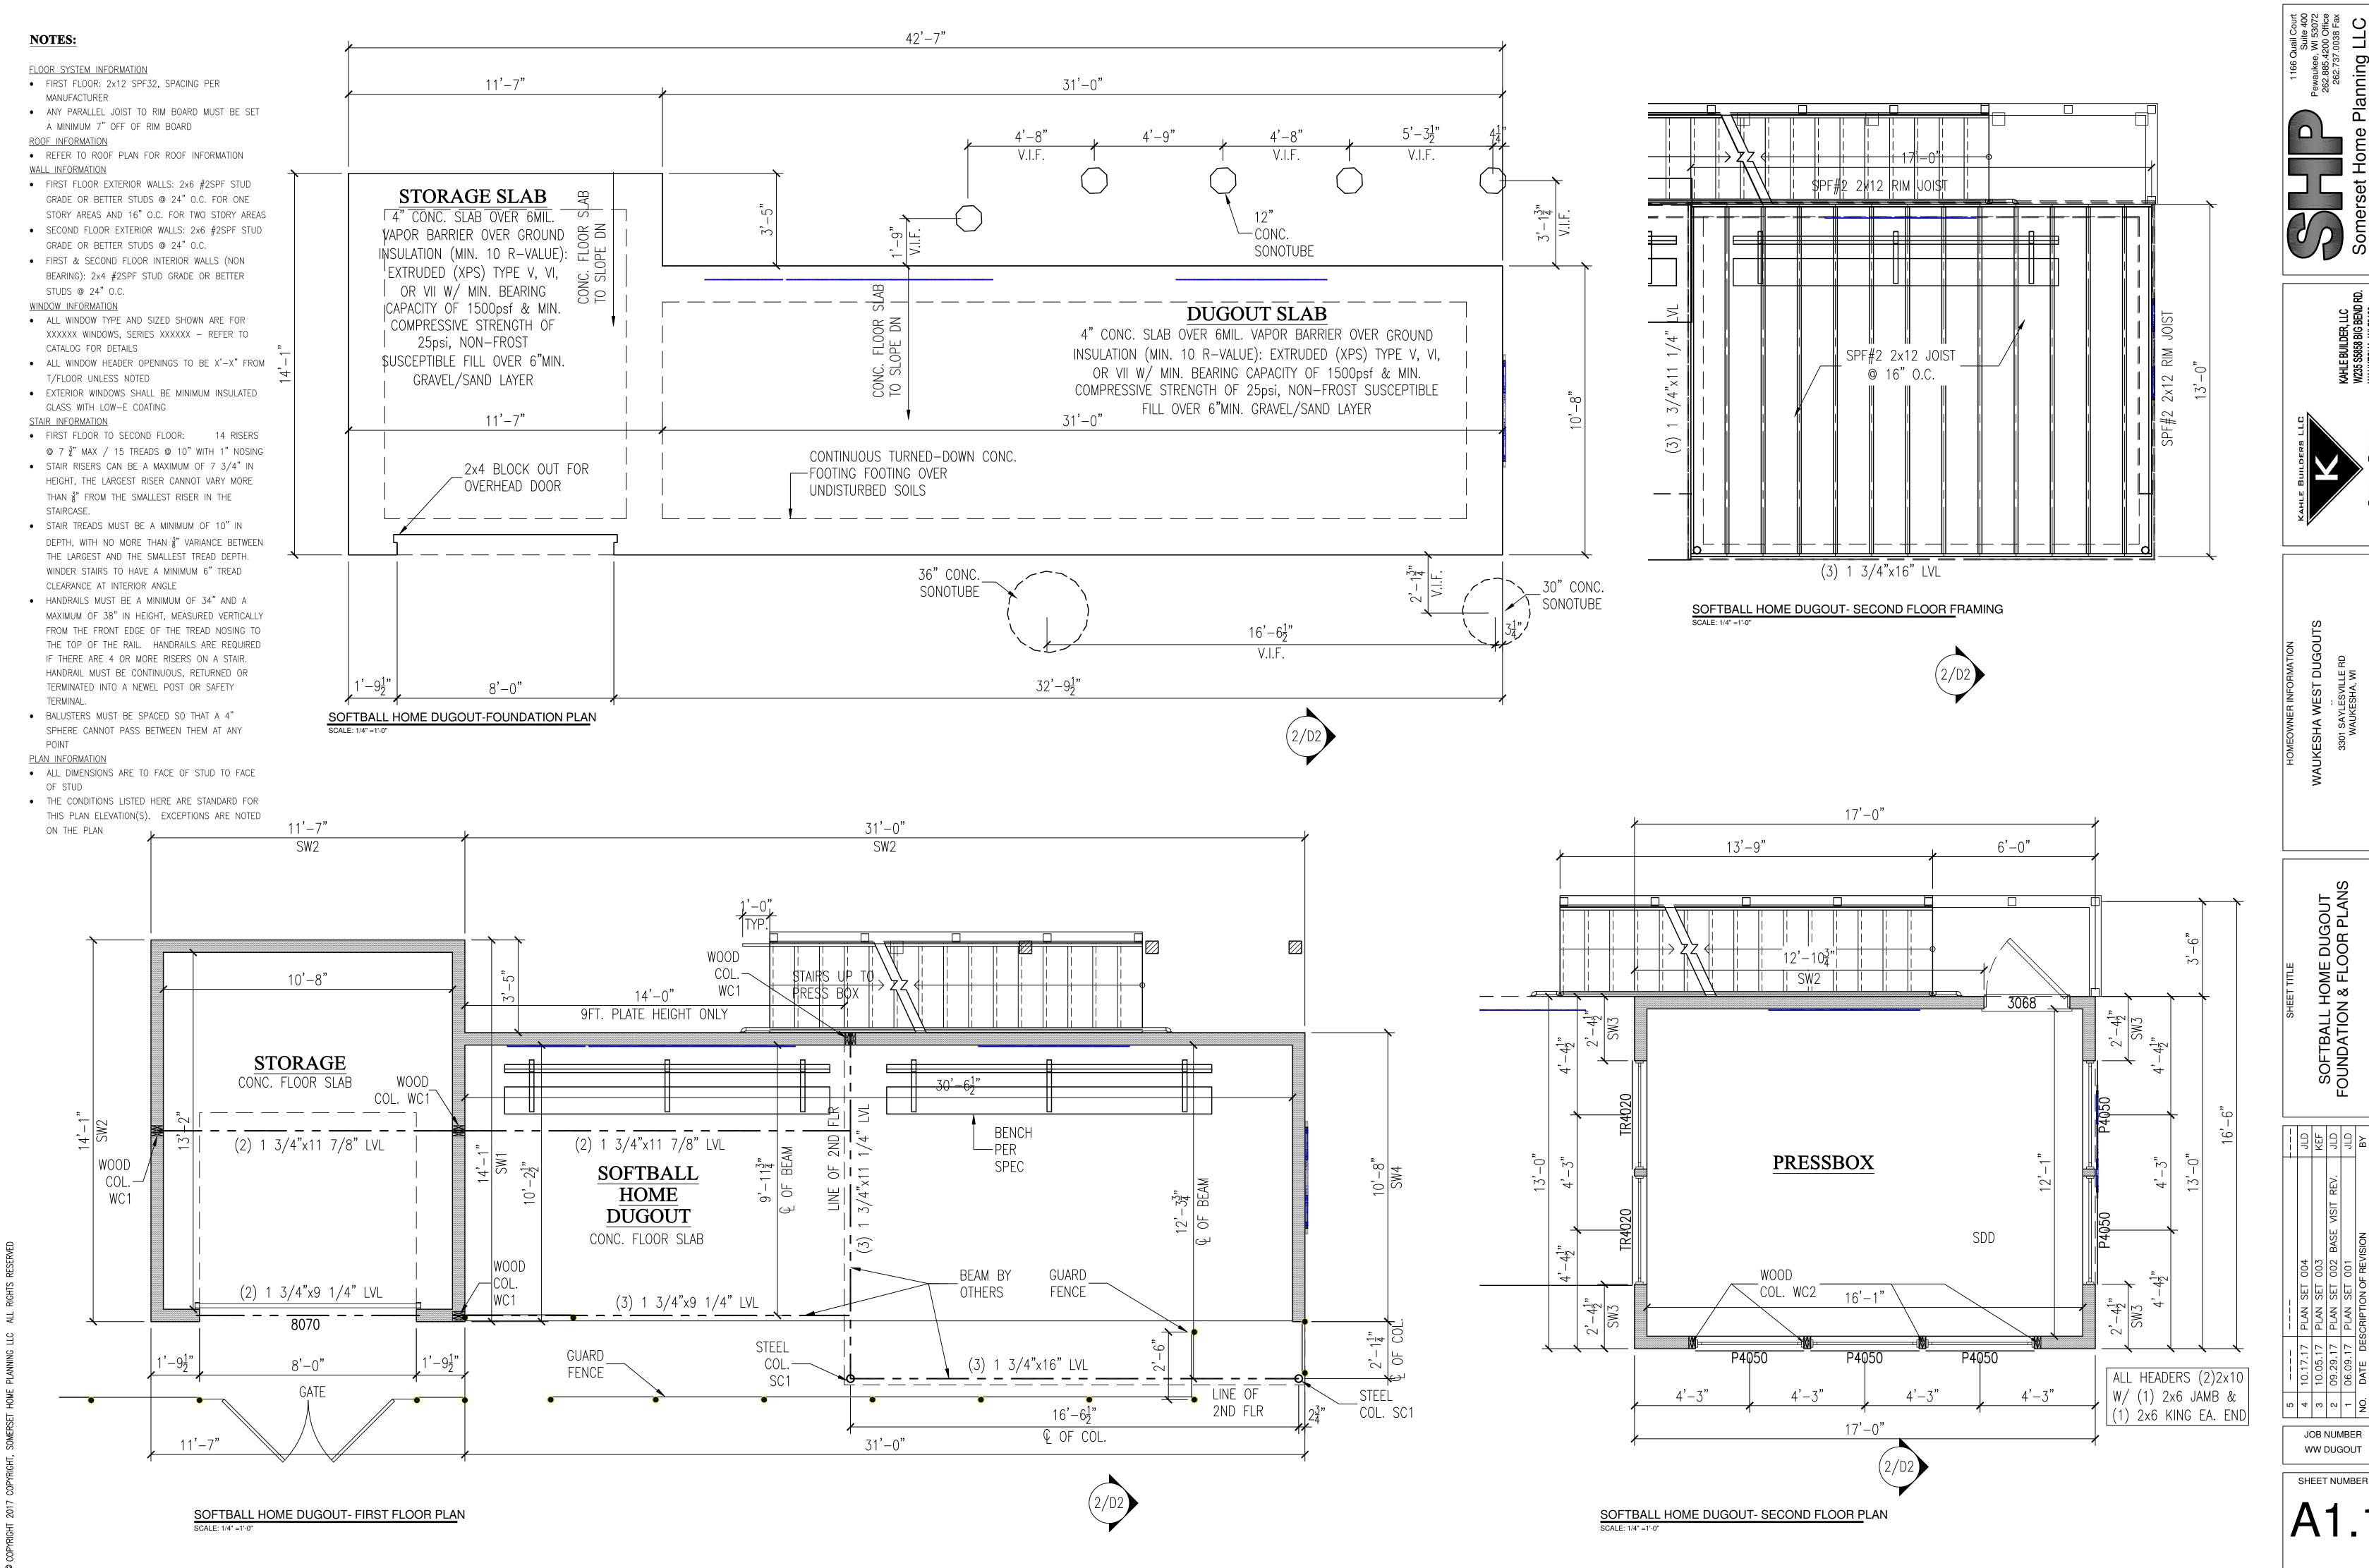

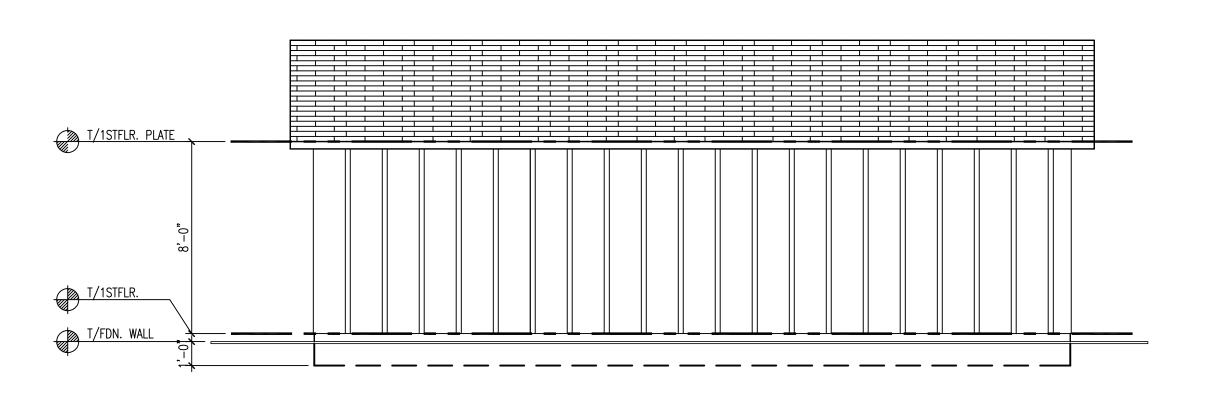



VISITOR DUGOUT-REAR VIEW
SCALE: 1/4" =1'-0"

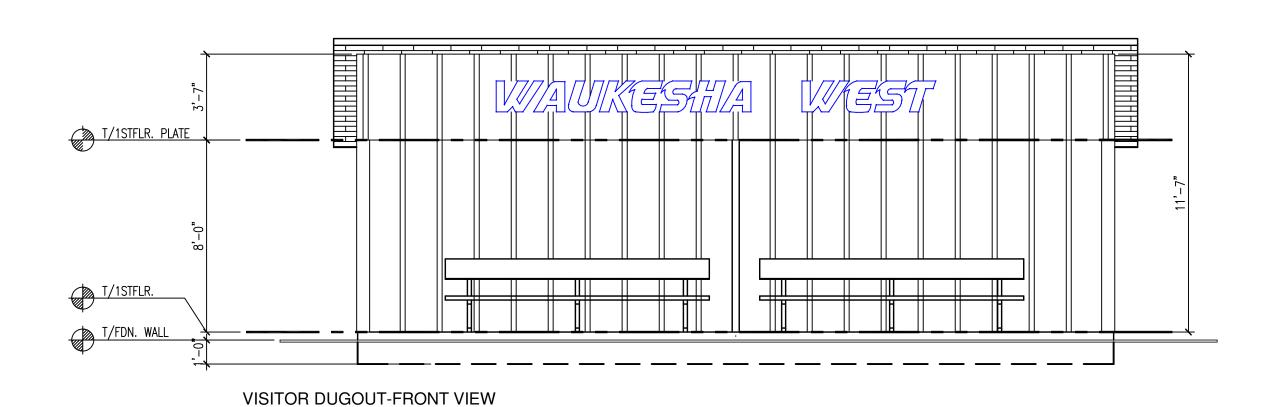


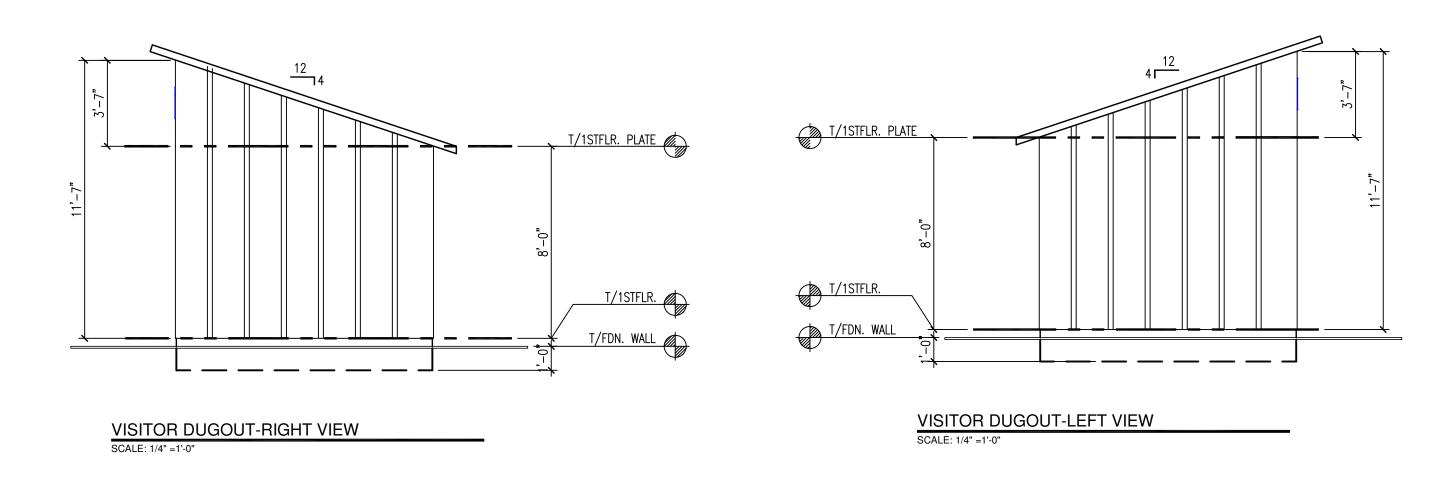




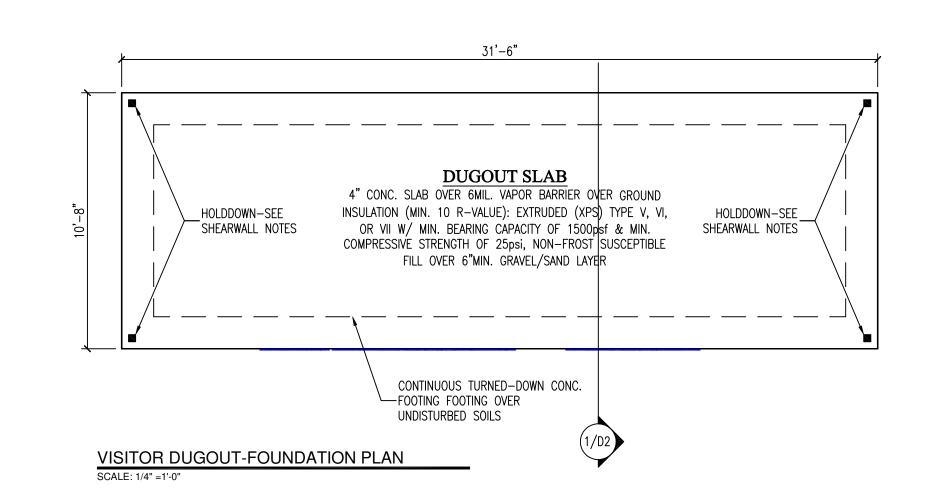

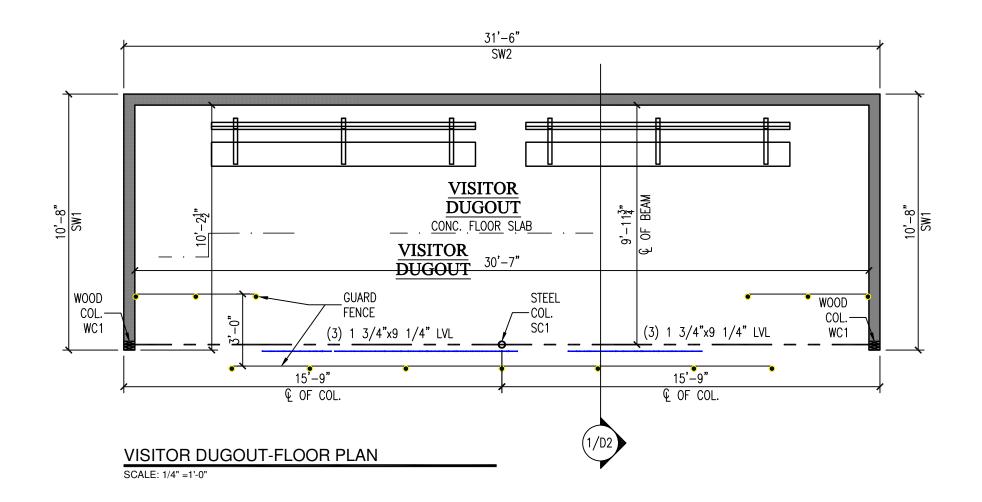

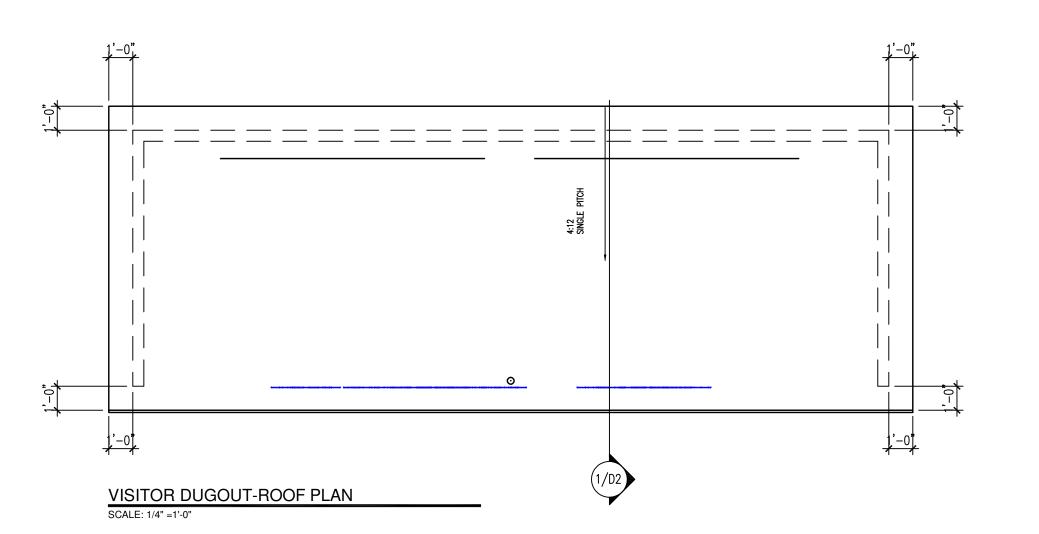

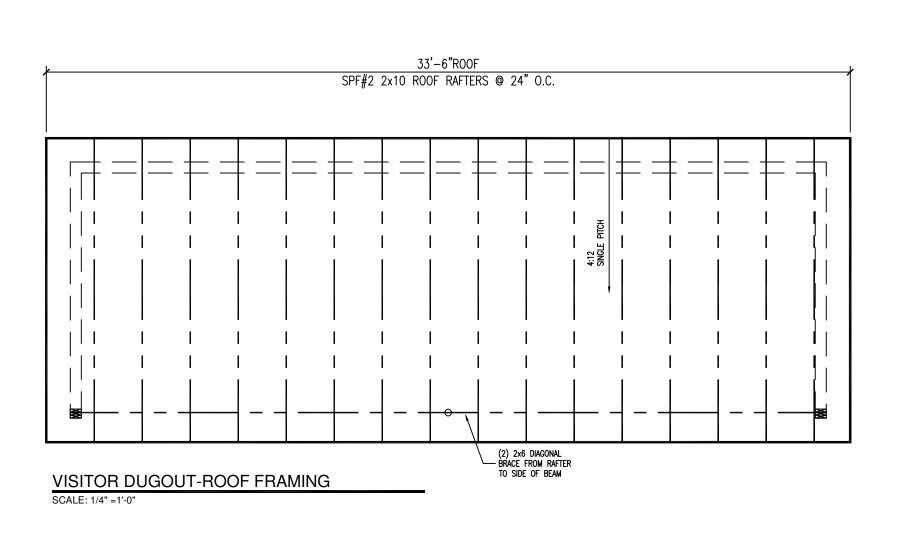

NOTES:

<u>COLUMNS</u>

- WC1: (3)2x6
- WC2: (2) 1/2"x5 1/2" W2, 1.3E
- SC1: PIPE 3 STD (3.50"x0.216") W/ SIMPSON LCC5.25-35 COLUMN CAP & 3/8" 10"x10" BNE PL W/ (4) 5/8" Ø SIMPSON TITEN ND ANCHORS, 4" EMBEDDED GALVANIZE ALL EXPOSED STEEL

SHEARWALLS

- SW1: 7/16" OSB OR PLYWOOD SHEATHING FASTENED WITH 8d NAILS @ 6" OC ALONG ALL PANEL EDGES & 12" OC IN THE FIELD. PROVIDE BLOCKING AT ALL PANEL JOINTS. PROVIDE SIMPSON HDU4-SDS2.5 HOLDDOWN EACH END WITH 5/8" DIAMETER A36 THREADED ROD EPOXIED INTO FOUNDATION WITH HILTI HIT-HY 200 ADHESIVE, MIN 10" EMBED.
- SW2: 7/16" OSB OR PLYWOOD SHEATHING FASTENED WITH 8d NAILS @ 6" OC ALONG ALL PANEL EDGES & 12" OC IN THE FIELD. PROVIDE BLOCKING AT ALL PANEL JOINTS. PROVIDE SIMPSON DTT2Z HOLDDOWN EACH END WITH 1/2" DIAMETER A36 THREADED ROD EPOXIED INTO FOUNDATION WITH HILTI HIT—HY 200 ADHESIVE, MIN 8" EMBED.
- SW3: 7/16" OSB OR PLYWOOD SHEATHING FASTENED WITH 8d NAILS @ 4" OC ALONG ALL PANEL EDGES & 12" OC IN THE FIELD. PROVIDE BLOCKING AT ALL PANEL JOINTS. PROVIDE SIMPSON CMST16 X 62" LONG HOLDDOWN STRAP EACH END OF WALL WITH (58) 16d SINKER NAILS.
- SW4: 7/16" OSB OR PLYWOOD SHEATHING FASTENED WITH 8d NAILS @ 4" OC ALONG ALL PANEL EDGES & 12" OC IN THE FIELD ON BOTH SIDES OF WALL. PROVIDE BLOCKING AT ALL PANEL JOINTS. PROVIDE SIMPSON HDU11—SDS2.5 HOLDDOWN EACH END WITH 1" DIAMETER A36 THREADED ROD EPOXIED INTO FOUNDATION WITH HILTI HIT—HY 200 ADHESIVE, MIN 12" EMBED.

NOTE:GUARD FENCE NOT SHOWN ON ELEVATIONS FOR CLARIFICATION



KAHLE BUILDER, LLC W235 S5858 BIG BEND | WAI IKFSHA WI 53189



WAUKESHA WEST DUGOUTS


SOFTBALL VISITOR DUGOUTS PLANS

)04 JLD)03 KEF	09.29.17 PLAN SET 002 BASE VISIT REV. JLD)01 JLD	REVISION BY	PRINT DATE: 10/17/2017 1:01 PM			
	10.17.17 PLAN SET 004	10.05.17 PLAN SET 003	PLAN SET 0	06.09.17 PLAN SET 001	DATE DESCRIPTION OF REVISION				
	10.17.17	10.05.17	09.29.17	06.09.17	DATE DES	DRAWN BY:			
2	4	3	2	1	NO.	DRAW			
IOD AU MOED									

JOB NUMBER
WW DUGOUT

SHEET NUMBER

A1.2

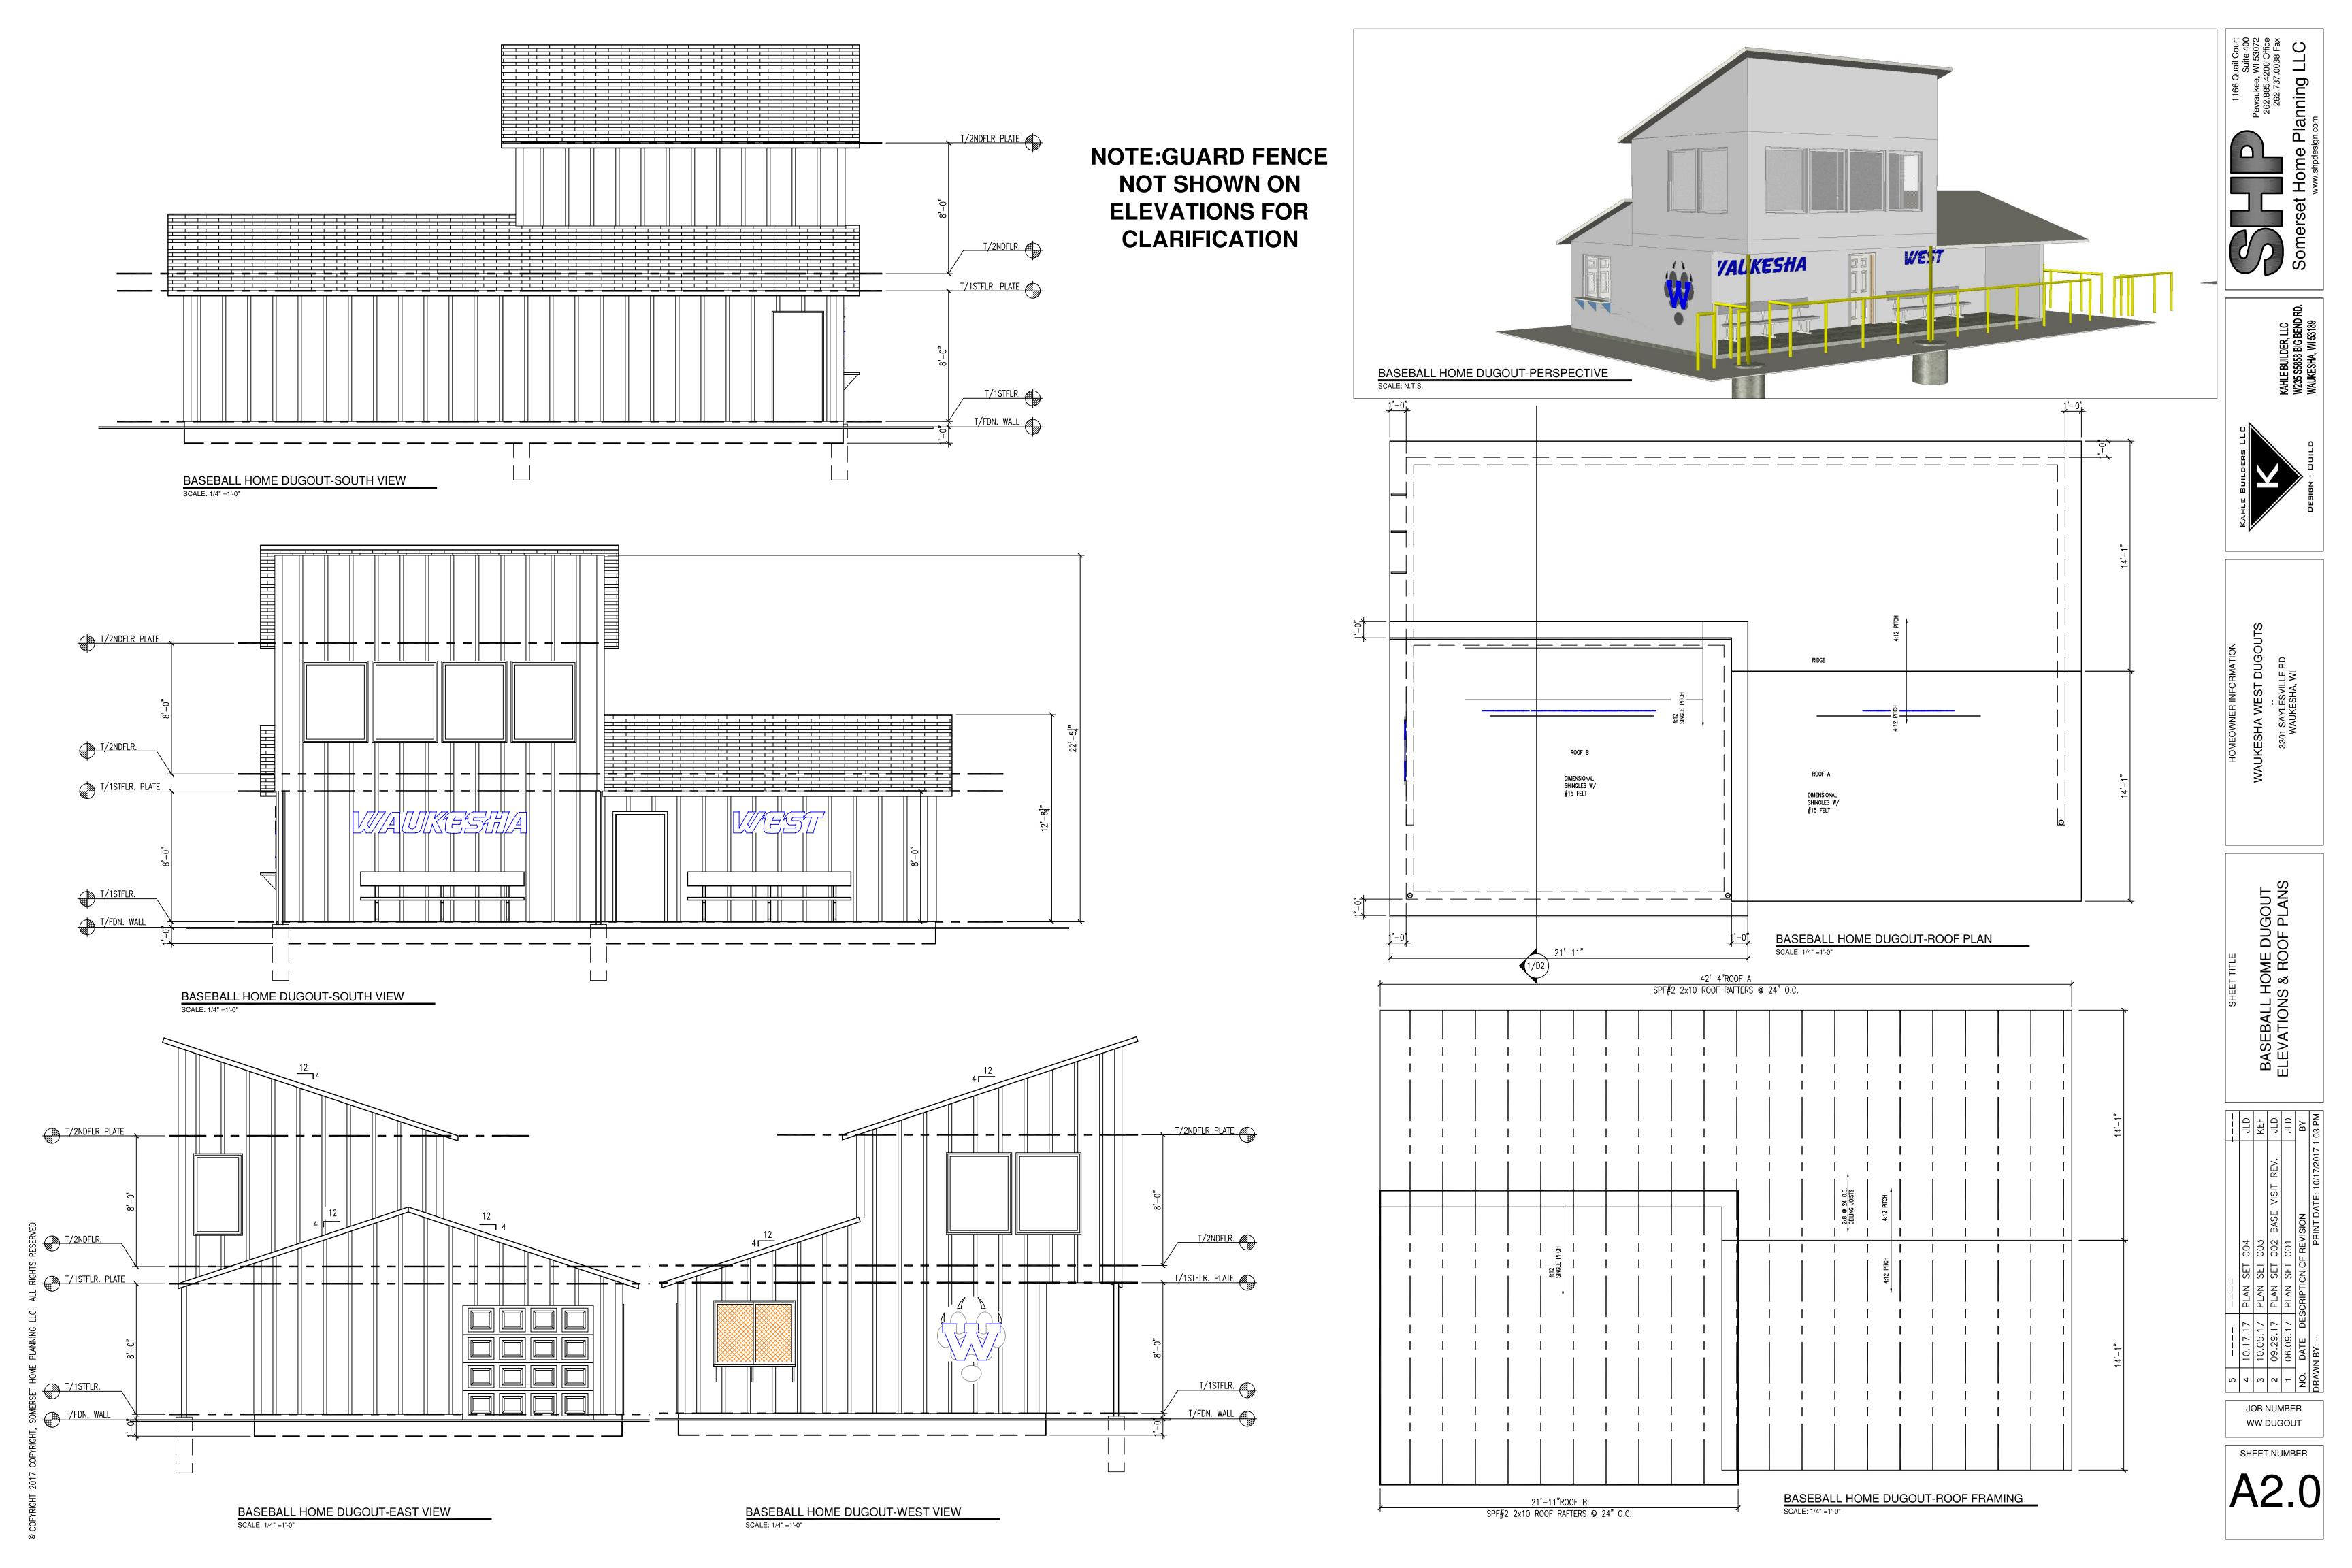

- FIRST FLOOR: 2x12 SPF32, SPACING PER MANUFACTURER
- ANY PARALLEL JOIST TO RIM BOARD MUST BE SET A MINIMUM 7" OFF OF RIM BOARD

ROOF INFORMATION REFER TO ROOF PLAN FOR ROOF INFORMATION

- WALL INFORMATION
- FIRST & SECOND FLOOR EXTERIOR WALLS: 2x6 #2SPF STUD GRADE OR BETTER STUDS @ 16" O.C.
- FIRST & SECOND FLOOR INTERIOR WALLS (NON BEARING): 2x4 #2SPF STUD GRADE OR BETTER STUDS @ 16" O.C.

WINDOW INFORMATION


- ALL WINDOW TYPE AND SIZED SHOWN ARE FOR XXXXXX WINDOWS, SERIES XXXXXX — REFER TO CATALOG FOR DETAILS
- ALL WINDOW HEADER OPENINGS TO BE X'-X" FROM T/FLOOR UNLESS NOTED
- EXTERIOR WINDOWS SHALL BE MINIMUM INSULATED GLASS WITH LOW-E COATING


STAIR INFORMATION

- FIRST FLOOR TO SECOND FLOOR: 14 RISERS @ 7 $\frac{3}{4}$ " MAX / 15 TREADS @ 10" WITH 1" NOSING
- STAIR RISERS CAN BE A MAXIMUM OF 7 3/4" IN HEIGHT, THE LARGEST RISER CANNOT VARY MORE THAN 3" FROM THE SMALLEST RISER IN THE STAIRCASE.
- STAIR TREADS MUST BE A MINIMUM OF 10" IN DEPTH, WITH NO MORE THAN 3" VARIANCE BETWEEN THE LARGEST AND THE SMALLEST TREAD DEPTH. WINDER STAIRS TO HAVE A MINIMUM 6" TREAD CLEARANCE AT INTERIOR ANGLE
- HANDRAILS MUST BE A MINIMUM OF 34" AND A MAXIMUM OF 38" IN HEIGHT, MEASURED VERTICALLY FROM THE FRONT EDGE OF THE TREAD NOSING TO THE TOP OF THE RAIL. HANDRAILS ARE REQUIRED IF THERE ARE 4 OR MORE RISERS ON A STAIR. HANDRAIL MUST BE CONTINUOUS, RETURNED OR TERMINATED INTO A NEWEL POST OR SAFETY TERMINAL.
- BALUSTERS MUST BE SPACED SO THAT A 4" SPHERE CANNOT PASS BETWEEN THEM AT ANY POINT

<u>PLAN INFORMATION</u>


- ALL DIMENSIONS ARE TO FACE OF STUD TO FACE OF STUD
- THE CONDITIONS LISTED HERE ARE STANDARD FOR THIS PLAN ELEVATION(S). EXCEPTIONS ARE NOTED ON THE PLAN

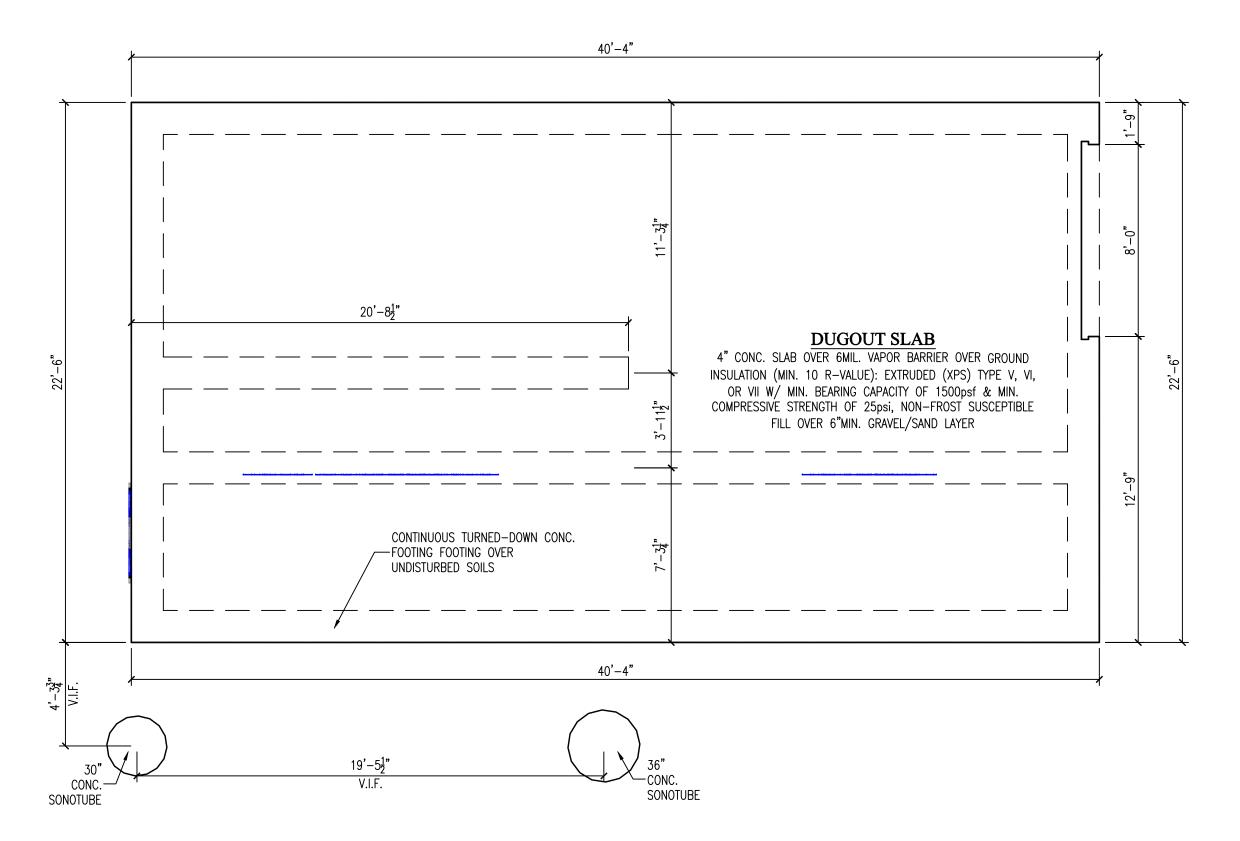


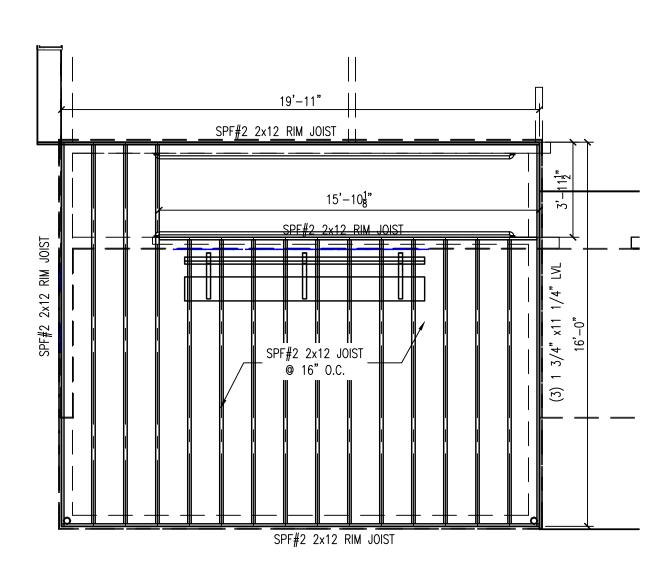

BASEBALL HOME DUGOUT-SECOND FLOOR FRAMING SCALE: 1/4" =1'-0"

BASEBALL HOME DUGOUT-FOUNDATION PLAN SCALE: 1/4" =1'-0"

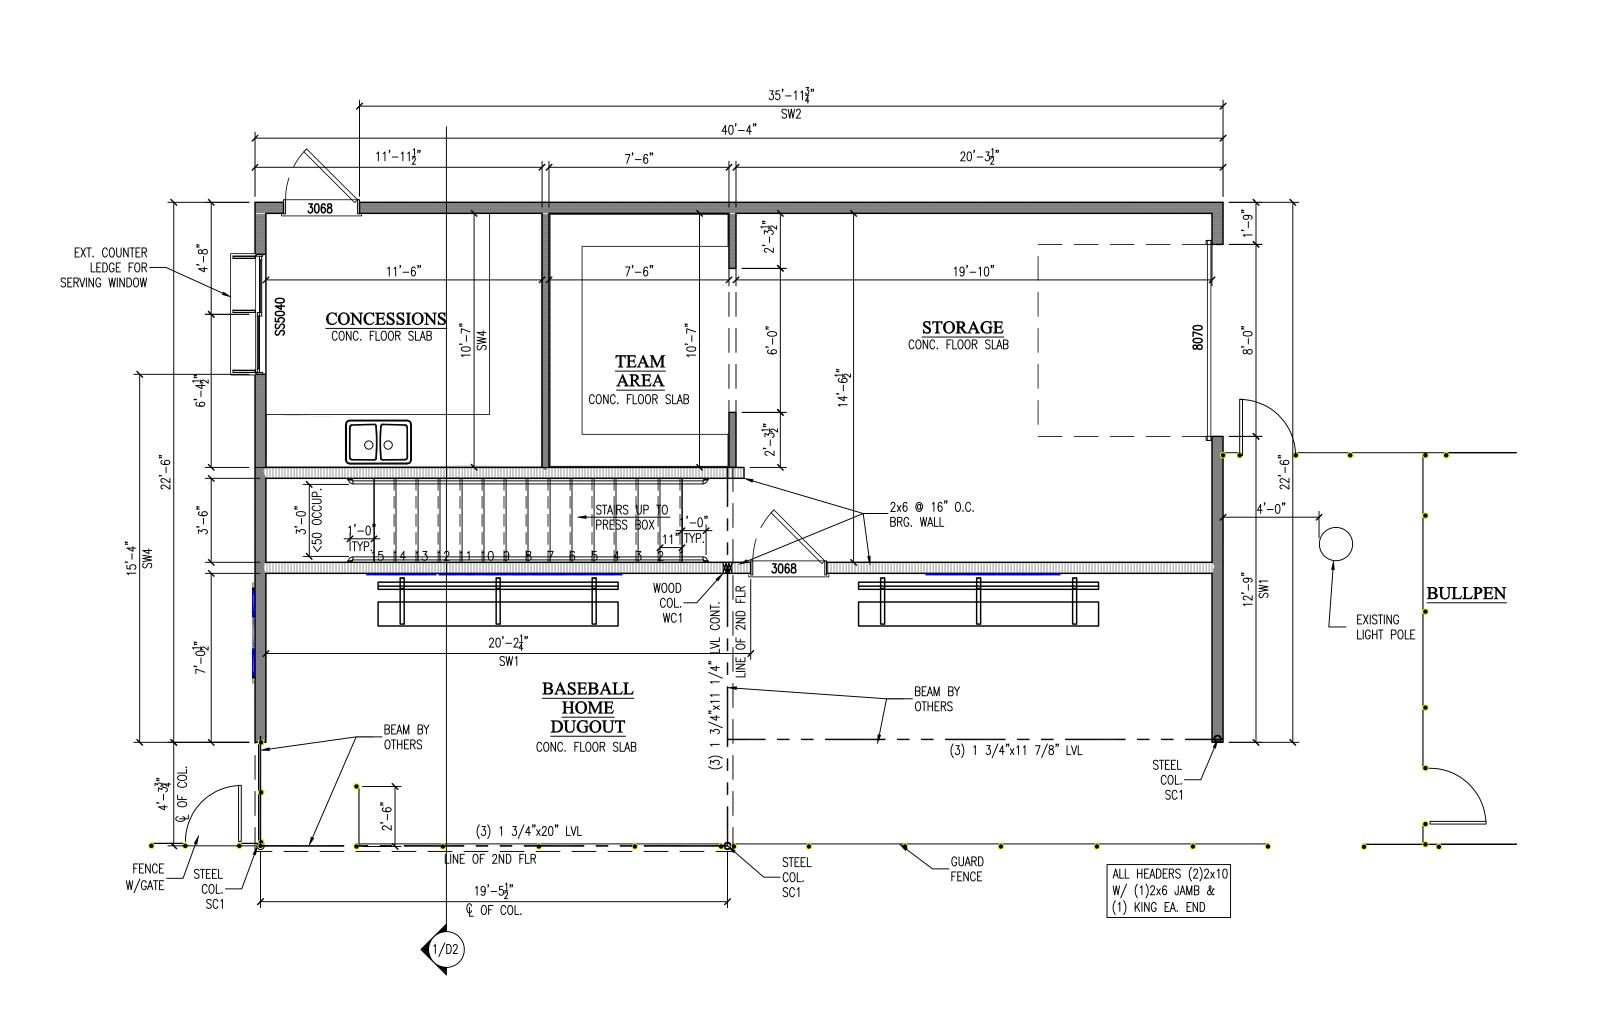


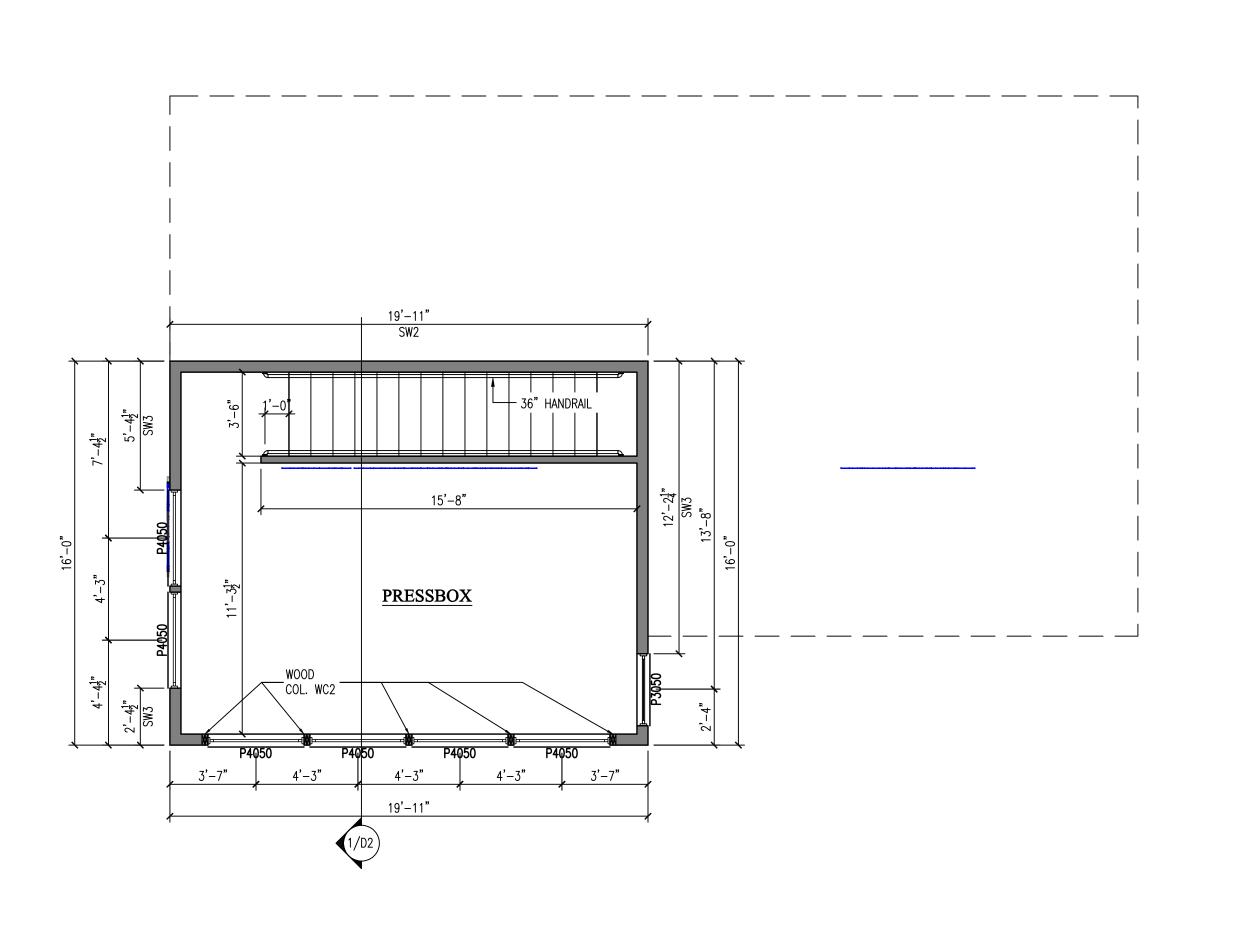



BASEBALL HOME DUGOUT-SECOND FLOOR PLAN
SCALE: 1/4" =1'-0"






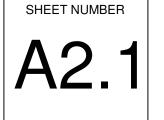


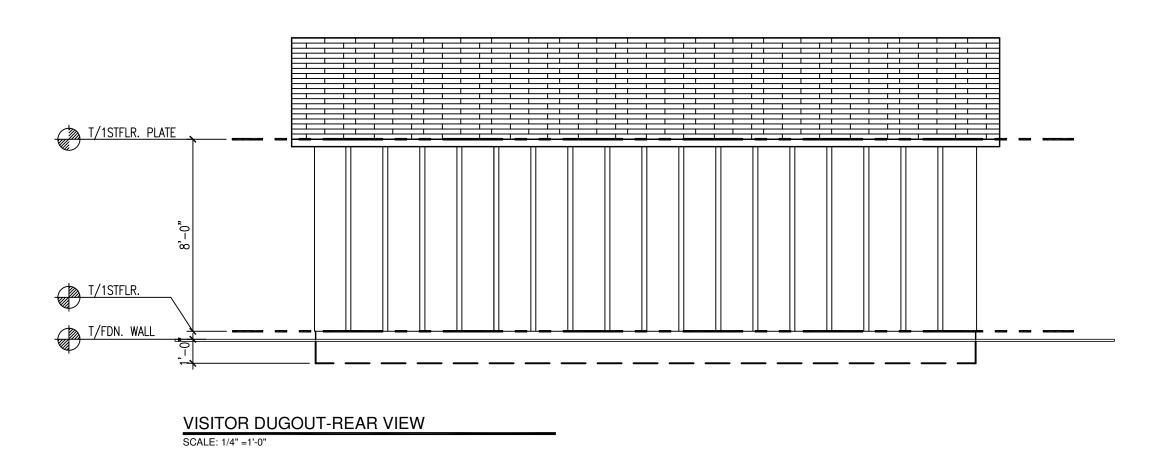

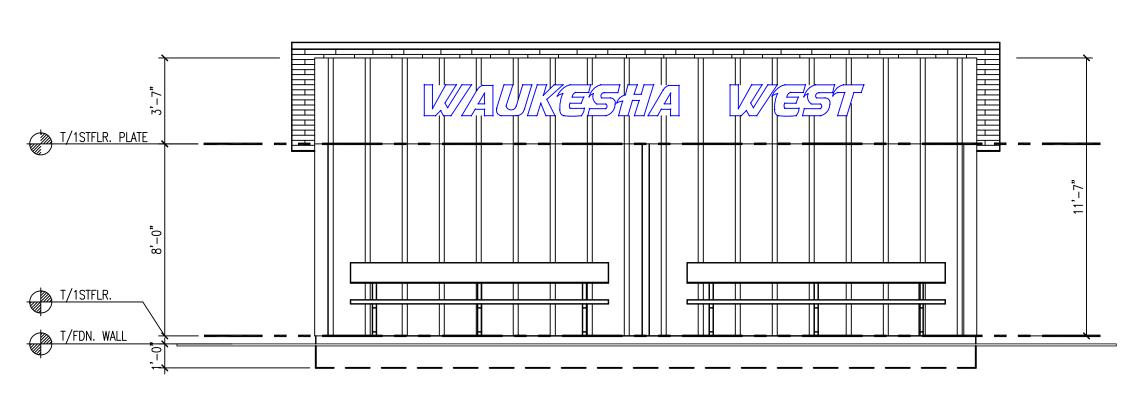




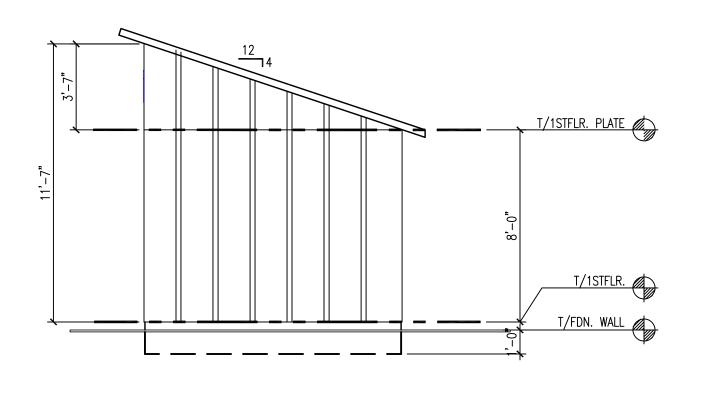


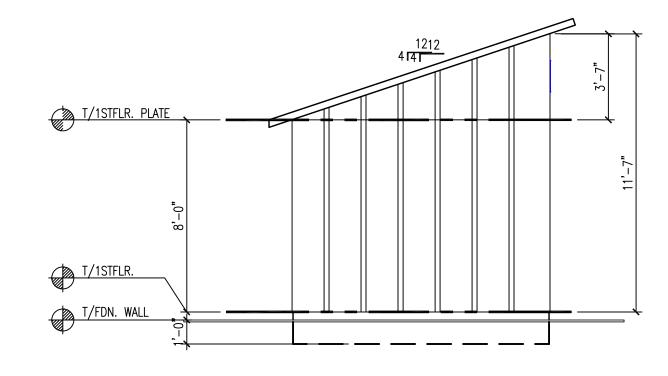

VISITOR DUGOUT-RIGHT VIEW




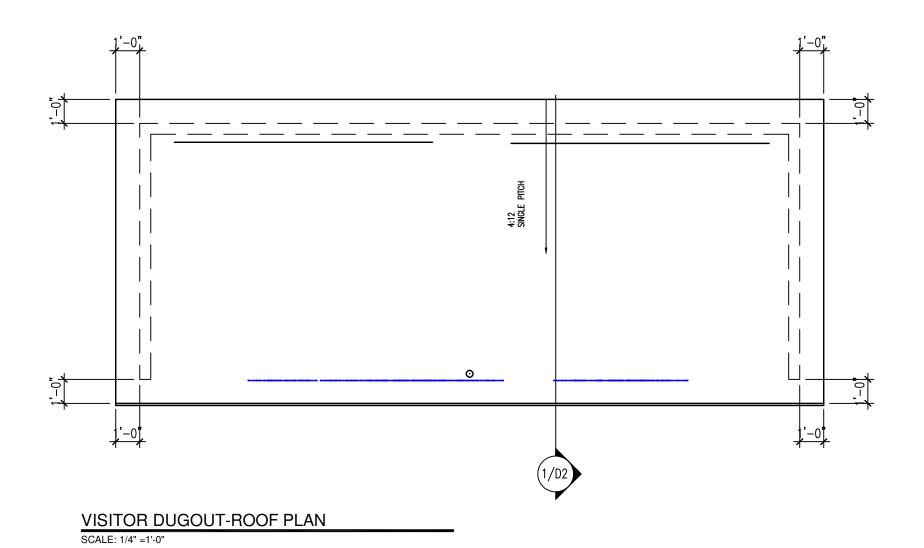


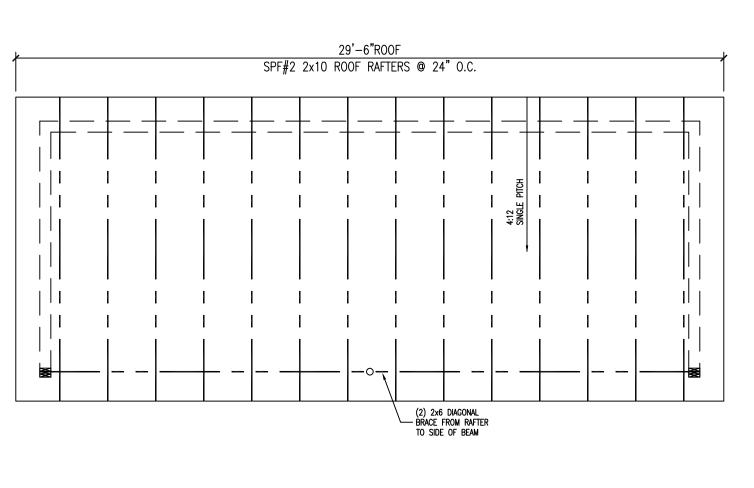

VISITOR DUGOUT-ROOF FRAMING

WAUKESHA WEST VISITOR DUGOUT-PERSPECTIVE SCALE: N.T.S.

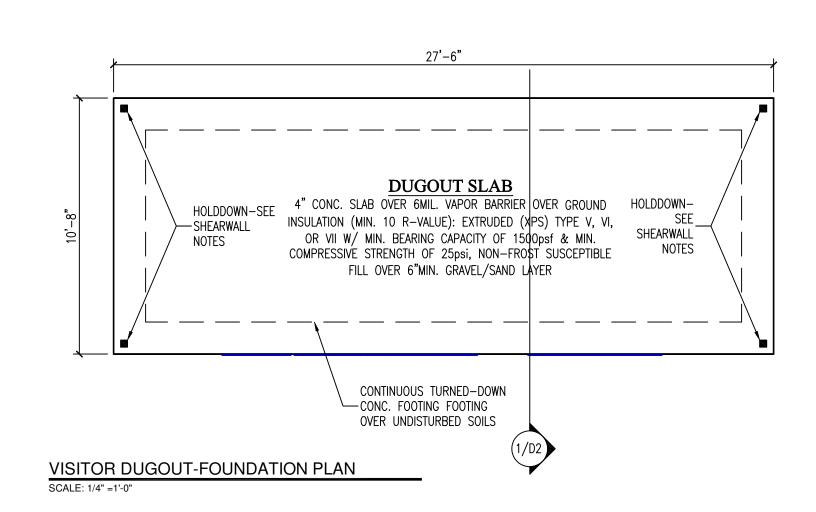

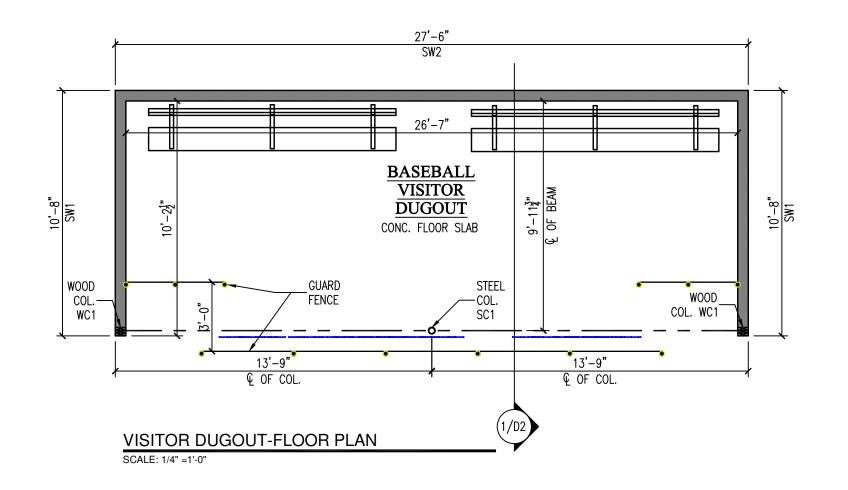

NOTES:

<u>COLUMNS</u>

- WC1: (3)2x6
- WC2: (2) 1/2"x5 1/2" W2, 1.3E
- SC1: PIPE 3 STD (3.50"x0.216") W/ SIMPSON LCC5.25-35 COLUMN CAP & 3/8" 10"x10" BNE PL W/ (4) 5/8" Ø SIMPSON TITEN ND ANCHORS, 4" EMBEDDED GALVANIZE ALL EXPOSED STEEL

<u>SHEARWALLS</u>


- SW1: 7/16" OSB OR PLYWOOD SHEATHING FASTENED WITH 8d NAILS @ 6" OC ALONG ALL PANEL EDGES & 12" OC IN THE FIELD. PROVIDE BLOCKING AT ALL PANEL JOINTS. PROVIDE SIMPSON HDU4-SDS2.5 HOLDDOWN EACH END WITH 5/8" DIAMETER A36 THREADED ROD EPOXIED INTO FOUNDATION WITH HILTI HIT-HY 200 ADHESIVE, MIN 10"
- SW2: 7/16" OSB OR PLYWOOD SHEATHING FASTENED WITH 8d NAILS @ 6" OC ALONG ALL PANEL EDGES & 12" OC IN THE FIELD. PROVIDE BLOCKING AT ALL PANEL JOINTS. PROVIDE SIMPSON DTT2Z HOLDDOWN EACH END WITH 1/2" DIAMETER A36 THREADED ROD EPOXIED INTO FOUNDATION WITH HILTI HIT-HY 200 ADHESIVE, MIN 8" EMBED.
- SW3: 7/16" OSB OR PLYWOOD SHEATHING FASTENED WITH 8d NAILS @ 4" OC ALONG ALL PANEL EDGES & 12" OC IN THE FIELD. PROVIDE BLOCKING AT ALL PANEL JOINTS. PROVIDE SIMPSON CMST16 X 62" LONG HOLDDOWN STRAP EACH END OF WALL WITH (58) 16d SINKER NAILS.
- SW4: 7/16" OSB OR PLYWOOD SHEATHING FASTENED WITH 8d NAILS @ 4" OC ALONG ALL PANEL EDGES & 12" OC IN THE FIELD ON BOTH SIDES OF WALL. PROVIDE BLOCKING AT ALL PANEL JOINTS. PROVIDE SIMPSON HDU11-SDS2.5 HOLDDOWN EACH END WITH 1" DIAMETER A36 THREADED ROD EPOXIED INTO FOUNDATION WITH HILTI HIT-HY 200 ADHESIVE, MIN 12" EMBED.


NOTE: GUARD FENCE NOT SHOWN ON **ELEVATIONS FOR CLARIFICATION**





JOB NUMBER WW DUGOUT


SHEET NUMBER

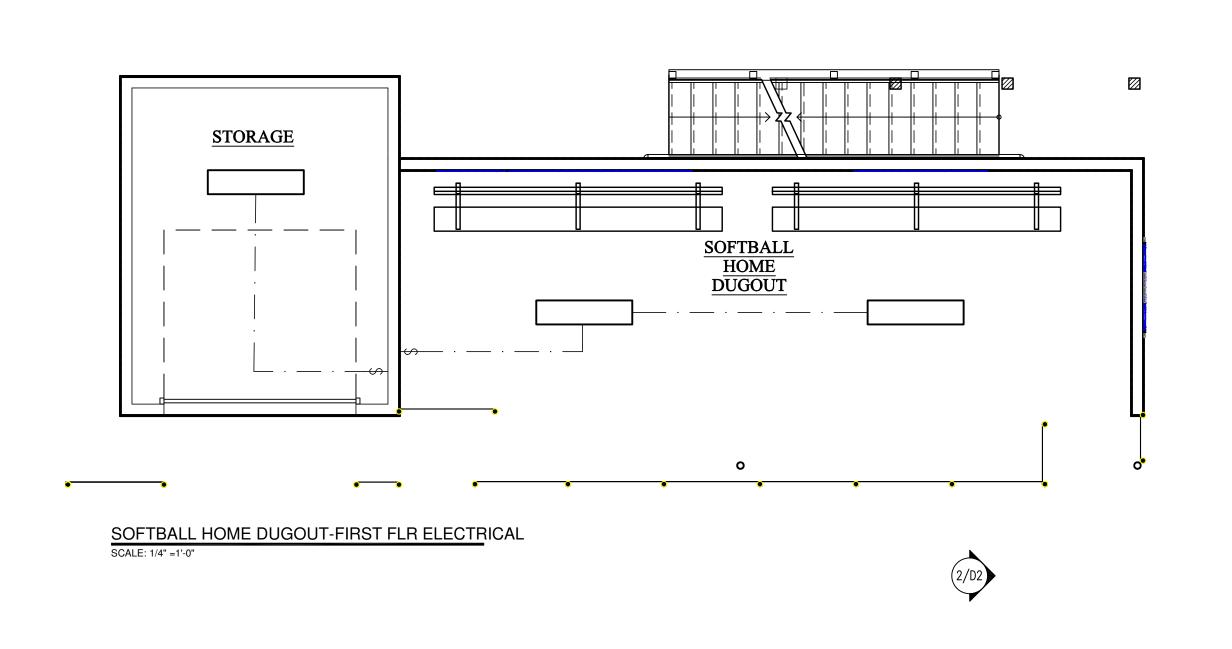


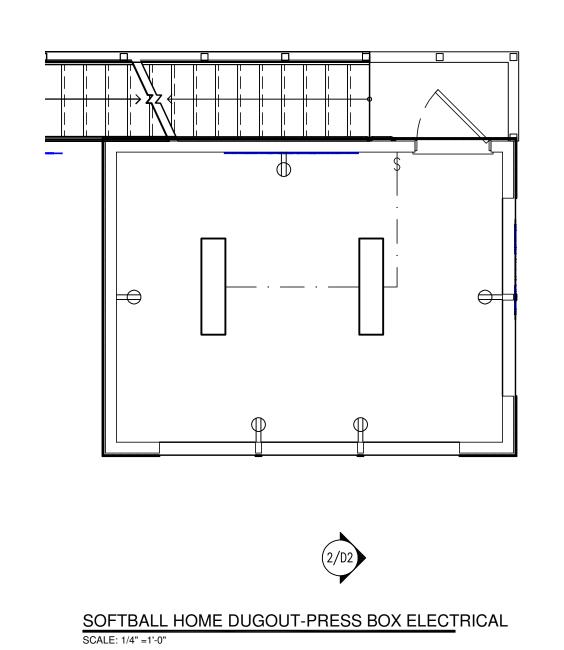

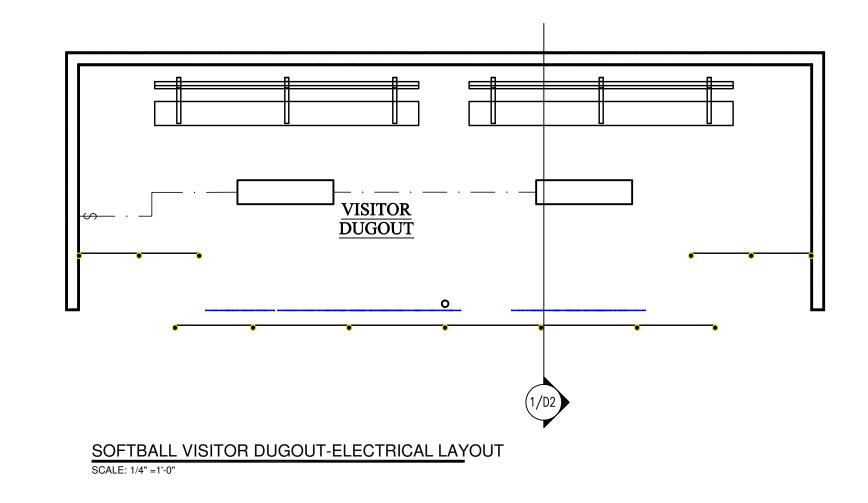

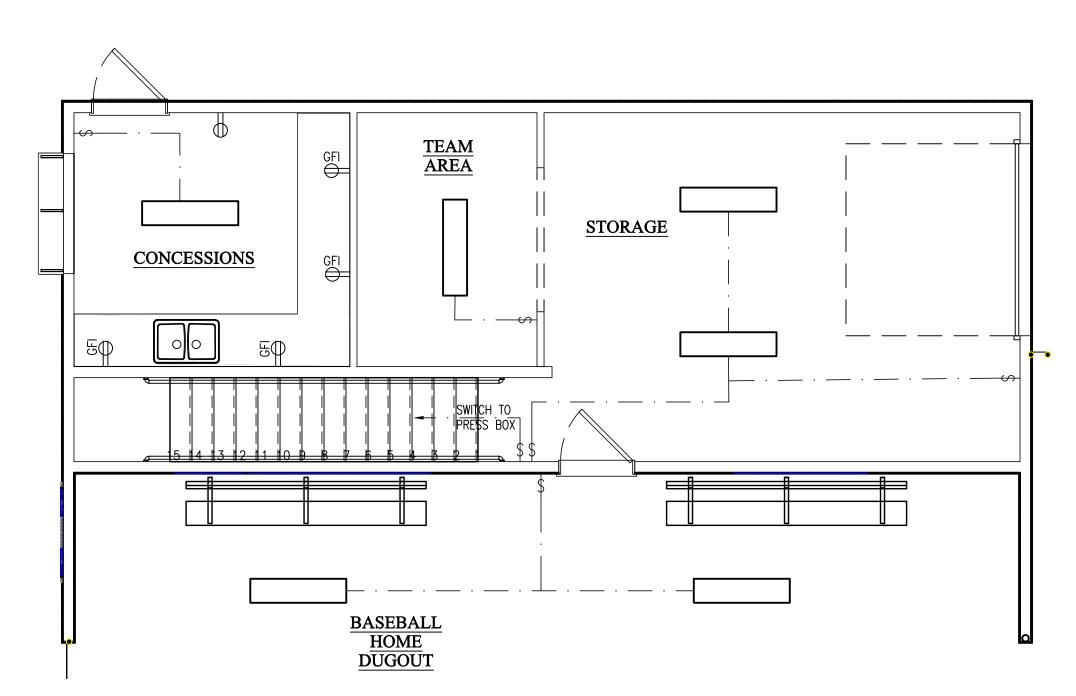


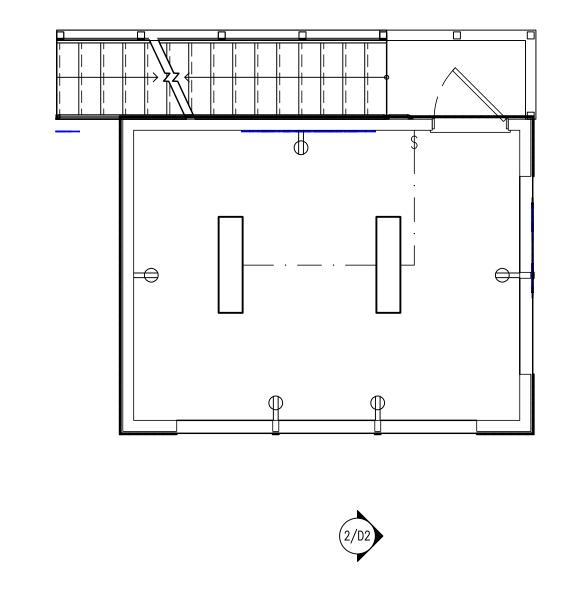


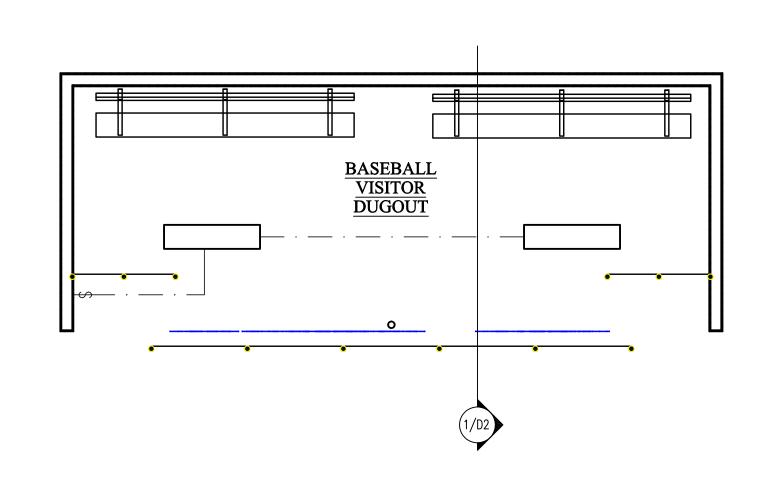

SOFTBALL HOME DUGOUT-FIRST FLR ELECTRICAL SCALE: 1/4" =1'-0"



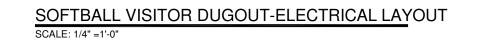

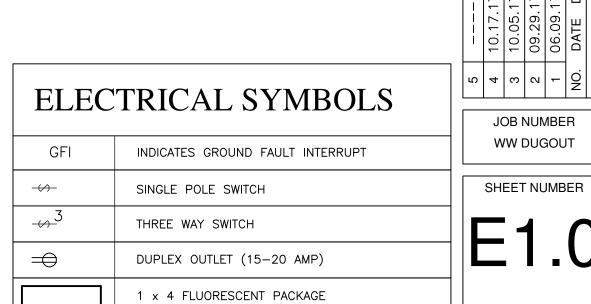


JOB NUMBER WW DUGOUT


SHEET NUMBER


SINGLE STORY WOOD FRAME WALL TYPICAL WALL SECTION 1/2" = 1'-0"


5/8" OSB/ PLYWOOD SHEATHING —— W/ SIMPSON PSC SHEATHING CLIPS WOOD ROOF RAFTERS BY OTHERS SEE STRUCTURAL ----SIMPSON HTS20 STRAP (BOTH SIDES - INTERIOR/EXTERIOR) SIMPSON ---STRONG-TIE H3 METAL DRIP EDGE -2x12 ALUMINUM WRAPPED 📇 FASCIA BOARDS — 2x6 DOUBLE TOP PLATE ALUMINUM SOFFIT W/ INTEGRATED SOFFIT VENT -HEADER BY OTHERS (SEE STRUCTURAL) BOARD AND BATTEN $\frac{7}{16}$ " EXTERIOR MIRATEC SIDING -- GRADE PLYWOOD 7 OSB SHEATHING_ 2x6 SPF STUD GRADE OR BETTER STUDS @ 24" O.C. —— 2x6 TREATED SILL PLATE W/ $\frac{1}{2}$ " ϕ ANCHOR BOLTS AS REQUIRED (MAX. SPACING 48" 4" REINFORCED CONCRETE SLAB & WITHIN 12" OF CORNERS) ___ GROUND INSULATION (MIN. 10 R-VALUE): EXTRUDED (XPS) TYPE V, VI, OR VII W/ MIN. BEARING CAPACITY OF 1200psf MIN._ 63" MIN. EXTENSION 174"

ENTIRE PERIMETER OF BUILDING MIN. (2)#5 HORIZONTAL BAR TOP & BOT. (MIN. 3" COVER BOT. & SIDES) 16"x16" CONTINUOUS TURNED-DOWN CONC. FOOTING FOOTING OVER UNDISTURBED SOILS — 6x6 #10 WWR_ NON-FROST SUSCEPTIBLE FILL -6" MIN. GRAVEL/SAND LAYER. UNDISTURBED SOILS-

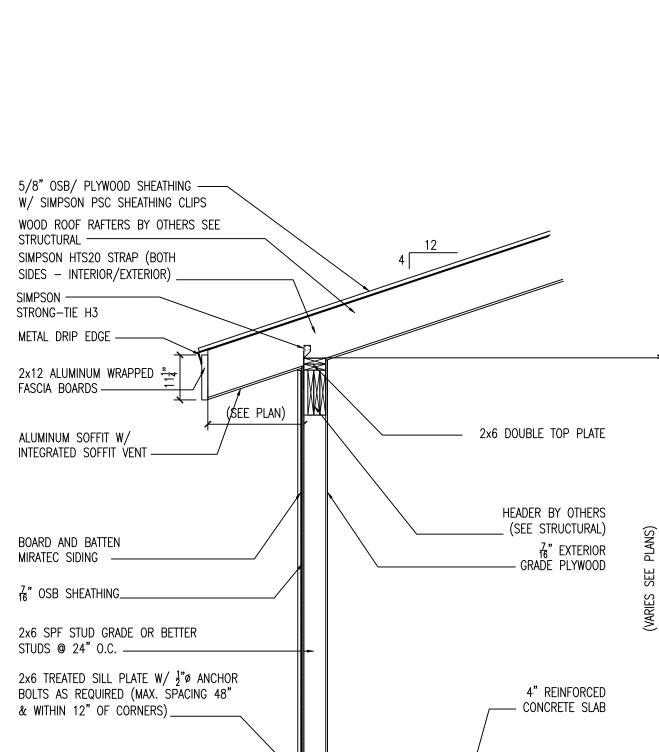

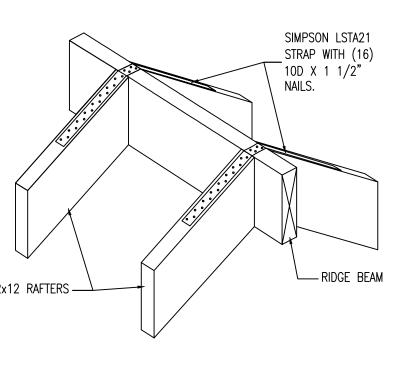

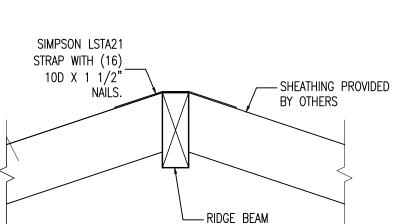

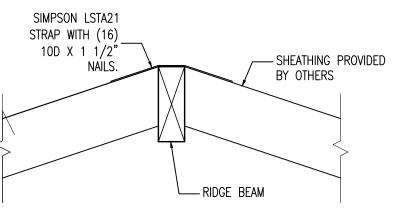

RAFTER TO RIDGE BEAM

TYPICAL DETAIL

5/8" OSB/ PLYWOOD SHEATHING — W/ SIMPSON PSC SHEATHING CLIPS

WOOD ROOF RAFTERS BY OTHERS

SIMPSON HTS20 STRAP (BOTH SIDES - INTERIOR/EXTERIOR) -

2x12 ALUMINUM WRAPPED FASCIA BOARDS

ALUMINUM SOFFIT W/ INTEGRATED SOFFIT VENT —

2x6 SPF STUD GRADE OR BETTER

STUDS @ 24" O.C. ——

2x12 RIM JOIST ——

BOARD AND BATTEN

7 OSB SHEATHING_

2x6 SPF STUD GRADE OR BETTER STUDS @ 16" O.C. —

& WITHIN 12" OF CORNERS) ____

GROUND INSULATION (MIN. 10 R-VALUE):

EXTRUDED (XPS) TYPE V, VI, OR VII W/ MIN. BEARING CAPACITY OF 1200psf MIN._

(2)#5 HORIZONTAL BAR TOP & BOT. (MIN. 3" COVER BOT. & SIDES)_____

16"x16" CONTINUOUS
TURNED-DOWN CONC. FOOTING
FOOTING OVER UNDISTURBED SOILS ——

TWO STORY WOOD FRAME WALL

1/2" = 1'-0"

NON-FROST SUSCEPTIBLE FILL -

6" MIN. GRAVEL/SAND LAYER.

UNDISTURBED SOILS -

6x6 #10 WWR _

63" MIN. EXTENSION 1'-4"

ENTIRE PERIMETER OF BUILDING MIN.

TYPICAL WALL SECTION

2x6 TREATED SILL PLATE W/ $\frac{1}{2}$ " ϕ ANCHOR BOLTS AS REQUIRED (MAX. SPACING 48"


MIRATEC SIDING -


SEE STRUCTURAL —

SIMPSON ----

STRONG-TIE H3

METAL DRIP EDGE -

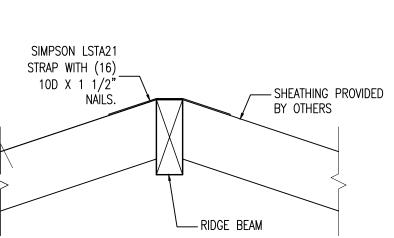

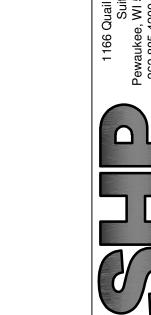

2x6 DOUBLE TOP PLATE

HEADER BY OTHERS _ (SEE STRUCTURAL)

7" EXTERIOR GRADE PLYWOOD


— 2x12 FLOOR JOISTS

— 2x6 DOUBLE TOP PLATE

7" EXTERIOR — GRADE PLYWOOD

4" REINFORCED

—— CONCRETE SLAB

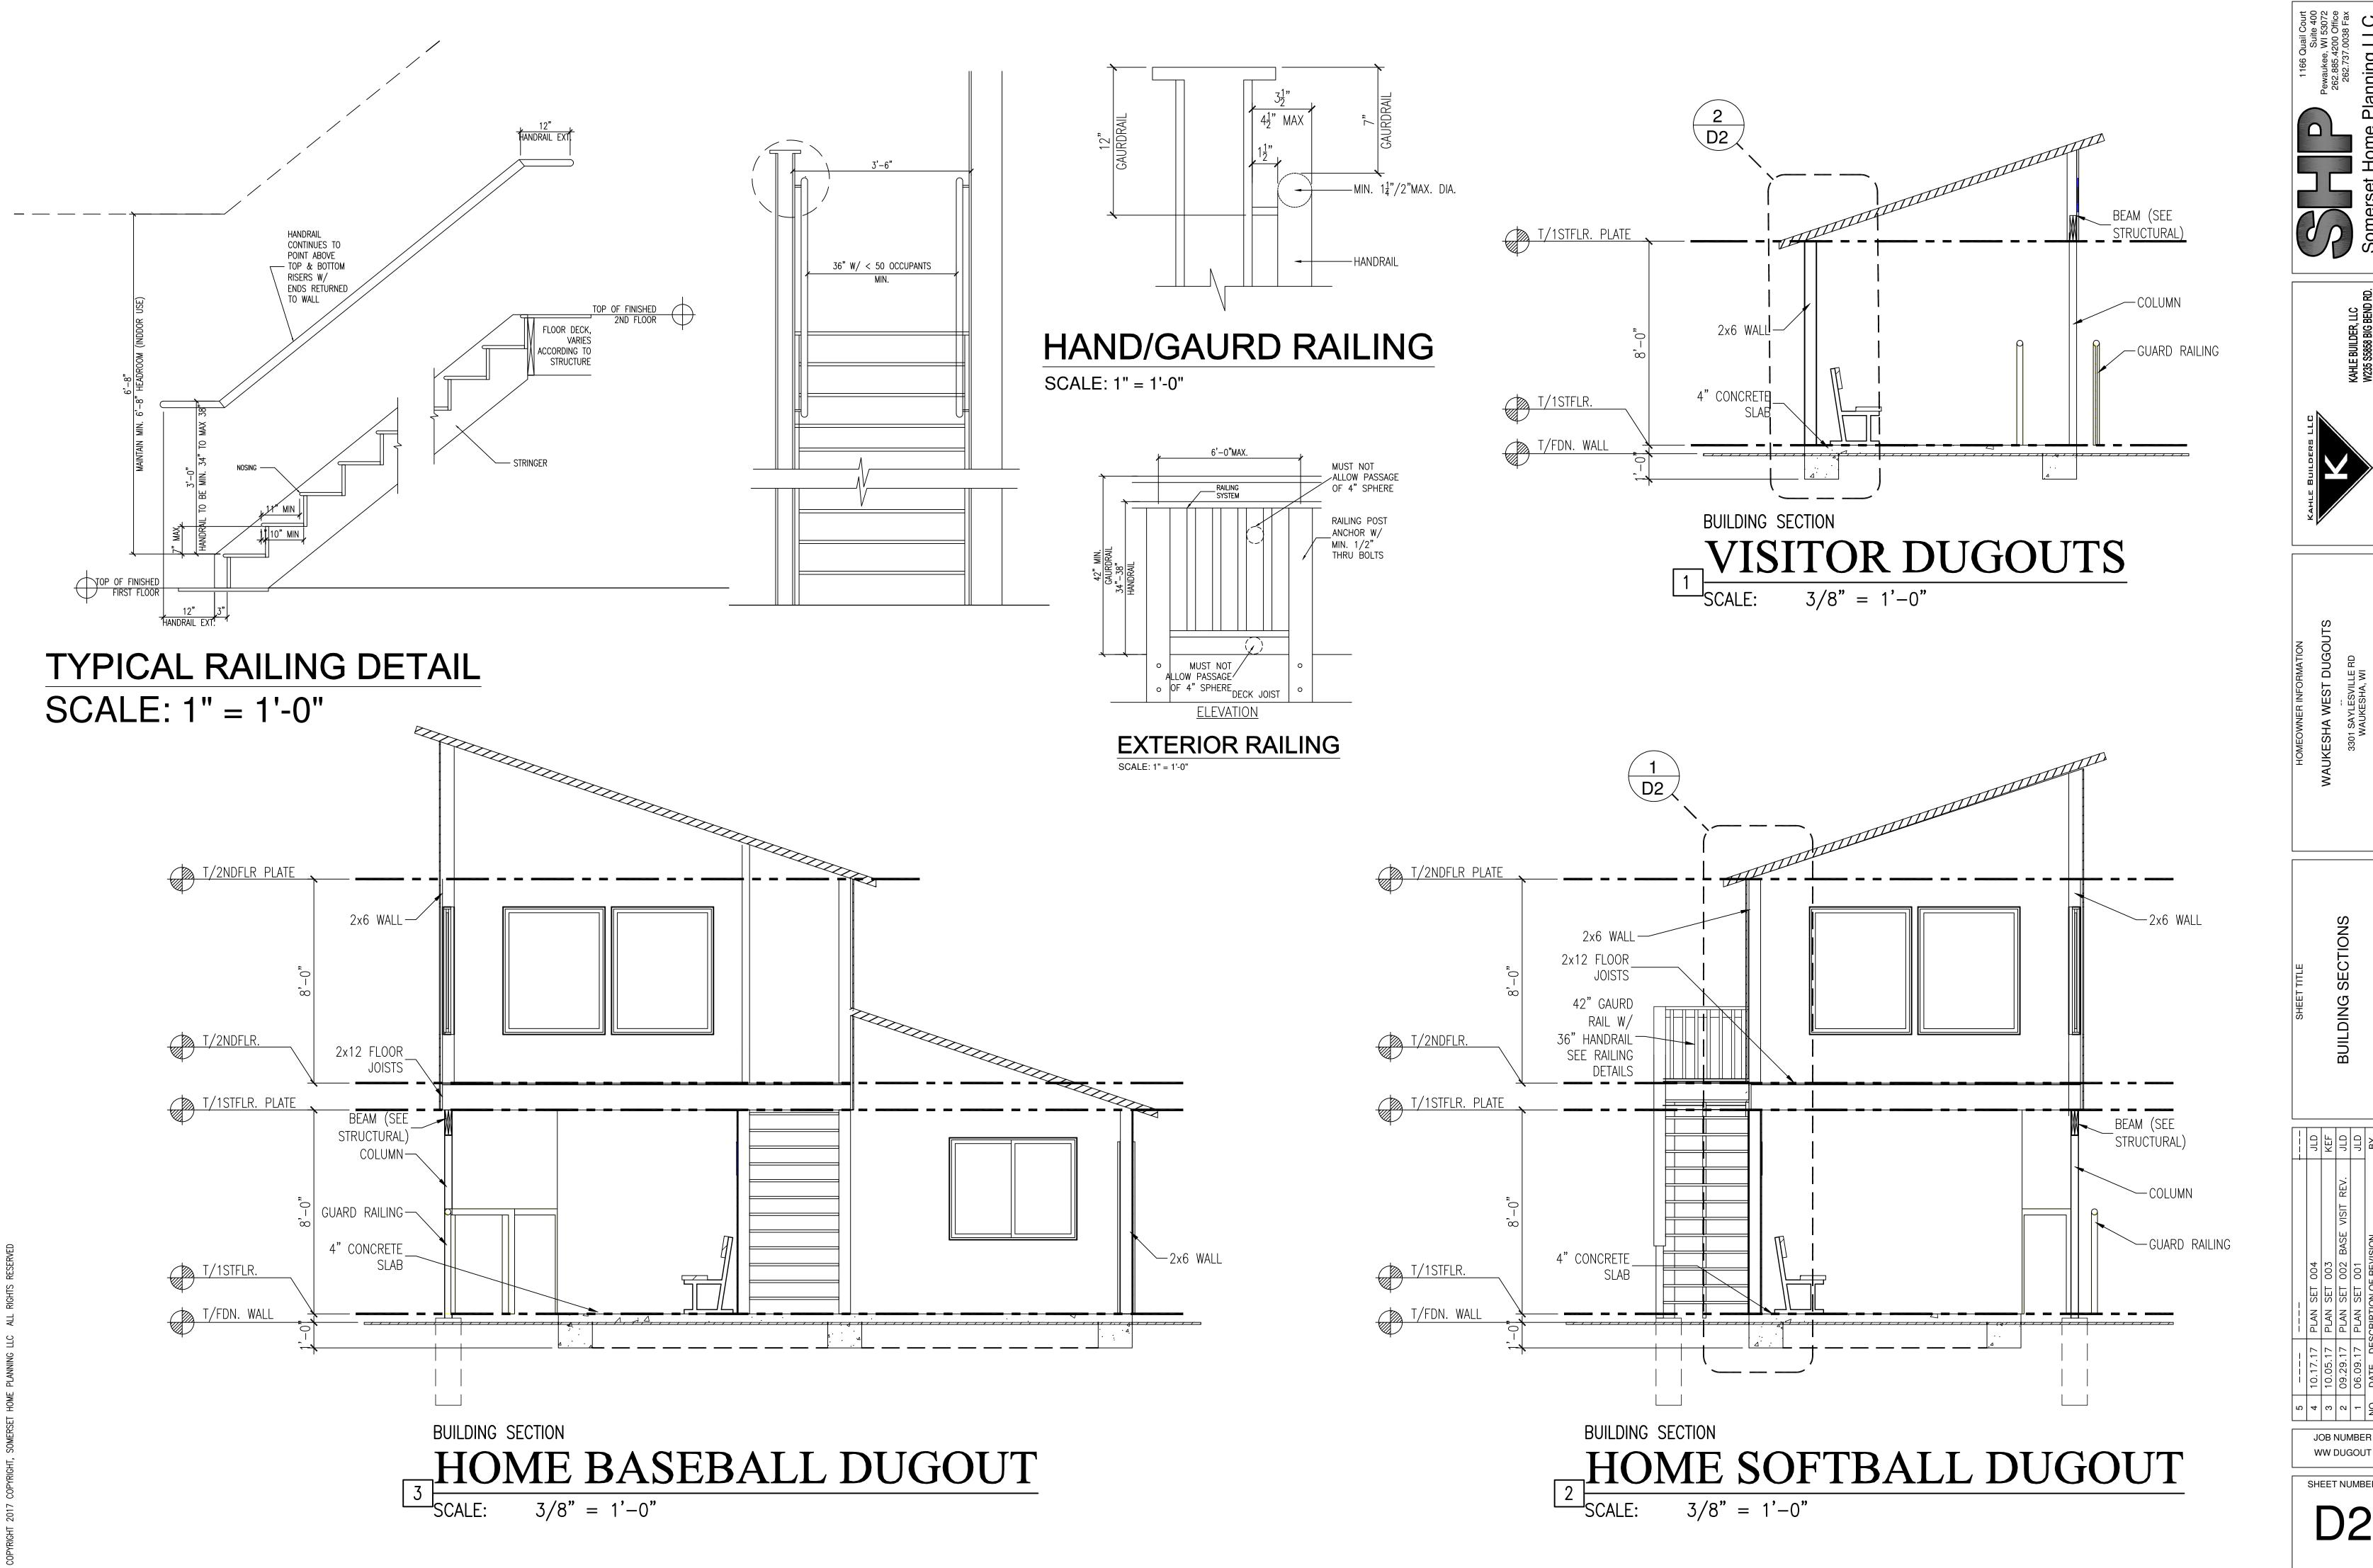

JOB NUMBER

SHEET NUMBER **D2**