



- 1. Contractor responsible for contacting Diggers Hotline (811 or 800-242-8511) to have site marked prior to excavation or planting.
- 2. Contractor to verify all plant quantities shown on Plant & Material List and landscape planting symbols and report any discrepancies to Landscape Architect or General Contractor.
- 3. All plantings shall comply with standards as described in American Standard of Nursery Stock Z60.1 ANSI (latest version). Landscape Architect reserves the right to inspect, and potentially reject any plants that are inferior, compromised, undersized, diseased, improperly transported, installed incorrectly or damaged. No sub-standard "B Grade" or "Park Grade" plant material shall be accepted. Plant material shall originate from nursery(ies) with a similar climate as the planting site.
- 4. Any potential plant substitutions must be approved by Landscape Architect or Owner. All plants must be installed as per sizes indicated on Plant & Material Schedule, unless approved by Landscape Architect. Any changes to sizes shown on plan must be submitted in writing to the Landscape Architect prior to
- 5. Topspoil in Parking Lot Islands (if applicable): All parking lot islands to be backfilled with topsoil to a minimum depth of 18" to insure long-term plant health. Topsoil should be placed within 3" of finish grade by General Contractor / Excavation Contractor during rough grading operations/activity. The landscape contractor shall be responsible for the fine grading of all disturbed areas, planting bed areas, and lawn areas. Crown all parking lot islands a minimum of 6" to provide proper drainage, unless otherwise specified.
- 6. Tree Planting: Plant all trees slightly higher than finished grade at the root flare. Remove excess soil from the top of the root ball, if needed. Remove and discard non-biodegradable ball wrapping and support wire. Removed biodegradable burlap and wire cage (if present) from the top  $\frac{1}{3}$  of the rootball and carefully bend remaining wire down to the bottom of the hole. Once the tree has been placed into the hole and will no longer be moved, score the remaining  $\frac{2}{3}$  of the burlap and remove the twine. Provide one slow release fertilizer packets (per 1" caliper) for each tree planted.
- 7. Tree Planting: Backfill tree planting holes 80% existing soils removed from excavation and 20% Soil Amendments (see Note 11). Avoid air pockets and do not tamp soil down. Discard any gravel, rocks, heavy clay, or concrete pieces. When hole is  $\frac{2}{3}$  full, trees shall be watered thoroughly, and water left to soak in before proceeding to fill the remainder of the hole. Water again to full soak in the new planting. Each tree shall receive a 3" deep, 4-5' diameter (see planting details or planting plan) shredded hardwood bark mulch ring / saucer around all trees. Do not build up any mulch onto the trunk of any tree. Trees that are installed incorrectly will be replaced at the time and expense of the Landscape Contractor.
- 8. Shrub Planting: All shrubs to be planted in groupings as indicated on the Landscape Plan. Install with the planting of shrubs a 50/50 mix of Soil Amendments with blended, pulverized topsoil. Install topsoil into all plant beds as needed to achieve proper grade and displace undesirable soils (see planting detail). Remove all excessive gravel, clay and stones from plant beds prior to planting. When hole(s) are  $\frac{2}{3}$  full, shrubs shall be watered thoroughly, and water left to soak in before proceeding. Provide slow-release fertilizer packets at the rater of 1 per 24" height/diamter of shrub at planting.
- 9. Mulching: All tree rings to receive a 3" deep layer of high quality shredded hardwood bark mulch (not pigment dyed or enviro-mulch). All shrub planting and perennial planting bed areas (groupings) shall receive a 2-3" layer of shredded hardwood bark mulch, and groundcover areas a 1-2" layer of the same mulch. Do not mulch annual flower beds (if applicable). Do not allow mulch to contact plant stems and tree trunks.
- 10. Edging: All planting beds shall be edged with a 4" deep spade edge using a flat landscape spade or a mechanical edger. Bedlines are to be cut crisp, smooth as per plan. A clean definition between landscape beds and lawn is required. Pack mulch against lawn edge to hold in place.
- 11. Plant bed preparation/Soil Amendment composition: All perennial, groundcover and annual areas (if applicable) are required to receive a blend of organic soil (Soil Amendments) amendments prior to installation. Roto-till the following materials at the following ratio, into existing soil beds or installed topsoil beds to a depth of approximately 8"-10". Containerized and balled & burlapped plant material should be back-filled with amended soil:

Per 100 SF of bed area (Soil Amendment composition):

3/4 CY Peat Moss or Mushroom Compost

3/4 CY blended/pulverized Topsoil ½ CY composted manure

In roto-tilled beds only, also include in above mixture:

2 lbs Starter Fertilizer

12. Installation preparation for all seeded areas: remove/kill off any existing unwanted vegetation prior to seeding. Prepare the topsoil (if adequate or provide as in item #6 above) and seed bed by removing all surface stones 1" or larger. Apply a starter fertilizer (20-10-5, or approved comparable) and specified seed uniformly at the specified rate, and provide mulch covering suitable to germinate and establish turf. Provide seed and fertilizer specifications to Landscape Architect and Owner prior to installation. Erosion control measures are to be used in swales and on slopes in excess of 1:3 and where applicable (see Civil Engineering Drawings). Methods of installation may vary are the discretion of the Landscape Contractor on his/her responsibility to establish and guarantee a smooth, uniform, quality turf. A minimum of 2" of blended, prepared and non-compacted topsoil is required for all lawn areas. If straw mulch is used as a mulch covering, a tackifier may be necessary to avoid wind dispersal of mulch covering. Marsh hay containing reed canary grass is NOT acceptable as a mulch covering.

An acceptable quality seed installation is defined as having:


No bare spots larger than one (1) square foot

No more than 10% of the total area with bare areas larger than one (1) square foot

A uniform coverage through all turf areas

- 13. Warranty and Replacements: All plantings are to be watered thoroughly at the time of planting, through construction and upon completion of project as required. Trees, Evergreens, and Shrubs (deciduous and evergreen) shall be guaranteed (100% replacement) for a minimum of one (1) year from the date of project completion. Perennials, groundcovers, and ornamental grasses shall be guaranteed for a minimum of one (1) growing season. Perennials, groundcovers, and ornamental grasses planted after September 15th shall be guaranteed through May 31st of the following year. Only one replacement per plant will be required during the warranty period, except for losses or replacements due to failure to comply with specified requirements. Watering and general ongoing maintenance instructions are to be supplied by the Landscape Contractor to the Owner upon completion of the project.
- 14. The Landscape Contractor is responsible for the watering and maintenance of all landscape areas for a period of 45 days after the substantial completion of the landscape installation. This shall include all trees, shrubs, evergreens, perennials, ornamental grasses, turf grass, no-mow grass, and native prairie seed mix / stormwater seed mix. Work also includes weeding, edging, mulching (only if required), fertilizing, trimming, sweeping up grass clippings, pruning and deadheading.
- 15. Project Completion: Landscape Contractor is responsible to conduct a final review of the project, upon completion, with the Landscape Architect, Client or Owner / Client Representative, and the General Contractor to answer questions, provide written care instructions for new plantings and turf, and insure that all specifications have been met.

LANDSCAPE GENERAL NOTES

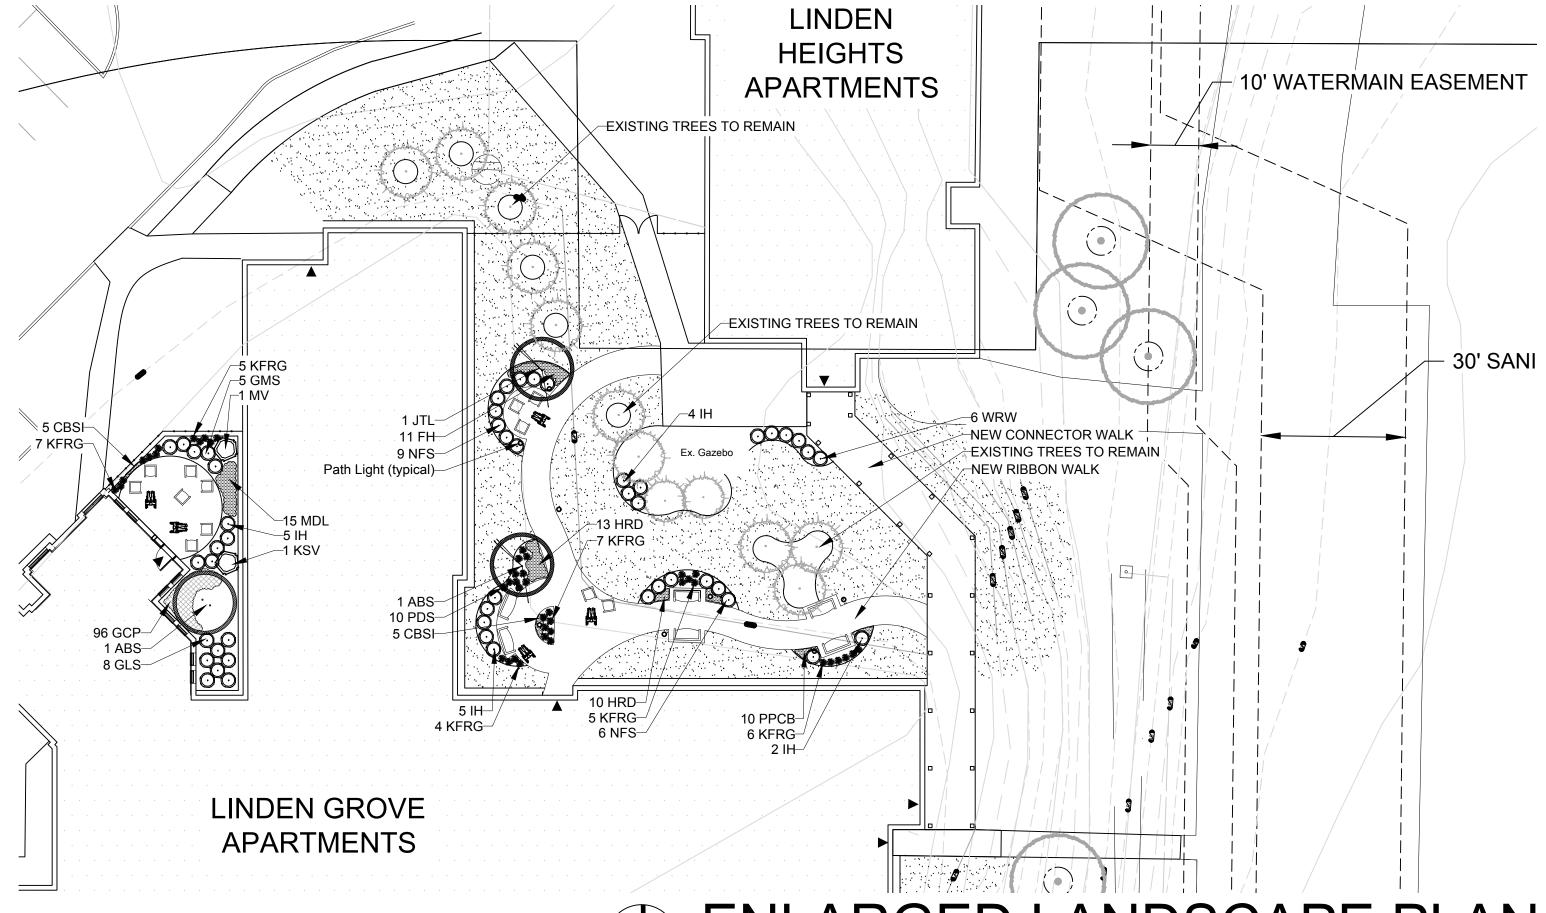

**PROJECT** 

## LINDEN GROVE **APARTMENTS**

425 N. University Drive Waukesha, WI, 53188

ISSUANCE AND REVISIONS

12.28.16 ISSUE TO OWNER

DATE DESCRIPTION

## ENLARGED LANDSCAPE PLAN

		N	ORTH Scale: 1" = 20'0"			
PLANT		PLANT MATERIAL PROPOSED		CALIPER/HEIGHT		
KEY	QUANTITY	BOTANICAL NAME	COMMON NAME	SIZE	ROOT	SPECIFICATION / NOTES
ORNAMENTAL TREES (DECIDUOUS)						
ABS	2	Amelanchier xgrandiflora 'Autumn Brilliance'	Autumn Brilliance Serviceberry	7-8'	B&B	Well balanced multi-stemmed tree with minimum four canes, and full appearance
JTL	1	Syringa reticulata 'Ivory Silk'	Ivory Silk Japanese Tree Lilac	2.25"	B&B	Straight central leader, full and even crown. Prune only after planting
PLANT		PLANT MATERIAL PROPOSED		SHRUB	ROOT/	
KEY	QUANTITY	BOTANICAL NAME	COMMON NAME	SIZE (HEIGHT)	CONT.	SPECIFICATION / NOTES
DECIDUOUS SHRUBS						
IH	16	Hydrangea arborescens 'Abetwo'	Incrediball Hydrangea	#5	Cont.	Full, well rooted plant, evenly shaped
GLS	8	Rhus aromatica 'Gro-Low'	Gro Low Fragrant Sumac	#5	Cont.	Full, well rooted plant, evenly shaped
GMS	5	Spirea xbumalda 'Goldmound'	Goldmound Spirea	24"	Cont.	Full, well rooted plant, evenly shaped
NFS	15	Spirea xbumalda 'Neon Flash'	Neon Flash Spirea	24"	Cont.	Full, well rooted plant, evenly shaped
KSV	1	Viburnum carlesii	Fragrant Koreanspice Viburnum	36"	Cont.	Full, well rooted plant, evenly shaped
MV	1	Viburnum lantana 'Mohican'	Mohican Viburnum	42"	B&B	Full, well rounded plant with moist rootball and healthy appearance
WRW	6	Wiegela florida 'Wine & Roses'	Wine & Roses Compact Wiegela	24"	Cont.	Full, well rooted plant, evenly shaped
PLANT		PLANT MATERIAL PROPOSED		CONTAINER		
KEY	QUANTITY	BOTANICAL NAME	COMMON NAME	SIZE		SPECIFICATION / NOTES
ORNAMENTAL GRASSES						
KFRG	34	Calamagrostis acutiflora 'Karl Foerster'	Karl Foerster Feather Reed Grass	#1	Cont.	Full, well rooted plant
PDS	10	Sporobolus heterolepis	Prairie Dropseed	#1	Cont.	Full, well rooted plant
PLANT		PLANT MATERIAL PROPOSED		CONTAINER		
KEY	QUANTITY	BOTANICAL NAME	COMMON NAME	SIZE		SPECIFICATION / NOTES
HERBACEOUS PERENNIALS						
HRD	23	Hemerocallis 'Happy Returns'	Happy Returns Daylilly	#1	Cont.	Full, well rooted plant, evenly shaped
MDL	5	Hemerocallis 'Catherine Woodbury'	Catherine Woodbury Daylilly (Soft Pink)	#1	Cont.	Full, well rooted plant, evenly shaped; mix three (3) MDL varieties together randomly

CONTAINER

SIZE

and notations depicted therein-shall govern.

Hyperion Daylilly (Lemon Yellow)

Summer Wine Daylilly (Maroon)

Palace Purple Coralbells

Caesars' Brother Siberian Iris

Green Carpet Pachysandra

see plan for area delineation

irrigation / lighting access

10% Atlantis Kentucky Bluegrass

10% Dragon Kentucky Bluegrass

Francee Hosta

**COMMON NAME** 

2,000 SF

2,000 SF

7,310 SF

2,000 SF

Hemerocallis 'Hyperion'

Hosta fortunei 'Francee'

KEY QUANTITY | BOTANICAL NAME

PPCB

CBSI

PLANT

**GROUNDCOVERS & VINES** 

Hardscape Materials

Hemerocallis 'Summer Wine'

Iris sibirica 'Caesars' Brother'

Heuchera micrantha 'Palace Purple'

Pachysandra terminalis 'Green Carpet'

Lawn Establishment Area / Grading Area

Erosion Matting for sloped seeded areas

Shredded Hardwood Mulch (3" depth)

Pulverized Topsoil (2" over bed areas)

Cedar Creek Premium Blue Tag (Ph: 888-313-6807):

10% Mid Atlantic Kentucky Bluegrass

20% Pennant Fine Perennial Ryegrass

20% Merit Kentucky Bluegrass

Soil Amendments (2" depth)

2" PVC Sleeve

**Seed Compositions:** 

20% Boreal Red Fescue

Pulverized Topsoil (Lawn Area)

PLANT MATERIAL PROPOSED

Full, well rooted plant, evenly shaped; mix three (3) MDL varieties together randomly Full, well rooted plant, evenly shaped; mix three (3) MDL varieties together randomly Full, well rooted plant, evenly shaped; mix three (3) MDL varieties together randomly Information contained herein is based on survey information, field inspection, and believed to be accurate. SHEET TITLE **ENLARGED** LANDSCAPE Cedar Creek Premium Blue Tag Seed Mix (Ph: 888-313-6807) PLAN EroTex DS75 Erosion Control Blanket (or approved equal) Bark Mulch; apply Preemergent after installation of mulch

\*Landscape counts & quantities are provided as a service to the Landscape Contractor; Landscape Contractor is responsible for verifying these counts and quantities in order to provide a complete landscape installation as outlined on this Landscape Master Plan. In the event that a discrepancy occurs between this schedule and the Landscape Master Plan, the Landscape Master Plan including the graphics

PROJECT MANAGER WDH PROJECT NUMBER 16-144

12.28.16

SHEET NUMBER

DATE

10% Palmer III Fine Perennial Ryegrass

Full, well rooted plant, evenly shaped

Full, well rooted plant, evenly shaped

Full, well rooted plant, evenly shaped

Full, well rooted plant

Schedule 40 PVC

Seed at rate of 3# per 1000 SF

CY

**SPECIFICATION / NOTES** 

PLANT & MATERIAL SCHEDULE