



### **Location Map**

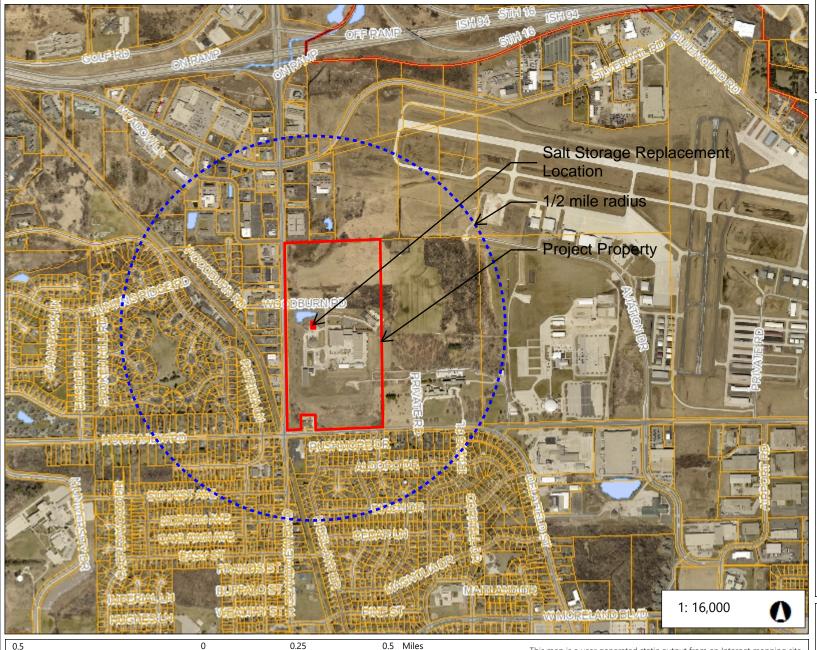

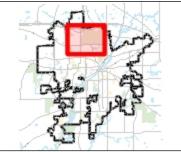

#### Legend

Parcels

Taxkey Labels

City Limits

Roads

+ Railroads

Water Bodies

Notes:

Print Date: 12/6/2024 City of Waukesha GIS This map is a user generated static output from an Internet mapping site and is for reference only. The data found on this site is considered to be correct, but should not be used for engineering or survey applications without verifying the information from officially recorded sources.

1641 WOODBURN ROAD

WAUKESHA, WI 53188

AY PROJECT NUMBER: 78290

SHEET INDEX:

**COVER SHEET** 

SITE SURVEY BY OTHERS, FOR REFERENCE ONLY EXISTING AND DEMOLITION SITE PLAN SITE LAYOUT AND UTILITY PLAN

SITE GRADING AND EROSION CONTROL PLAN COVER SHEET & SPECIFICATIONS FOOTING AND WALL PLAN CONCRETE DETAILS FOOTING REINFORCEMENT PLAN

G001

IMAGE FOR REFERENCE ONLY, NOT FOR CONSTRUCTION

EXTERIOR ELEVATIONS **BUILDING SECTIONS BUILDING SECTIONS** 

ELECTRICAL FIRST FLOOR ELECTRICAL PLAN ELECTRICAL SCHEDULES, DETAILS & ONE-LINE DIAGRAM

LOCATION MAP:

REGULATORY DATA:

BUILDING CODES: OVERALL BUILDING: 2015 INTERNATIONAL BUILDING CODE

2015 INTERNATIONAL FIRE CODE

2009 ANSI A117.1

GROUP S2 - LOW HAZARD STORAGE NON-SEPARATED USE

TYPE OF CONSTRUCTION:
TYPE V-B - COMBUSTIBLE UNPROTECTED CONSTRUCTION

FIRE PROTECTION SYSTEM:

**GENERAL BUILDING HEIGHT AND AREA** 

TOTAL MAXIMUM ALLOWABLE

MAXIMUM ALLOWABLE 2 STORIES (PER 504.5 IBC 2015)

MAXIMUM ALLOWABLE 40' - 0" (PER 504.3 IBC 2015)

PROJECT NOTES:

ALL SITE IMPROVEMENTS AND CONSTRUCTION SHOWN ON THE PLANS SHALL CONFORM TO THE CITY OF WAUKESHA DEVELOPMENT HANDBOOK & INFRASTRUCTURE SPECIFICATIONS. WHERE THE PLANS DO NOT COMPLY, IT SHALL BE THE SOLE RESPONSIBILITY AND EXPENSE OF THE DEVELOPER TO MAKE REVISIONS TO THE PLANS AND/OR CONSTRUCTED INFRASTRUCTURE TO

BENCHMARK IS LOCATED ON CHISELED SQUARE ON LIGHT POLE BASE DIRECTLY TO THE EAST OF THE NEW SALT SHED AS SHOWN ON SITE PLANS, ELEVATION 931.22

NO:	DESCRIPTION:	DATE:
1	BID / CONSTRUCTION	01/07/2025

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608.756.2326 www.angusyoung.com

**COVER SHEET** 

DETAILS IN THIS SET ARE PLACED ON THE SHEETS AND NUMBERED WITH RESPECT TO THE GRID ABOVE. CONSEQUENTLY, DETAILS ON A GIVEN SHEET MAY OR MAY NOT BE NUMBERED CONSECUTIVELY.

24 | 20 | 16 | 12 | 08 | 04 |

BRADLEY T. WERGINZ STOUGHTON

# PROJECT TEAM

WAUKESHA COUNTY - DPW 515 W. MORELAND BLVD. - RM G1 WAUKESHA, WI 53188


CONTACT: TY HIETPAS EMAIL: THIETPAS@WAUKESHACOUNTY.GOV

CONTACT: BRAD WERGINZ EMAIL: B.WERGINZ@ANGUSYOUNG.COM PHONE: 608-756-2326


PHONE: 262-548-7195

ARCHITECT: 555 SOUTH RIVER STREET JANESVILLE, WI 53548

G001

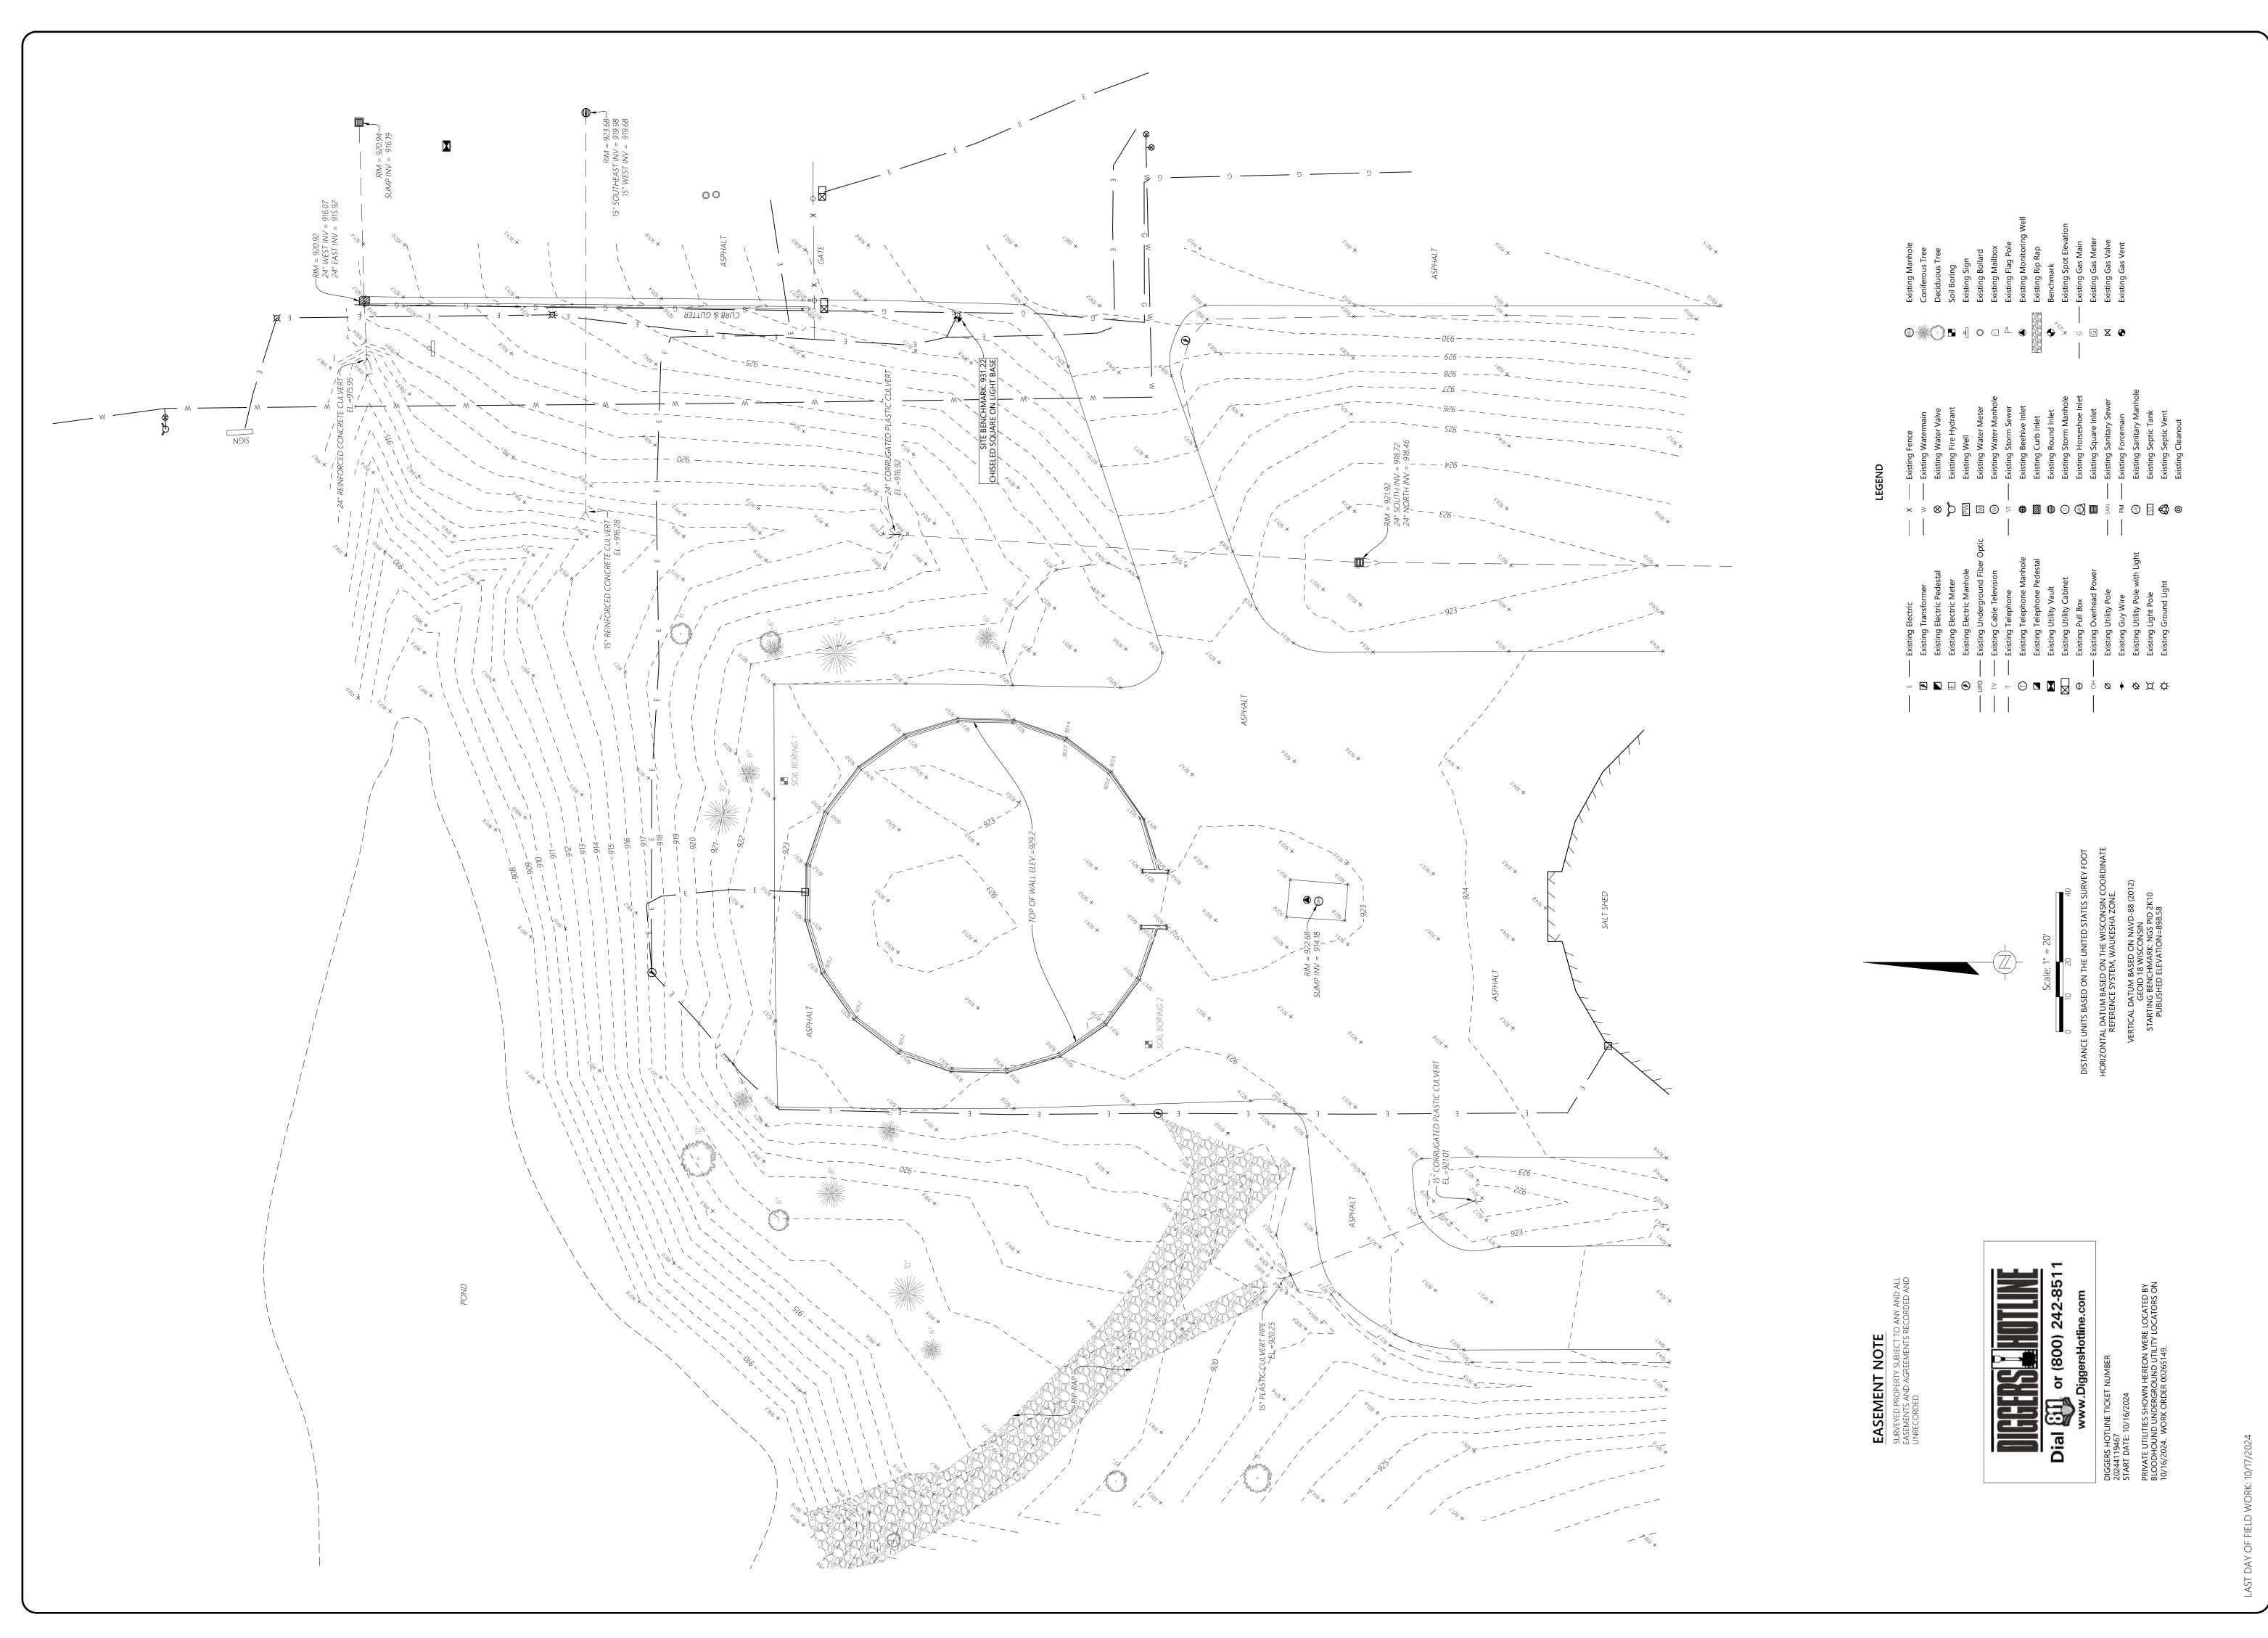

TOPOGRAPHIC EXISTING CONDITIONS

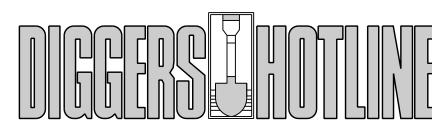

CALL TOLL FREE 1-800-242-8511 MILWAUKEE AREA 414-259-1181 FAX A LOCATE 1-800-338-3860 TDD (HEARING IMPAIRED) 1-800-542-2289 ONLINE: www.DiggersHotline.com

wisconsin statue 182.0175 (1974) REQUIRES A MINIMUM
of three (3) Working days notice prior to excavation.

SITE LINE LEGEND						
	PROPERTY LINE					
	SETBACK LINE					
	EASEMENT LINE					
xxx	EXISTING INTERMEDIATE CONTOUR					
	EXISTING INDEX CONTOUR					
xxx	NEW INTERMEDIATE CONTOUR					
xxx	NEW INDEX CONTOUR					
-	PAVEMENT					
××	FENCE					
	STORM DRAIN					
ss	SANITARY SEWER					
———— w ————	WATER					
G	GAS					
— Р —	ELECTRICAL POWER					
PU	UNDERGROUND ELECTRICAL POWER					
	UNDERGROUND FIBER OPTIC					
— т —	TELEPHONE					
——— ти ————	UNDERGROUND TELEPHONE					
CATV	CABLE					
~~~~~	EDGE OF TREES OR SHRUBS					

## NOTE: ALL LINE TYPES MAY NOT BE USED IN THIS SET.

SITE GENERAL NOTES

- TRUE NORTH MAY VARY FROM PROJECT NORTH.
   CONSTRUCTION PRACTICES, MEANS AND METHODS, AND JOB SITE SAFETY, SHALL REMAIN THE SOLE
- RESPONSIBILITY OF THE CONTRACTOR.

  3. ALL WORK SHALL BE PERFORMED IN COMPLIANCE WITH THE FEDERAL OCCUPATIONAL HEALTH AND SAFETY ADMINISTRATION (OSHA), AND ALL FEDERAL, STATE AND LOCAL CODES AND ORDINANCES AS THEY PERTAIN TO THIS PROJECT.
- FIELD VERIFY ALL EXISTING AND PROPOSED UTILITIES, ELEVATIONS AND DIMENSIONS.
   COORDINATE WITH THE AUTHORITY HAVING JURISDICTION AND UTILITY COMPANIES AS NECESSARY.
   ALL EXTERIOR CONCRETE SIDEWALKS AND YARD SLABS SHALL BE 4,000 PSI. ALL CONCRETE PAVEMENT SHALL BE 4,500 PSI UNLESS NOTED OTHERWISE.

KEYNOTES

SAWCUT AND REMOVE EXISTING PAVEMENT. PAVEMENT TO BE REPLACED, SEE SHEETS C100 AND C300 FOR ADDITIONAL INFORMATION. EXISTING STONE BASE TO REMAIN.

02 REMOVE EXISTING CONCRETE WALL AND FOUNDATION

03 INTERCEPT EXISTING POWER AND REMOVE EXISTING PANEL ON WALL

04 EXISTING GRAVEL TO BE REGRADED, SEE SHEET C300 FOR PROPOSED GRADES.

ANGUS-YOUNG ARCHITECTS/ENGINEERS Janesville | Madison

WAUKESHA COUNTY

SALT SHED REPLACEMENT

1641 WOODBURN ROAD WAUKESHA, WI 53188

ISSUANCES / REVISIONS NO: DESCRIPTION: 01 BID / CONSTRUCTION

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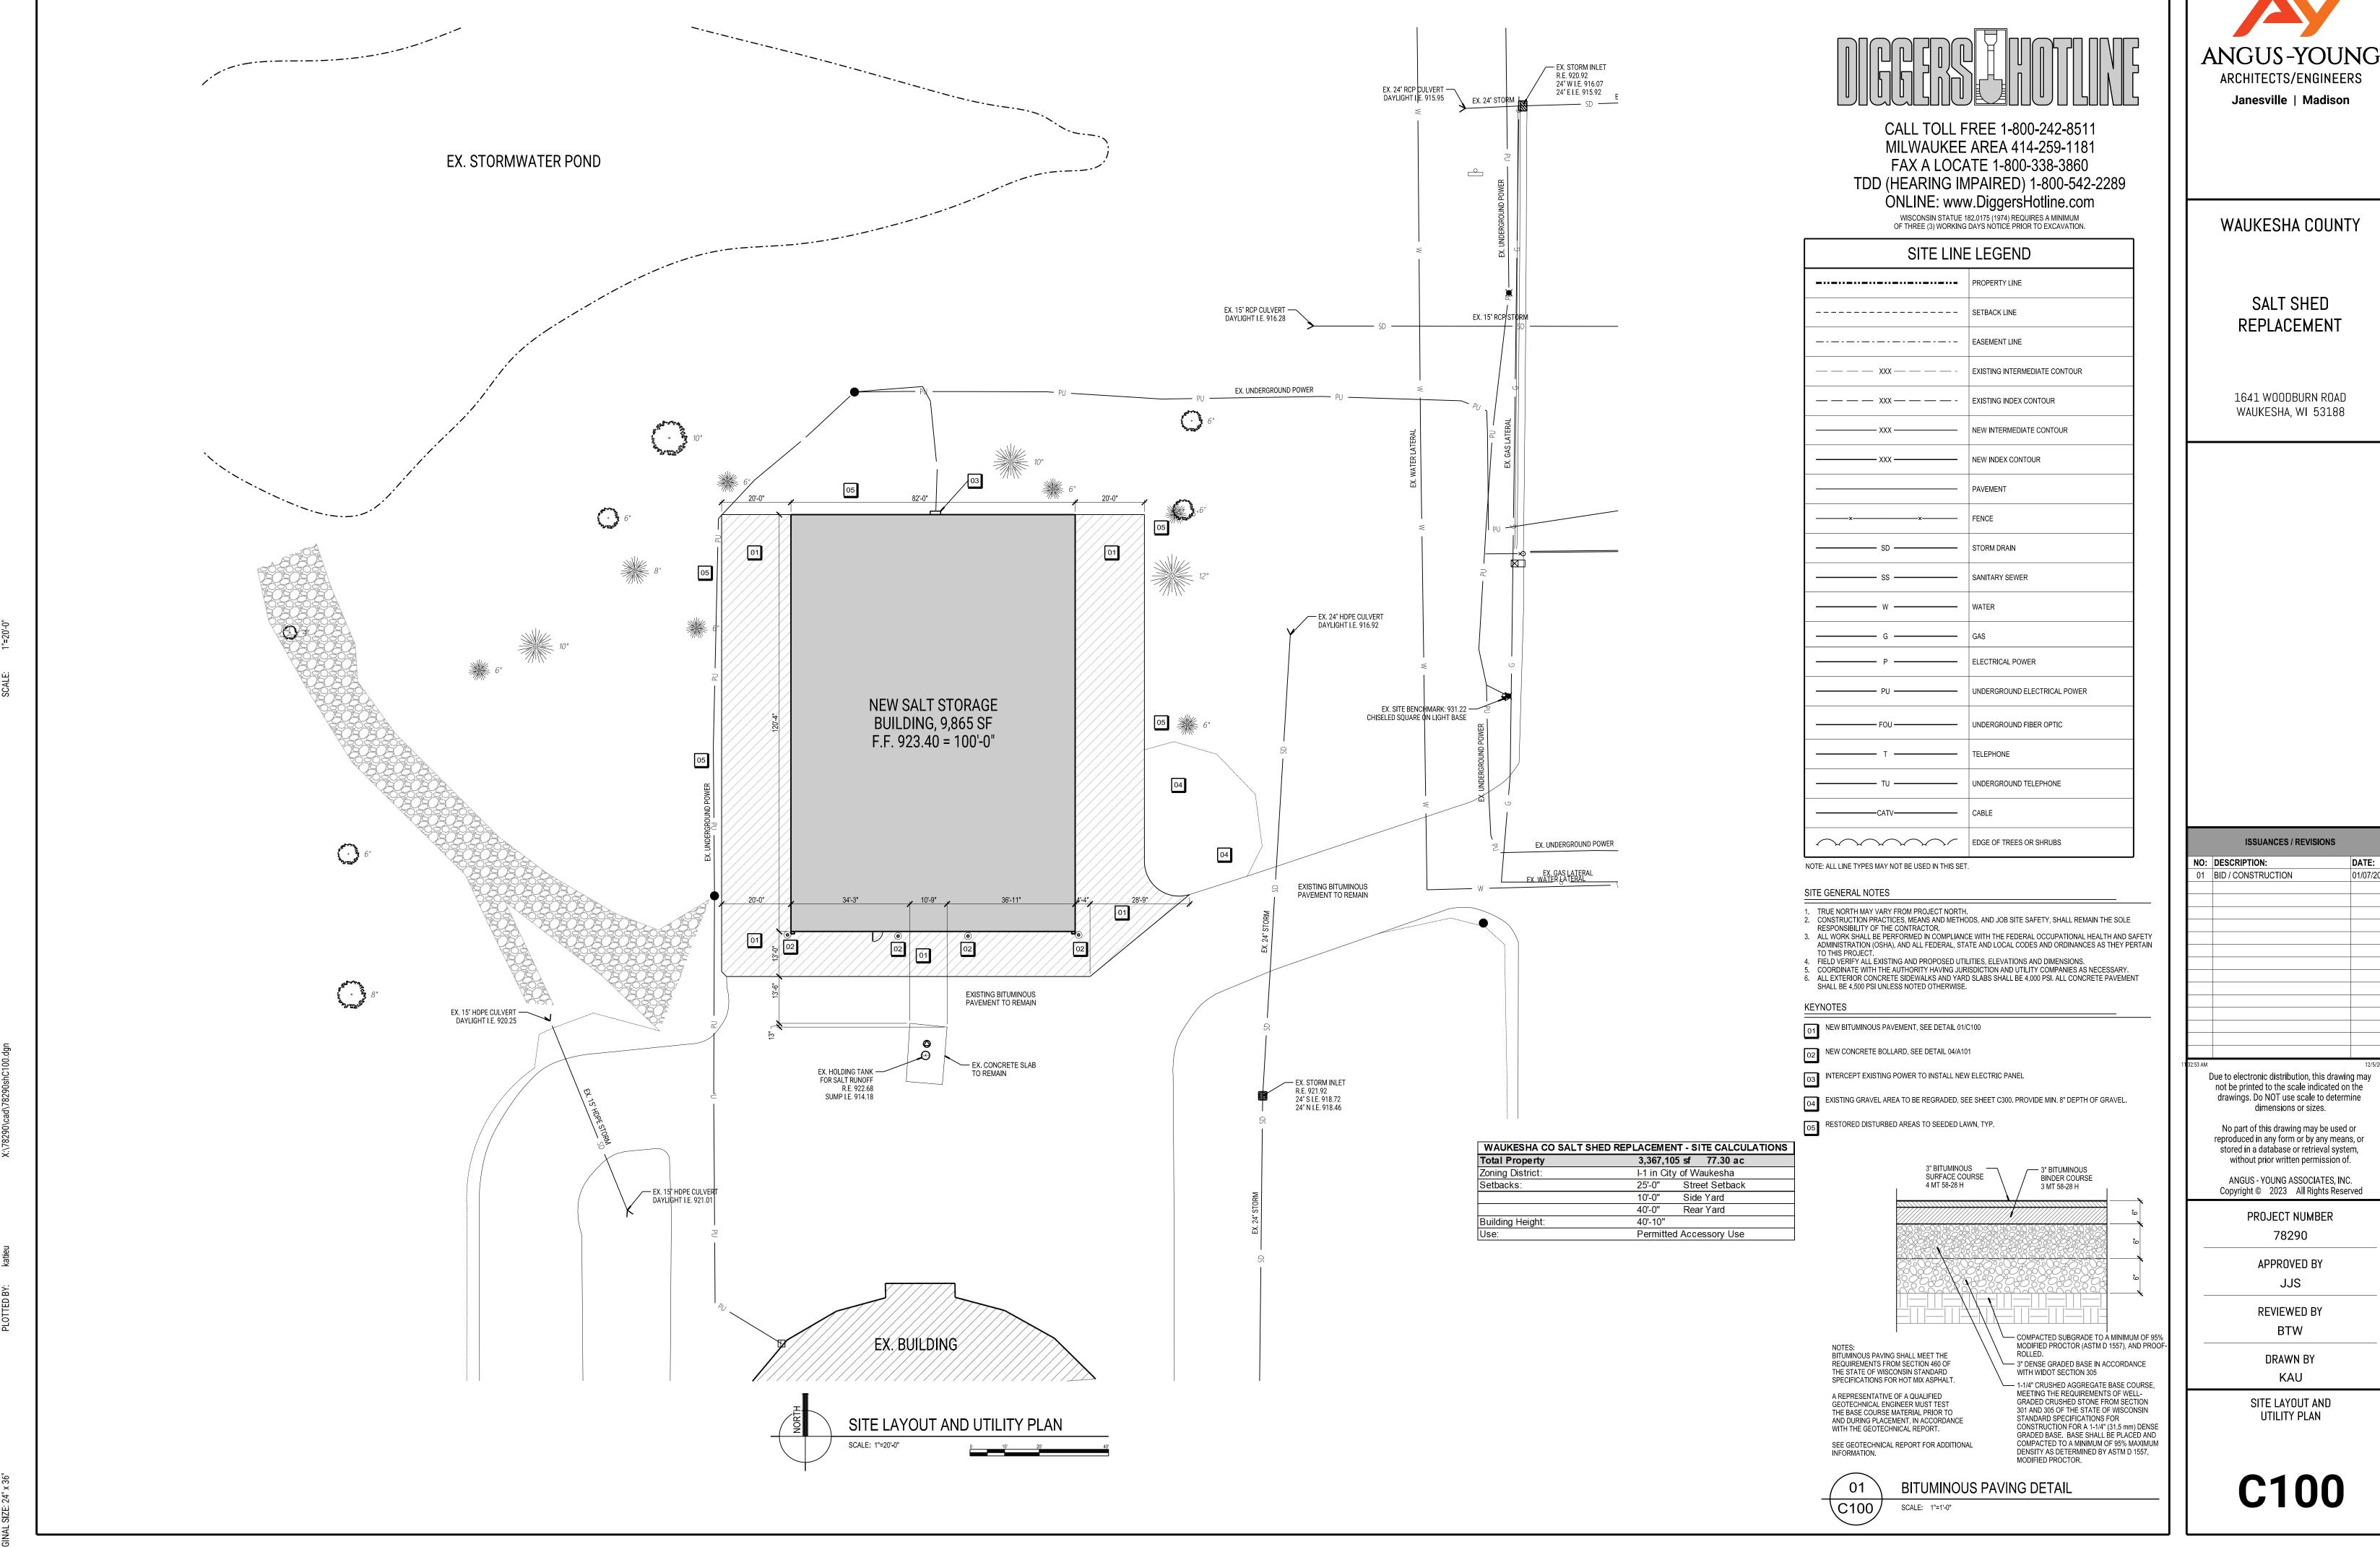
78290

APPROVED BY

REVIEWED BY


DRAWN BY

**EXISTING AND** DEMOLITION SITE PLAN



ARCHITECTS/ENGINEERS

01/07/202

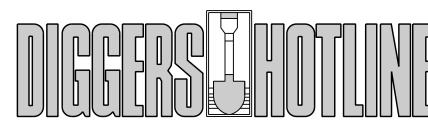

CALL TOLL FREE 1-800-242-8511 MILWAUKEE AREA 414-259-1181 FAX A LOCATE 1-800-338-3860 TDD (HEARING IMPAIRED) 1-800-542-2289

ONLINE: www.DiggersHotline.com WISCONSIN STATUE 182.0175 (1974) REQUIRES A MINIMUM OF THREE (3) WORKING DAYS NOTICE PRIOR TO EXCAVATION.

SITE LINE LEGEND					
	PROPERTY LINE				
	SETBACK LINE				
	EASEMENT LINE				
xxx	EXISTING INTERMEDIATE CONTOUR				
xxx	EXISTING INDEX CONTOUR				
xxx	NEW INTERMEDIATE CONTOUR				
xxx	NEW INDEX CONTOUR				
	PAVEMENT				
xx	FENCE				
sd	STORM DRAIN				
ss	SANITARY SEWER				
w	WATER				
G	GAS				
Р ———	ELECTRICAL POWER				
PU	UNDERGROUND ELECTRICAL POWER				
	UNDERGROUND FIBER OPTIC				
т ——	TELEPHONE				
ти	UNDERGROUND TELEPHONE				
CATV	CABLE				
~~~~	EDGE OF TREES OR SHRUBS				

NOTE: ALL LINE TYPES MAY NOT BE USED IN THIS SET.

SITE GENERAL NOTES

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- FIELD VERIFY ALL EXISTING AND PROPOSED UTILITIES, ELEVATIONS AND DIMENSIONS.
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   ALL EXTERIOR CONCRETE SIDEWALKS AND YARD SLABS SHALL BE 4,000 PSI. ALL CONCRETE PAVEMENT SHALL BE 4,500 PSI UNLESS NOTED OTHERWISE.

KEYNOTES


TEMPORARY SEDIMENT LOG OR SILT FENCE IN ACCORDANCE WITH DNR TECHNICAL STANDARD NO. 1056 'PERIMETER SEDIMENT CONTROL AND SLOPE INTERRUPTION' DATED APRIL 2024.

## **EROSION CONTROL NOTES**

NR 151.105 CONSTRUCTION SITE PERFORMANCE STANDARD FOR NON-PERMITTED SITES.

4 **REQUIREMENTS.** EROSION AND SEDIMENT CONTROL PRACTICES AT EACH SITE WHERE LAND DISTURBING CONSTRUCTION ACTIVITY IS TO OCCUR SHALL BE USED TO PREVENT OR REDUCE ALL OF THE FOLLOWING:

- a THE DEPOSITION OF SOIL FROM BEING TRACKED ONTO STREETS BY
- VEHCILES. b THE DISCHARGE OF SEDIMENT FROM DISTURBED AREAS INTO ON-
- SITE STORM WATER INLETS. c THE DISCHARGE OF SEDIMENT FROM DISTURBED AREAS INTO
- ADJACENT WATERS OF THE STATE. d THE DISCHARGE OF SEDIMENT FROM DRAINAGE WAYS THAT FLOW
- OFF THE SITE. e THE DISCHARGE OF SEDIMENT BY DEWATERING ACTIVITIES
- f THE DISCHARGE OF SEDIMENT ERODING FROM SOIL STOCKPILES EXISTING FOR MORE THAN 7 DAYS.
- g THE TRANSPORT BY RUNOFF INTO WATERS OF THE STATE OF CHEMICALS, CEMENT AND OTHER BUILDING COMPOUNDS AND MATERIALS ON THE CONSTRUCTION SITE DURING THE CONSTRUCTION PERIOD. HOWEVER, PROJECTS THAT REQUIRE THE PLACEMENT OF THESE MATERIALS IN WATERS OF THE STATE, SUCH AS CONSTRUCTING BRIDGE FOOTINGS OR BMP INSTALLATIONS, ARE NOT PROHIBITED BY THIS PARAGRAPH.

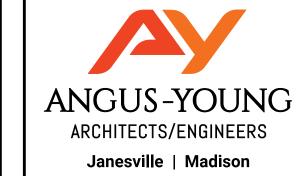

WAUKESHA COUNTY

SALT SHED REPLACEMENT

1641 WOODBURN ROAD WAUKESHA, WI 53188

ISSUANCES / REVISIONS NO: DESCRIPTION: DATE: 01 BID / CONSTRUCTION 01/07/202

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PROJECT NUMBER

78290

APPROVED BY

**REVIEWED BY** 

 $\mathsf{BTW}$ 

KAU SITE GRADING AND

DRAWN BY

**EROSION CONTROL** 

PLAN

## WAUKESHA COUNTY PUBLIC WORKS SALT STORAGE BUILDING WAUKESHA, WISCONSIN

		PLAN SHEET INDEX					
SHEET DESCRIPTION							
	1	COVER SHEET & SPECIFICATIONS					
	2	FOOTING & WALL PLAN					
	3	CONCRETE DETAILS					
	4	FOOTING REINFORCEMENT PLAN					
	5	WALL REINFORCEMENT PLAN					
	6	POST PLAN					

PRELIMINARY FOUNDATION DRAWINGS PROVIDED AS BASIS OF DESIGN FOR CAST IN PLACE CONCRETE AND REINFORCMENT WORK TO BE INCLUDED IN BASE BID. FINAL **DESIGN DRAWINGS TO BE PROVIDED BY BUILDING SUPPLIER DURING SUBMITTAL** PROCESS.

#### **DESIGN DATA:**

THE INTERNATIONAL BUILDING CODE GOVERNS.

THE DESIGN OF THIS STRUCTURE COMPLIES WITH THE BUILDING CODE AND SUPPLEMENTAL SPECIFICATIONS AS INDICATED IN THE CODE AND THE DESIGN COMPUTATIONS.

- 1) USE AND OCCUPANCY CLASSIFICATION GROUP S-2
- 2) TYPE OF CONSTRUCTION = V-B
- 3) BULK STORAGE: 80 PCF SALT. 12FT. AT WALLS. 25FT. MAX. FILL HT. MAX. SLOPE SHALL BE 1 VERTICAL TO 2 HORIZONTAL.
- 4) ROOF LIVE LOAD USED IN THE DESIGN 28.6 PSF

COVER SHEET & SPECIFICATIONS


- A) GROUND SNOW LOAD 30 PSF
- B) FLAT ROOF SNOW LOAD 25.2 PSF
- C) SNOW EXPOSURE FACTOR 1.0
- D) THERMAL FACTOR 1.2
- 5) A) BASIC WIND SPEED 105 MPH
  - B) OCCUPANCY CATEGORY 1
  - C) EXPOSURE "C"

#### **CONSTRUCTION NOTES:**

FOOTINGS ARE DESIGNED FOR A NET ALLOWABLE BEARING PRESSURE OF 2,500 PSF, THE GEOTECHNICAL ENGINEER OR PROJECT ENGINEER ON SITE SHALL VERIFY.

CONCRETE CONSTRUCTION, INCLUDING BUT NOT LIMITED TO MIX DESIGN, QUALITY CONTROL, PLACEMENT, COLD WEATHER PROVISIONS, AND ANCHORAGE INSTALLATION, SHALL BE IN ACCORDANCE WITH THE CODE AND THE BUILDING CODE REQUIREMENTS FOR STRUCTURAL CONCRETE (ACI 318) AS APPROVED BY THE PROJECT ENGINEER ON SITE. CONCRETE TO BE 4000 PSI, NORMAL WEIGHT. ALL REINFORCEMENT STEEL SHALL BE GRADE 60, EPOXY COATED.

CONCRETE DRAWINGS ARE PRELIMINARY AND ARE SUBJECT TO MINOR CHANGES PER BUILDING MANUFACTURER'S FINAL DESIGN. BUILDING MANUFACTURER SHALL SUBMIT PE STAMPED SEALED CONCRETE FOUNDATION DRAWINGS AND CALCULATIONS AS PART OF THE FULL BUILDING SUBMITTAL. CONTRACTOR SHALL WAIT UNTIL SUBMITTALS ARE APPROVED TO ORDER REBAR.

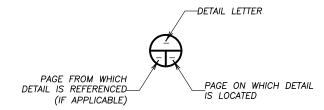

CALLOUT LEGEND


DO NOT SCALE DRAWINGS


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WAUKESHA COUNTY PUBLIC WORKS SALT STORAGE BUILDING 120' L X 80' W X 30' H WAUKESHA, WISCONSIN



9531	W.78th	Street,	Ste.100
Eden	Prairie,	MN 55	344
952-	929-78	54	
info@	wheeler1	892.co	n
wheel	er1892.d	com	



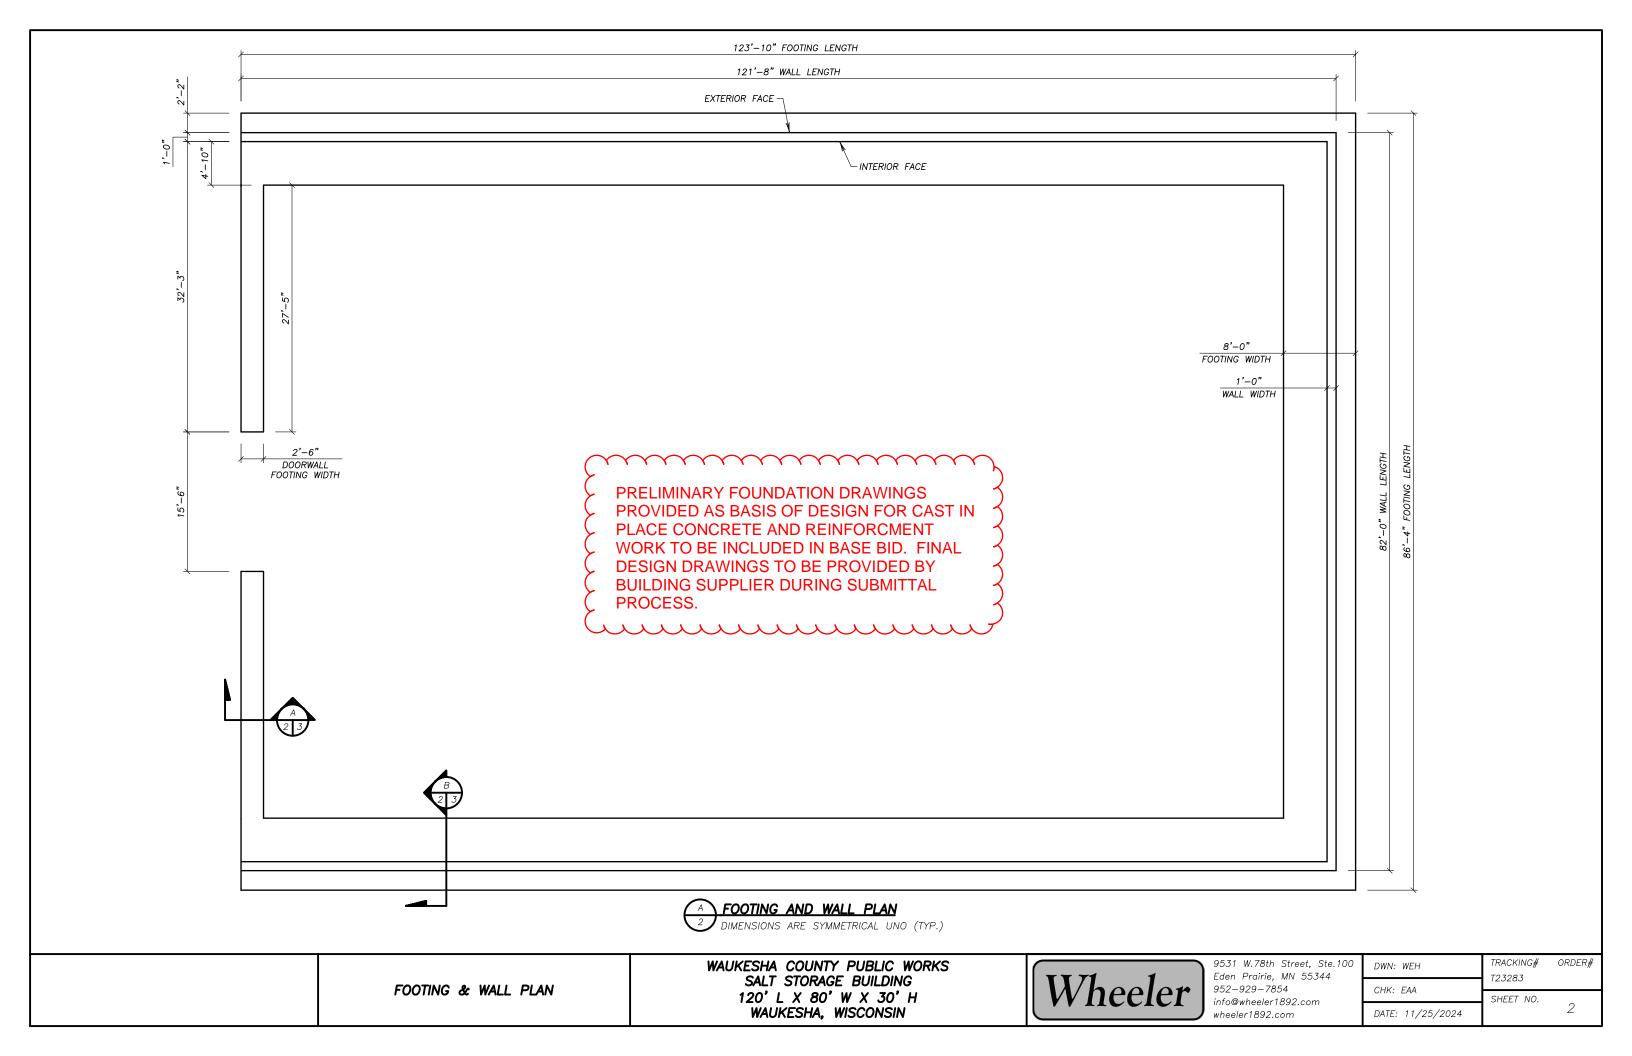

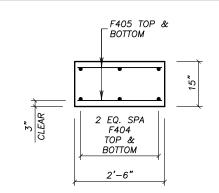CONCRETE FOOTING SECTION @ DOORWALL

INT = INTERIOR FACE EXT = EXTERIOR FACE EQ = EQUAL

SPA = SPACESUNO = UNLESS NOTED OTHERWISE


THE FIRST DIGIT OF THE BAR NAME SIGNIFIES THE BAR


BAR SIZES SHOWN IN THIS PLAN ARE U.S. CUSTOMARY DESIGNATIONS.

ALL REINFORCEMENT STEEL SHALL BE GRADE 60, EPOXY COATED.

DRAWINGS SHALL NOT BE SCALED.

NOMINAL 2X4 KEY MAY BE MADE WITH S4S MATERIAL, 1 1/2" X 3 1/2". KEY MAY BE REPLACED WITH INTENTIONALLY ROUGHENED SURFACE, 1/4" AMPLITUDE. PRELIMINARY FOUNDATION DRAWINGS PROVIDED AS BASIS OF DESIGN FOR CAST IN PLACE CONCRETE AND REINFORCMENT WORK TO BE INCLUDED IN BASE BID. FINAL DESIGN DRAWINGS TO BE PROVIDED BY **BUILDING SUPPLIER DURING SUBMITTAL** PROCESS.

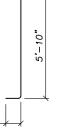

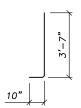





**D501** 

**D502** 

**W405** 

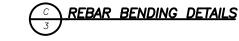


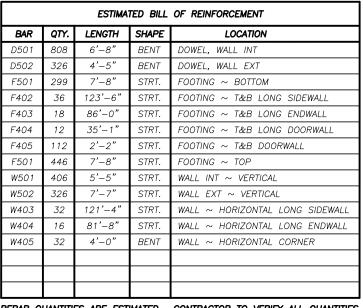

REBAR QUANTITIES ARE ESTIMATED. CONTRACTOR TO VERIFY ALL QUANTITIES.

#### **KEY NOTES:**

- (1) REINFORCEMENT SHALL BE CAREFULLY PLACED TO AVOID ANCHOR BOLTS. 2" CLEAR SHALL BE PROVIDED ON EACH SIDE. SEE ALSO POST FOOTING DETAILS.
- 2 SEE "FOOTING REINFORCEMENT PLAN" SHEET.
- (3) SEE "WALL REINFORCEMENT PLAN" SHEET.
- (4) PROVIDE 1'-10" LAPS AS NEEDED. LOCATION DETERMINED BY CONTRACTOR. BAR LENGTH TABULATED IS THE OUT-TO-OUT MEASUREMENT.
- (5) SEE "FOOTING REINFORCEMENT PLAN" FOR LAYOUT OF F506 BARS. BARS MUST BE PLACED PER PLAN TO AVOID INTERFERENCE WITH LOWER POST ANCHOR(S).
- 6 SEE "WALL REINFORCEMENT PLAN" SHEET FOR LAYOUT OF D501 AND W501 BARS. REBAR SPACING VARIES PER POST SPACING. BARS MUST BE PLACED PER PLAN TO AVOID UPPER POST ANCHOR(S).

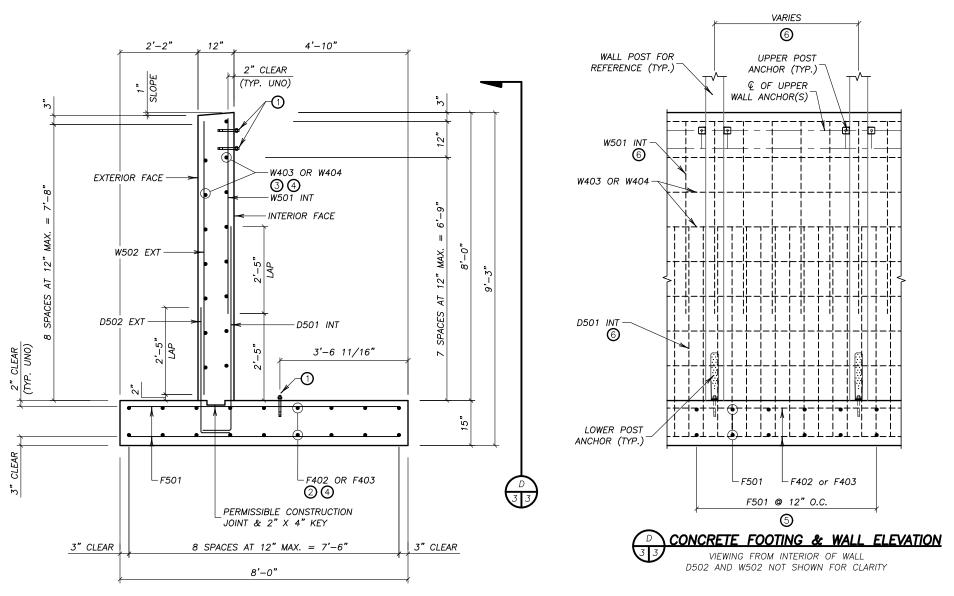

CONCRETE FOOTING & WALL SECTION @ LOADWALL


WAUKESHA COUNTY PUBLIC WORKS SALT STORAGE BUILDING 120' L X 80' W X 30' H WAUKESHA, WISCONSIN




9531 W.78th Street, Ste.100 Eden Prairie, MN 55344 952-929-7854 info@wheeler1892.com wheeler1892.com

TRACKING# ORDER# DWN: WEH T23283 CHK: EAA SHEET NO. 3 DATE: 11/25/2024

CONCRETE DETAILS

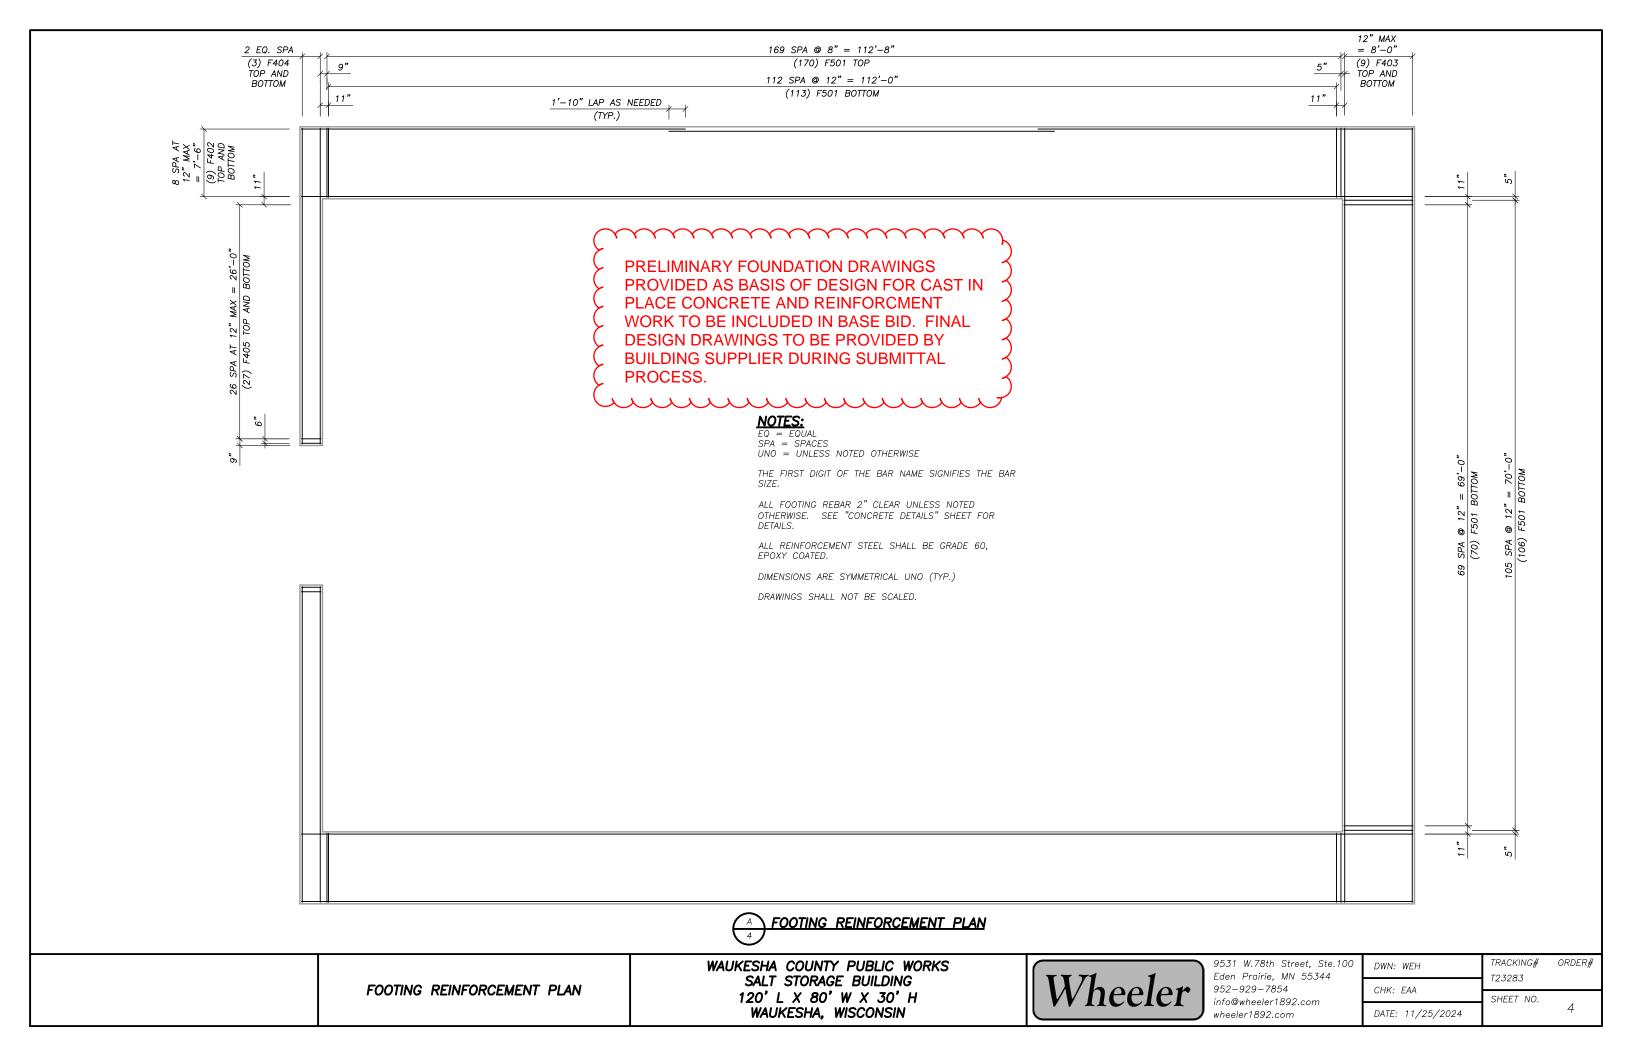

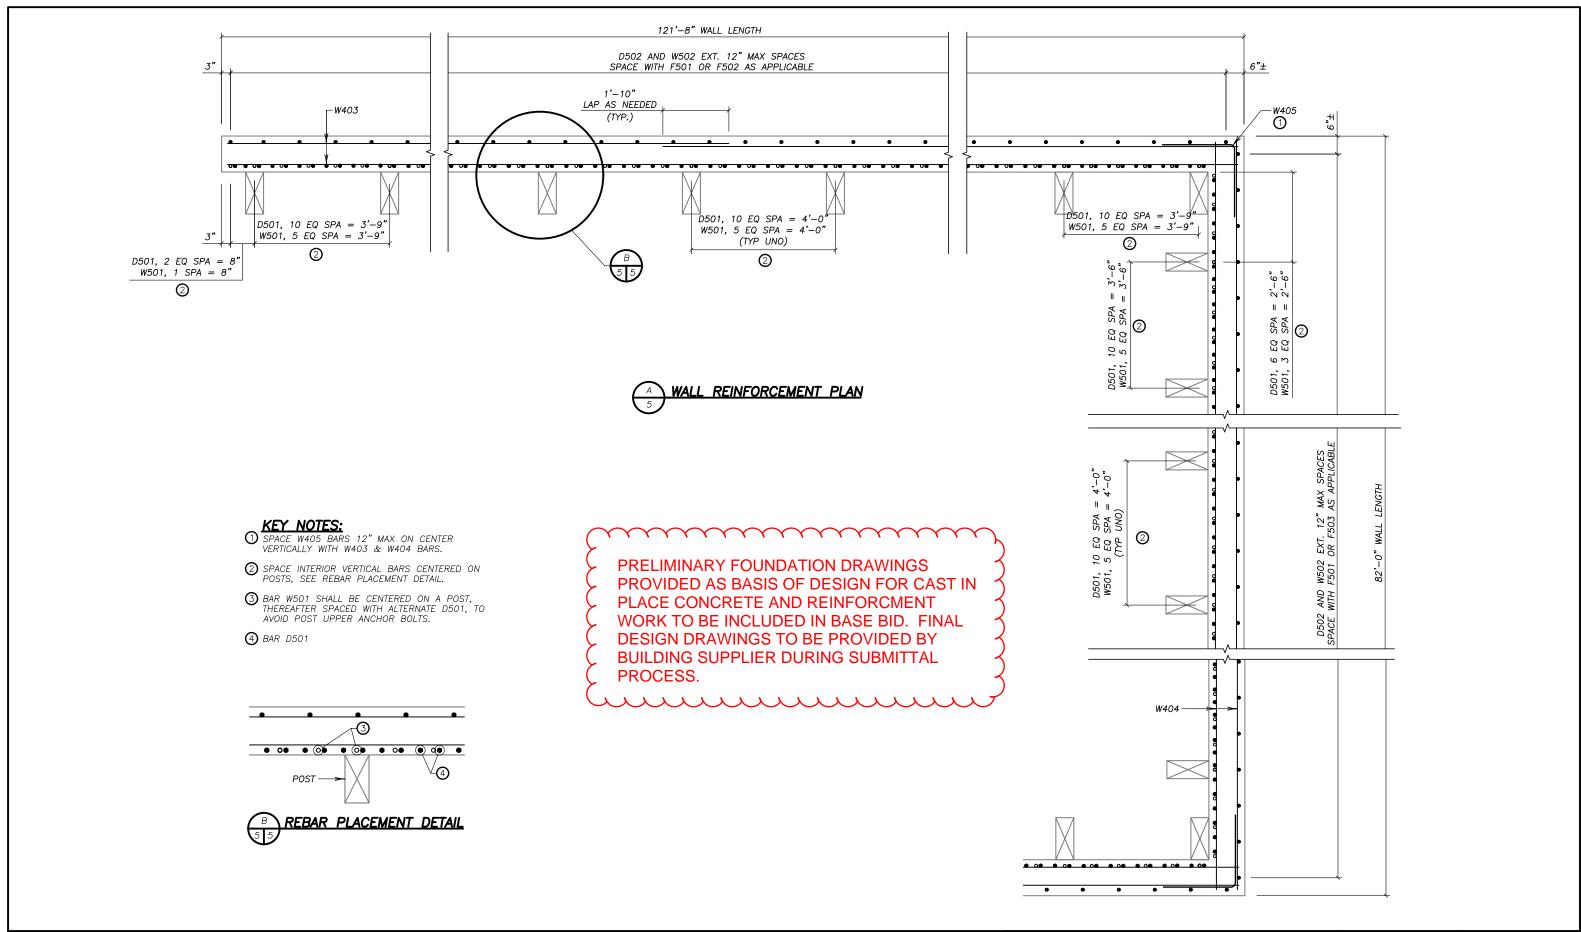

WAUKESHA COUNTY PUBLIC WORKS SALT STORAGE BUILDING 120' L X 80' W X 30' H


WAUKESHA, WISCONSIN

WALL REINFORCEMENT PLAN

9531 W.78th Street, Ste.100 Eden Prairie, MN 55344 952-929-7854 info@wheeler1892.com wheeler1892.com

TRACKING# ORDER# DWN: WEH T23283 CHK: EAA SHEET NO. 5

DATE: 11/25/2024

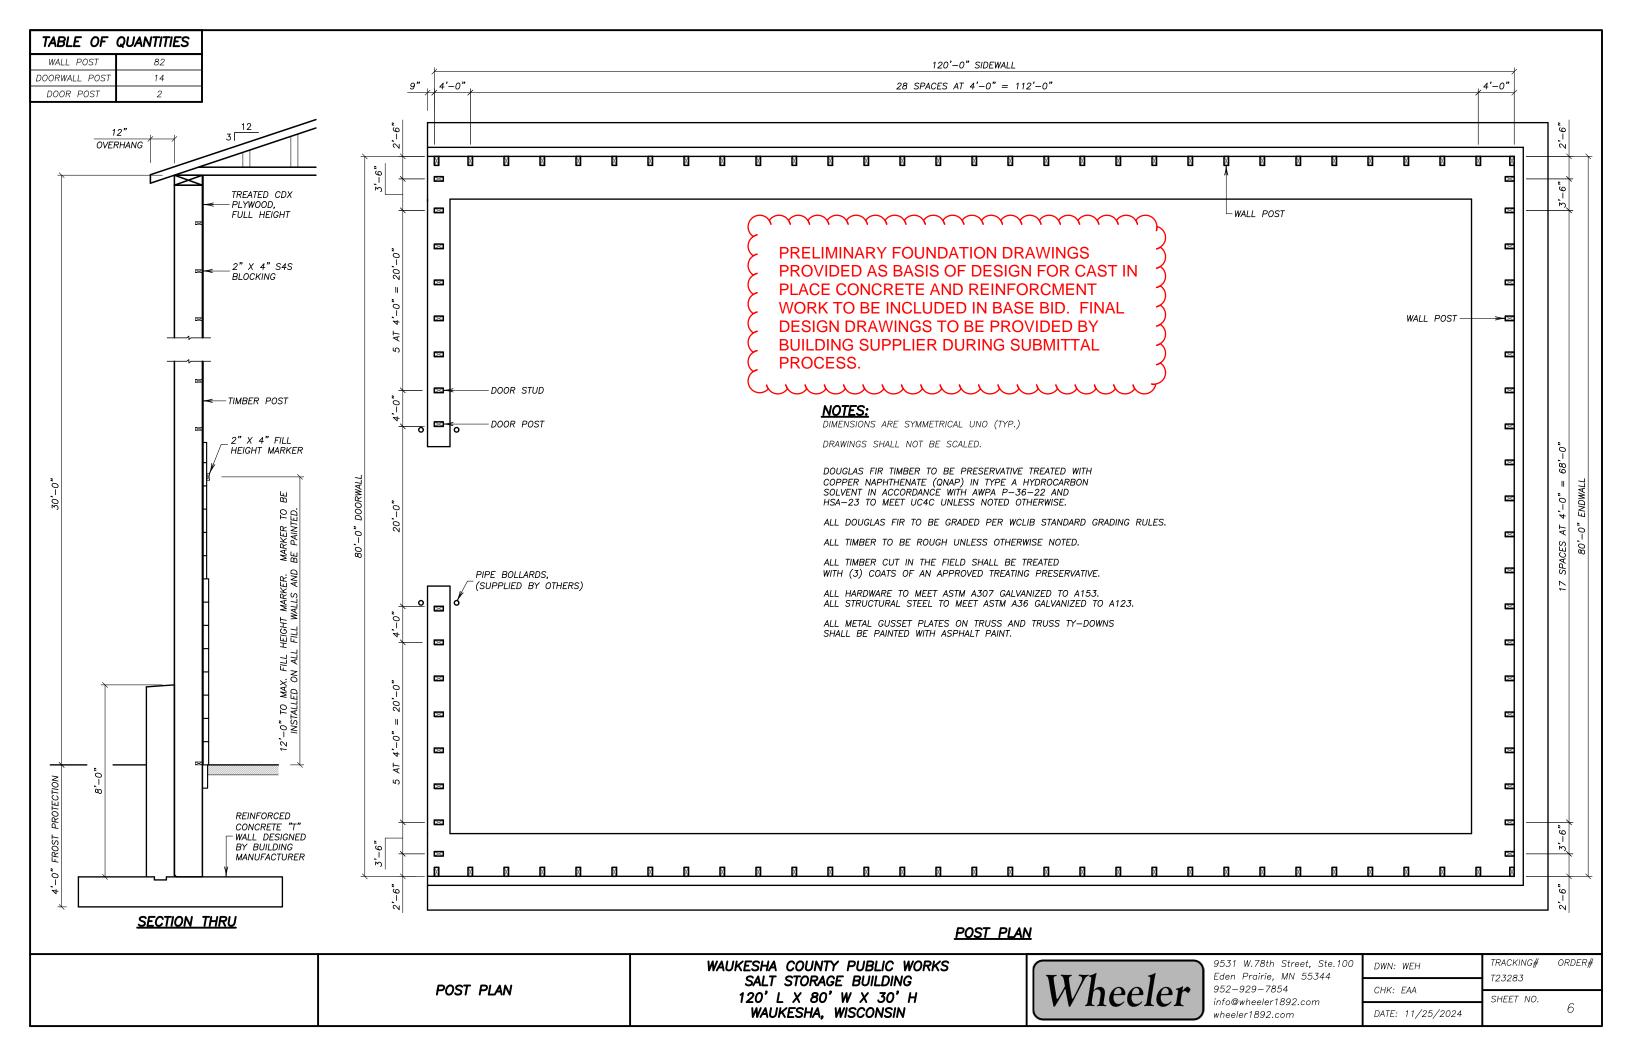

ARCHITECTS/ENGINEERS Janesville | Madison | Rockford

WAUKESHA COUNTY

SALT SHED REPLACEMENT

1641 WOODBURN ROAD WAUKESHA, WI 53188

ISSUANCES / REVISIONS

01/07/2025

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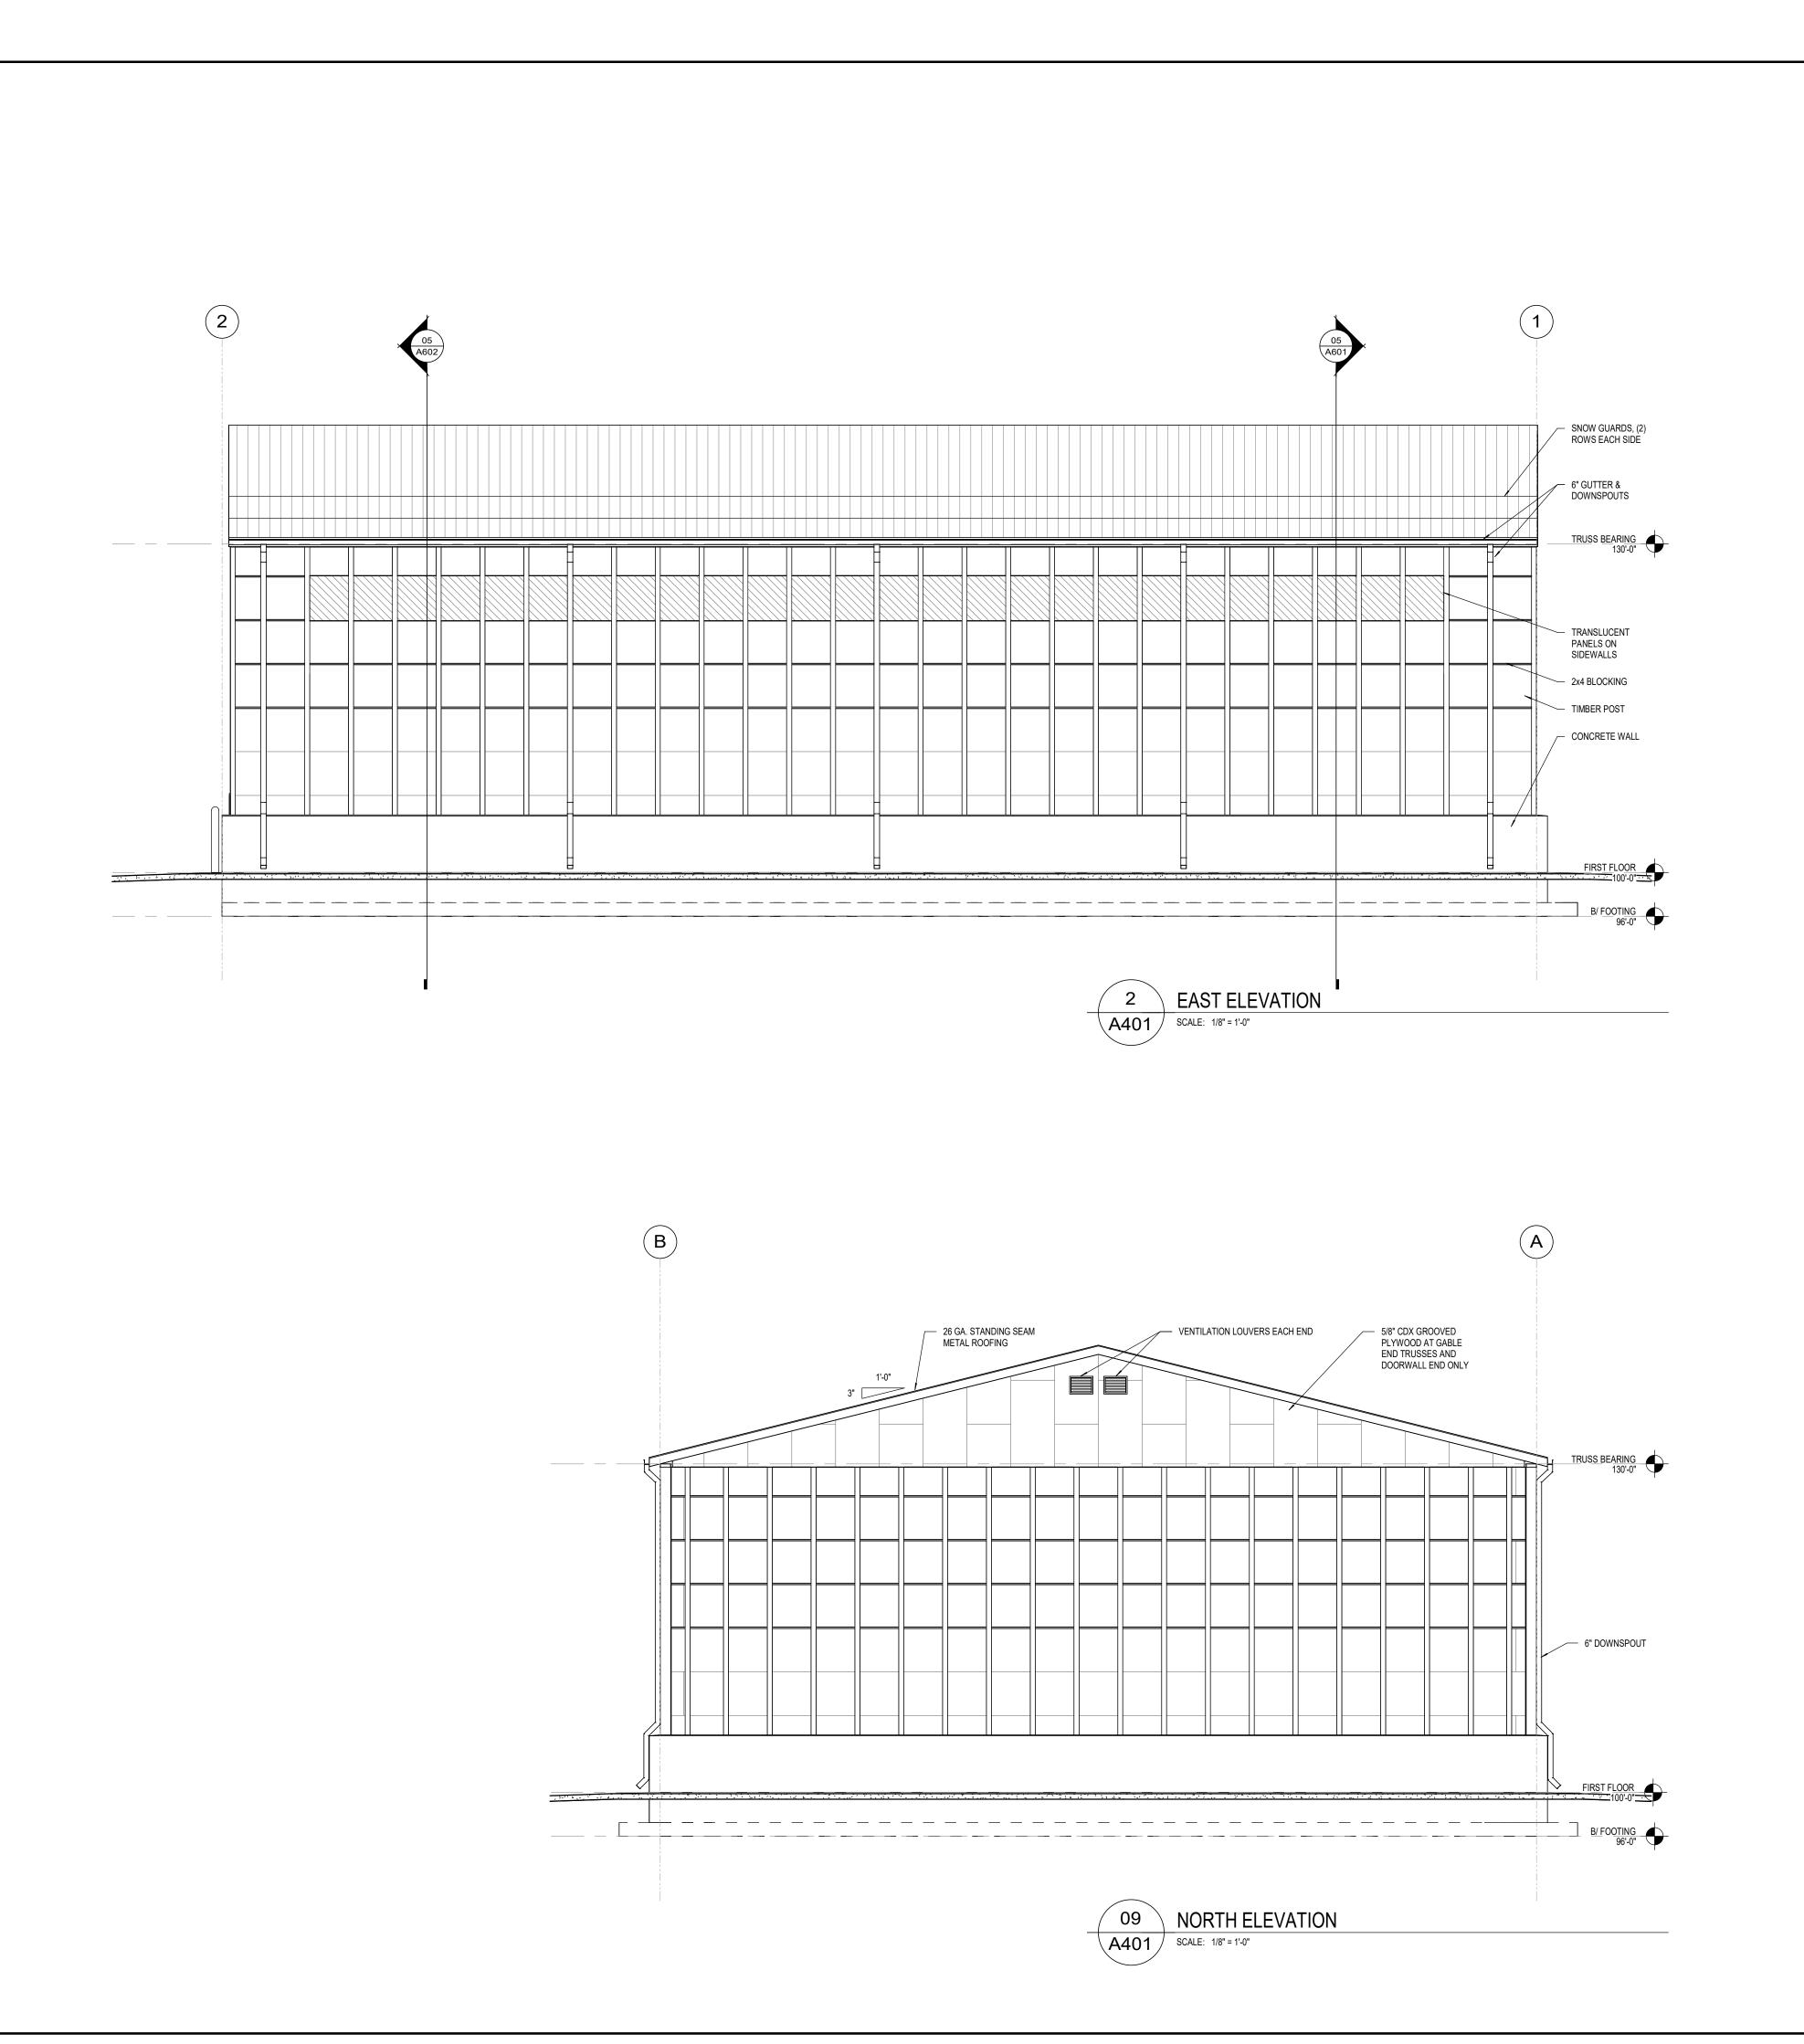
> PROJECT NUMBER 78290

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REVIEWED BY

DRAWN BY

FIRST FLOOR PLAN





SALT SHED REPLACEMENT

1641 WOODBURN ROAD WAUKESHA, WI 53188

NO:	DESCRIPTION:	DATE:
1	BID / CONSTRUCTION	01/07/2025

ISSUANCES / REVISIONS

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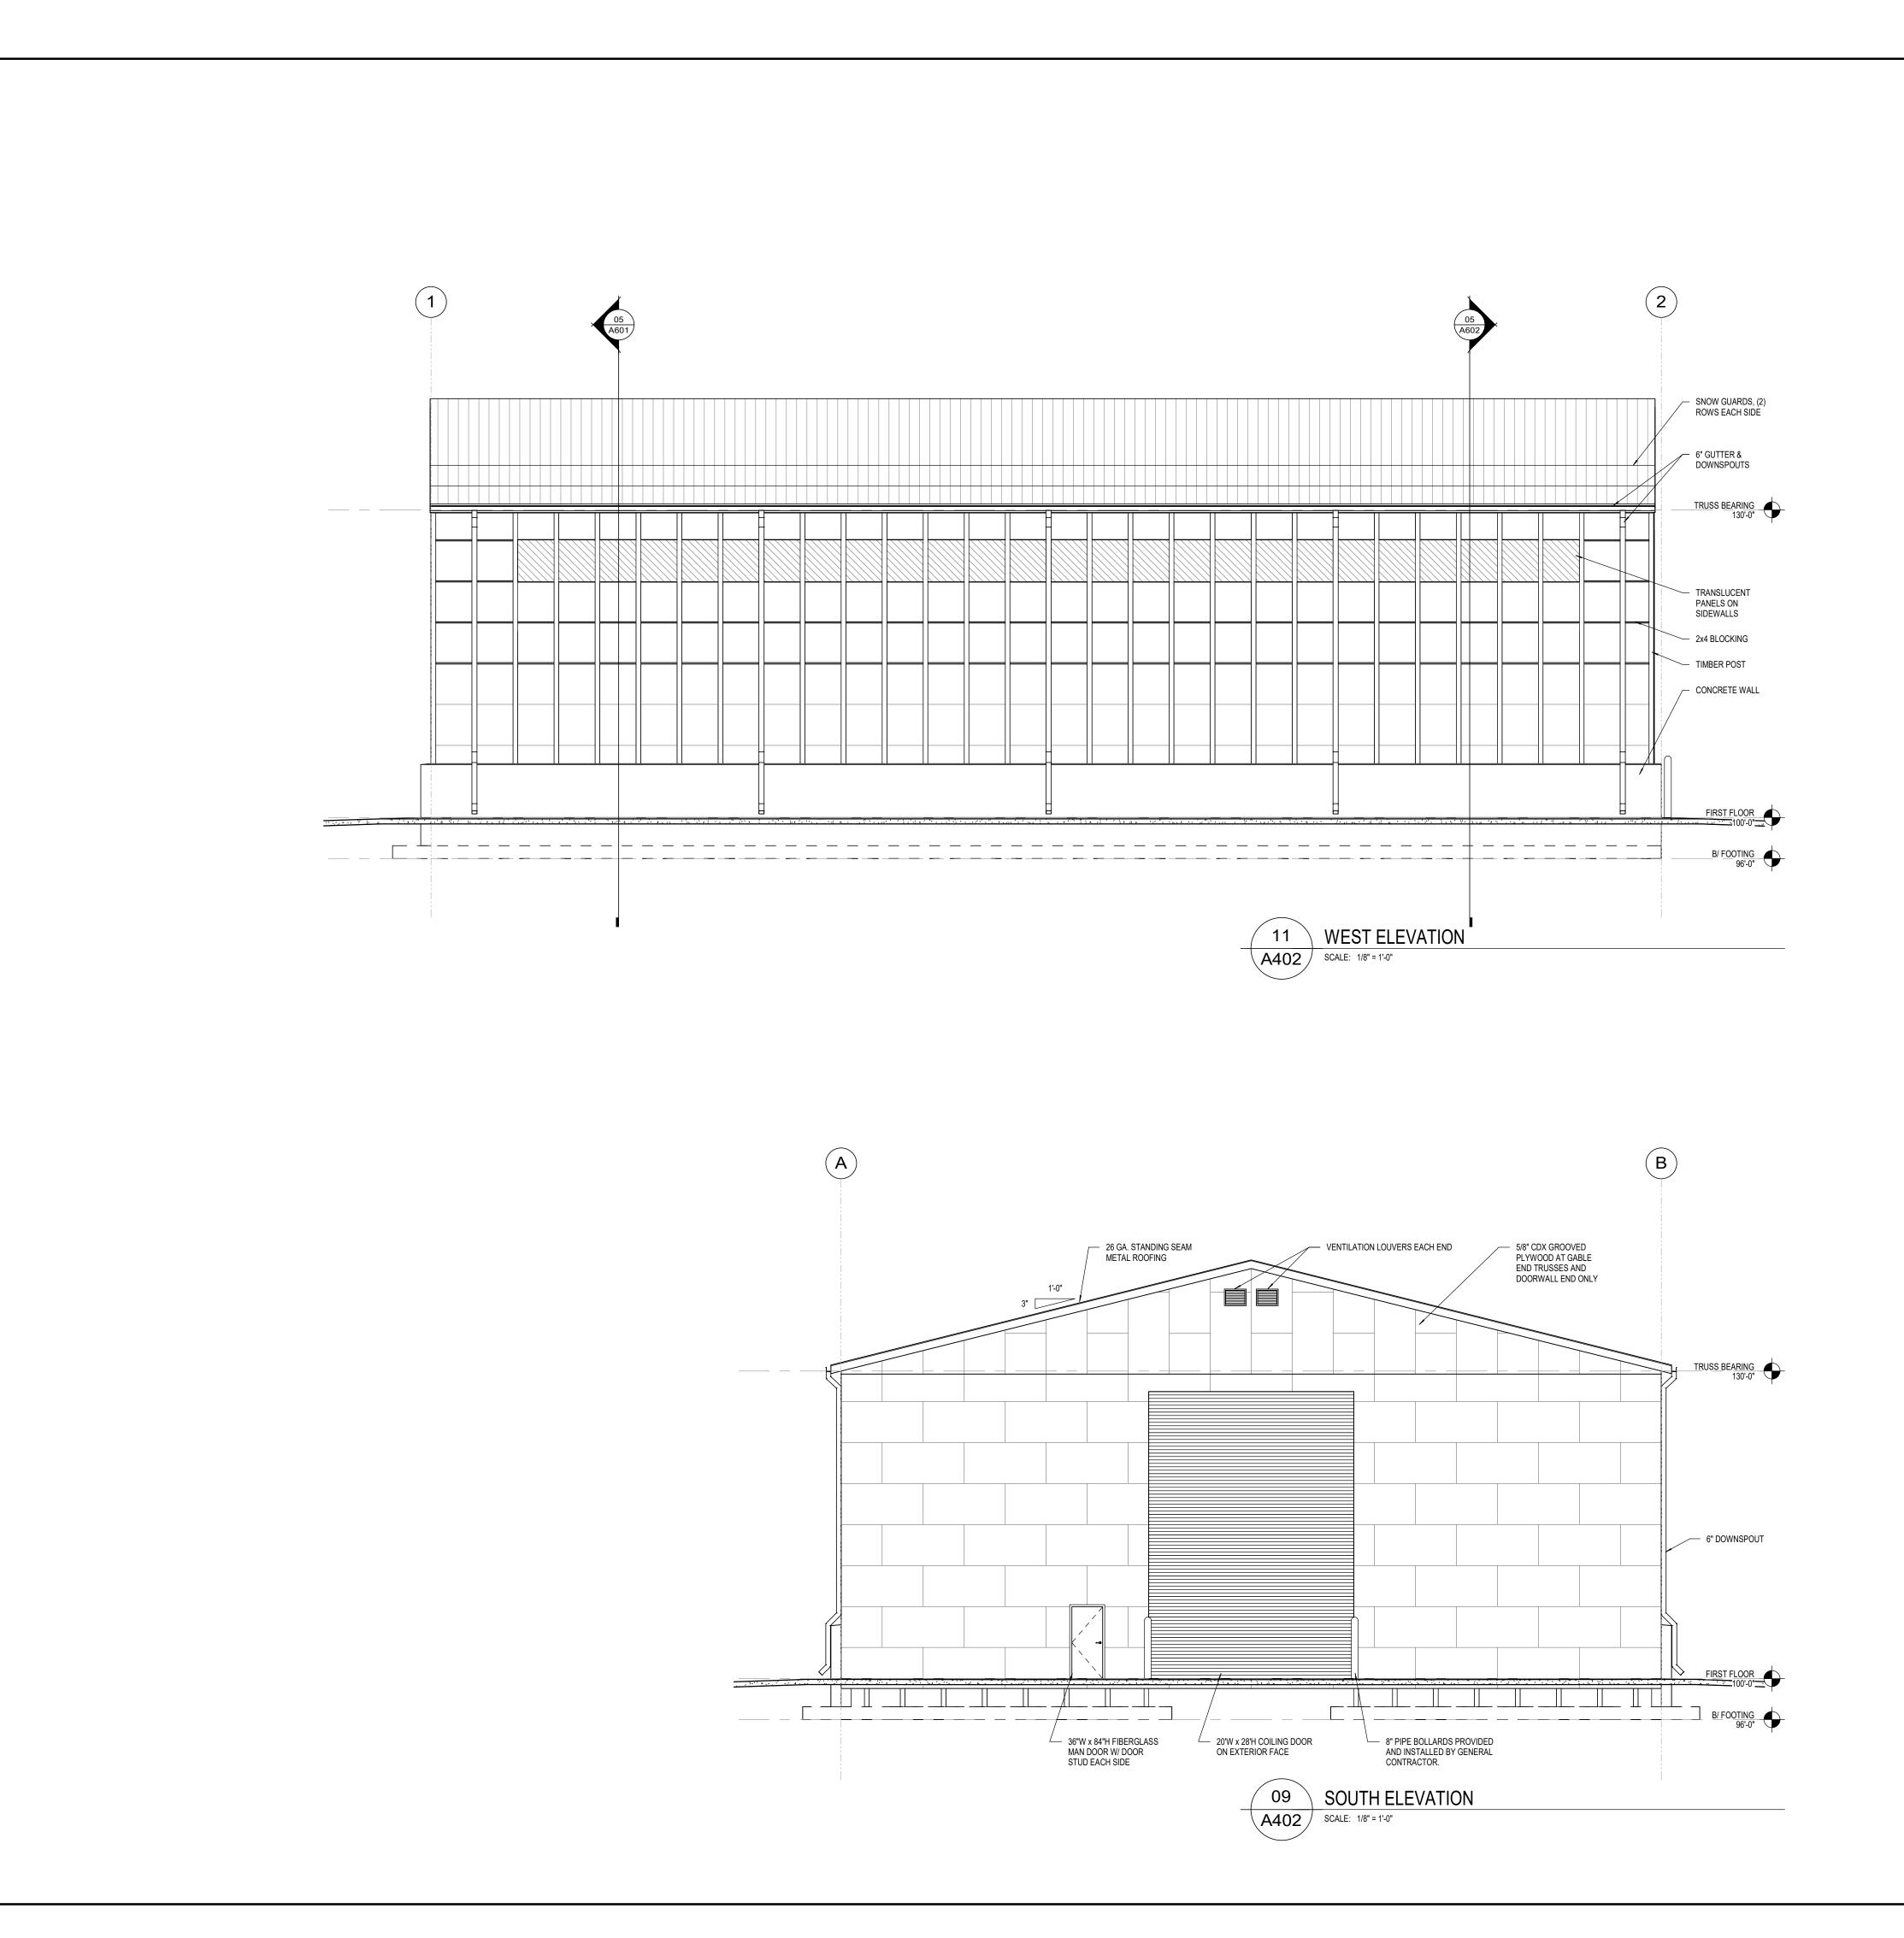
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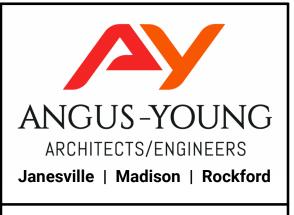
REVIEWED BY

DRAWN BY

EXTERIOR ELEVATIONS

**A401** 





SALT SHED REPLACEMENT

1641 WOODBURN ROAD WAUKESHA, WI 53188

10.	DESCRIPTION:	T
NO: [	DESCRIPTION:	DATE:
1 E	BID / CONSTRUCTION	01/07/2025

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> PROJECT NUMBER 78290

APPROVED BY

I IS

REVIEWED BY BTW

DRAWN BY

EXTERIOR ELEVATIONS

**A402** 

ANGUS-YOUNG ARCHITECTS/ENGINEERS Janesville | Madison | Rockford

WAUKESHA COUNTY

SALT SHED REPLACEMENT

1641 WOODBURN ROAD WAUKESHA, WI 53188

ISSUANCES / REVISIONS

1 BID / CONSTRUCTION 01/07/2025

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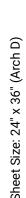
PROJECT NUMBER 78290


APPROVED BY JJS

**REVIEWED BY** 

DRAWN BY

**BUILDING SECTIONS** 



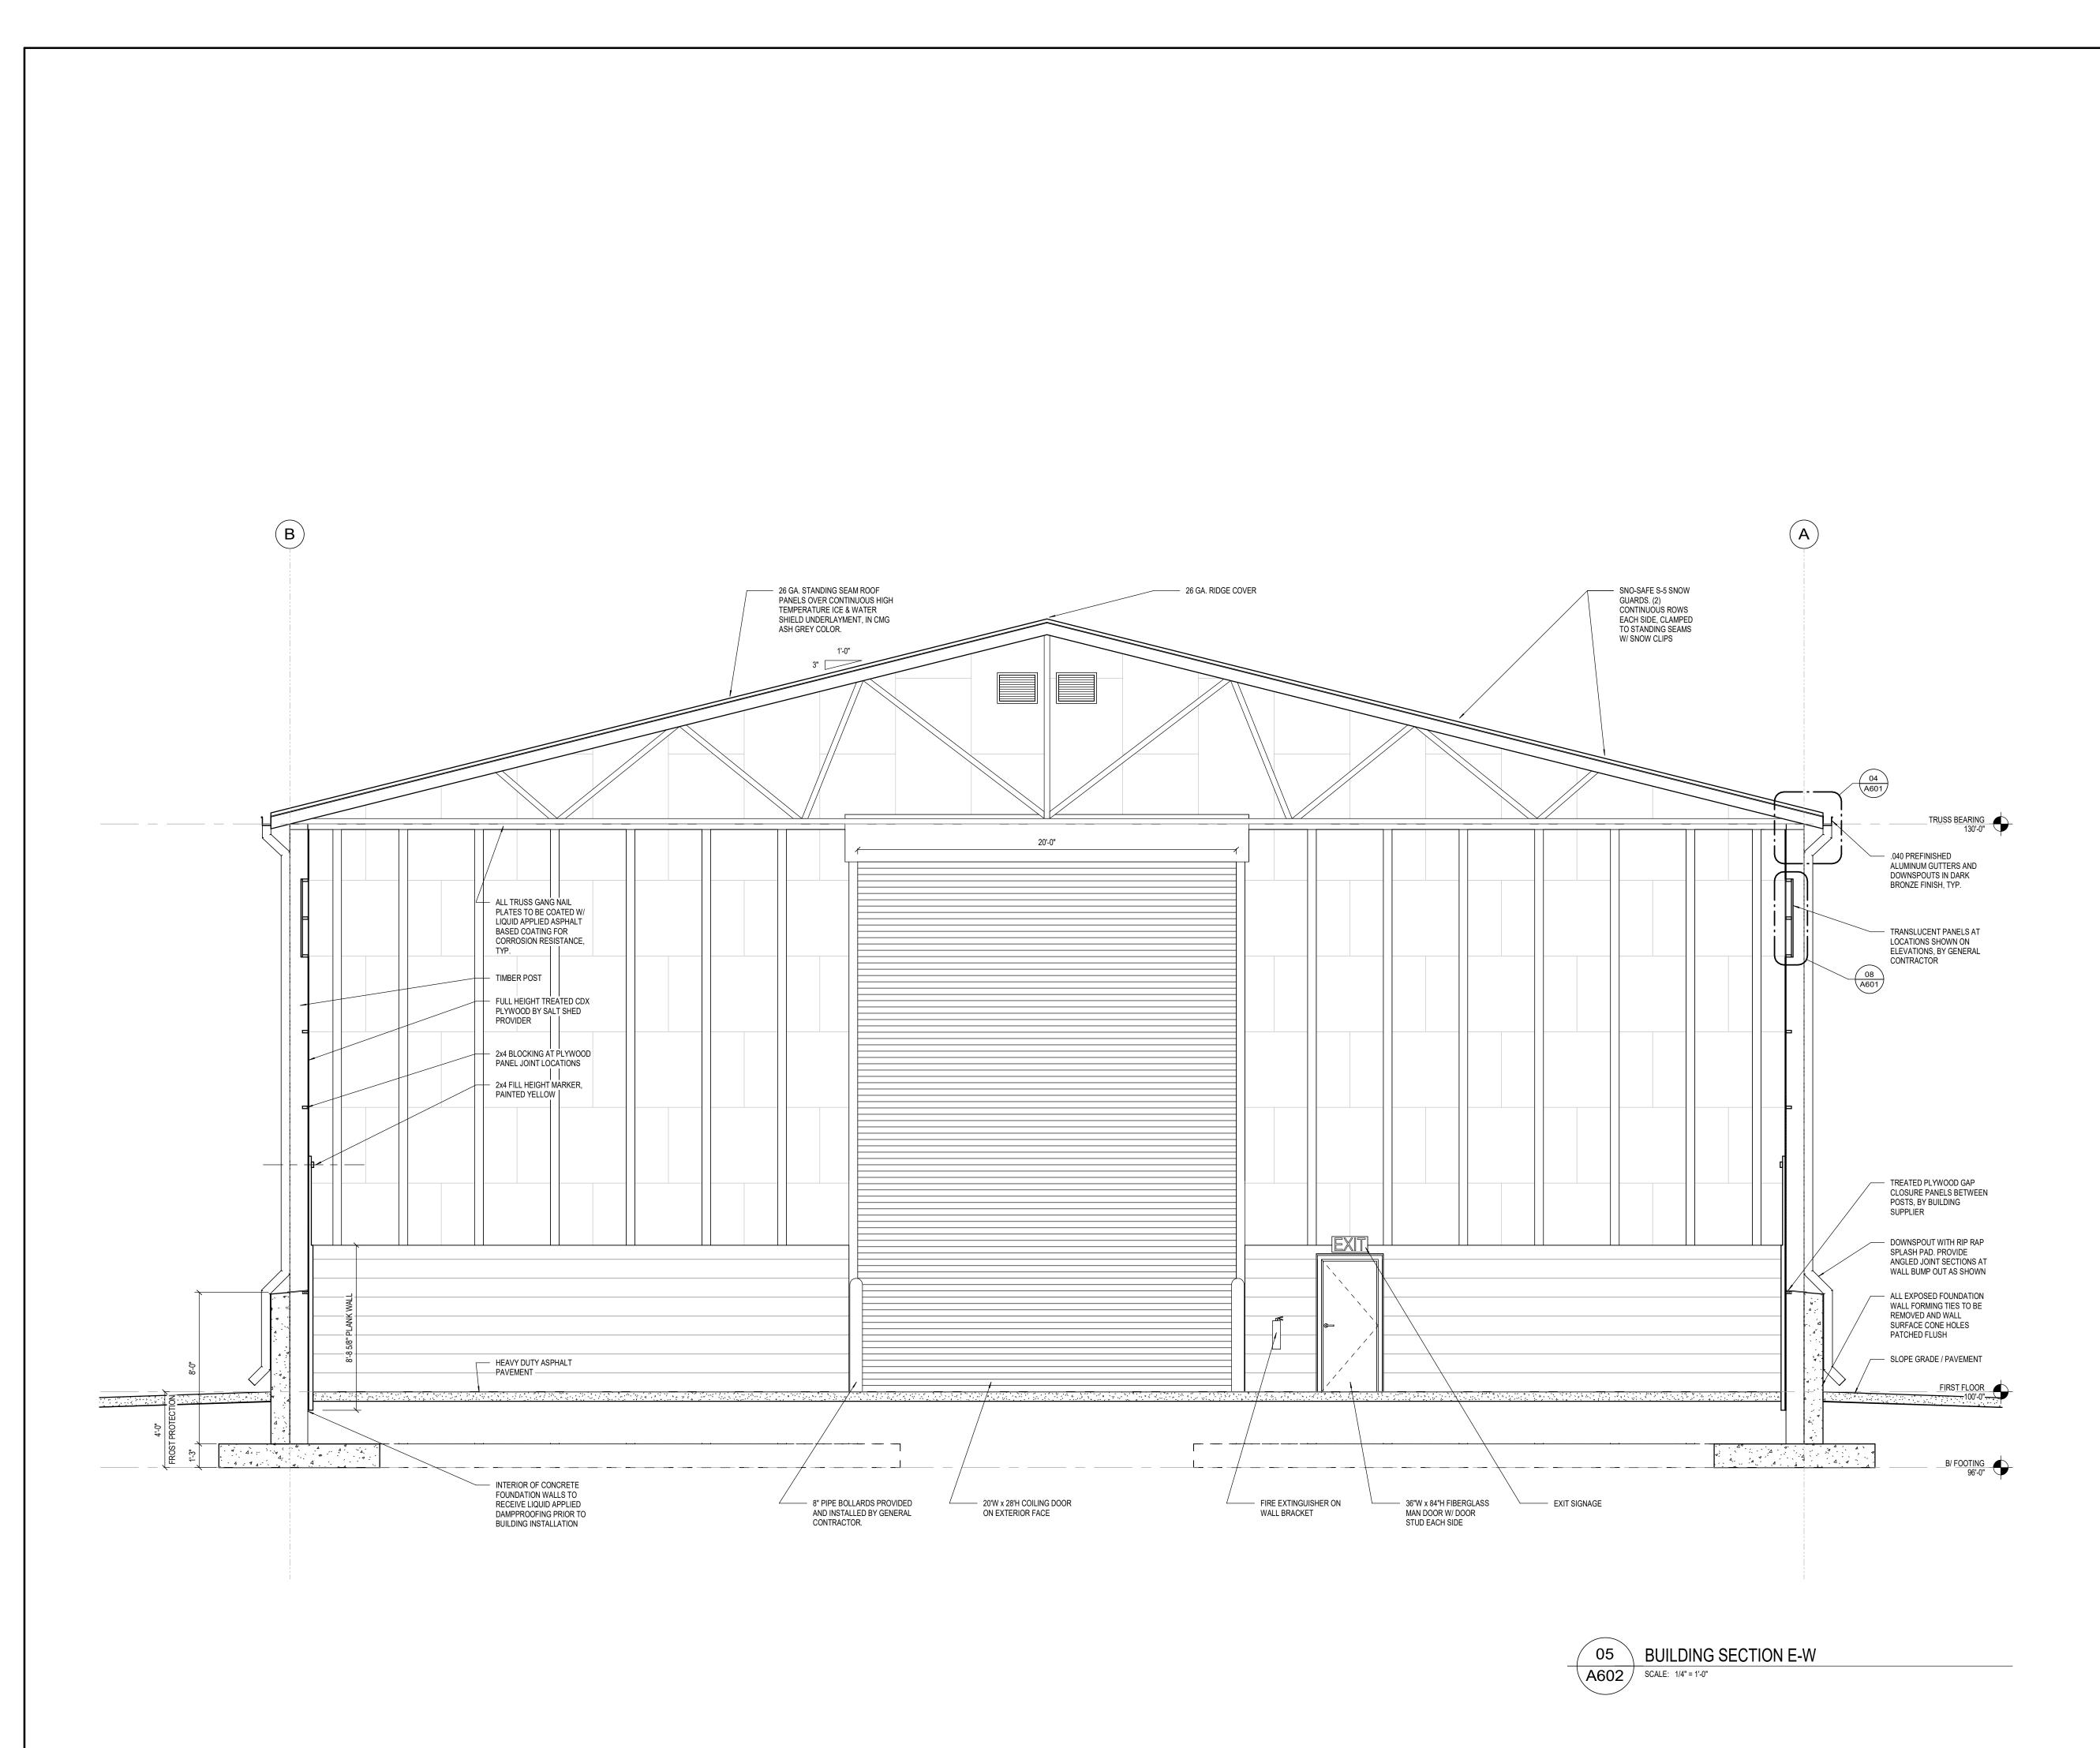



SALT SHED REPLACEMENT

1641 WOODBURN ROAD WAUKESHA, WI 53188

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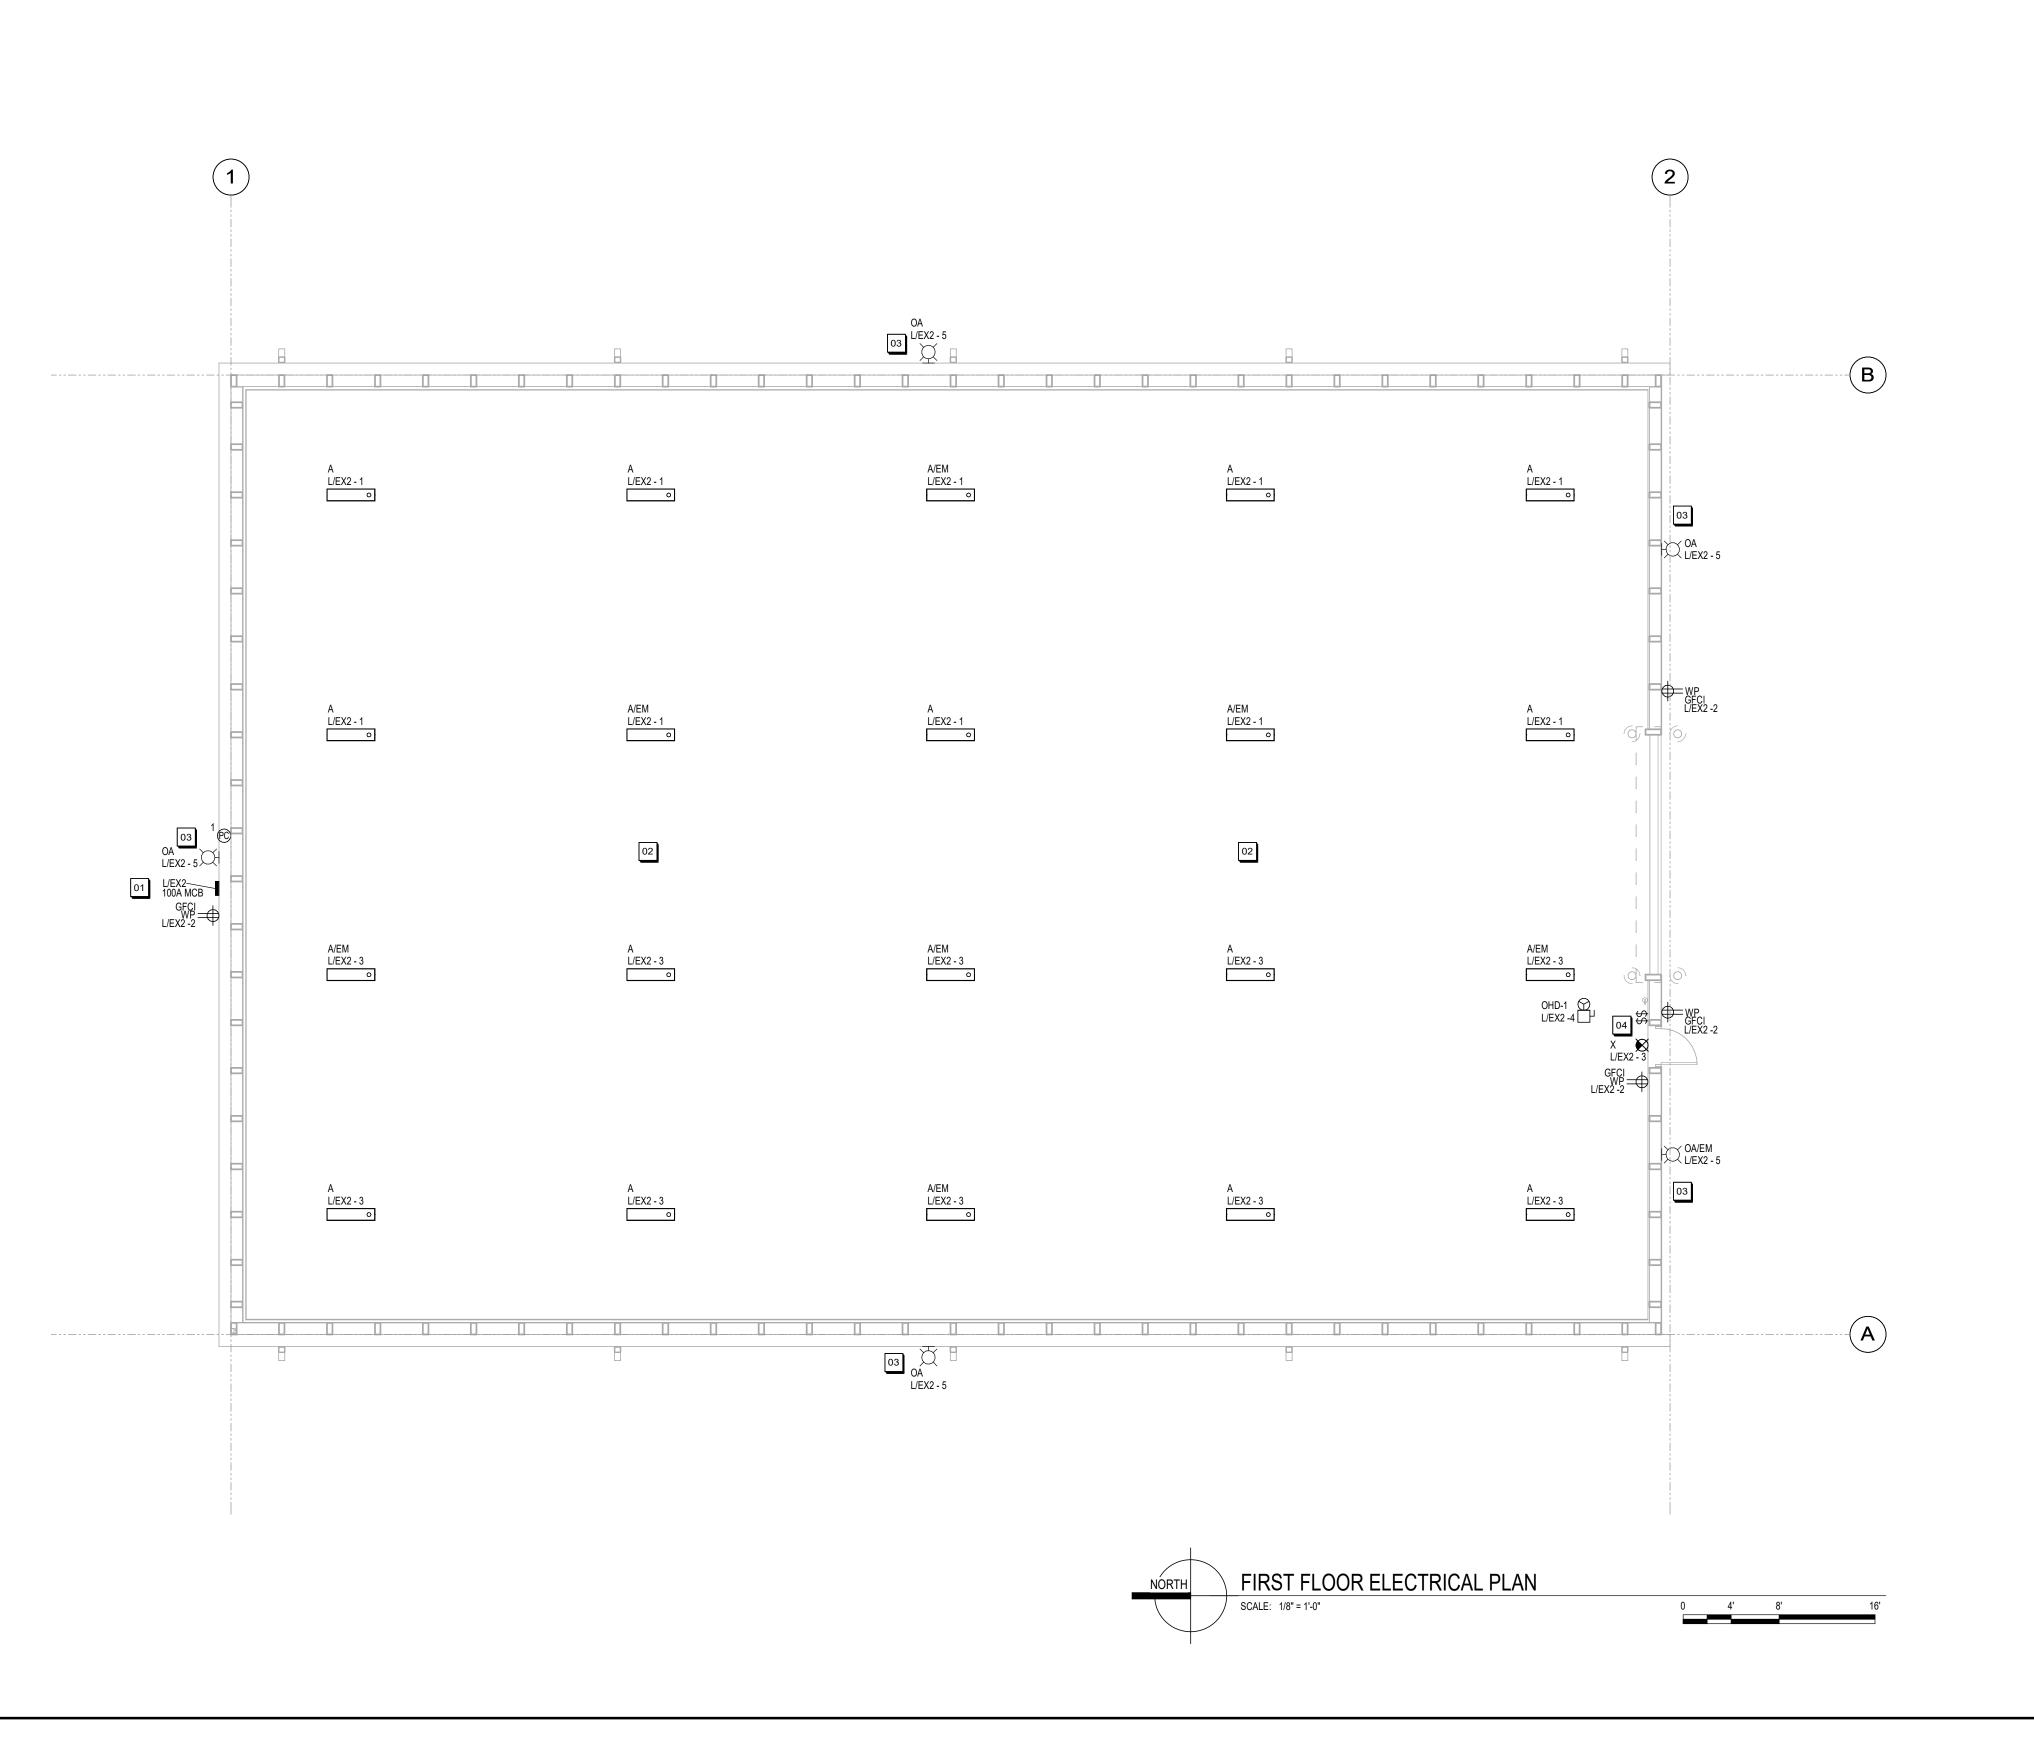
78290

APPROVED BY

REVIEWED BY BTW

DRAWN BY

**BUILDING SECTIONS** 



#### SHEET NOTES:

- 1. THE INFORMATION SHOWN ON THESE DRAWINGS WAS OBTAINED FROM THE ORIGINAL CONSTRUCTION DRAWINGS WHERE AVAILABLE. PRIOR TO BIDDING. EACH CONTRACTOR SHALL INVESTIGATE THE EXISTING SYSTEM TO THE EXTENT NECESSARY TO ACCURATELY DETERMINE THE EXACT EXTENT OF THE REQUIRED WORK.
- THE CONTRACTOR'S BID PRICE SHALL INCLUDE THE RESOLUTION OF MINOR DISCREPANCIES AT NO COST TO THE OWNER. PRIOR TO THE START OF THE RENOVATION THE CONTRACTOR SHALL RE-VERIFY ALL EXISTING ELECTRICAL SYSTEMS AND SYSTEM COMPONENTS AND REPORT ANY SIGNIFICANT DISCREPANCIES FOUND TO THE A/E FOR RESOLUTION. ANY CONTROLLED EQUIPMENT OR COMPONENTS NOT NOTED IN THE PLANS OR SPECS BUT FOUND PRIOR TO OR DURING COMPLETION OF THE NEW WORK SHALL ALSO BE REPORTED TO THE A/E.
- THE CONTRACTOR SHALL FIELD VERIFY ACTUAL LOCATION AND SIZE OF EXISTING BRANCH CIRCUIT WIRING, PANEL CAPACITY, CONDITION, AND BREAKERS.
- 4. CONTRACTOR SHALL PROTECT ALL WALLS, CEILINGS, FLOORS, LIGHTS AND OTHER FINISHED SURFACES. IF DAMAGED, CONTRACTOR SHALL REPAIR OR REPLACE TO MATCH EXISTING CONDITIONS AT NO ADDITIONAL COST TO THE OWNER. VERIFY LOCATIONS OF AND PROTECT EXISTING INTERIOR ELECTRICAL AND MECHANICAL UTILITIES AND SERVICES.
- 5. ALL MATERIALS & EQUIPMENT REQUIRING REMOVAL AND RELOCATION FOR REUSE SHALL BE CAREFULLY REMOVED AND STORED TO PREVENT DAMAGE AND SHALL BE REINSTALLED AS THE WORK PROGRESSES.
- 6. ANY ELECTRICAL EQUIPMENT FOUND TO BE NON-FUCTIONAL OR IN NEED OF REPAIR OR MAINTENANCE WORK SHALL BE REPORTED TO THE A/E AND THE OWNER.
- 7. ALL RACEWAY IS TO BE CONCEALED IN WALLS OR ABOVE CEILINGS UNLESS APPROVED BY THE A/E PRIOR TO INSTALLATION. IN EXPOSED CEILING AREAS, CONDUIT IS TO BE PAINTED TO MATCH.
- 8. ELECTRICAL CONTRACTOR TO CALCULATE VOLTAGE DROP OF ALL BRANCH CIRCUITS EXCEEDING 100' AND INCREASE CONDUCTOR AND GROUND SIZES AS REQUIRED TO MAINTAIN LESS THAN 5% COMBINED FEEDER/BRANCH VOLTAGE DROP AT THE FARTHEST LOAD.
- LIGHT FIXTURES LABELLED WITH "EM" ARE TO CONTAIN INTEGRATED BATTERY BACKUP. UPON NORMAL POWER LOSS, INTEGRATED BATTERY BACKUP POWER SHALL AUTOMATICALLY BE TRANSFERRED "ON."
- 10. EXIT SIGN LAYOUT SHOWN IS DIAGRAMMATIC. PROVIDE NECESSARY QUANTITY TO COMPLY WITH LINE OF SIGHT AND MAXIMUM 100' SPACING. COORDINATE WITH EGRESS PLANS ON ARCHITECTURAL SHEETS.
- ALL EXTERIOR LIGHT FIXTURES ARE TO BE CONTROLLED VIA EXTERIOR PHOTOCELL. ALL EXTERIOR LIGHT FIXTURES ARE TO HAVE DARK BRONZE FINISH.

### KEYNOTES

FROM EXISTING 240/120V 100A 1P 3W UNDERGROUND FEEDER FROM ADJACENT WAUKESHA COUNTY HIGHWAY OPERATIONS BUILDING, EXTENDING AS NEEDED. COORDINATE RELOCATION OF EXISTING INGRADE JUNCTION BOX FEEDING PANEL AS NEEDED. COORDINATE FINAL LOCATION OF NEW ELECTRICAL PANEL WITH GC.

EXISTING PANEL L/EX2 ON EXG. STRUCTURE IS TO BE DISCONNECTED FOR REMOVAL. REFEED NEW PANEL

- ELECTRICAL INSTALLATIONS ARE TO BE CORROSION RESISTANT. ALL RACEWAY AND CONDUIT IN EXPOSED INTERIOR LOCATIONS IS TO BE PVC COATED.
- 03 ALL CONDUIT FEEDING EXTERIOR LIGHT FIXTURES IS TO BE ROUTED WITHIN THE BUILDING.
- PROVIDE AND INSTALL (1) 1-POLE SWITCH TO CONTROL LIGHTS ON CIRCUIT L/EX2-1 AND (1) 1-POLE SWITCH TO CONTROL LIGHTS ON CIRCUIT L/EX2-3. TYPE X EXIT SIGN IS TO BE UNSWITCHED. ALL INTERIOR LIGHTS ARE TO UTILIZE OCCUPANCY SENSORS FOR AUTOMATIC ON/OFF CONTROL.



WAUKESHA COUNTY

SALT SHED REPLACEMENT

1641 WOODBURN ROAD WAUKESHA, WI 53188

	ISSUANCES / REVISIONS						
NO:	DESCRIPTION:	DATE:					
1	BID/CONSTRUCTION	01/07/202					

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> PROJECT NUMBER 78290

> > APPROVED BY

JJS

REVIEWED BY CTK

DRAWN BY

FIRST FLOOR ELECTRICAL PLAN

E101

	LIGHTING FIXTURE SCHEDULE										
TYPE	DESCRIPTION	MFR	CATALOG NO.	MOUNTING	VOLT	WATT	LAMP	NOTE			
Α	LED VAPORTITE WRAP	LITHONIA	FHE L48 24000LM PCL MD 120 GZ10 50K 80CRI SPD MSI6NWL OR EQUAL	SURFACE MOUNT TO BOTTOM OF STRUCTURE	120 V	149 W	LED 5000K	PROVIDE AND INSTALL MSI6NWL OR EQUAL OCCUPANCY SENSOR OPTION.			
A/EM	LED VAPORTITE WRAP	LITHONIA	FHE L48 24000LM PCL MD 120 GZ10 50K 80CRI FE14WCP SPD MSI6NWL OR EQUAL	SURFACE MOUNT TO BOTTOM OF STRUCTURE	120 V	149 W	LED 5000K	PROVIDE AND INSTALL MSI6NWL OR EQUAL OCCUPANCY SENSOR AND FE14WCP COLD WEATHER BATTERY BACKUP OPTIONS.			
OA	LED EXTERIOR WALL PACK	LITHONIA	WDGE3 LED P1 50K 70CRI R2 MVOLT SRM DDBXD OR EQUAL	WALL MOUNTED @ 20'-0" TO BOTTOM OF FIXTURE AFG	120 V	52 W	LED 5000K				
OA/EM	LED EXTERIOR WALL PACK	LITHONIA	WDGE3 LED P1 50K 70CRI R2 MVOLT SRM E20WC DDBXD OR EQUAL	WALL MOUNTED @ 20'-0" TO BOTTOM OF FIXTURE AFG	120 V	52 W	LED 5000K	INCLUDE COLD WEATHER BATTERY BACKUP OPTION.			
Х	UNIVERSAL LED EXIT LIGHT	LITHONIA	LQM S W 3 R MVOLT EL N SD OR EQUAL	UNIVERSAL	120 V	1 W	LED	PROVIDE WITH BATTERY BACKUP.			

GENERAL EQUIPMENT POWER CONNECTION SCHEDULE									
TYPE	DESCRIPTION	DISCONNECT	VOLTAGE	PHASE	HORSEPOWER	MOCP	MCA	FLA	NOTES
OHD-1	OVERHEAD DOOR OPERATOR	PROVIDE AND INSTALL NON-FUSED DISCONNECT SWITCH AT LINIT	120 V	1	1.00 hp	35.0 A	20.0 A	16.0 A	VERIFY FINAL REQUIREMENTS WITH FINAL EQUIPMENT SELECTION.

	SWITCH SCHEDULE									
CALLOUT	SYMBOL	MOUNTING	NOTE 1	NOTE 2						
1 POLE SWITCH	\$	MOUNT AT 44" TO BOTTOM UNLESS NOTED OTHERWISE								
EXTERIOR PHOTOCELL - LINE VOLTAGE	©	LOCATE HIGH ON WALL ON NORTH SIDE OF BUILDING OR WHERE SHOWN ON FLOORPLAN	ACCEPTABLE MODELS: INTERMATIC K4221C; TORK 2001; PRECISION ST-15							

RECEPTACLE SCHEDULE											
DESCRIPTION	SYMBOL	VOLTAGE	NOTE 1	NOTE 2							
RAISED WEATHERPROOF GFCI DUPLEX	grci 🔷	120 V	MOUNT @ 44" TO BOTTOM UNLESS OTHERWISE NOTED								

PANELBOARD: L/EX2

LOCATION: VOLTAGE: 120/240 V. 1 ø 3 W.

MOUNTING: SURFACE NEMA 1

MAIN DEVICE: 100.0 A MCB

BUS AMPS: 100 AMPS

PANELBOARD: L/EX2

VOLTAGE: 120/240 V. 1 ø 3 W.

A.I.C. RATING: 22,000 AMPS SYMMETRICAL


SPECIAL:

LOAD DESCRIPTION	BKR	P	СКТ	1	SE A /A	1	SE B /A	СКТ	Р	BKR	LOAD	DESCRIPTION	
LITES	20 A	1	1	1.7	0.7			2	1	20 A	RCPT		
LITES	20 A	1	3			1.7	1.9	4	1	35 A	OHD-1		
EXT. LITES	20 A	1	5	0.3				6					
			7					8					
			9					10					
			11					12					
			13					14					
			15					16					
			17					18					
	TOTAL LOA			<b>D</b> : 3 kVA		4 kVA							
	TOTAL AMP			<b>PS</b> : 22 A		29.8 A							
LOAD CLASSIFICATION	CONNECTED		D	DEMAND		ESTIMATE		D	PANEL TOTALS				
RCPT	720 VA			100.00%		720 VA							
LITES	3601 VA			125.00%		4501 VA			CONNECTED LOAD: 6241 VA				
MTR	1920 VA			125.00%		2400 VA			ES	STIMATED	DEMAND:	7621 VA	
									CON	NECTED	CURRENT:	26.0 A	
							EST. I	DEMAND	CURRENT:	31.8 A			

KEYNOTES

NEW 100A 120/240V 1-PHASE MCB PANEL TO REPLACE EXISTING EXTERIOR PANEL.

EXISTING UNDERGROUND FEEDER TO GRADE LEVEL JUNCTION BOX TO BE RELOCATED AND REFED TO LOCATION OF NEW PANEL. COORDINATE RELOCATION OF FEEDER AND JUNCTION BOX AND EXTEND AS NECESSARY. COORDINATE FINAL LOCATIONS WITH GC.

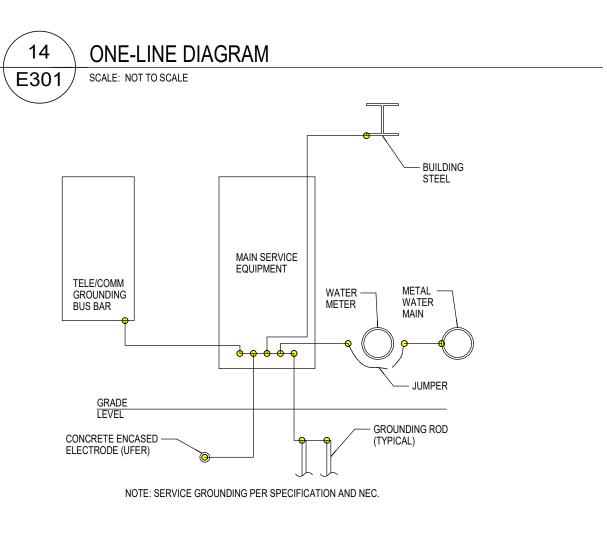

EXG. H/3 480Y/277V 3P 4W

225A RATED

225/3

EXG. XFMR

25KVA RATED

480V 2P 2W PRIM 240/120V 2P 3W SEC REL L/EX2 240/120V 2P 3W

100A RATED

100/2


EXG. MSB/H 480Y/277V 3P 4W

225/3

2000A RATED

2000/3)



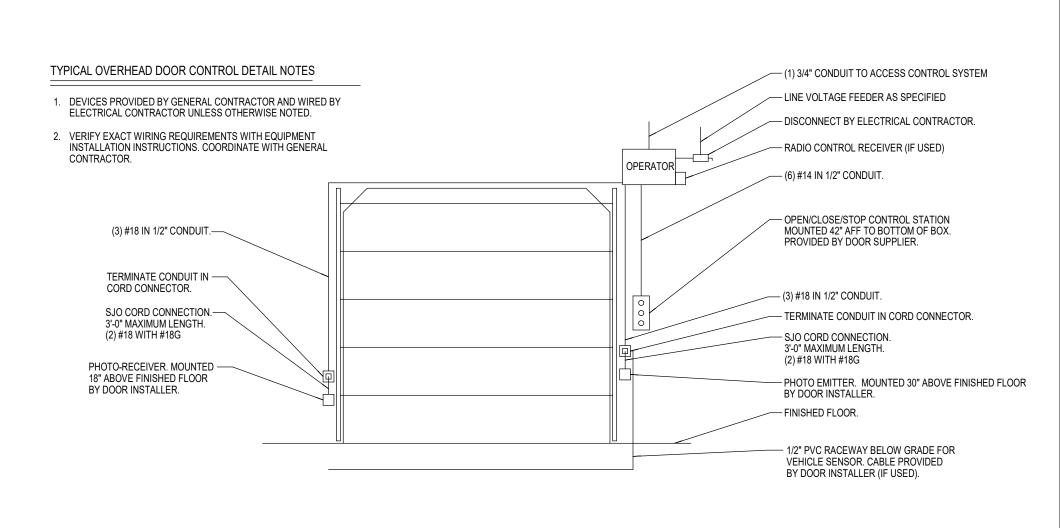

9 TYPICAL GRADE LEVEL OVERHEAD DOOR CONTROL DETAIL
SCALE: NOT TO SCALE

ANGUS-YOUNG
ARCHITECTS/ENGINEERS
Janesville | Madison | Rockford

WAUKESHA COUNTY

SALT SHED REPLACEMENT

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> PROJECT NUMBER 78290

> > APPROVED BY JJS

REVIEWED BY CTK

> DRAWN BY SMS

ELECTRICAL SCHEDULES, DETAILS & ONE-LINE DIAGRAM

E301