

T-Mobile® stick together®

SITE NUMBER: ML531081

JURISDICTION: CITY OF WAUKESHA

SITE NAME: CHRIST THE LIFE EVANGELICAL


CITY: WAUKESHA

SITE TYPE: 140' MONOPOLE


COUNTY: WAUKESHA COUNTY

Parallel
INFRASTRUCTURE

PLANS PREPARED BY:
CelluSite, LLC

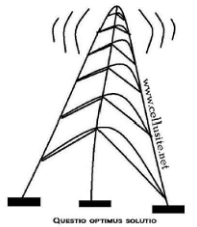

ENGINEERING LICENSE:

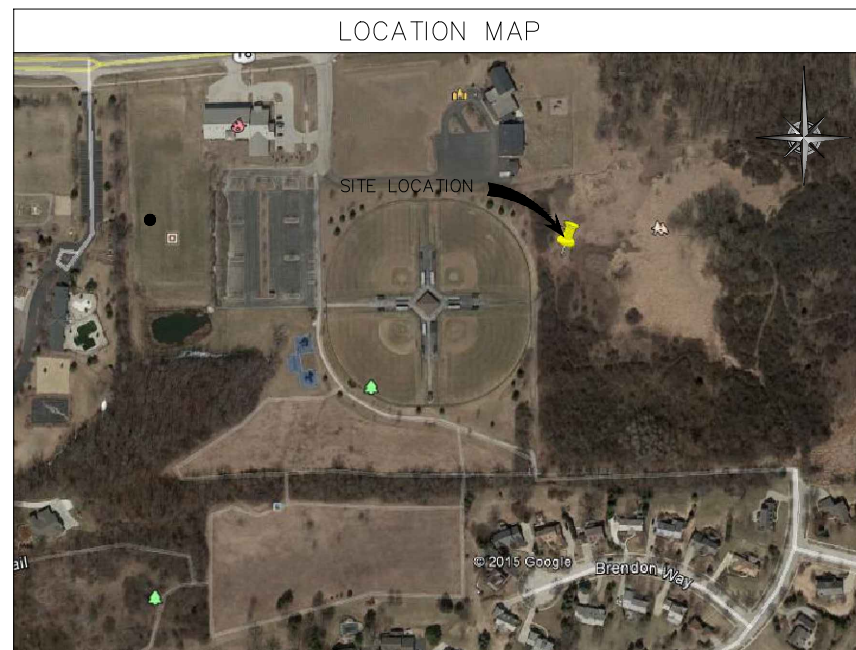

PROJECT DESCRIPTION

INSTALL T-MOBILE EQUIPMENT CABINET ON NEW CONCRETE PAD AT GRADE. NO NEW WATER OR SEWER IS REQUIRED AS FACILITY IS UNMANNED.

INITIAL BUILD OUT:
6 NEW ANTENNAS, 1 HCS, 2 COVP'S, 1 CABINET, 5 TOWER MODULES, 2 GROUND MODULES

CONTACTS

APPLICANT
T-MOBILE USA
8550 BRYN MAWR AVE., SUITE 100
CHICAGO, ILLINOIS 60631
TEL: (773) 444-5400
CONTACT: TBD

PROPERTY OWNER CONTACT:
PROPERTY OWNER: CHRIST THE LIFE EVANGELICAL LUTHERN CHURCH
CONTACT: CARLTON MANSKE
3031 SUMMIT AVE.
WAUKESHA WI 53188
TEL: (262) 547-7232
ALTERNATE: (262) 547-7394 FAX

SHEET INDEX

SHEET NUMBER:	DESCRIPTION:
T-1	TITLE SHEET
T-2	GENERAL NOTES & SPECIFICATIONS
T-3	GENERAL NOTES & SPECIFICATIONS
SURV.	SITE SURVEY
C-1	OVERALL SITE PLAN
C-2	ENLARGED SITE PLANS
C-3	EQUIPMENT ELEVATION
C-4	ICE BRIDGE, GPS AND HYBRID CABLE DETAILS
C-5	PLATFORM ELEVATIONS
C-6	PLATFORM DETAILS
C-7	PLATFORM NOTES
C-8	FENCE DETAILS
A-1	TOWER ELEVATION
A-2	ANTENNA PLAN
A-3	EQUIPMENT SPECIFICATIONS
A-4	RF DATA SHEET
A-5	RISER DIAGRAM
A-6	ANTENNA CONFIGURATION SHEET
E-1	UTILITY PLANS
E-2	H-FRAME & UTILITY PLANS
E-3	UTILITY RISER DIAGRAM & PANEL SCHEDULE
GR-1	GROUNDING PLAN
GR-2	GROUNDING RISER
GR-3	GROUNDING DETAILS
REV	REVISIONS PAGE

DATE:	DESCRIPTION:	BY:	REV:
06/03/15	REVIEW CD	BMW	A
06/04/15	REVIEW CD	BMW	B
07/21/15	REVIEW CD	BMW	C
08/20/15	REVIEW CD	BMW	D

PROJECT LOCATION

COORDINATES (NAD83):
LAT: 43° 1' 8.75"
LONG: -88° 16' 44.24"
AMSL: 879.91'

SITE ADDRESS:
3031 SUMMIT AVE.
WAUKESHA, WI 53188
WAUKESHA COUNTY

*PER 1A DATED 6/03/15

UTILITIES

ELECTRIC:
WE ENERGY
TEL: 414-221-2345
CONTACT: N/A

TELEPHONE:
AT&T
TEL: 855-327-0860
CONTACT: N/A

PROPERTY SUMMARY

PROPERTY ADDRESS:
3031 SUMMIT AVE.
WAUKESHA, WI 53188

ZONING:
WAUKESHA COUNTY, IL

ASSESSOR'S PARCEL NUMBER (APN):
TBD



APPLICABLE CODES

BUILDING CODE: INTERNATIONAL BUILDING CODE 2012 WITH AMENDMENTS
ELECTRICAL CODE: NATIONAL ELECTRICAL CODE 2011

PROJECT TEAM

LEAD ENGINEER
JACOB CORALSKI, P.E.
IRISH TOWER, LLC
4603 BERMUDA DR.
SUGAR LAND, TX 77479

LEAD SITE ACQ.
CELLUSTE, LLC
103 WILSHIRE COURT,
NOBLESVILLE, IN 46062
TEL: (317) 507-4541
FAX: N/A

DRIVING DIRECTIONS

DEPART T-MOBILE OFFICE [8550 W BRYN MAWR AVE, CHICAGO, IL 60631] ON W BRYN MAWR AVE (EAST) 0.3 MI. TURN LEFT (NORTH) ONTO IL-171 [N CUMBERLAND AVE] 0.4 MI. TAKE RAMP (RIGHT) ONTO I-90 [KENNEDY EXPY W] 0.8 MI. *TOLL ROAD* KEEP LEFT TO STAY ON I-90 [JANE ADDAMS MEMORIAL TOLLWAY] *TOLL ROAD* TAKE RAMP (RIGHT) ONTO I-294 [TRI-STATE TOLLWAY] 12.7 MI. *TOLL ROAD* MERGE ONTO I-94 [TRI-STATE TOLLWAY] 23.9 MI. STAY ON I-94 [US-41] (NORTH) 33.4 MI. ENTERING WISCONSIN AT EXIT 316, TAKE RAMP (LEFT) ONTO I-43 [I-894] 5.2 MI. KEEP LEFT ONTO I-894 [ZOO FWY] 4.3 MI. AT EXIT 1B, TAKE RAMP (LEFT) ONTO I-94 13.1 MI. AT EXIT 291, TURN OFF ONTO RAMP 0.3 MI. ROAD NAME CHANGES TO LOCAL ROAD(S) 21 YDS. TURN LEFT (SOUTH) ONTO CR-TT [MEADOWBROOK RD] 2.0 MI. TURN LEFT (EAST) ONTO US-18 [SUMMIT AVE] 0.4 MI. TURN RIGHT (SOUTH) ONTO LOCAL ROAD(S) 164 YDS. ARRIVE ML53108-1 CHRIST THE LIFE.

REVIEW

PENDING APPROVAL OF THE JURISDICTION, THE FOLLOWING PARTIES HAVE REVIEWED THE DESIGN WITHIN THEIR FUNCTIONAL RESPONSIBILITIES AND HAVE APPROVED THIS PROJECT FOR CONSTRUCTION. CONTRACTORS MAY NOT START CONSTRUCTION WITHOUT A NOTICE TO PROCEED (NTP) FROM T-MOBILE.

	PRINT NAME	SIGNATURE	DATE
LANDLORD	_____	_____	_____
PRECON. MGR	_____	_____	_____
DEVELOP. MGR	_____	_____	_____
CONST. INSP.	_____	_____	_____
A&E MGR	_____	_____	_____
RF ENGINEER	_____	_____	_____
OPERATIONS	_____	_____	_____
ZONING REP	_____	_____	_____
UTILITIES	_____	_____	_____

ISSUED FOR PERMIT

SITE INFORMATION:
ML531081
Christ the Life
Evangelical
Lutheran Church
WI-Waukesha-
Summit
3031 Summit Ave
Waukesha, WI 53188
Waukesha COUNTY

SHEET TITLE:
TITLE SHEET

SHEET NUMBER:
T-1

GENERAL NOTES


- 1) A FULL BOUNDARY SURVEY WAS NOT PERFORMED ON THE PARENT PARCEL SHOWN ON THIS SHEET. MONUMENTS SHOWN AS "FOUND" AND RECORDED DOCUMENTS WERE USED TO DESCRIBE THE EASEMENTS AND LEASED PREMISES.
- 2) THE LOCATIONS OF UTILITY MAINS, STRUCTURES, AND SERVICE CONNECTIONS PLOTTED ON THIS DRAWING ARE APPROXIMATE ONLY AND WERE OBTAINED FROM RECORDS MADE AVAILABLE TO XCEL CONSULTANTS, INC. THERE MAY BE OTHER EXISTING UTILITY MAINS, STRUCTURES AND SERVICE CONNECTIONS NOT KNOWN TO XCEL CONSULTANTS, INC., AND NOT SHOWN ON THIS DRAWING.
- 3) BEARINGS ARE REFERENCED TO THE SOUTH LINE OF SECTION 23 WITH THE ASSUMED BEARING OF N89°57'46"E.
- 4) THE SURVEY FOR THIS MAP WAS PERFORMED ON MARCH 16, 2015 BY XCEL CONSULTANTS, INC.; REVIEW WAS PERFORMED BY JAMES FAETANNI, P.L.S.
- 5) THERE DOES NOT APPEAR TO BE TELEPHONE AND ELECTRICAL SERVICE PRESENT ON OR NEAR THE LEASED PREMISES, BUT PARENT PROPERTY DOES HAVE SERVICES.
- 6) THERE DOES NOT APPEAR TO BE ANY APPLICABLE BUFFER ZONES OR LANDSCAPE REQUIREMENTS.
- 7) THE LEASED PREMISES IS CONTIGUOUS ALONG ITS COMMON BOUNDARIES TO THE ACCESS AND UTILITY EASEMENT, WHICH IN TURN IS CONTIGUOUS ALONG ITS COMMON BOUNDARIES TO THE RIGHT OF WAY OF SUMMIT ROAD, AND THAT THERE ARE NO GAPS, GORES, SPACES OR OVERLAPS BETWEEN OR AMONG ANY OF SAID PARCELS OF LAND.

SITE INFORMATION

SITE OWNER: CHRIST THE LIFE EVANGELICAL LUTHERAN CHURCH
SITE ADDRESS: 3031 SUMMIT ROAD, WAUKESHA, WI 53188 WAUKESHA COUNTY
TAX PARCEL NUMBERS: WAK0991999001
THIS PARCEL IS ZONED: I-1, INSTITUTIONAL DISTRICT & C-1, LOWLAND CONSERVANCY DISTRICT PER THE CITY OF WAUKESHA, WISCONSIN JURISDICTION.
SETBACKS: I-1
 FRONT = 25'
 REAR = 10'
 SIDE = 40'
THE CENTER OF TOWER IS OUTSIDE THE CURRENT SETBACK LINES
HEIGHT RESTRICTION = NO PRINCIPAL BUILDING OR PART OF A PRINCIPAL BUILDING SHALL EXCEED THIRTY-FIVE (35) FEET IN HEIGHT. NO ACCESSORY BUILDING SHALL EXCEED FIFTEEN (15) FEET IN HEIGHT.
TOWER DOES EXCEED HEIGHT RESTRICTION
JURISDICTION: CITY OF WAUKESHA, WAUKESHA COUNTY
FEMA: ACCORDING TO FEDERAL EMERGENCY MANAGEMENT AGENCY MAPS, THE PROPOSED TELECOMMUNICATIONS SITE IS LOCATED IN ZONE X, COMMUNITY PANEL NO. 55133C0194C, DATED NOVEMBER 4, 2014.
WETLANDS: NO WETLANDS AREAS HAVE BEEN INVESTIGATED BY THIS SURVEY

SURVEY PLAT


PROPERTY OWNER: CHRIST THE LIFE EVANGELICAL LUTHERAN CHURCH
 ADDRESS: 3031 SUMMIT AVENUE, WAUKESHA, WI 53188 WAUKESHA COUNTY

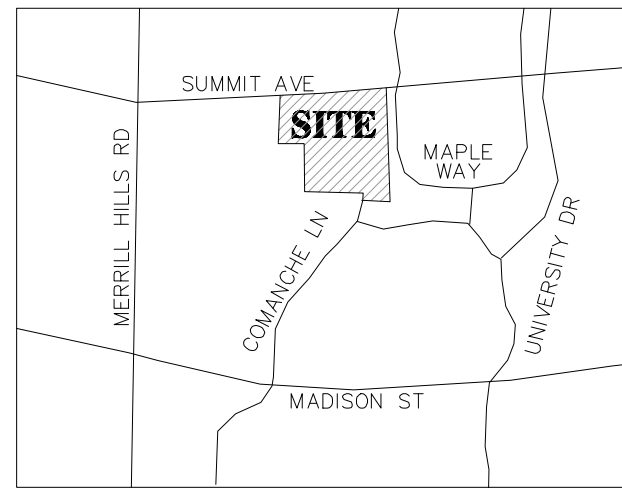

VICINITY MAP
NOT TO SCALE


LEGAL DESCRIPTIONS

PARENT PARCEL
 ALL THOSE CERTAIN PARCELS OF LAND SITUATED IN SECTION 32, TOWNSHIP 7 NORTH, RANGE 19 EAST, THE CITY OF WAUKESHA, WAUKESHA COUNTY, WISCONSIN, BOUNDED AND DESCRIBED AS FOLLOWS:
 BEGINNING AT THE SOUTHEAST CORNER OF SAID SOUTHWEST 1/4; THENCE NORTH 00 DEGREES 01' 08" EAST ALONG THE EAST LINE OF SAID SOUTHWEST 1/4 AND ALONG THE WEST LINE OF MAPLE LANE HILLS; A RECORDED SUBDIVISION IN SAID SECTION 32, 1245.604 FEET TO THE SOUTH RIGHT-OF-WAY LINE OF UNITED STATES HIGHWAY 18; THENCE SOUTH 85 DEGREES 52' 38" WEST ALONG SAID SOUTH RIGHT-OF-WAY LINE 1102.688 FEET; THENCE SOUTH 83 DEGREES 00' 54" WEST ALONG SAID SOUTH RIGHT-OF-WAY LINE 200.250 FEET; THENCE SOUTH 85 DEGREES 52' 38" WEST ALONG SAID SOUTH RIGHT-OF-WAY LINE 144.810 FEET; THENCE SOUTH 00 DEGREES 06' 34" WEST 350.000 FEET; THENCE NORTH 89 DEGREES 57' 46" EAST 588.993 FEET; THENCE SOUTH 00 DEGREES 06' 34" WEST 732.507 FEET; THENCE NORTH 89 DEGREES 57' 46" EAST 665.667 FEET; THENCE SOUTH 00 DEGREES 02' 14" EAST 50.000 FEET TO THE SOUTH LINE OF SAID SOUTHWEST 1/4; THENCE NORTH 89 DEGREES 57' 46" EAST ALONG THE SOUTH LINE OF SAID SOUTHWEST 1/4 220.000 FEET TO THE PLACE OF BEGINNING.

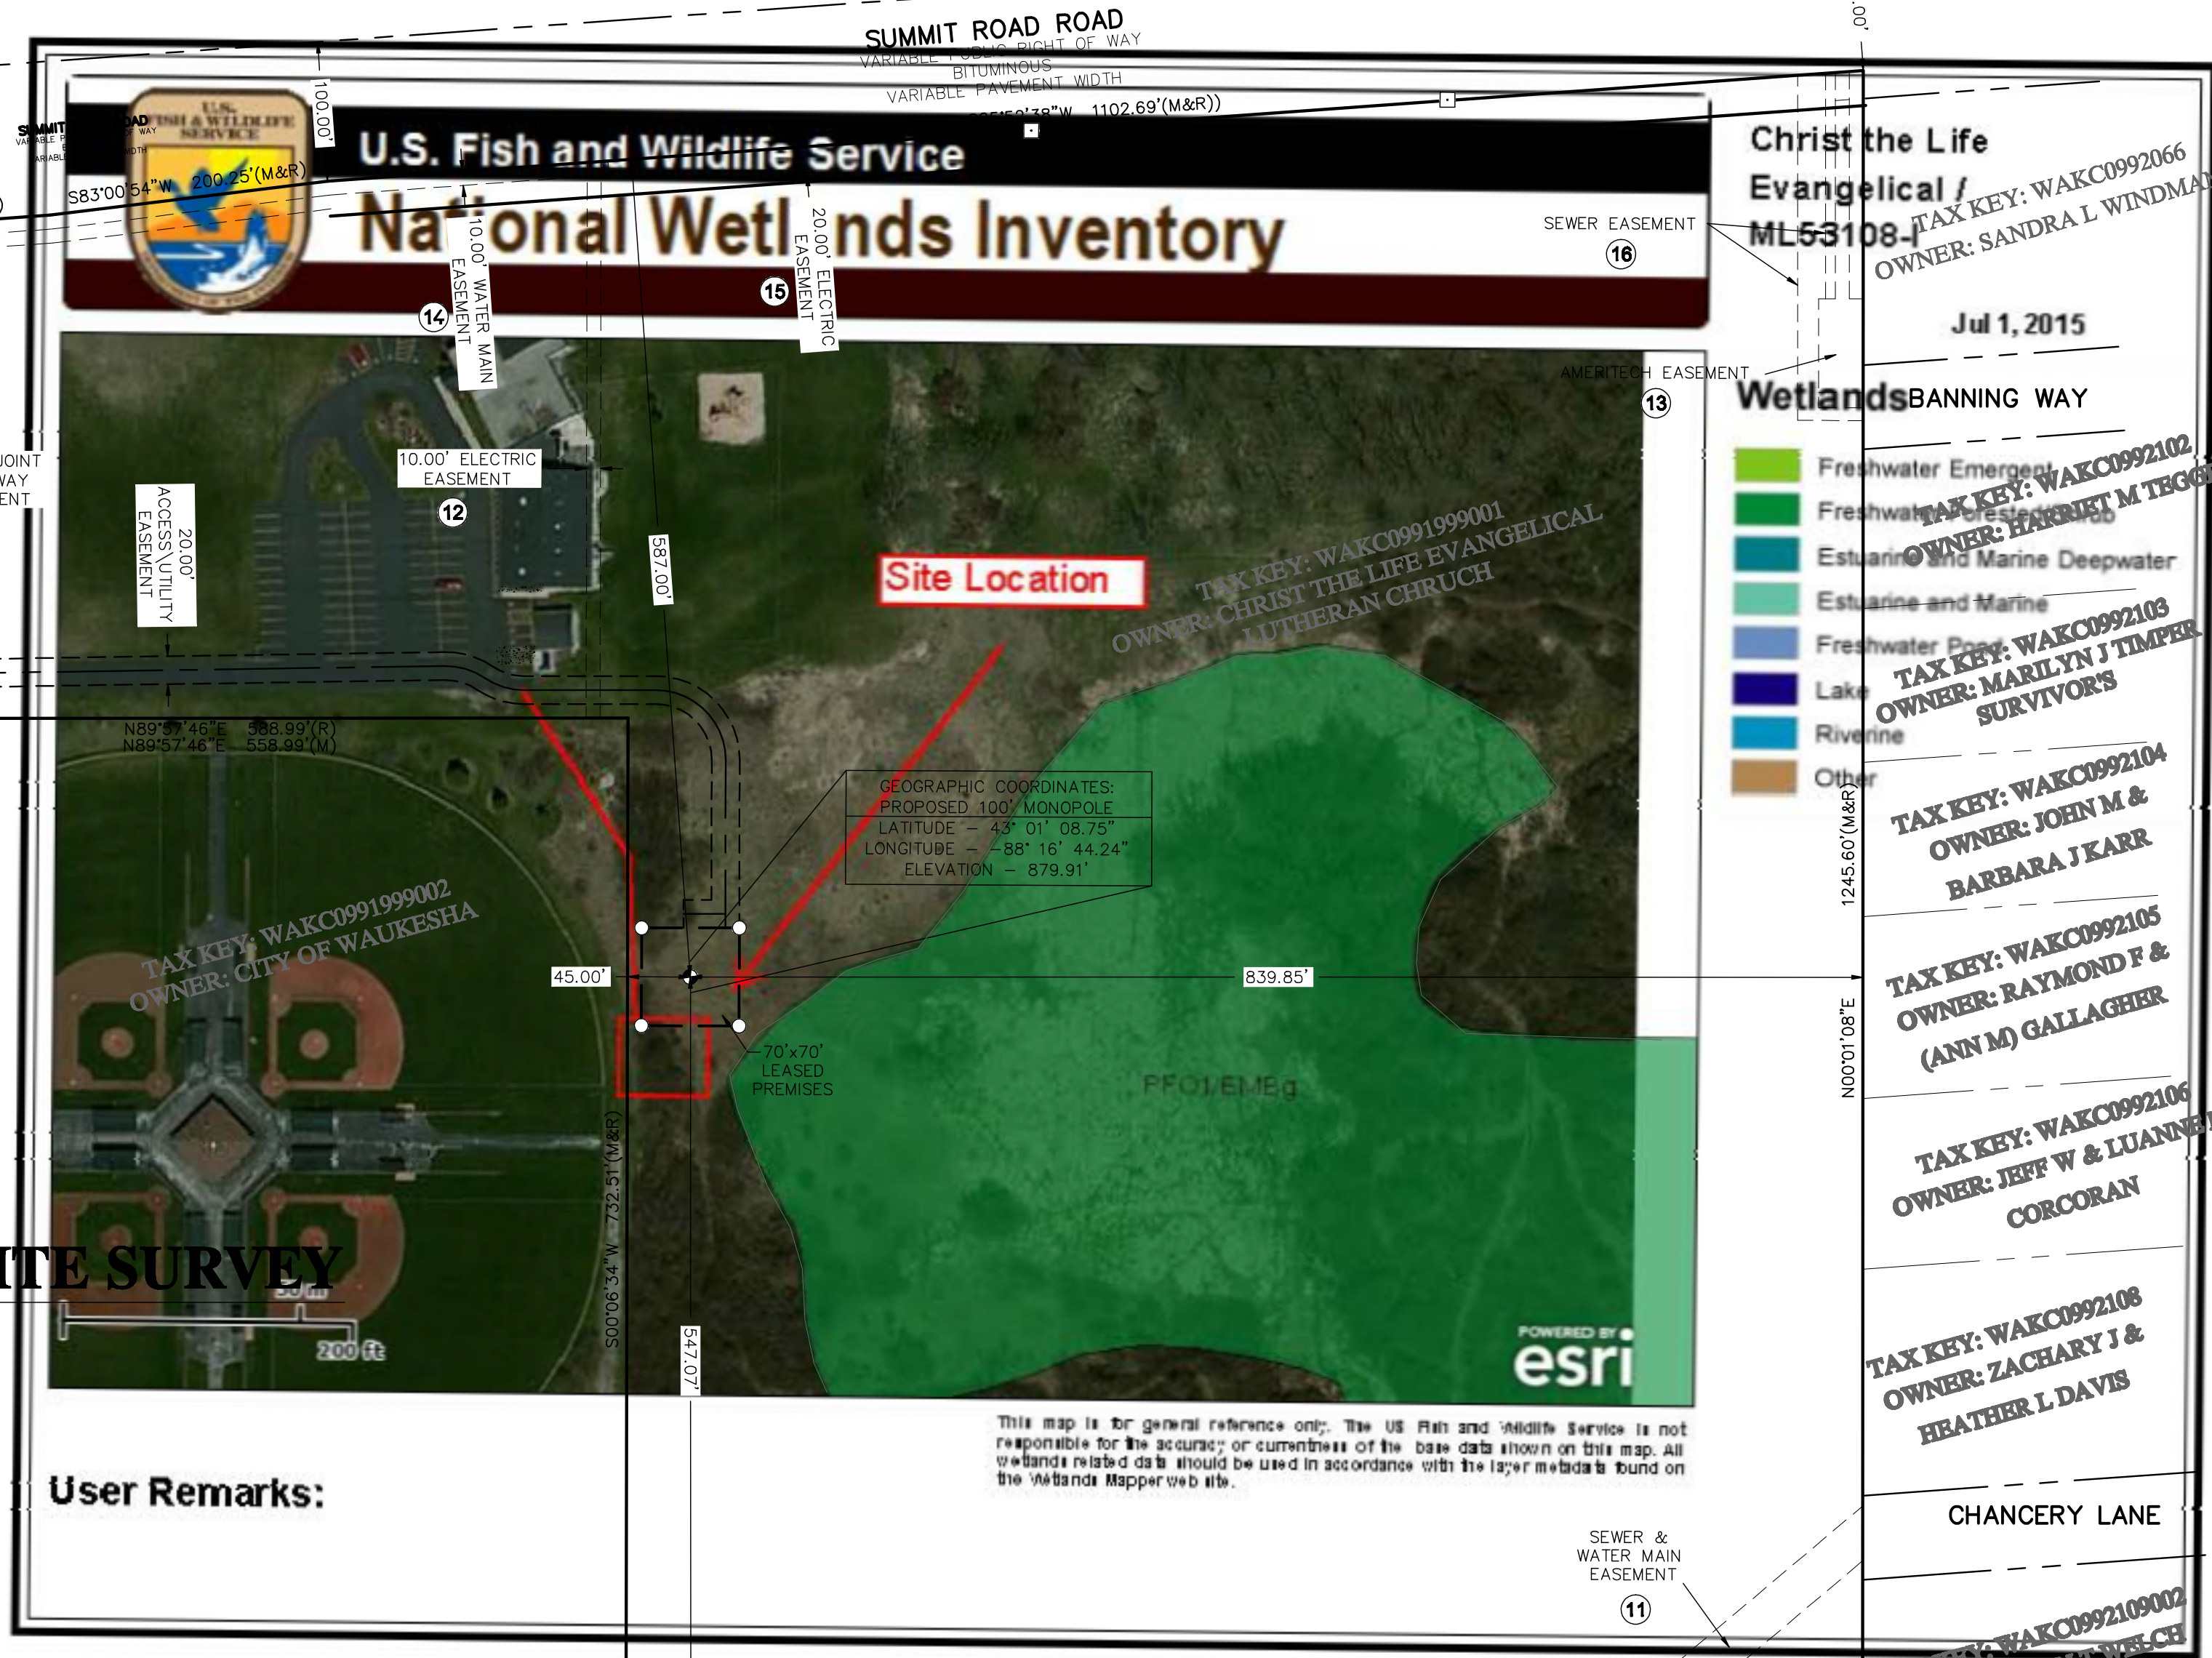


UTILITY CONTACT INFORMATION

POWER CONTACT: TBD
 TELEPHONE CONTACT: TBD

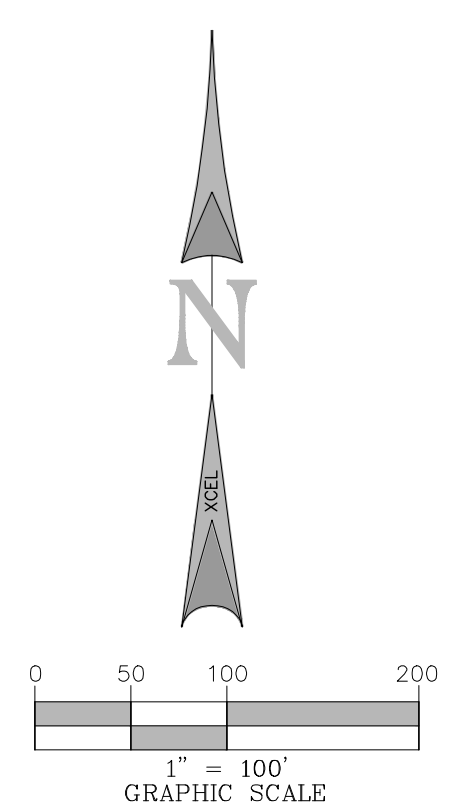

TO: PI TELECOM INFRASTRUCTURE I, LLC, A DELAWARE LIMITED LIABILITY COMPANY, AND CHICAGO TITLE INSURANCE COMPANY
 I, JAMES A. FAETANNI, AN ILLINOIS PROFESSIONAL LAND SURVEYOR, CERTIFY THAT THE INFORMATION SHOWN HEREON WAS OBTAINED USING DATA FROM AN AERIAL PHOTO SURVEY MADE UNDER MY DIRECT SUPERVISION AND THAT THE FIELD SURVEY AND THE COMPLETION OF ANY WORK SHOWN HEREON WERE CONDUCTED IN ACCORDANCE WITH THE ILLINOIS MINIMUM STANDARDS OF PRACTICE AS SET FORTH UNDER SECTION 1270.3667 OF THE ILLINOIS PROFESSIONAL LAND SURVEYORS ACT OF 1989 AS PUBLISHED BY THE ILLINOIS JOINT COMMITTEE ON ADMINISTRATIVE MATTERS.
 DATE: _____
 JAMES A. FAETANNI LICENSE NUMBER 035-003494 MY LICENSE RENEWAL DATE IS NOVEMBER 30, 2016 SHEETS COVERED BY THIS SEAL 2 OF 2

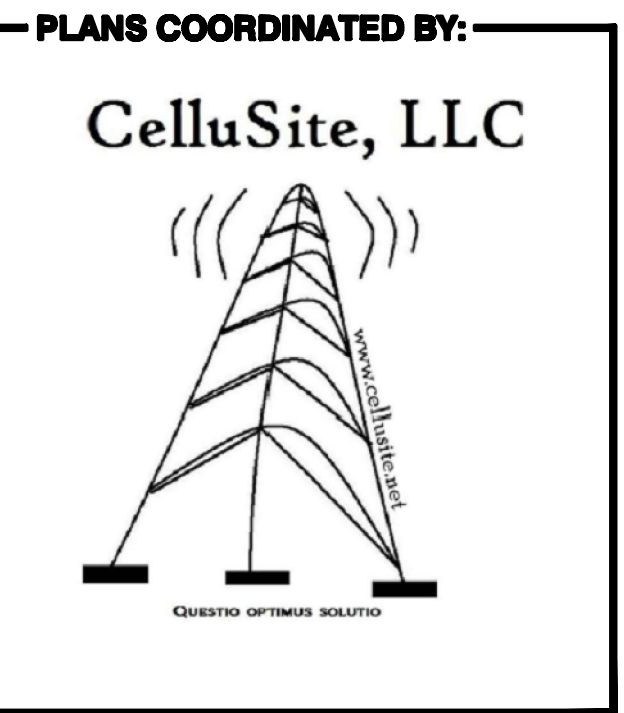

PLANS PREPARED BY:
 BRIAN HOLLAND (E) BHOLLAND@XCELCONSULTANTSINC.COM
 8300 42ND STREET WEST
 ROCK ISLAND, IL 61201
 (O) 309-787-9988
 (F) 309-756-5540

XCEL Consultants
 Civil Engineering & Professional Land Surveying
 JOB # 150566

DATE	DESCRIPTION	BY	REV

SITE INFORMATION:

CHRIST THE LIFE EVANGELICAL LUTHERAN CHURCH
 CHRIST THE LIFE EVANGELICAL LUTHERAN CHURCH
 3031 SUMMIT AVENUE, WAUKESHA, WI 53188 WAUKESHA COUNTY

SHEET TITLE:
SURVEY PLAT

SHEET NUMBER:
1 OF 2

SCALE: 1"=100'

GENERAL NOTES


- 1) A FULL BOUNDARY SURVEY WAS NOT PERFORMED ON THE PARENT PARCEL SHOWN ON THIS SHEET. MONUMENTS SHOWN AS "FOUND" AND RECORDED DOCUMENTS WERE USED TO DESCRIBE THE EASEMENTS AND LEASED PREMISES.
- 2) THE LOCATIONS OF UTILITY MAINS, STRUCTURES, AND SERVICE CONNECTIONS PLOTTED ON THIS DRAWING ARE APPROXIMATE ONLY AND WERE OBTAINED FROM RECORDS MADE AVAILABLE TO XCEL CONSULTANTS, INC. THERE MAY BE OTHER EXISTING UTILITY MAINS, STRUCTURES AND SERVICE CONNECTIONS NOT KNOWN TO XCEL CONSULTANTS, INC., AND NOT SHOWN ON THIS DRAWING.
- 3) BEARINGS ARE REFERENCED TO THE SOUTH LINE OF SECTION 23 WITH THE ASSUMED BEARING OF N89°57'46"E.
- 4) THE SURVEY FOR THIS MAP WAS PERFORMED ON MARCH 16, 2015 BY XCEL CONSULTANTS, INC.; REVIEW WAS PERFORMED BY JAMES FAETANNI, P.L.S.
- 5) THERE DOES NOT APPEAR TO BE TELEPHONE AND ELECTRICAL SERVICE PRESENT ON OR NEAR THE LEASED PREMISES, BUT PARENT PROPERTY DOES HAVE SERVICES.
- 6) THERE DOES NOT APPEAR TO BE ANY APPLICABLE BUFFER ZONES OR LANDSCAPE REQUIREMENTS.
- 7) THE LEASED PREMISES IS CONTIGUOUS ALONG ITS COMMON BOUNDARIES TO THE ACCESS AND UTILITY EASEMENT, WHICH IN TURN IS CONTIGUOUS ALONG ITS COMMON BOUNDARIES TO THE RIGHT OF WAY OF SUMMIT ROAD, AND THAT THERE ARE NO GAPS, GORES, SPACES OR OVERLAPS BETWEEN OR AMONG ANY OF SAID PARCELS OF LAND.

SITE INFORMATION

SITE OWNER: CHRIST THE LIFE EVANGELICAL LUTHERAN CHURCH
 SITE ADDRESS: 3031 SUMMIT ROAD, WAUKESHA, WI 53188 WAUKESHA COUNTY
 TAX PARCEL NUMBERS: WAK0991999001
 THIS PARCEL IS ZONED: I-1, INSTITUTIONAL DISTRICT & C-1, LOWLAND CONSERVANCY DISTRICT PER THE CITY OF WAUKESHA, WISCONSIN JURISDICTION.
 SETBACKS: I-1
 FRONT = 25'
 REAR = 10'
 SIDE = 40'
THE CENTER OF TOWER IS OUTSIDE THE CURRENT SETBACK LINES
 HEIGHT RESTRICTION = NO PRINCIPAL BUILDING OR PART OF A PRINCIPAL BUILDING SHALL EXCEED THIRTY-FIVE (35) FEET IN HEIGHT. NO ACCESSORY BUILDING SHALL EXCEED FIFTEEN (15) FEET IN HEIGHT.
TOWER DOES EXCEED HEIGHT RESTRICTION
 JURISDICTION: CITY OF WAUKESHA, WAUKESHA COUNTY
 FEMA: ACCORDING TO FEDERAL EMERGENCY MANAGEMENT AGENCY MAPS, THE PROPOSED TELECOMMUNICATIONS SITE IS LOCATED IN ZONE X, COMMUNITY PANEL NO. 55133C0194C, DATED NOVEMBER 4, 2014.
 WETLANDS: NO WETLANDS AREAS HAVE BEEN INVESTIGATED BY THIS SURVEY

SURVEY PLAT


PROPERTY OWNER: CHRIST THE LIFE EVANGELICAL LUTHERAN CHURCH
 ADDRESS: 3031 SUMMIT AVENUE, WAUKESHA, WI 53188 WAUKESHA COUNTY

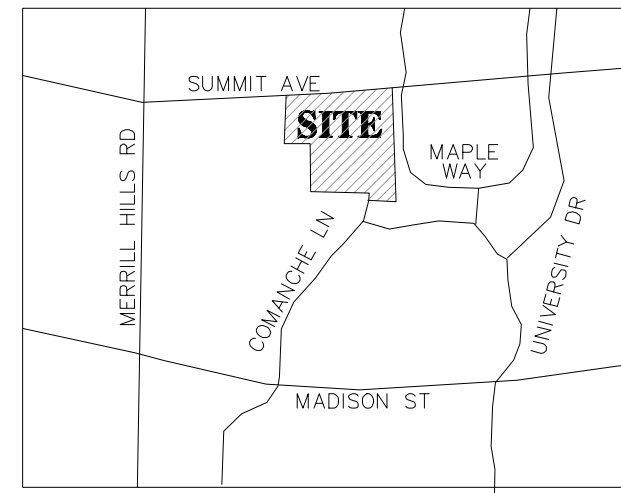

VICINITY MAP
NOT TO SCALE


LEGAL DESCRIPTIONS

ALL THOSE CERTAIN PARCELS OF LAND SITUATED IN SECTION 32, TOWNSHIP 7 NORTH, RANGE 19 EAST, THE CITY OF WAUKESHA, WAUKESHA COUNTY, WISCONSIN.
PARENT PARCEL
 ALL THAT PART OF THE SOUTHEAST 1/4 AND SOUTHWEST 1/4 OF THE SOUTHWEST 1/4 OF SECTION 32, TOWN 7 NORTH, RANGE 19 EAST, CITY OF WAUKESHA, COUNTY OF WAUKESHA, STATE OF WISCONSIN, BOUNDED AND DESCRIBED AS FOLLOWS:
 BEGINNING AT THE SOUTHEAST CORNER OF SAID SOUTHWEST 1/4; THENCE NORTH 00 DEGREES 01' 08" EAST ALONG THE EAST LINE OF SAID SOUTHWEST 1/4 AND ALONG THE WEST LINE OF MAPLE LANE HILLS, A RECORDED SUBDIVISION IN SAID SECTION 32, 1245.604 FEET TO THE SOUTH RIGHT-OF-WAY LINE OF UNITED STATES HIGHWAY 18; THENCE SOUTH 85 DEGREES 52' 38" WEST ALONG SAID SOUTH RIGHT-OF-WAY LINE 1102.688 FEET; THENCE SOUTH 83 DEGREES 00' 54" WEST ALONG SAID SOUTH RIGHT-OF-WAY LINE 200.250 FEET; THENCE SOUTH 85 DEGREES 52' 38" WEST ALONG SAID SOUTH RIGHT-OF-WAY LINE 144.810 FEET; THENCE SOUTH 00 DEGREES 06' 34" WEST 350.000 FEET; THENCE NORTH 89 DEGREES 57' 46" EAST 588.993 FEET; THENCE SOUTH 00 DEGREES 06' 34" WEST 732.507 FEET; THENCE NORTH 89 DEGREES 57' 46" EAST 665.667 FEET; THENCE SOUTH 00 DEGREES 02' 14" EAST 50.000 FEET TO THE SOUTH LINE OF SAID SOUTHWEST 1/4; THENCE NORTH 89 DEGREES 57' 46" EAST ALONG THE SOUTH LINE OF SAID SOUTHWEST 1/4 220.000 FEET TO THE PLACE OF BEGINNING.

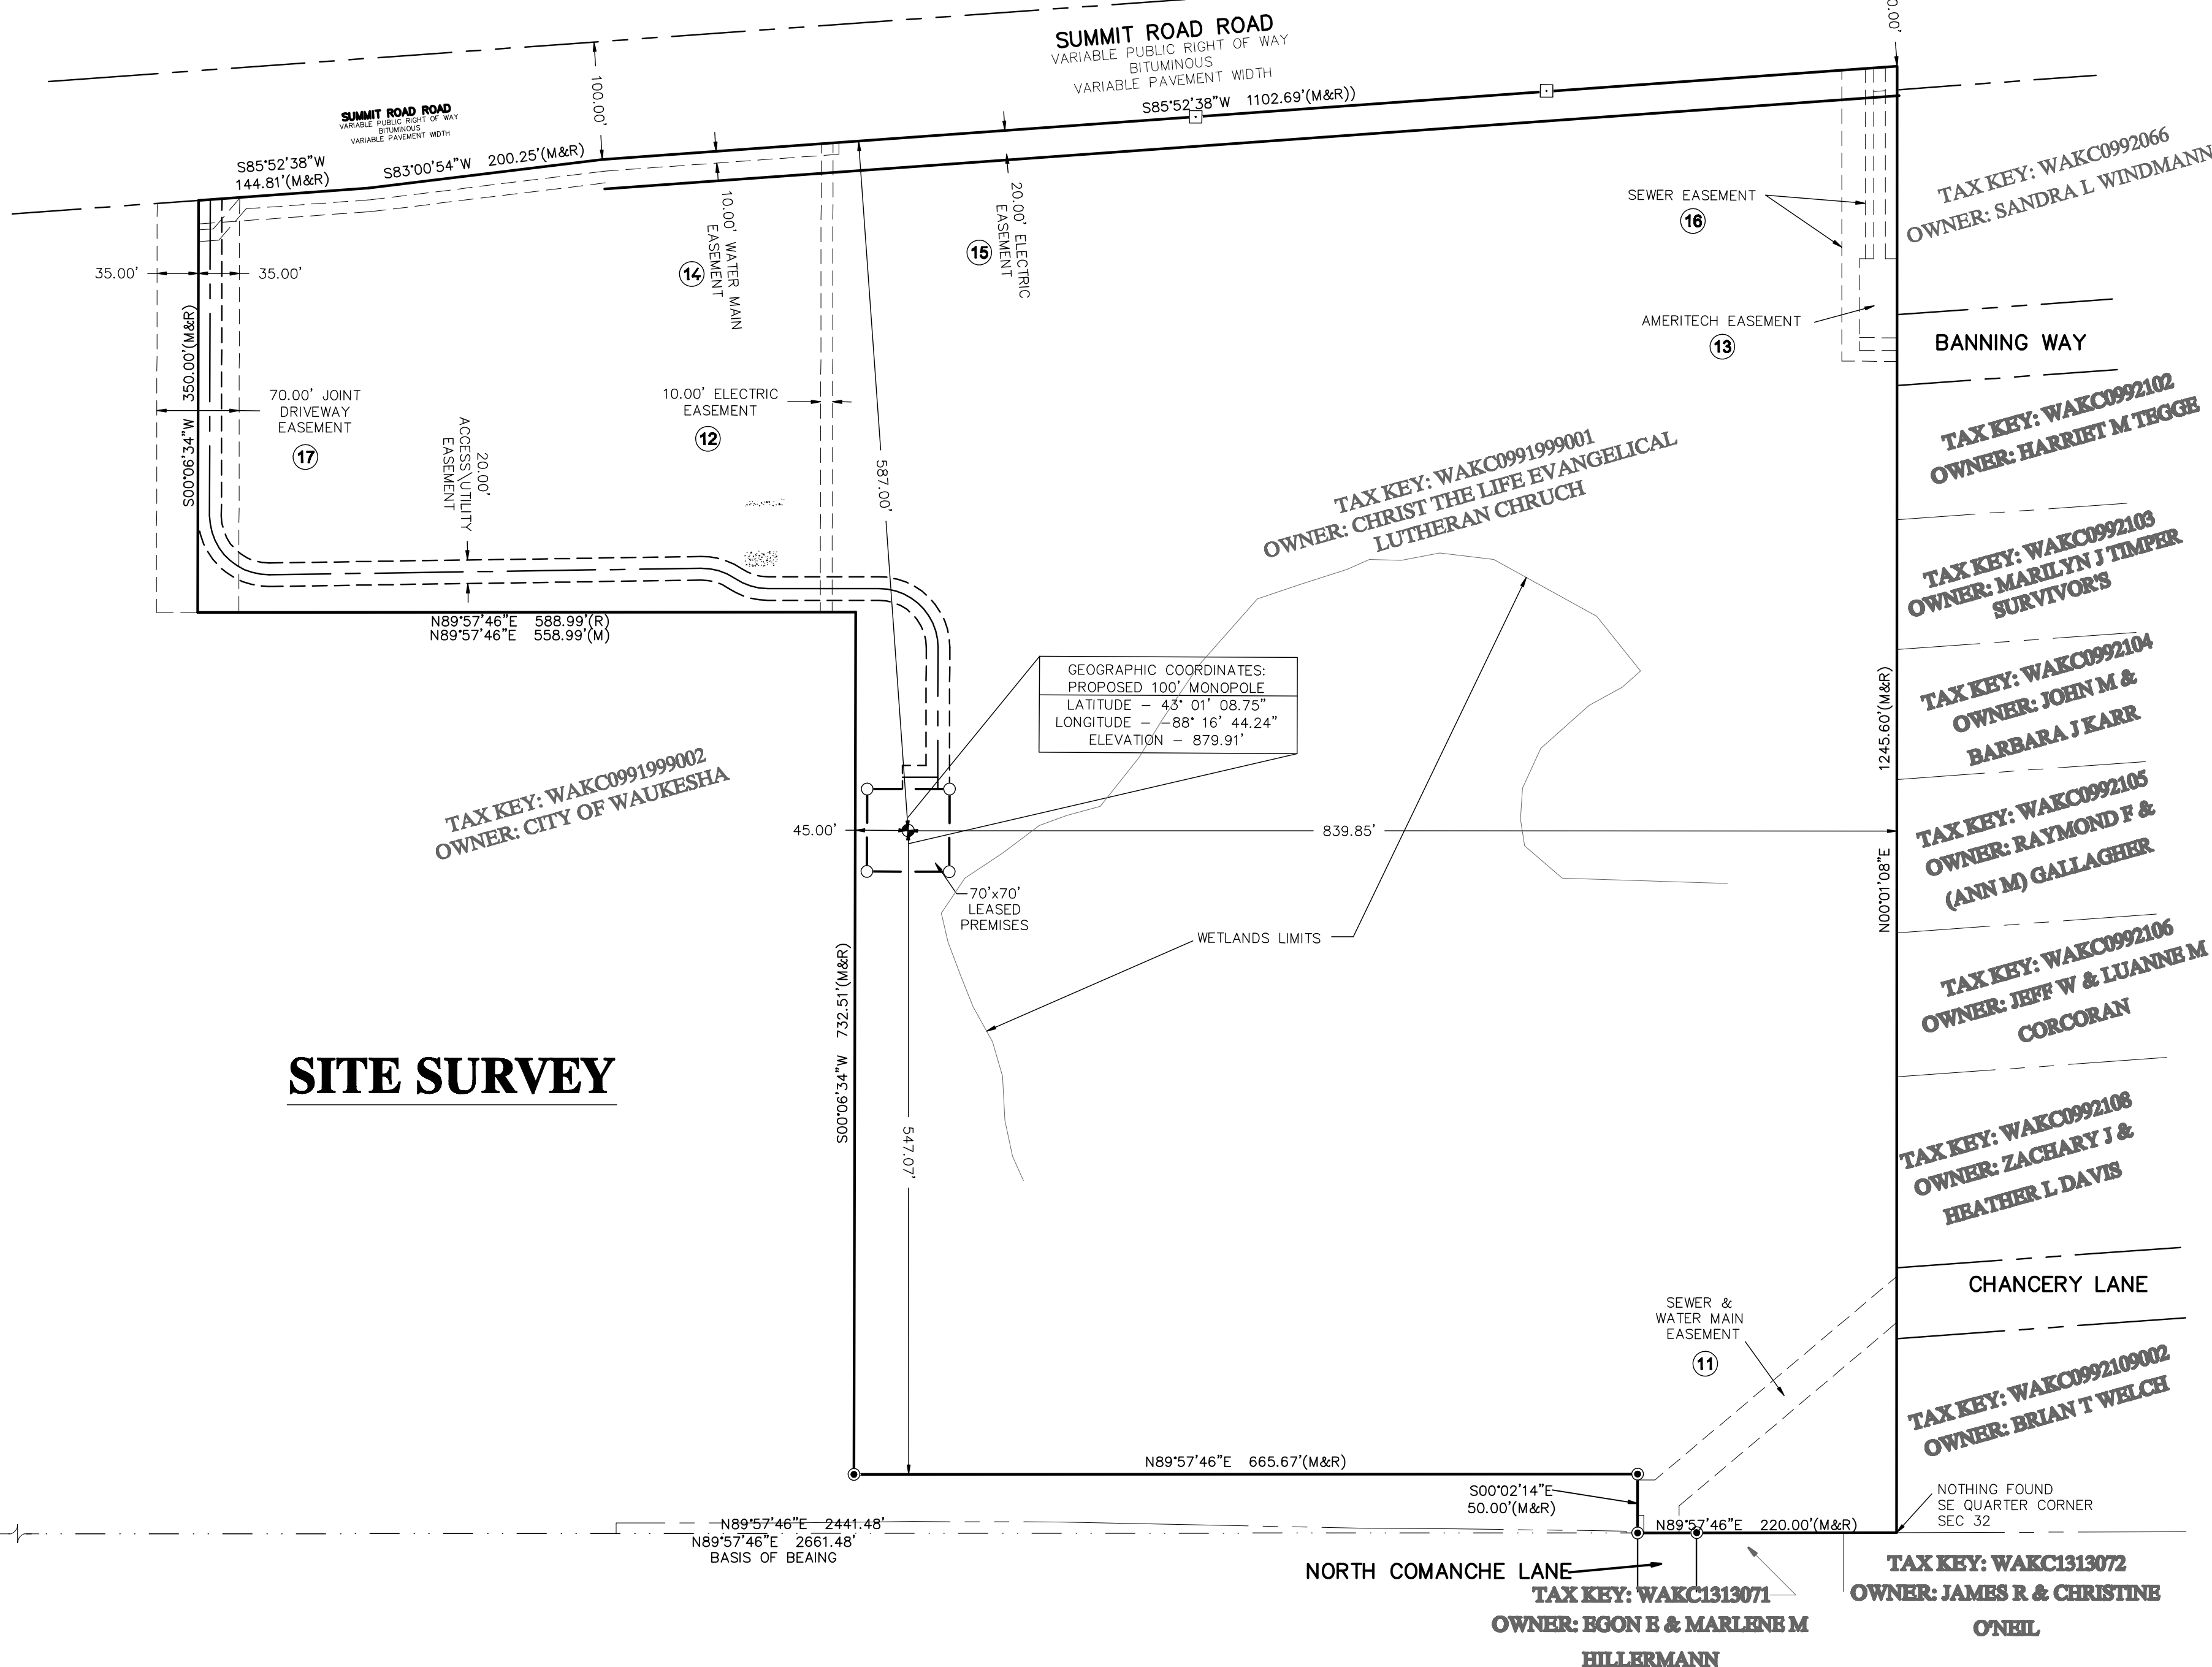


UTILITY CONTACT INFORMATION

POWER CONTACT: TBD
 TELEPHONE CONTACT: TBD

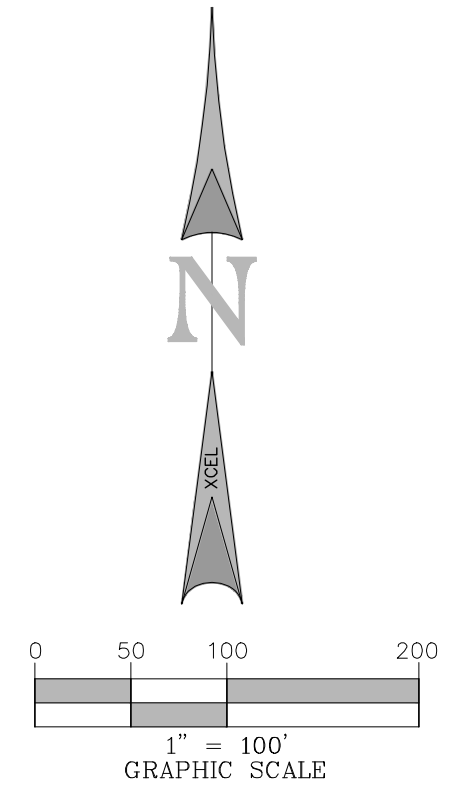

TO: PI TELECOM INFRASTRUCTURE I, LLC, A DELAWARE LIMITED LIABILITY COMPANY, AND CHICAGO TITLE INSURANCE COMPANY
 I, JAMES A. FAETANNI, AN ILLINOIS PROFESSIONAL LAND SURVEYOR, CERTIFY THAT THE INFORMATION SHOWN HEREON WAS COMPILED USING DATA FROM AN ACCURATE SURVEY MADE UNDER MY DIRECT SUPERVISION AND THAT THE FIELD SURVEY AND THE COMPLETION OF THIS MONUMENT SHOWN HEREIN WERE CONDUCTED IN ACCORDANCE WITH THE ILLINOIS MINIMUM STANDARDS OF PRACTICE AS SET FORTH UNDER SECTION 1270.560F OF THE ILLINOIS PROFESSIONAL LAND SURVEYORS ACT OF 1989 AS PUBLISHED BY THE ILLINOIS JOINT COMMITTEE ON ADMINISTRATIVE MATTERS.
 JAMES A. FAETANNI DATE: _____
 LICENSE NUMBER 035-003494
 MY LICENSE RENEWAL DATE IS NOVEMBER 30, 2016
 SHEETS COVERED BY THIS SEAL 2 OF 2

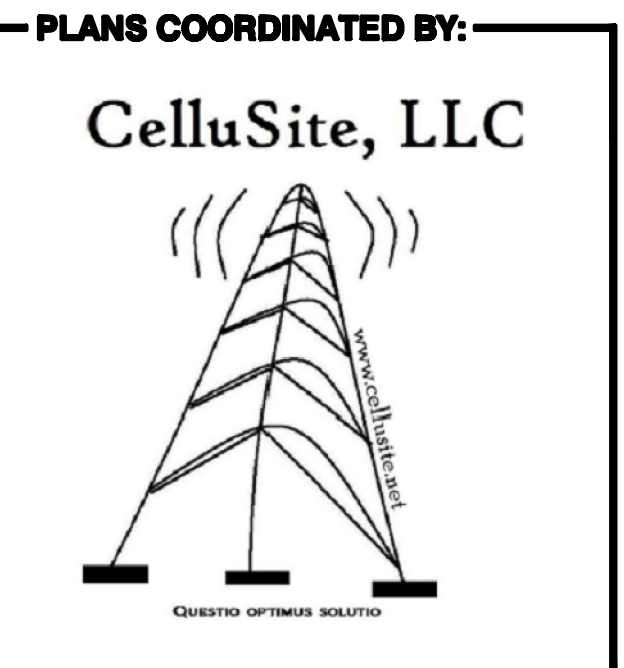

PLANS PREPARED BY:
 BRIAN HOLLAND
 (E) BHOLLAND@XCELCONSULTANTSINC.COM
 8300 42ND STREET WEST
 ROCK ISLAND, IL 61201
 (O) 309-787-9988
 (F) 309-756-5540
XCEL Consultants
 Civil Engineering & Professional Land Surveying
 JOB # 150566

DATE	DESCRIPTION	BY	REV

SITE INFORMATION:
CHRIST THE LIFE EVANGELICAL LUTHERAN CHURCH
 CHRIST THE LIFE EVANGELICAL LUTHERAN CHURCH
 3031 SUMMIT AVENUE,
 WAUKESHA, WI 53188
 WAUKESHA COUNTY

SURVEY PLAT

SHEET TITLE:
SURVEY PLAT
SHEET NUMBER:
1 OF 2
 SCALE: 1"=100'


CITY OF CHICAGO DEPARTMENT OF CONSTRUCTION AND PERMITS GENERAL BUILDING
REQUIREMENTS PER CHICAGO ZONING ORDINANCE (CZO) AND CHICAGO BUILDING CODE (CBC) 2014 EDITION

ITEM	ISSUE	CHAPTER/ARTICLE	ORDINANCE REQUIREMENT	ACTUAL	REQUIREMENT N/A	LOCATION/SHEET NO.	AGENCY/TEST NO.	REMARKS
PART 1- ZONING REQUIREMENTS								
1.01	ZONING DISTRICT	CHAPTER 17-1-800	N/A	M1-2	N/A	N/A	N/A	
1.02	LOT AREA	N/A	N/A	N/A	N/A	N/A	N/A	
1.03	MAXIMUM FLOOR AREA RATIO	N/A	N/A	N/A	N/A	N/A	N/A	
1.04	TOTAL BUILDING AREA	N/A	N/A	N/A	N/A	N/A	N/A	
1.05	BUILDING HEIGHT-NO. OF FLOORS	N/A	N/A	N/A	N/A	N/A	N/A	
1.06	MINIMUM YARDS	N/A	N/A	N/A	N/A	N/A	N/A	
1.07	GRADE ELEVATION (CCD)	N/A	N/A	TBD	N/A	N/A	N/A	
1.08	OFF STREET LOADING	CHAPTER 17-10-1101	N/A	N/A	N/A	N/A	N/A	
1.09	OFF STREET PARKING	CHAPTER 17-10-0207	N/A	N/A	N/A	N/A	N/A	
1.10	LANDSCAPING	CHAPTER 17-11-0050	N/A	N/A	N/A	N/A	N/A	
			N/A	N/A	N/A	N/A	N/A	
			N/A	N/A	N/A	N/A	N/A	
			N/A	N/A	N/A	N/A	N/A	
PART 2- BUILDING REQUIREMENTS								
2.01	OCCUPANCY CLASSIFICATION	3 (13-56) PAGE 115	N/A	N/A	N/A	N/A	N/A	
2.02	HEIGHT AND AREA LIMITATIONS	5 (13-48) PAGE 323	N/A	N/A	N/A	N/A	N/A	
	A) EXCEPTIONS TO AREA LIMITATIONS	5 (13-48-090) PAGE 325	N/A	N/A	N/A	N/A	N/A	
	B) MIXED OCCUPANCY BUILDINGS	5 (13-48-100) PAGE 326	N/A	N/A	N/A	N/A	N/A	
2.03	TYPES OF CONSTRUCTION	6 (13-60) PAGE 329	N/A	N/A	N/A	N/A	N/A	
2.04	MIXED OCCUPANCY SEPARATIONS	3 (13-56-280) PAGE 118	N/A	N/A	N/A	N/A	N/A	
2.05	REQ. HRS OF FIRE RESISTANCE	6 (13-60-100) PAGE 330	N/A	N/A	N/A	N/A	N/A	
	EXTERIOR BEARING WALLS	TABLE 6 (13-60-100)	N/A	N/A	N/A	N/A	N/A	
	EXTERIOR-NONBEARING WALLS	TABLE 6 (13-60-100)	N/A	N/A	N/A	N/A	N/A	
	INTERIOR BEARING WALLS	TABLE 6 (13-60-100)	N/A	N/A	N/A	N/A	N/A	
	INTERIOR NONBEARING WALLS	TABLE 6 (13-60-100)	N/A	N/A	N/A	N/A	N/A	
	COLUMNS	TABLE 6 (13-60-100)	N/A	N/A	N/A	N/A	N/A	
	COLUMNS SUPPORTING ROOFS ONLY	TABLE 6 (13-60-100)	N/A	N/A	N/A	N/A	N/A	
	BEAMS	TABLE 6 (13-60-100)	N/A	N/A	N/A	N/A	N/A	
	BEAMS SUPPORTING ROOFS ONLY	TABLE 6 (13-60-100)	N/A	N/A	N/A	N/A	N/A	
	FLOOR CONSTRUCTION	TABLE 6 (13-60-100)	N/A	N/A	N/A	N/A	N/A	
	ROOF CONSTRUCTION	TABLE 6 (13-60-100)	N/A	N/A	N/A	N/A	N/A	
2.06	ELEVATOR FRAMING	6 (13-60-130) PAGE 331	N/A	N/A	N/A	N/A	N/A	
2.07	MEZZANINE FLOORS	6 (13-60-160) PAGE 332	N/A	N/A	N/A	N/A	N/A	
2.08	BASEMENT CONSTRUCTION	6 (13-60-170) PAGE 332	N/A	N/A	N/A	N/A	N/A	
2.09	DRIVEWAYS AND LOADING SPACES	6 (13-60-210) PAGE 332	N/A	N/A	N/A	N/A	N/A	
2.10	FIRE-RESISTIVE REQUIREMENTS	7 (15-8) PAGE 335	N/A	N/A	N/A	N/A	N/A	
	A) FIRE WALLS-CONSTRUCTION	7 (15-8-010) PAGE 335	N/A	N/A	N/A	N/A	N/A	
	B) PARAPETS	7 (15-8-100) PAGE 335&336	N/A	N/A	N/A	N/A	N/A	
	C) STAIRWAY ENCLOSURES	7 (15-8-140) PAGE 337	N/A	N/A	N/A	N/A	N/A	
	D) ELEVATOR ENCLOSURES	7 (15-8-150) PAGE 337	N/A	N/A	N/A	N/A	N/A	
	E) ENCLOSURES OF HEATING ROOMS	7 (15-8-190) PAGE 338	N/A	N/A	N/A	N/A	N/A	
	F) ENCLOSURES OF WELLS & CHUTES	7 (15-8-170) PAGE 338	N/A	N/A	N/A	N/A	N/A	
	G) OTHER ENCLOSURES	7 (15-8-240) PAGE 339	N/A	N/A	N/A	N/A	N/A	
	H) INTERIOR WALL AND CLG. FINISHES	7 (15-8-380) PAGE 341	N/A	N/A	N/A	N/A	N/A	
	I) STORAGE ROOMS OVER 100SQ.FT	7 (15-8-240)(B) PAGE 339	N/A	N/A	N/A	N/A	N/A	
2.11	FIRE-RESISTIVE MATERIALS AND CONSTRUCTION	7 (15-12) PAGE 348	N/A	N/A	N/A	N/A	N/A	
2.12	ACCEPTED ENGINEERING PRACTICE RECOGNIZED AGENCIES	7 (15-12-050)	N/A	N/A	N/A	N/A	N/A	
2.13	FIRE PROTECTION EQUIPMENT	9 (15-16) PAGE 361	N/A	N/A	N/A	N/A	N/A	
	A) SPRINKLER SYSTEMS	9 (15-16-010) PAGE 362	N/A	N/A	N/A	N/A	N/A	
	B) SPECIAL REQUIREMENTS	9 (15-16-030) PAGE 362	N/A	N/A	N/A	N/A	N/A	
PART 3- EXIT REQUIREMENTS								
3.01	TYPES OF EXITS	10(13-160-040) PAGE 388	N/A	N/A	N/A	N/A	N/A	
3.02	MINIMUM NUMBER OF EXITS	10(13-160-050) PAGE 388	N/A	N/A	N/A	N/A	N/A	
3.03	TRAVEL DISTANCE TO EXITS	10(13-160-110) PAGE 389	N/A	N/A	N/A	N/A	N/A	
	A) INCREASES PERMITTED	10(13-160-150) PAGE 390	N/A	N/A	N/A	N/A	N/A	
	B) DEAD END CORRIDOR	10(13-160-160) PAGE 390	N/A	N/A	N/A	N/A	N/A	
3.04	CAPACITY OF EXITS	10(13-160-210) PAGE 390	N/A	N/A	N/A	N/A	N/A	
3.05	MINIMUM WIDTH OF EXITS	10(13-160-220) PAGE 391	N/A	N/A	N/A	N/A	N/A	
3.06	SWING OF EXIT DOORS	10(13-160-250) PAGE 391	N/A	N/A	N/A	N/A	N/A	
3.07	HARDWARE	10(13-160-260) PAGE 392	N/A	N/A	N/A	N/A	N/A	
3.08	REVOLVING DOORS	10(13-160-270) PAGE 393	N/A	N/A	N/A	N/A	N/A	
3.09	LANDINGS	10(13-160-310) PAGE 394	N/A	N/A	N/A	N/A	N/A	
3.10	HANDRAILS	10(13-160-320) PAGE 394	N/A	N/A	N/A	N/A	N/A	
3.11	CONSTRUCTION	10(13-160-330) PAGE 394	N/A	N/A	N/A	N/A	N/A	
3.12	ENCLOSURES	7 (15-8-140) PAGE 337	N/A	N/A	N/A	N/A	N/A	
3.13	HEAD ROOM	10(13-160-350) PAGE 394	N/A	N/A	N/A	N/A	N/A	



PLANS PREPARED BY:

CelluSite, LLC

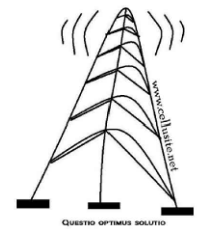

ENGINEERING LICENSE:

DATE	DESCRIPTION	BY	REV
06/03/15	REVIEW CD	BMW	A
06/04/15	REVIEW CD	BMW	B
07/21/15	REVIEW CD	BMW	C
08/20/15	REVIEW CD	BMW	D

SITE INFORMATION:

ML531081
Christ the Life
Evangelical
Lutheran Church
WI-Waukesha-
Summit
3031 Summit Ave
Waukesha, WI 53188
Waukesha COUNTY

SHEET TITLE:

CODE MATRIX
SCHEDULE

SHEET NUMBER:

T-2

PLOT SCALE: 1:1 @ 11"x17"

GROUNDING STANDARDS (CONT.):

3.4 SURGE ARRESTOR GROUND BAR: THE PURPOSE OF THE SURGE ARRESTOR GROUND BAR IS FOR LIGHTING PROTECTION. THE SURGE ARRESTOR GROUND BAR IS A BENT (3" X 3") X 1/4" X 24" COPPER BAR. IT IS LOCATED ON THE WAVEGUIDE BRIDGE SUPPORT CLOSEST TO THE EQUIPMENT. ONE FACE OF THE BAR SHALL HAVE A MINIMUM OF (28) 3/8" DIA. HOLES. HOLES SHALL BE IN PAIRS THAT ARE 1" CENTER TO CENTER. THE OTHER FACE SHALL HAVE 3/8" DIA. HOLES AS REQUIRED TO ATTACH AND GROUND COAXIAL SURGE ARRESTORS. THE GROUND BAR SHALL BE SUPPORTED BY MOUNTING BRACKETS WITH INSULATOR STANDOFFS.

3.5 GROUND ROD AND GROUND RING PLACEMENT: THE OUTSIDE GROUND RING SHALL BE PLACED AROUND THE BTS AT A DISTANCE OF TWO (2) FEET FROM THE BTS AT A DEPTH OF 2'-6" OR 6" BELOW THE FROST LINE, WHICHEVER IS DEEPER. RODS SHALL BE DRIVEN TO A DEPTH SUCH THAT THE TOP OF THE RODS IS AT THE LEVEL OF THE GROUND RING CONDUCTOR. THE RODS SHALL BE PLACED MINIMALLY ALONG THE RING AT THE FOLLOWING LOCATIONS:

- A. BELOW THE AREA OF THE INTERNAL MASTER GROUND BAR FOR CONNECTION TO THE MGB.
- B. BELOW THE UTILITY RACK FOR CONNECTION TO THE MAIN BUILDING COMMERCIAL POWER DISCONNECT.
- C. BELOW THE CORNERS OF THE BTS.
- D. AS REQUIRED TO ACHIEVE A RECOMMENDED SPACING OF TWENTY (20) FEET BETWEEN GROUND RODS ALONG THE RING PERIMETER.
- E. AS REQUIRED ALONG THE RING PERIMETER TO ACHIEVE 5 OHMS OR LESS RESISTANCE WHEN TESTED.
- F. TWO RODS LOCATED ON OPPOSITE SIDES AT EACH TOWER LEG OR MONOPOLE.
- G. ONE ROD LOCATED BENEATH EACH END OF THE WAVE GUIDE BRIDGE OR CABLE TRAY.
- H. ONE ROD LOCATED ADJACENT TO THE STANDBY GENERATOR, AND IF SEPARATED BY MORE THAN TEN (10) FEET, ONE LOCATED ADJACENT TO THE FUEL TANK.
- I. ONE ROD LOCATED AT THE BASE OF THE TOWER FOR THE TGB.

3.6 TOWER GROUNDING: ALL MONOPOLES SHALL HAVE TWO GROUND RODS (MINIMUM). ALL OTHER TOWERS SHALL HAVE TWO GROUND RODS PLACED AT THE BASE OF EACH TOWER LEG. EACH MONOPOLE OR TOWER LEG SHALL BE BONDED TO THE SYSTEM VIA TWO #2 BARE TINNED SOLID COPPER CONDUCTORS. BURNDY CONNECT THE CONDUCTORS TO ONLY STRUCTURAL BASE PLATES OR LUGS OR EARS AS MAY BE PROVIDED. NO BURNDY CONNECTIONS SHALL BE MADE TO THE VERTICAL WALLS OF THE STRUCTURE. NEVER GROUND TO HOLLOW LEG MEMBERS.

3.7 ANTENNA GROUNDING: EACH ANTENNA COAXIAL CABLE SHALL TYPICALLY BE GROUNDED AT THREE POINTS USING A HARD-SHELL COAXIAL CABLE KIT FROM THE MANUFACTURER OF THE ANTENNA CABLE. A TYPICAL INSTALLATION SHALL BE AS FOLLOWS:

- A. THE FIRST GROUND CONNECTION SHALL OCCUR AS CLOSE TO THE ANTENNA AS POSSIBLE, BELOW THE FIRST POINT THE COAX CABLE BEGINS TO RUN VERTICAL DOWN THE TOWER. THIS GROUND SHALL TERMINATE DIRECT TO THE TOP AGB. ON A T/I, GROUND TO THE AGB AT THE ANTENNA MOUNTS.
- B. THE SECOND GROUND SHALL BE MADE AT THE BOTTOM OF THE VERTICAL RUN OF THE COAXIAL CABLE AS IT TURNS OUT AWAY FROM THE TOWER TOWARDS THE BTS. THIS GROUND SHALL BE TERMINATED AT THE TGB. THE TGB SHALL HAVE TWO (2) LEADS OF #2 AWG BARE TINNED SOLID COPPER WIRE, AND SHALL TERMINATE AT THE TOWER GROUND RING. THESE SHALL BE ENCASED IN PVC PIPE.
- C. THE THIRD GROUND SHALL BE ON THE SURGE ARRESTOR. GROUND TO BE ATTACHED TO THE CABLE ON STRAIGHT RUNS (NOT WITHIN BENDS) AND BE WEATHERPROOFED PER THE MANUFACTURER'S SPECIFICATIONS. THE SURGE ARRESTORS SHALL BE GROUNDED TO THE GROUND BAR. THE SAGB SHALL HAVE TWO (2) LEADS OF #2 AWG BARE TINNED SOLID COPPER WIRE, AND SHALL TERMINATE AT THE TOWER GROUND RING. THESE SHALL BE ENCASED IN PVC PIPE.

3.8 PERIMETER FENCE GROUNDING:

- A. ALL FENCE CORNER AND END POSTS (MINIMUM OF TWO) SHALL HAVE ONE #2 SOLID TINNED COPPER GROUND WIRE CONNECTED TO A 5/8" X 10" SOLID COPPER CLAD GROUND ROD NEXT TO THE POST. THESE POSTS SHALL BE CONNECTED TO THE GROUND RING WITH A #2 SOLID TINNED COPPER GROUND WIRE AND INTERMEDIATE GROUND RODS IF THE DISTANCE FROM THE POST TO THE GROUND RING EXCEEDS 10 FEET. IN NO CASE SHALL ANY PORTION OF THE SAME FENCE REMAIN DISCONNECTED FROM THE GROUND RING.
- B. GATE POSTS SHALL BE GROUNDED TO EACH OTHER TO ENSURE THE ENTIRE FENCE HAS ELECTRICAL CONTINUITY. CONNECTIONS SHALL BE DRILL AND TAP WITH BURNDY TYPE KC22 TO THE POST WITH A #2 AWG BARE SOLID TINNED COPPER WIRE.
- C. GATES SHALL BE BONDED TO GATE POSTS WITH A 18" BRAIDED STRAP TYPE B018G92. THE CONNECTIONS SHALL BE BURNDY 2-HOLE LUGS (3/8" HOLES, 1" CENTER TO CENTER) BOLTED THROUGH EACH POST.
- D. ALL DOWN LEADS TO EARTH WILL BE ENCASED IN 3/4 INCH PVC NON-METALLIC AND SEALED WITH SILICONE.

3.9 GENERATOR FUEL TANK GROUNDING: THE GENERATOR FUEL TANK, IF REQUIRED, SHALL BE CONNECTED IN AT LEAST ONE PLACE TO THE MAIN EXTERIOR GROUND RING. #2 AWG BARE SOLID TINNED COPPER WIRE SHALL BE BURNDY CONNECTED TO ONE SUPPORT LEG OF THE FUEL TANK AND CAD WELD TO THE NEAREST EXTERIOR GROUND RING/GROUND ROD.

3.10 EQUIPMENT ROOM GROUNDING: THE MASTER GROUND BAR (MGB) SERVES AS THE COLLECTION POINT FOR THE BTS AS WELL AS ALL INTERIOR NON-ELECTRICAL GROUNDED METAL MATERIALS (HVAC GRILLS, DOOR FRAMES/DOORS, TELCO BOARD, UNISTRUTS, CABLE TRAYS, ALARM JUNCTION BOX, ETC.) SHALL BE GROUNDED WITH #6 AWG STRANDED (GREEN) GROUND WIRES WITH INDIVIDUAL RUNS BACK TO THE MGB. (THE CABLE TRAY, DOOR/FRAME AND UNISTRUT MAY BE JUMPERED TOGETHER AND HAVE A SINGLE GROUND WIRE CONNECTION TO THE MGB.)

3.11 WALL PENETRATIONS SLEEVES: INSTALL PER CONSTRUCTION DRAWINGS.

3.12 A/C COMMERCIAL POWER GROUNDING CONNECTIONS: AT THE ON-SITE RISER POLE LOCATION OR UNDERGROUND SERVICE ENTRANCE LOCATION, THE A/C SERVICE SHALL BE MECHANICALLY BONDED TO THE A/C SERVICE ENTRANCE GROUND AS SPECIFIED BY THE NATIONAL ELECTRIC CODE, ARTICLE 250, AND/OR APPROPRIATE LOCAL CODES. A SEPARATE GROUND ROD SHALL BE PROVIDED AT THIS POINT, AND SHALL BE CONNECTED TO THE EXTERIOR GROUND RING. A SEPARATE A/C SERVICE GROUND AND NEUTRAL SHALL THEN BE ROUTED TO AND CONNECTED TO THE MAIN DISCONNECT INSIDE THE BUILDING OR AS REQUIRED BY LOCAL AUTHORITY.

3.13 GENERATOR RECEPTACLE GROUNDING: THE GENERATOR RECEPTACLE (HUBBLE PLUG) SHALL BE GROUNDED TO THE EGR.

3.14 COAX BRIDGE / CABLE TRAY GROUNDING : BOND THE COAX BRIDGE OR CABLE TRAY TO THE AGB WITH #2 SOLID TINNED GROUND WIRE. THESE CONNECTIONS SHALL BE DOUBLE LUG BOLTED / SCREWED MECHANICAL CONNECTIONS WITH STAR LOCK WASHERS AND NOALOX. ALL BRIDGE SPLICES SHALL HAVE JUMPER OF #2 SOLID WITH COMPRESSION LUGS.

3.15 CAD WELD & BURNDY CONNECTION:

CAD WELDS (EXOTHERMIC WELDS) AND BURNDY CONNECTIONS SHALL BOND ALL UNDERGROUND AND DAMP LOCATION CONNECTIONS, SHELTER SKID GROUNDS, TOWER OR MONOPOLE GROUNDS, FENCING CORNER AND GATE POSTS, ANTENNA GROUND BARS, (AGB) SURGE ARRESTER GROUND BAR, AND THE MASTER GROUND BAR (MGB). MECHANICAL CONNECTIONS SHALL BE TYPICALLY USED TO BOND ALL INTERIOR EQUIPMENT, COAX CABLE BRIDGES AND COAXIAL CABLE GROUND KITS. ALL LUG TYPE MECHANICAL CONNECTORS TO THE MGB OR AGB SHALL BE TWO HOLE TYPE CONNECTED WITH STAINLESS STEEL BOLTS AND NUTS WITH STAINLESS STEEL LOCK WASHERS AND NOALOX ON EITHER SIDE OF THE BUSS BAR.

3.16 CHEMICAL GROUND RODS: CHEMICAL GROUND RODS SHALL NOT BE INSTALLED ON GROUND RING INSTALLATIONS WITH NORMAL SOIL. CHEMICAL GROUND RODS SHALL BE INSTALLED ONLY FOR SPECIAL DESIGN APPLICATIONS THAT REQUIRE SINGLE POINT GROUNDING DUE TO SPECIFIC SITE CONDITIONS.

3.17 TENANT IMPROVEMENT SITE GROUNDING: FOR ROOF TOP ANTENNA INSTALLATIONS ADDITIONAL ANTENNA GROUND BARS MAY HAVE TO BE INSTALLED AT EACH ANTENNA MOUNT LOCATION. ALL ANTENNA MOUNTS SHALL BE GROUNDED WITH A #2 AWG CONDUCTOR CONNECTED TO THE NEAREST BUILDING STEEL OR THE AGB INSTALLED AT THE MOUNT. ALL BUSS BARS, BOTH MGB AND AGB(S), SHALL BE INDEPENDENTLY TIED TO THE NEAREST BUILDING STEEL OR DESIGNATED GROUNDING SYSTEM. AGB(S) MAY BE HOME RUN BACK TO THE MGB WHERE NO BUILDING STEEL IS AVAILABLE.

3.18 LIMITS OF BEND RADIUS: IT IS IMPORTANT THAT THE GROUNDING CONDUCTOR CONNECTING THE INSIDE AND OUTSIDE GROUND SYSTEMS BE AS STRAIGHT AS POSSIBLE, WITH NO TURN OR BEND SHORTER THAN ONE FOOT RADIUS WITH A THREE FOOT RADIUS PREFERRED. NO RIGHT ANGLE OR SHARP BENDS SHALL BE ALLOWED.

3.19 BONDING PREPARATION & FINISH: ALL SURFACES REQUIRE PREPARATION PRIOR TO BONDING OF EITHER CAD WELD OR BURNDY FASTENERS. GALVANIZED SURFACES SHALL BE GROUND OR SANDED TO THE POINT OF EXPOSING THE STEEL SURFACE BELOW, PRIOR TO BONDING THE GROUND CONDUCTOR. FOR OTHER SURFACES INCLUDING COPPER BUSS BARS ALL PAINT, RUST TARNISH AND GREASE SHALL BE REMOVED PRIOR TO BONDING THE GROUND CONDUCTOR. CAD WELD TYPE BONDS SHALL BE FINISHED WITH THE APPLICATION OF COLD GALVANIZATION AND WHEN APPLICABLE, FINISH PAINTED WITH AN APPROPRIATE COLOR AS REQUIRED. MECHANICAL TYPE BONDS ON BUSS BARS SHALL BE FINISHED WITH THE APPLICATION OF NOALOX OR OTHER APPROVED CONDUCTIVE MEDIUM MATERIAL BETWEEN CONNECTOR AND BUSS BAR. MECHANICAL TYPE BONDS ON ALL OTHER SURFACES SHALL BE FINISHED WITH THE APPLICATION OF COLD GALVANIZATION AND/OR THE APPROPRIATE PAINT TO MATCH AS REQUIRED.

3.20 TESTING: THE OUTSIDE GROUND RING SHALL BE TESTED AFTER INSTALLATION BUT PRIOR TO BACKFILLING THE GROUND RING TRENCH. THE GROUND FIELD RESISTANCE SHALL MEASURE 5 OHMS OR LESS TO GROUND. ANY DIFFICULTY IN ACHIEVING THIS LEVEL OF RESISTANCE MUST BE BROUGHT TO THE ATTENTION OF THE PROJECT MANAGER. THE RESISTANCE TO GROUND SHALL BE MEASURED USING THE FALL OF POTENTIAL METHOD. TESTING SHALL BE PERFORMED BY AN OWNER PROVIDED INDEPENDENT TESTING LABORATORY FROM WHICH A WRITTEN REPORT SHALL BE PRODUCED FOR REVIEW BY THE PROJECT MANAGER.

3.21 SPECIAL CONDITIONS: WHEN SOIL CONDITIONS EXIST (I.E., NON-COMPACTABLE ROCK, GRAVEL, SHALE, ETC.) THAT PREVENTS THE INSTALLATION OF THE STANDARD GROUNDING SYSTEM AND PROCEDURES, THEN VERBAL PROCEDURES SHALL BE REQUESTED BY THE PM.

3.22 EXTERNAL GROUND RING: THE EXTERNAL GROUND RING SHALL EXTEND TO THE MAXIMUM ALLOWABLE DEPTH IN 95% COMPACTED SOIL.

3.23 GROUND RODS (REPLACEMENT): WHEN GROUND RODS CANNOT BE DRIVEN INTO THE SOIL VERTICALLY TO A DEPTH DESCRIBED IN PARAGRAPH 3.5, AND REMAIN IN 95% COMPACTED SOIL, THEN THE FOLLOWING METHODS OF SUBSTITUTION MAY BE USED. THESE ARE SUGGESTED METHODS ONLY, AND EACH CASE SHOULD BE REVIEWED BY THE T-MOBILE PROJECT MANAGER. THE PURPOSE IS TO ACHIEVE THE LOWEST IMPEDANCE TO GROUND, IN ANY CASE, EQUAL TO OR LESS THAN 5 OHMS.

3.24 ROCK WITH SOME OR NO SOIL COVER: FOR SITES WHICH HAVE SOIL CONDITIONS WHICH CONSIST OF SOLID OR SEMI SOLID ROCK BELOW ABOUT THREE FEET OF COMPATIBLE SOIL, A COMBINATION OF METHODS MAY BE USED:

- A. A COMBINATION OF SHORT GROUND RODS MAY BE USED WITH 3" BSQUARE 1/4" COPPER PLATES. A MINIMUM OF TWO PLATES SHOULD BE USED AND SHOULD REPLACE GROUND RODS ON AN EQUIVALENCY OF TWO GROUND ROD LENGTHS PER COPPER PLATE. THE COPPER PLATE SHOULD BE PLACED IN A MINIMUM 3" BENTONITE BASE AND COVERED WITH 3" OF BENTONITE FILL PRIOR TO BACKFILL.
- B. AN ACTIVE TYPE CHEMICAL ROD SYSTEM MAY BE USED. THIS IS AN ENGINEERING JUDGMENT AND SHOULD BE USED ONLY WHERE NECESSARY, DUE TO EXPENSE. IN ALL CASES, THE STANDARD PRACTICES OUTLINED IN THIS DOCUMENT SHOULD BE FOLLOWED TO THE EXTENT THAT IS APPLICABLE, AND SHOULD BE MODIFIED AS TO THE QUANTITY OF GROUND RODS AND CONDUCTOR SIZE ONLY AS RECOMMENDED BY THE MANUFACTURER OF THE GROUND ROD SYSTEM.
- C. A SYSTEM UTILIZING CORED SHAFTS, STANDARD GROUND RODS ON A TYPICAL LAYOUT, WITH A BENTONITE (CLAY) BACKFILL. IN THIS CASE EACH GROUND ROD SHOULD BE TESTED INDIVIDUALLY, AND EACH ROD SHOULD HAVE AN ACCESS BOX PLACED FOR FUTURE TESTING.


3.24 HIGH RISE BUILDING:

- A. HIGH RISE BUILDINGS PRESENT A UNIQUE PROBLEM IN GROUNDING. A FACILITY INVESTIGATION SHOULD BE MADE INTO THE STRUCTURE OF THE BUILDING, AND AS TO THE POSSIBLE PRESENCE OF AN EXISTING LIGHTNING PROTECTION SYSTEM. IF ONE IS IN PLACE AND APPEARS ADEQUATE IN DESIGN, IT MAY BE NECESSARY TO CONNECT THE ANTENNA SYSTEM TO THE EXISTING SYSTEM, WITH A TEST TO THE SYSTEM AFTER INSTALLATION TO ENSURE THAT IT HAS NOT CAUSED THE SYSTEM TO EXCEED 5 OHMS.
- B. STRUCTURAL STEEL BUILDINGS: IF THE BUILDING IS BUILT OF STRUCTURAL STEEL, IT MAY BE POSSIBLE TO GROUND THE ANTENNAS TO THE BUILDING SITE. IT IS PREFERABLE TO GROUND THE ANTENNAS AND THE SITE TO A DIRECT EARTH CONNECTION, BY USE OF SEPARATE DOWN LEADS OF CONSIDERABLE SIZE (250 MCM OR LARGER) COMING FROM GROUND BUSS BARS TO COLLECT THE GROUND INPUT, AND RUN DOWN A VERTICAL SHAFT OR STAIRWELL TO A PATTERN OF NO LESS THAN FOUR GROUND RODS. WHERE PRACTICAL, THE BUILDING STEEL SHOULD BE BONDED TO THE GROUND RING WITH A SEPARATE LEAD TO THE GROUND ROD FIELD.
- C. A SYSTEM STRUCTURAL CONCRETE BUILDINGS ARE MORE DIFFICULT TO GROUND PROPERLY. THE ANTENNAS SHOULD BE GROUNDED TO A SEPARATE BUSS BAR AND DOWN LEAD WHERE THE COAXIAL CABLES ENTER THE BUILDING. THE DOWN LEAD SHOULD BE RUN IN A SIMILAR FASHION AS IN THE STRUCTURAL STEEL EQUIPMENT ROOM. THE DOWN LEADS SHOULD BE PROTECTED IN CONDUIT AND SHOULD BE INSTALLED AS FAR APART AS IS PRACTICAL FROM EACH OTHER. THE SEPARATE DOWN LEADS SHOULD NOT CONTACT EACH OTHER UNTIL CONNECTION WITH THE FIRST GROUND ROD.



PLANS PREPARED BY:

CelluSite, LLC

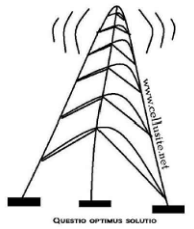

ENGINEERING LICENSE:

DATE:	DESCRIPTION:	BY:	REV:
06/03/15	REVIEW CD	BMW	A
06/04/15	REVIEW CD	BMW	B
07/21/15	REVIEW CD	BMW	C
08/20/15	REVIEW CD	BMW	D

SITE INFORMATION:

ML531081
Christ the Life
Evangelical
Lutheran Church
WI-Waukesha-
Summit
 3031 Summit Ave
 Waukesha, WI 53188
 Waukesha COUNTY

SHEET TITLE:

GENERAL
NOTES &
SPECIFICATIONS

SHEET NUMBER:

T-3

PLOT SCALE: 1:1 @ 11"x17"




Know what's below.
Call before you dig.

IMPORTANT SITE NOTES:

1. GENERAL CONTRACTOR WILL NOT START CONSTRUCTION UNTIL AFTER THEY HAVE RECEIVED THE PRE-CON PACKAGE AND HAVE A PRE-CON WALK WITH THE PROJECT MANAGER.
2. GENERAL CONTRACTOR TO HIRE PUBLIC (811) AND PRIVATE LOCATING SERVICE IN ORDER TO LOCATE AND PROTECT ALL SURFACE UTILITIES. DO NOT SCALE OFF THESE PLANS FOR ANY BELOW GRADE UTILITIES
3. CONTRACTOR SHALL VERIFY ALL EXISTING BURIED AND OVERHEAD UTILITIES PRIOR TO EXCAVATION. CONTRACTOR SHALL REPAIR ALL DAMAGED UTILITIES AT HIS OWN COST AND COORDINATE ANY REPAIRS WITH RESPECTIVE UTILITY COMPANY.
4. CONTRACTOR TO VERIFY ALL HEIGHTS AND AZIMUTHS IN FIELD PRIOR TO CONSTRUCTION. CONTRACTOR SHALL NOTIFY T-MOBILE AND ENGINEERING FIRM OF ANY DISCREPANCIES BEFORE PROCEEDING.
5. CONTRACTOR SHALL RESTORE AND REPAIR ANY DAMAGED AREAS CAUSED BY CONSTRUCTION

PLANS PREPARED BY:

CelluSite, LLC

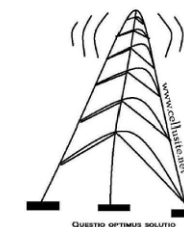

ENGINEERING LICENSE:

DATE	DESCRIPTION	BY	REV
06/03/15	REVIEW CD	BMW	A
06/04/15	REVIEW CD	BMW	B
07/21/15	REVIEW CD	BMW	C
08/20/15	REVIEW CD	BMW	D

SITE INFORMATION:

ML531081
Christ the Life
Evangelical
Lutheran Church
WI-Waukesha-
Summit
3031 Summit Ave
Waukesha, WI 53188
Waukesha COUNTY


SHEET TITLE:

OVERALL
SITE PLAN

SHEET NUMBER:


C-1

PLOT SCALE: 1:1 @ 11"x17"

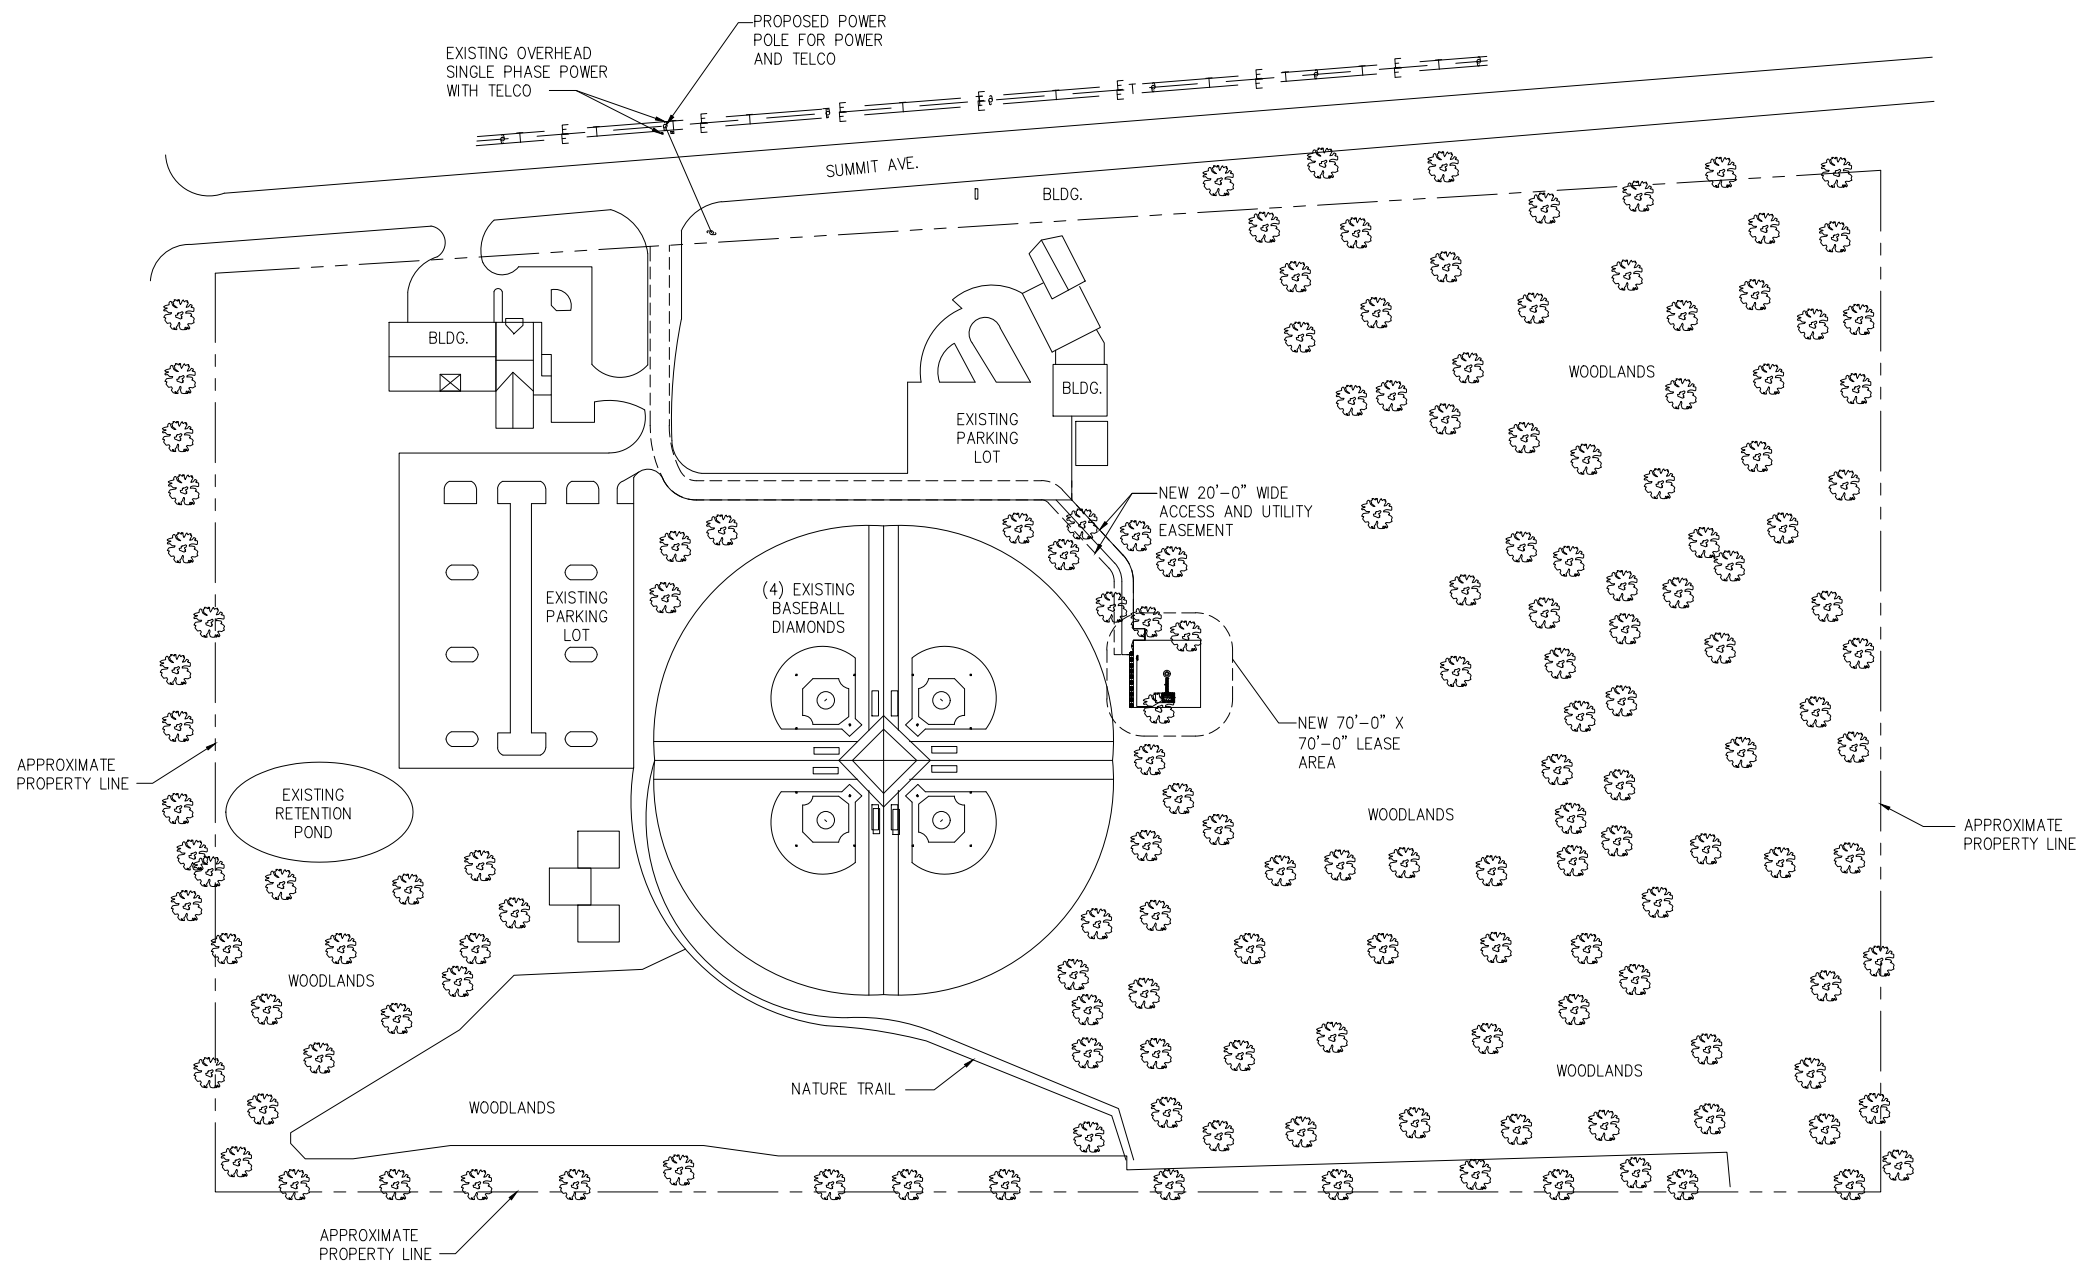

OVERALL SITE PLAN

SCALE: 1"=80'-0"

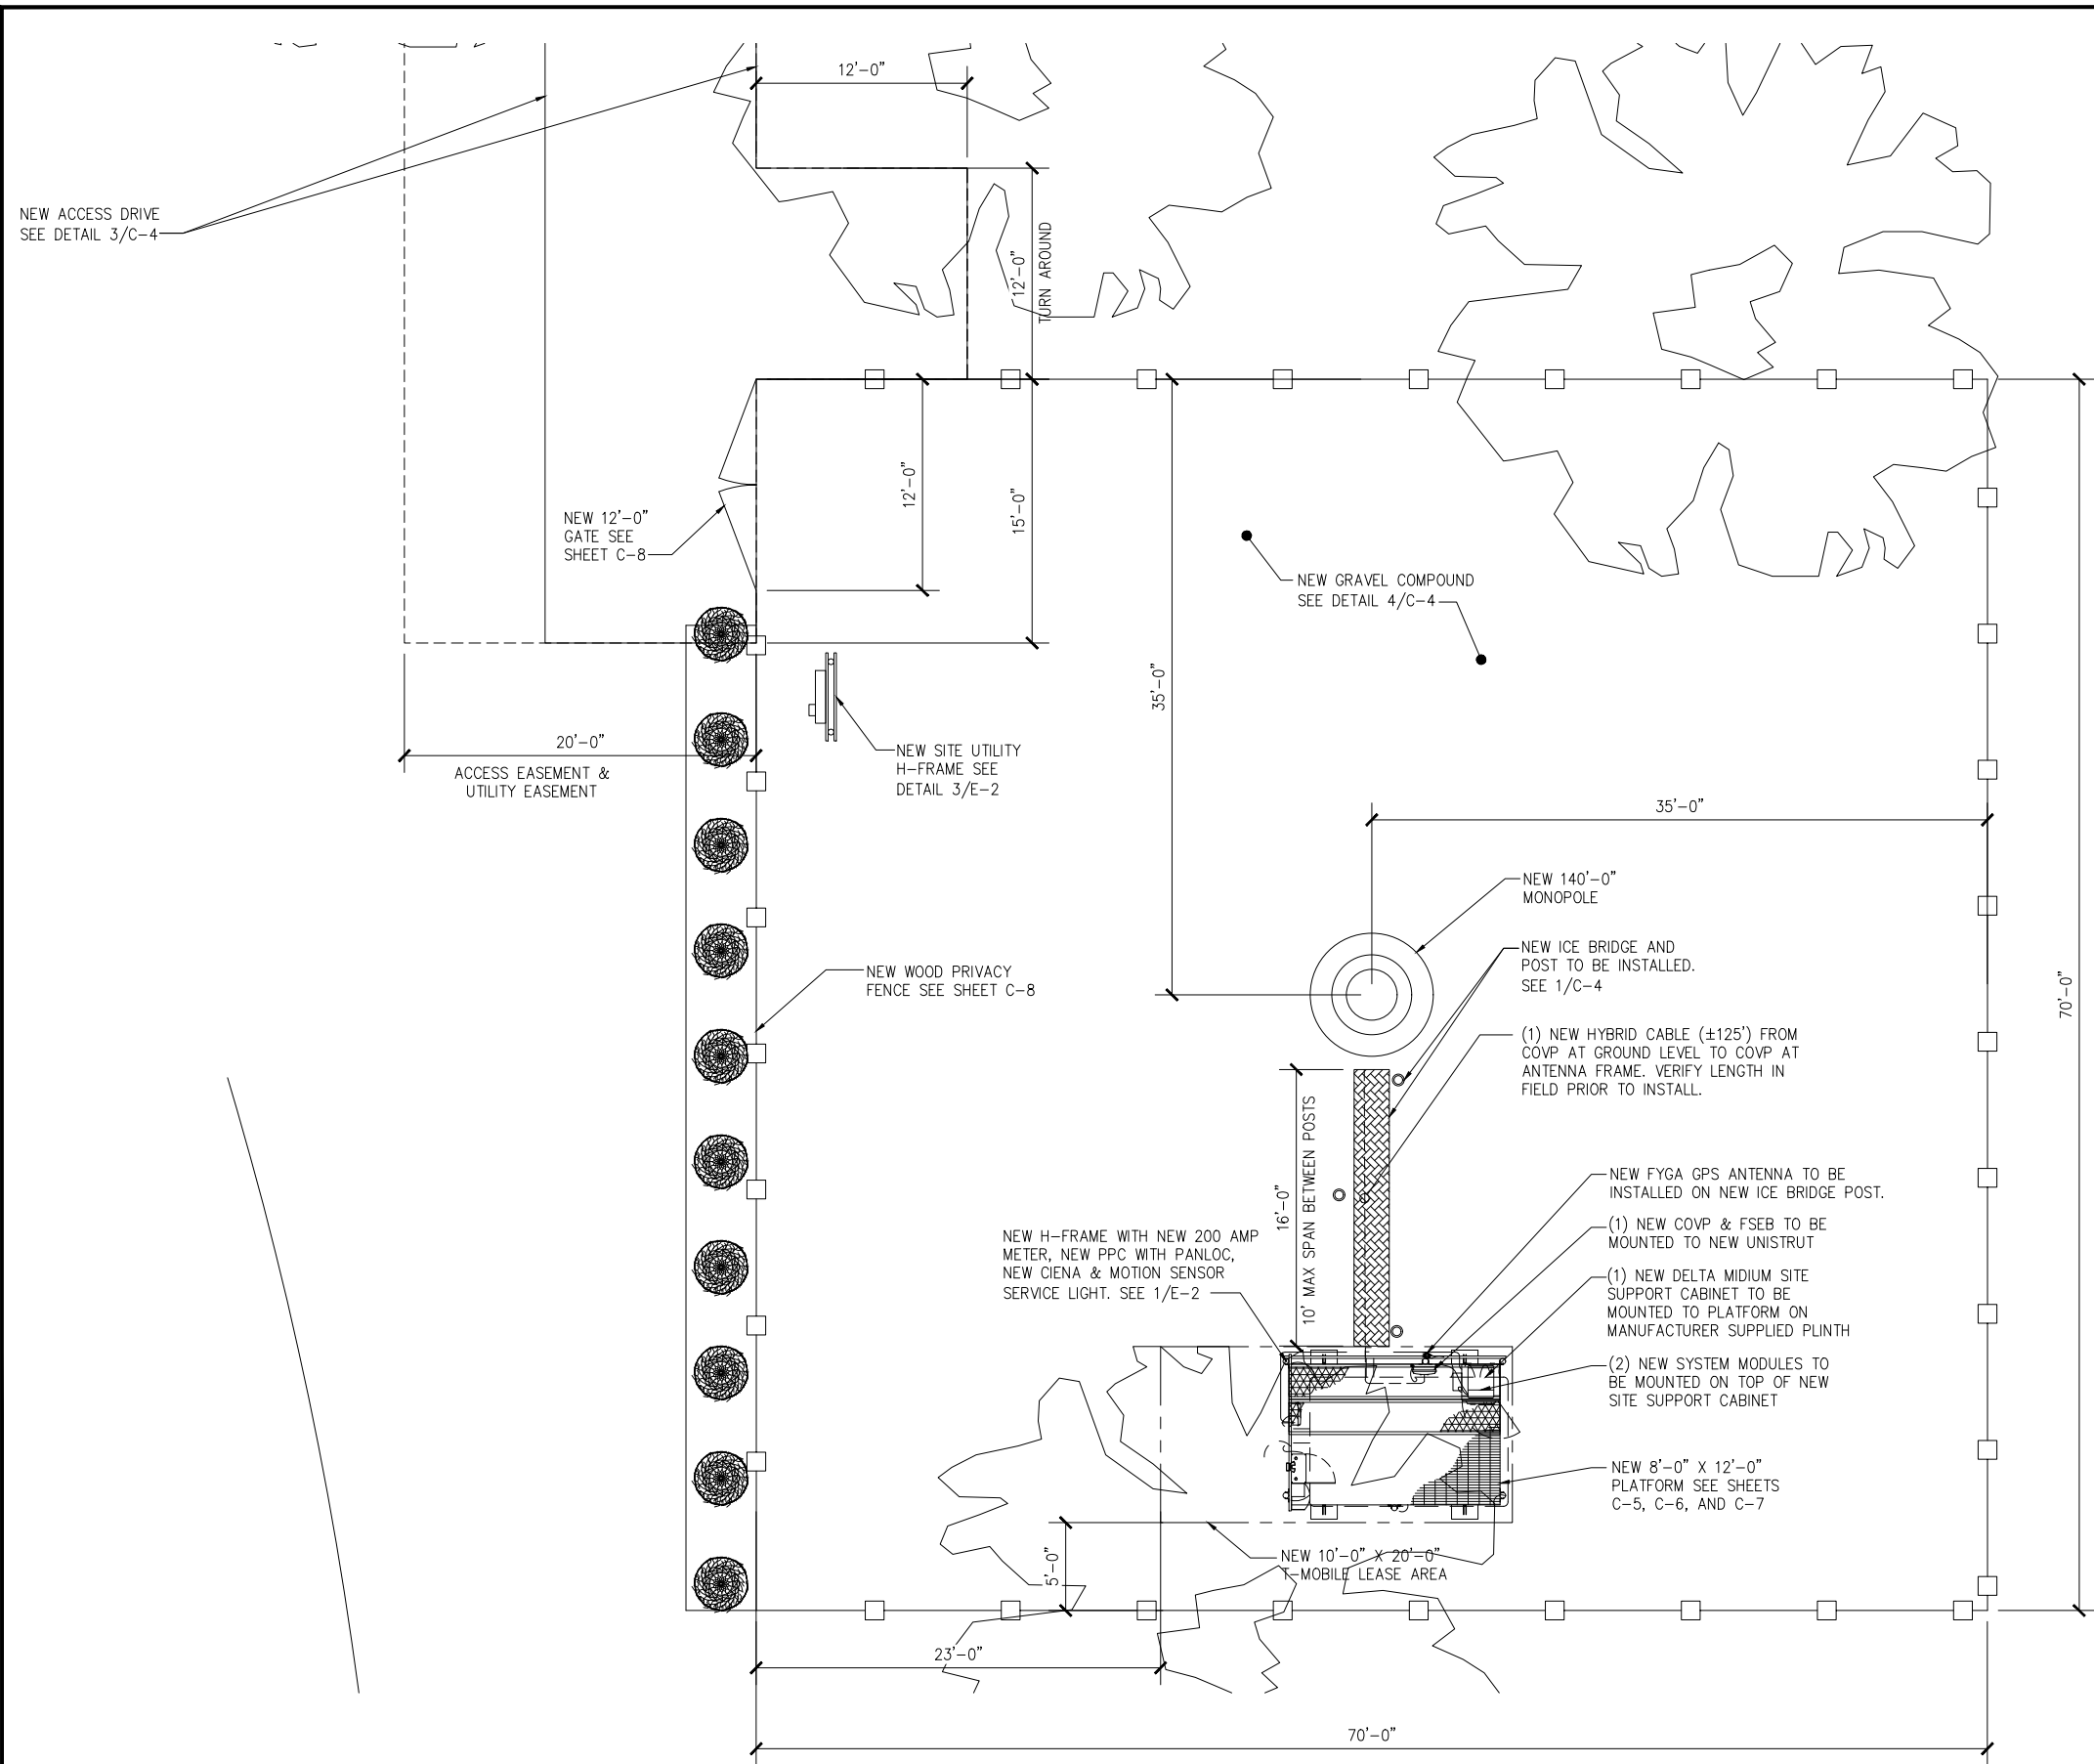

NOTE:
 ALL UNISTRUT, FASTENERS, HARDWARE, ETC. ARE TO BE EITHER HOT-DIPPED GALVANIZED OR STAINLESS STEEL. GENERAL CONTRACTOR IS NOT TO USE ZINC-PLATED OR PRE-GALVANIZED.
 ALL TREES TO BE REMOVED AS NECESSARY.



PLANS PREPARED BY:
CelluSite, LLC

ENGINEERING LICENSE:

DATE	DESCRIPTION	BY	REV
06/03/15	REVIEW CD	BMW	A
06/04/15	REVIEW CD	BMW	B
07/21/15	REVIEW CD	BMW	C
08/20/15	REVIEW CD	BMW	D

SITE INFORMATION:
ML531081
Christ the Life
Evangelical
Lutheran Church
WI-Waukesha-
Summit
 3031 Summit Ave
 Waukesha, WI 53188
 Waukesha COUNTY


SHEET TITLE:
 ENLARGED
 SITE PLAN

SHEET NUMBER:
 C-2

PLOT SCALE: 1:1 @ 11"x17"

ENLARGED SITE PLAN
 SCALE: 3/16" = 1'-0"
 1




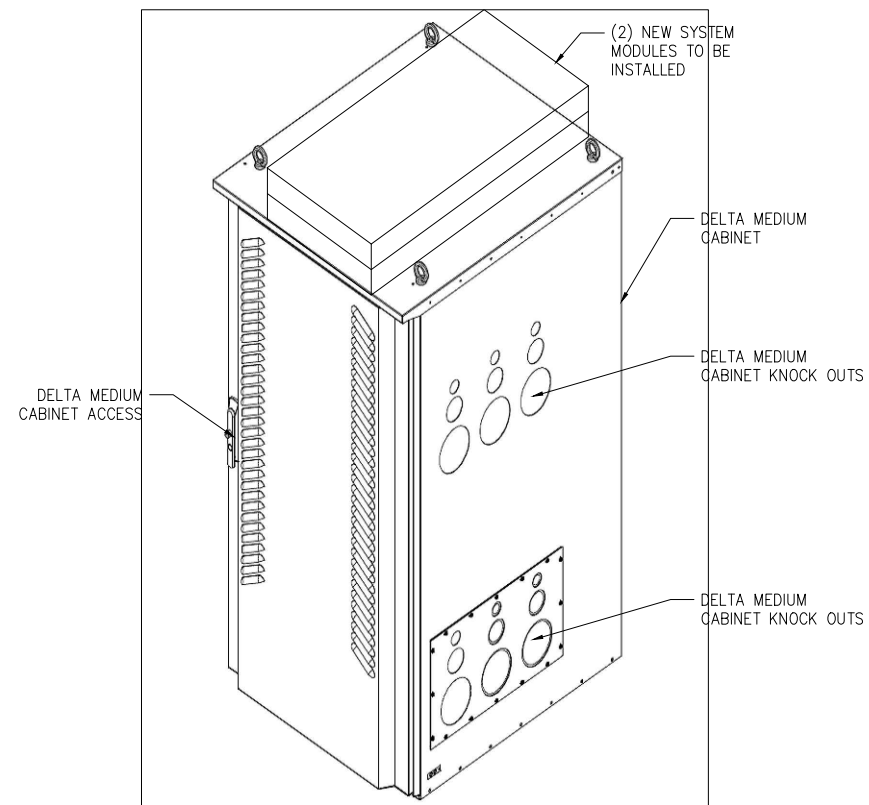

ISOMETRIC EQUIPMENT VIEW

SCALE: NOT TO SCALE


1

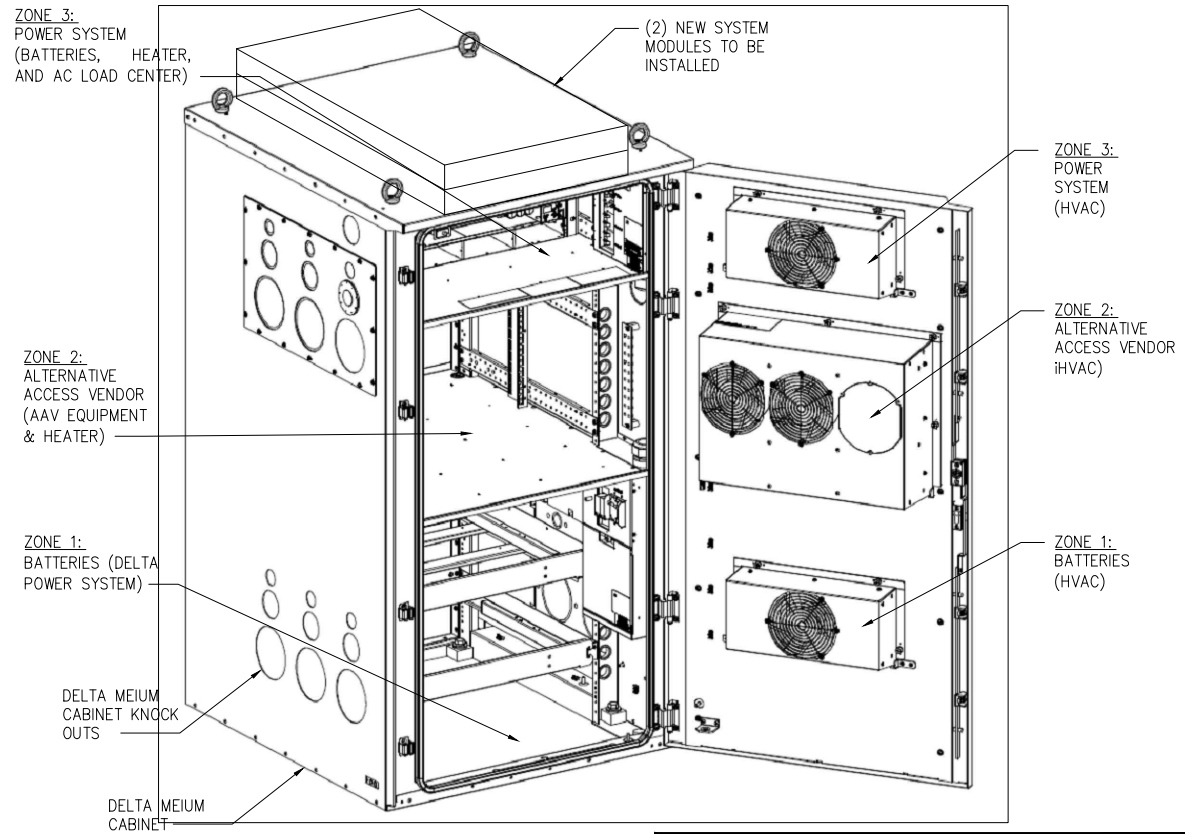

ISOMETRIC EQUIPMENT VIEW

SCALE: NOT TO SCALE


2

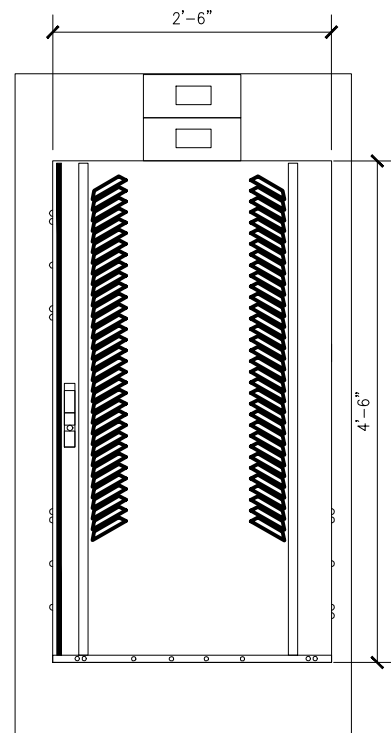

FRONT EQUIPMENT VIEW

SCALE: NOT TO SCALE


3

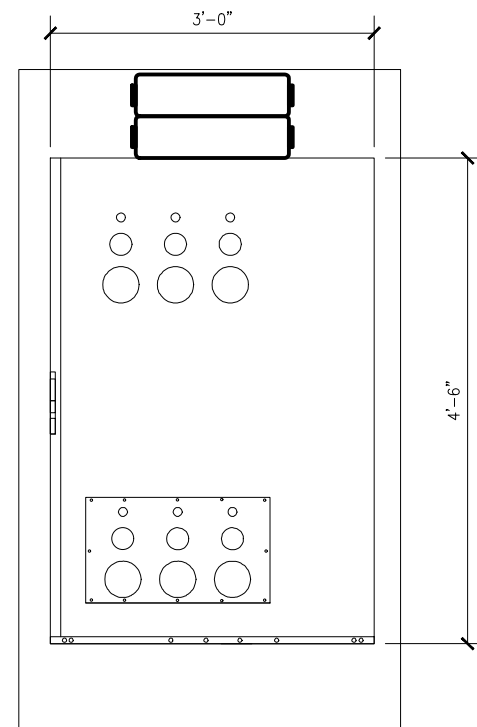

RIGHT EQUIPMENT VIEW

SCALE: NOT TO SCALE


4

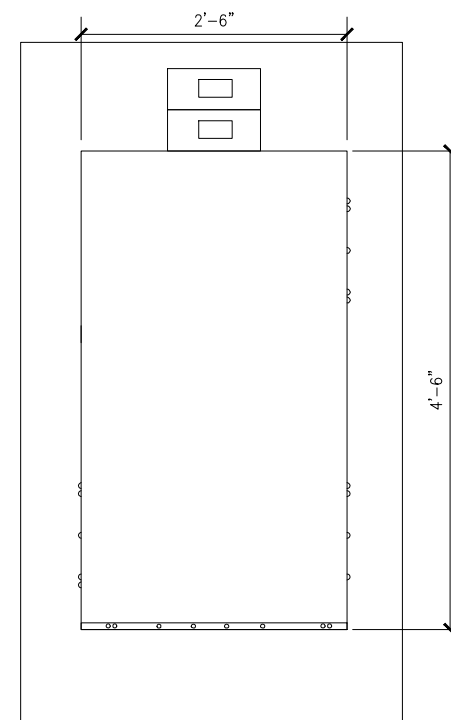

BACK EQUIPMENT VIEW

SCALE: NOT TO SCALE

5

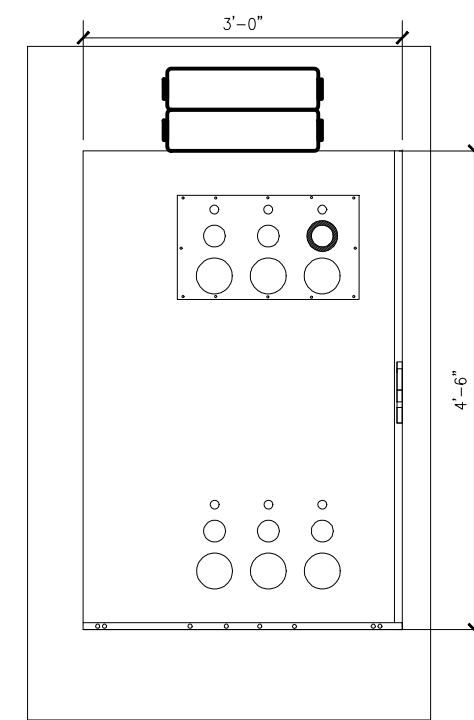


LEFT EQUIPMENT VIEW

SCALE: NOT TO SCALE

6

PLANS PREPARED BY:

CelluSite, LLC

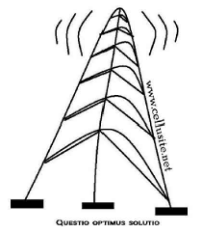

ENGINEERING LICENSE:

DATE	DESCRIPTION	BY	REV
06/03/15	REVIEW CD	BMW	A
06/04/15	REVIEW CD	BMW	B
07/21/15	REVIEW CD	BMW	C
08/20/15	REVIEW CD	BMW	D

SITE INFORMATION:

ML531081
Christ the Life
Evangelical
Lutheran Church
WI-Waukesha-
Summit
3031 Summit Ave
Waukesha, WI 53188
Waukesha COUNTY

SHEET TITLE:

EQUIPMENT
ELEVATION

SHEET NUMBER:

C-3

PLANS PREPARED BY:

CelluSite, LLC




ENGINEERING LICENSE:

DATE	DESCRIPTION	BY	REV
06/03/15	REVIEW CD	BMW	A
06/04/15	REVIEW CD	BMW	B
07/21/15	REVIEW CD	BMW	C
08/20/15	REVIEW CD	BMW	D


SITE INFORMATION:
ML531081
Christ the Life
Evangelical
Lutheran Church
WI-Waukesha-
Summit
3031 Summit Ave
Waukesha, WI 53188
Waukesha COUNTY

SHEET TITLE:
**ICE BRIDGE,
GPS AND
HYBRID CABLE
DETAILS**


SHEET NUMBER:
C-4

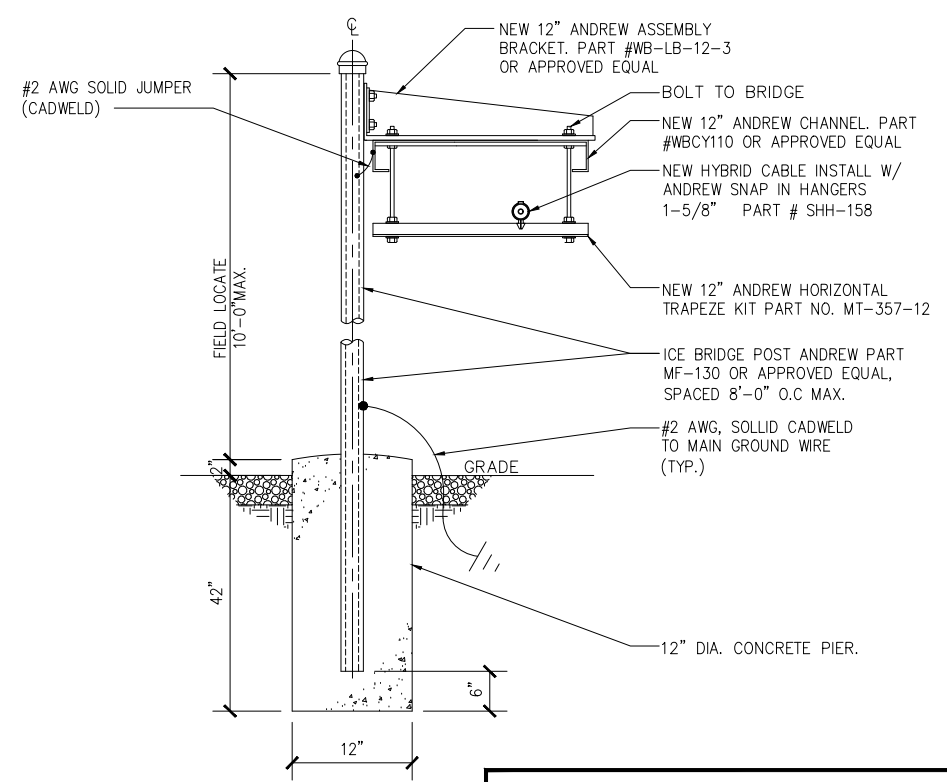


ICE BRIDGE DETAIL
SCALE: NONE 1

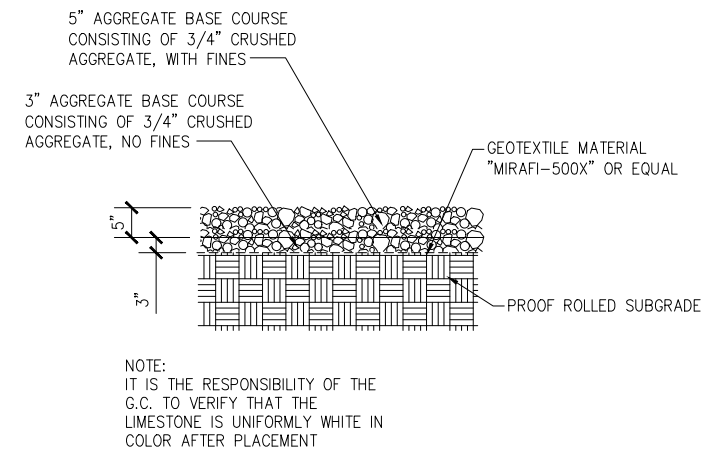


SITE SURFACING DETAIL
SCALE: NONE 4

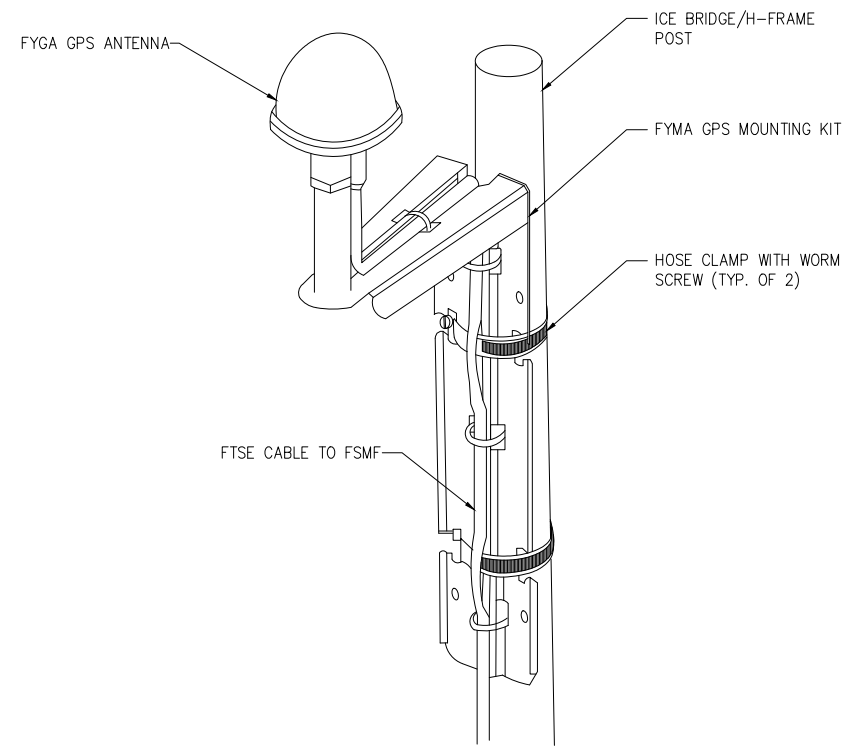

FYGA GPS ANTENNA DETAIL
SCALE: NONE 2

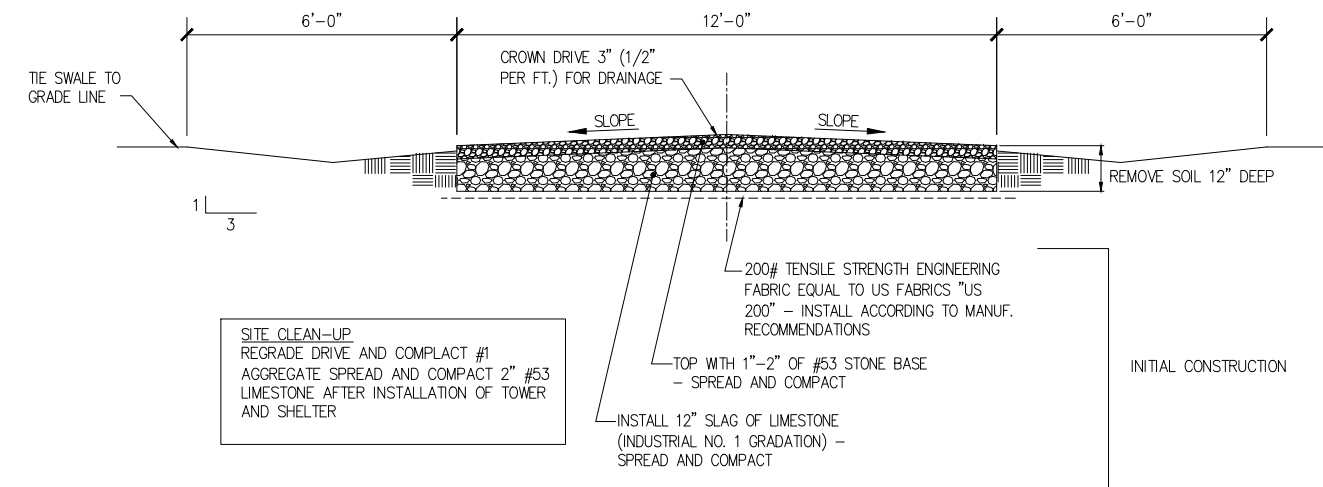


ACCESS DRIVE DETAIL
SCALE: NONE 3

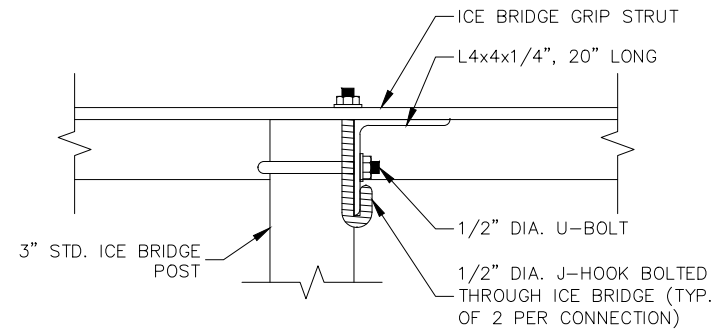

CONNECTION DETAIL

SCALE: 1 1/2" = 1'-0"

2

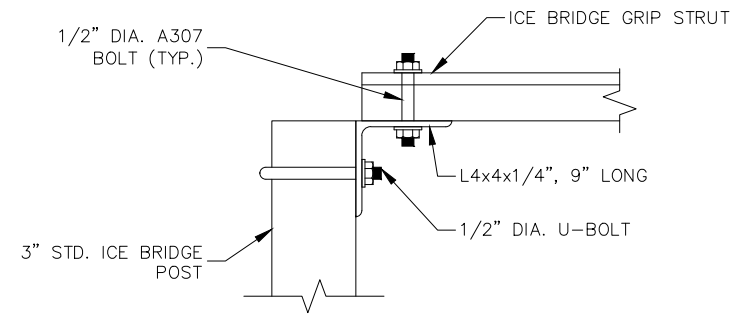

CONNECTION DETAIL

SCALE: 1 1/2" = 1'-0"


3

NOTES:

1. EXISTING CONDITIONS SHALL BE CHECKED AND VERIFIED IN FIELD BY THE CONTRACTOR PRIOR TO FABRICATION AND INSTALLATION. IF SIGNIFICANT DEVIATIONS OR DETERIORATION ARE ENCOUNTERED AT THE TIME OF CONSTRUCTION, A REPAIR PERMIT SHALL BE OBTAINED AND CONTRACTOR SHALL NOTIFY STRUCTURAL ENGINEER IMMEDIATELY.
2. FOUNDATIONS ARE DESIGNED FOR AN ASSUMED MINIMUM NET ALLOWABLE SOIL BEARING CAPACITY OF 2000 PSF. IT IS RECOMMENDED THAT A GEOTECHNICAL INVESTIGATION BE COMPLETED PRIOR TO CONSTRUCTION. IF SOIL BEARING CAPACITY IS LESS THAN WHAT IS SPECIFIED HERE, CONTACT ARCHITECT/ENGINEER FOR A REDESIGN.
3. DO NOT SCALE DRAWINGS.

PLANS PREPARED BY:

CelluSite, LLC

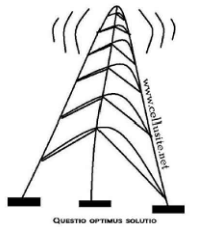

ENGINEERING LICENSE:

DATE	DESCRIPTION	BY	REV
06/03/15	REVIEW CD	BMW	A
06/04/15	REVIEW CD	BMW	B
07/21/15	REVIEW CD	BMW	C
08/20/15	REVIEW CD	BMW	D

SITE INFORMATION:

ML53108I
Christ the Life
Evangelical
Lutheran Church
WI-Waukesha-
Summit
3031 Summit Ave
Waukesha, WI 53188
Waukesha COUNTY



SHEET TITLE:

PLATFORM
ELEVATIONS

SHEET NUMBER:

C-5

PLOT SCALE: 1:1 @ 11"x17"

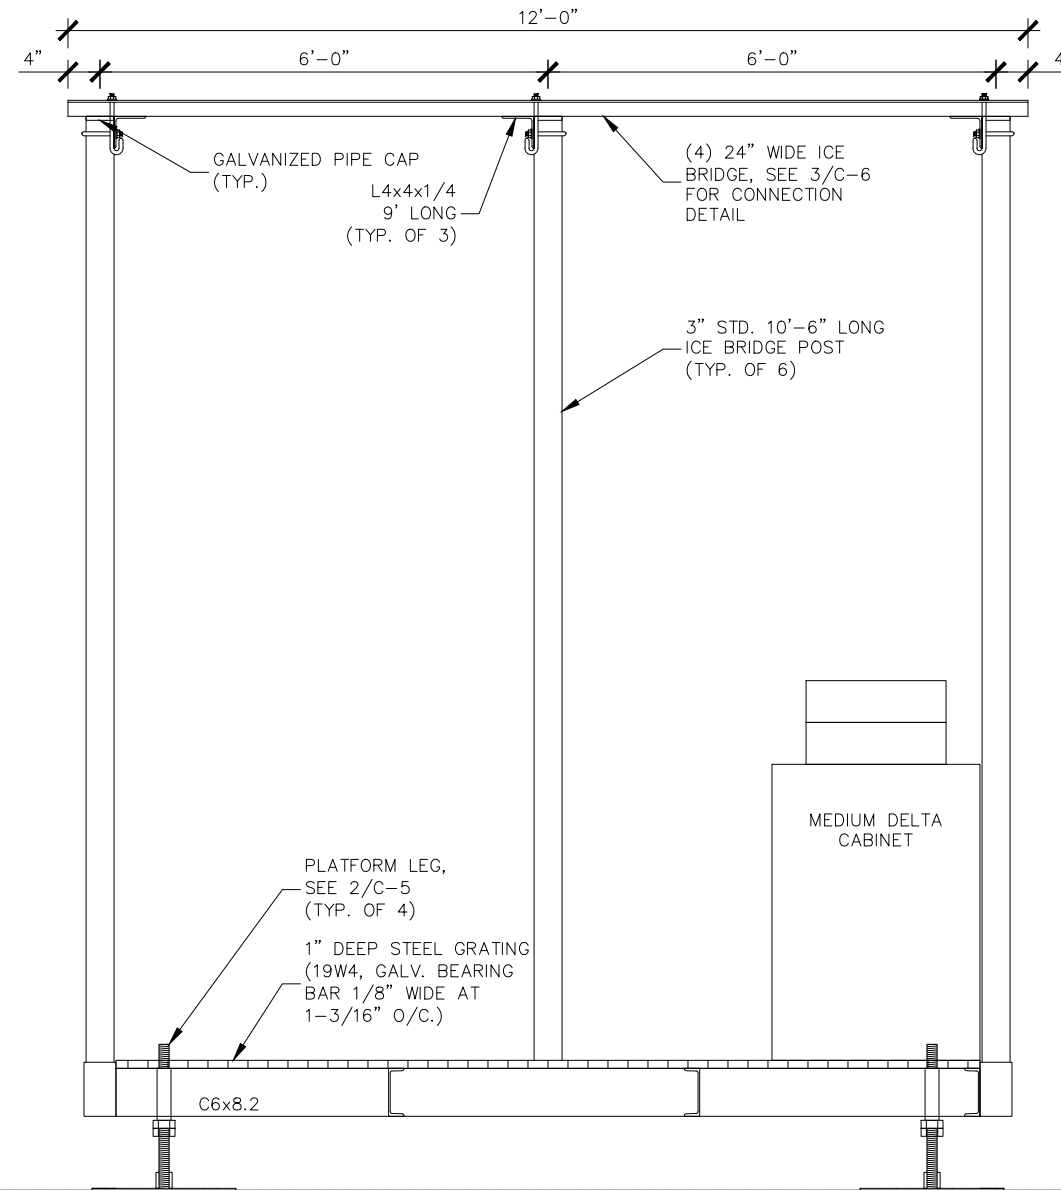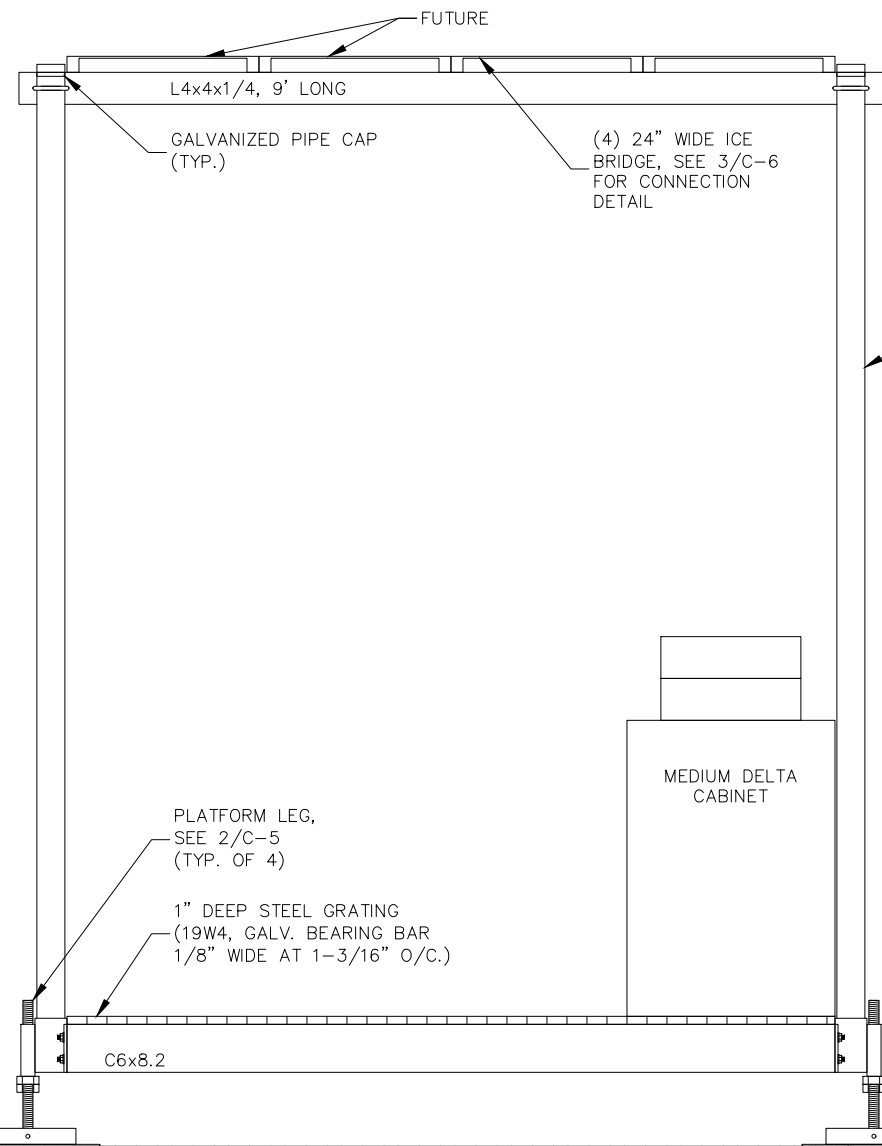


GRADE
739'-0" AMSL


12'-0" x 8'-0" PLATFORM ELEVATIONS

SCALE: 1/2" = 1'-0"


1

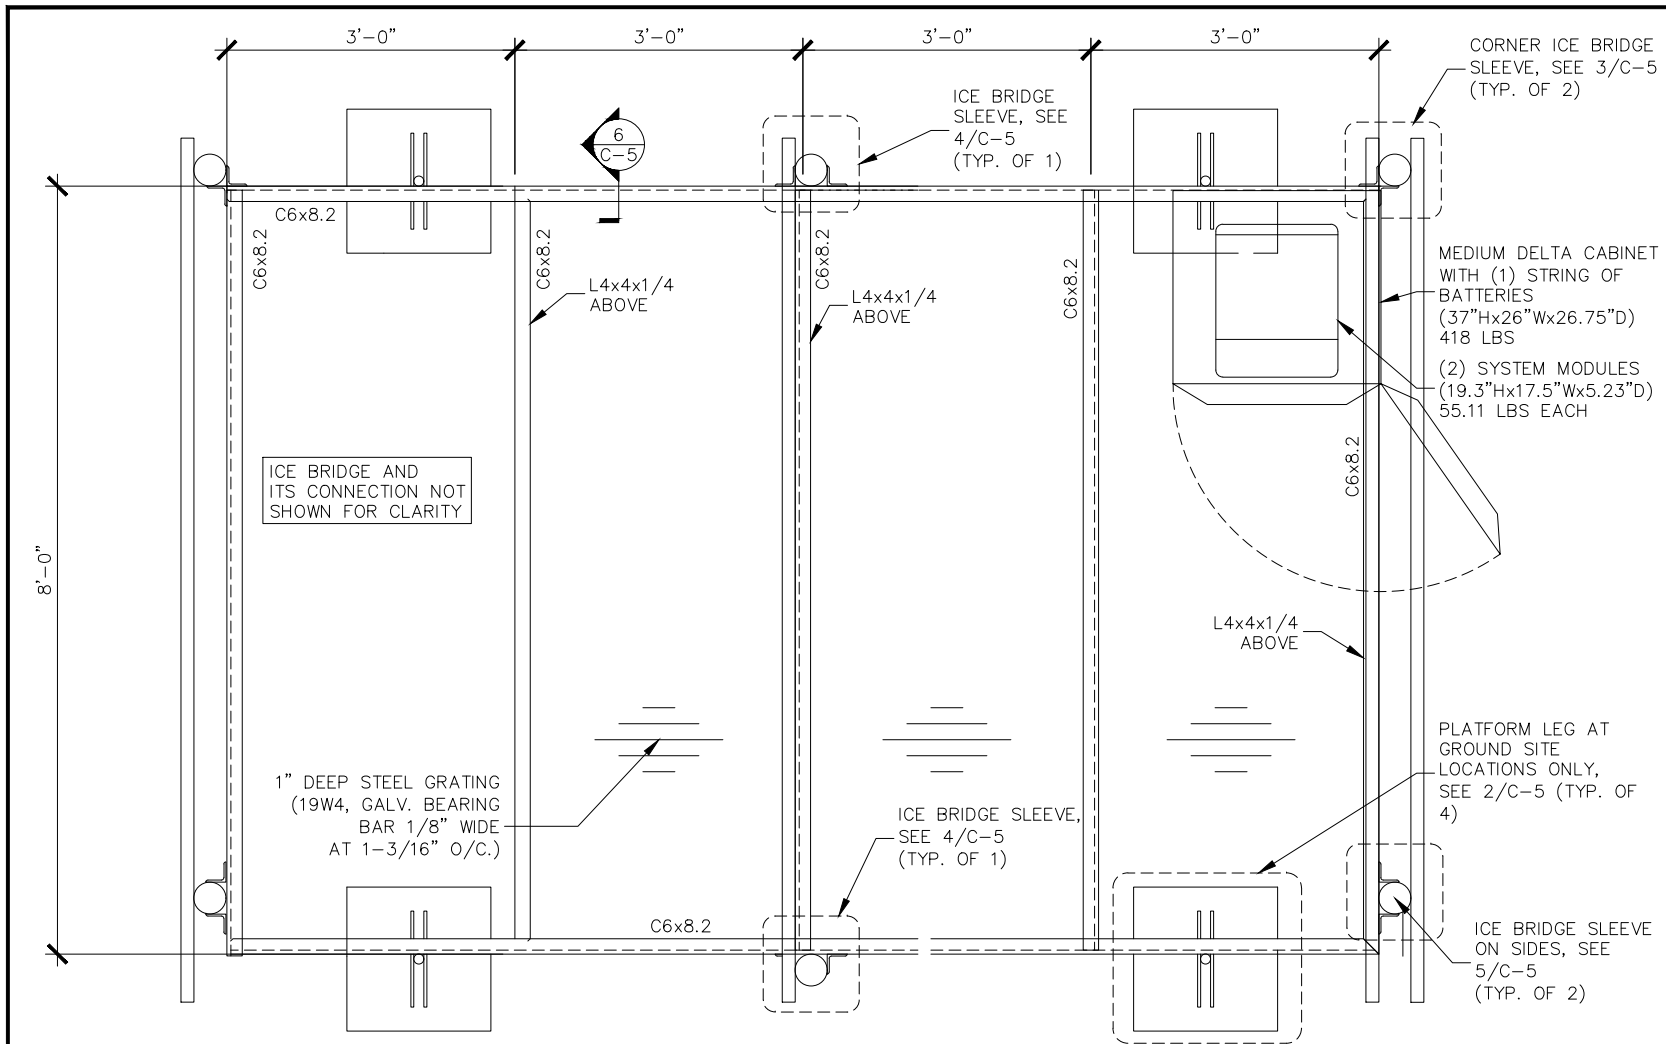


12'-0" x 8'-0" PLATFORM PLAN
SCALE: 1/2" = 1'-0"

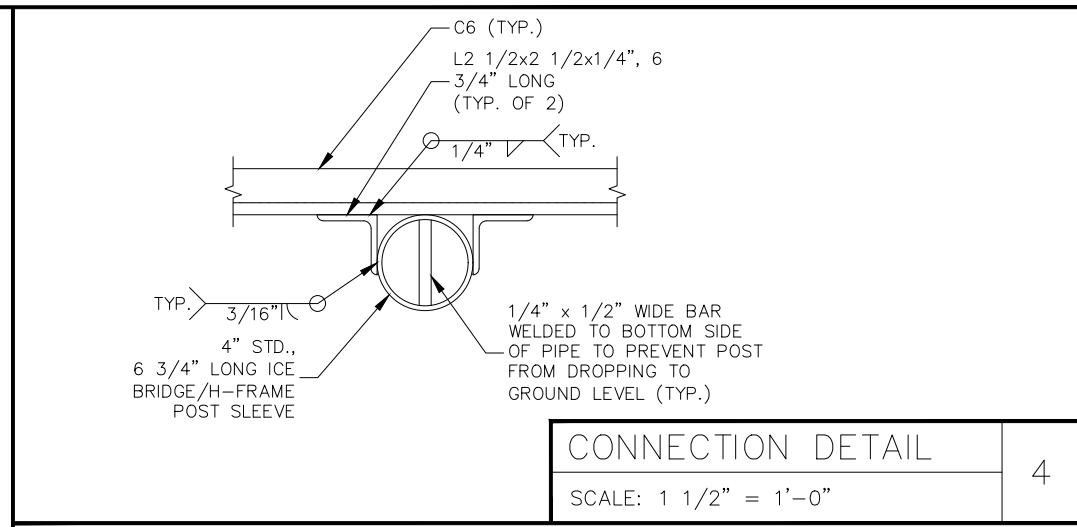


CONNECTION DETAIL 4
SCALE: 1 1/2" = 1'-0"

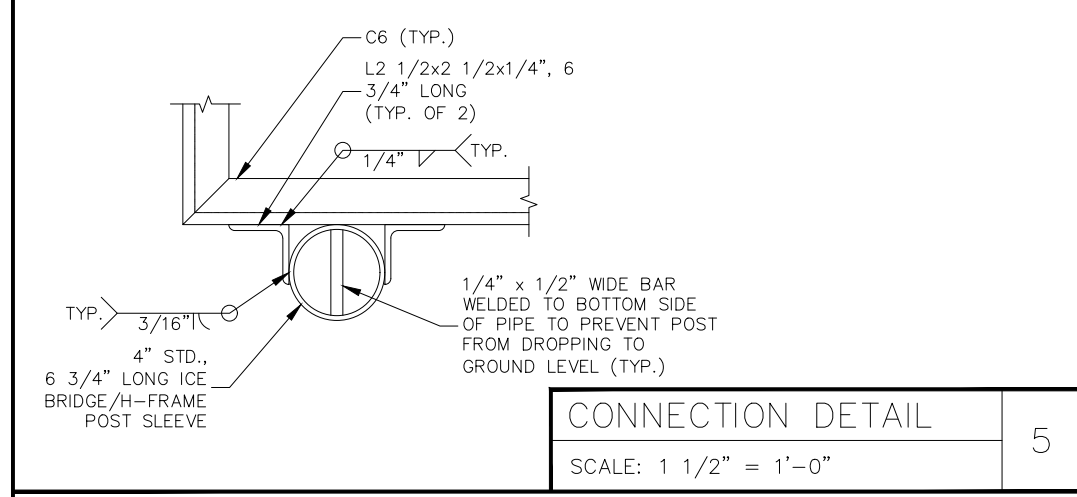


CONNECTION DETAIL 5
SCALE: 1 1/2" = 1'-0"

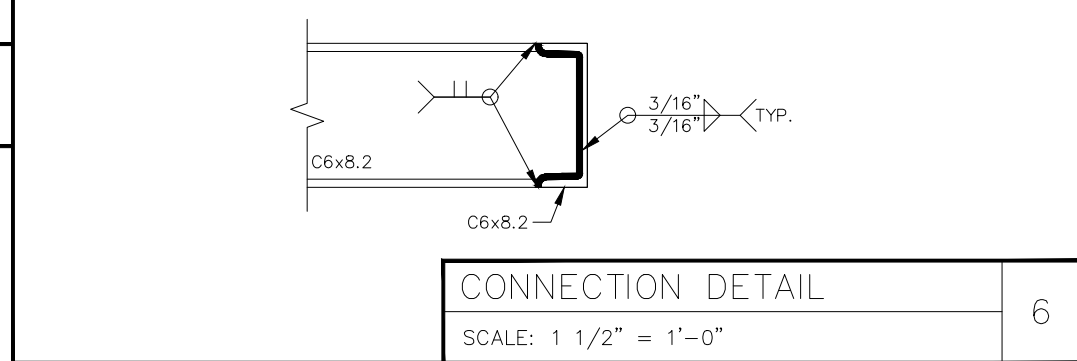


CONNECTION DETAIL 6
SCALE: 1 1/2" = 1'-0"

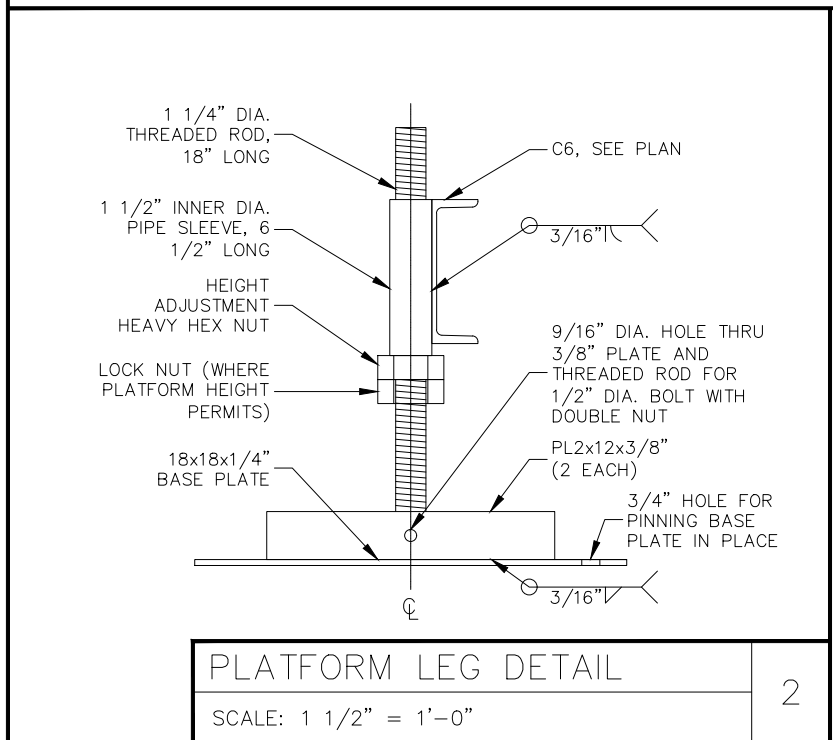

PLATFORM LEG DETAIL 2
SCALE: 1 1/2" = 1'-0"

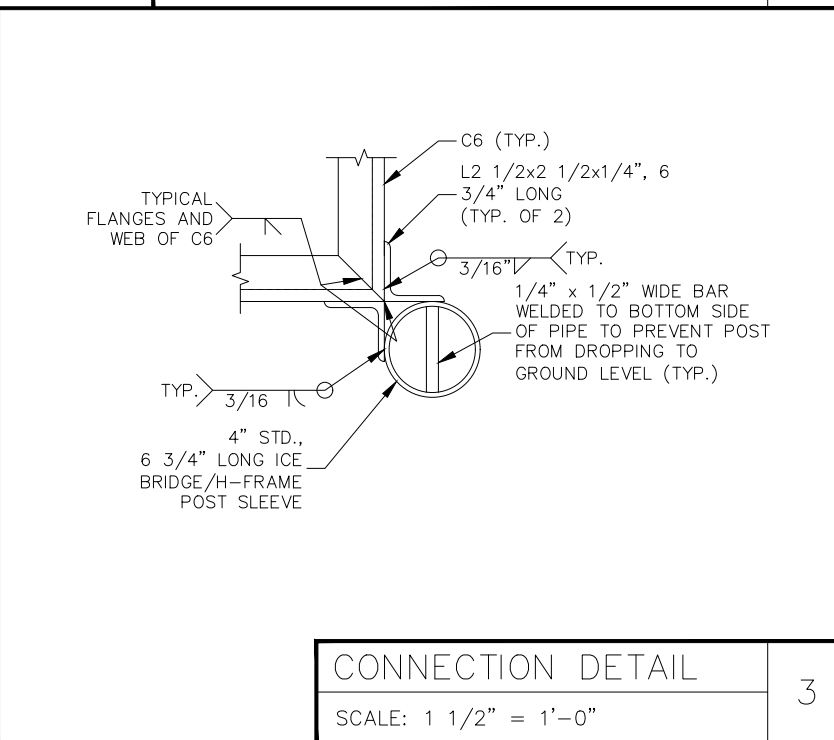

CONNECTION DETAIL 3
SCALE: 1 1/2" = 1'-0"

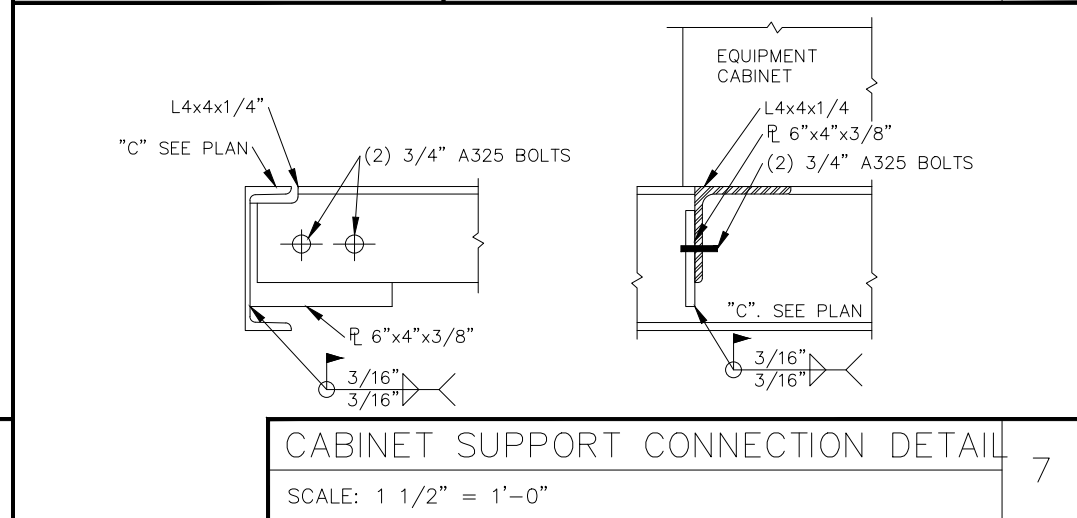

CABINET SUPPORT CONNECTION DETAIL 7
SCALE: 1 1/2" = 1'-0"



PLANS PREPARED BY:
CelluSite, LLC

ENGINEERING LICENSE:

DATE	DESCRIPTION	BY	REV
06/03/15	REVIEW CD	BMW	A
06/04/15	REVIEW CD	BMW	B
07/21/15	REVIEW CD	BMW	C
08/20/15	REVIEW CD	BMW	D

SITE INFORMATION:
ML531081
Christ the Life
Evangelical
Lutheran Church
WI-Waukesha-
Summit
3031 Summit Ave
Waukesha, WI 53188
Waukesha COUNTY

SHEET TITLE:
PLATFORM
DETAILS

SHEET NUMBER:
C-6

GENERAL STRUCTURAL NOTES

1.0 GENERAL CONDITIONS

1.1 DESIGN AND CONSTRUCTION OF WORK SHALL CONFORM TO 2012 INTERNATIONAL BUILDING CODE, ACI 318-11, AISC/ASD 14TH EDITION, ASCE 7-10, TIA/EIA-222-G. IN CASE OF CONFLICT BETWEEN THE CODES, STANDARDS, REGULATIONS, SPECIFICATIONS, GENERAL NOTES AND/OR MANUFACTURER'S REQUIREMENTS USE THE MOST STRINGENT PROVISION.

1.2 IT IS THE EXPRESS INTENT OF THE PARTIES INVOLVED IN THIS PROJECT THAT THE CONTRACTOR OR SUBCONTRACTOR OR INDEPENDENT CONTRACTOR OR THEIR RESPECTIVE EMPLOYEES SHALL EXCULPATE THE ARCHITECT, THE ENGINEER, THE CONSTRUCTION MANAGER, THE OWNER, AND THEIR AGENTS, FROM ANY LIABILITY WHATSOEVER AND HOLD THEM HARMLESS AGAINST LOSS, DAMAGES, LIABILITY OR ANY EXPENSE ARISING IN ANY MATTER FROM THE WRONGFUL OR NEGLIGENT ACT, OR FAILURE TO CARRY OUT THE WORK IN ACCORDANCE WITH THE CONTRACT DOCUMENTS, OR THE CONSTRUCTION MEANS, METHODS, TECHNIQUES, SEQUENCES OR PROCEDURES OR FAILURE TO CONFORM TO THE STATE SCAFFOLDING ACT IN CONNECTION WITH THE WORK.

1.3 DO NOT SCALE DRAWINGS.

1.4 VERIFY ALL EQUIPMENT MOUNTING DIMENSIONS PER MANUFACTURER DRAWINGS.

1.5 SUBMIT ONE COPY OF ALL STRUCTURAL SHOP DRAWINGS FOR REVIEW.

1.6 DESIGN LOADS ARE:

A. EQUIPMENT LOAD

- (1) NEW MEDIUM DELTA CABINET (54"Hx30"Wx36"D).....200 LBS
 *(MEDIUM CABINET WEIGHS 200 LBS. WITHOUT EQUIPMENT OR BATTERIES)**
- (2) NEW SYSTEM MODULE (19.3"Hx17.5"Wx5.23"D).....55.11 LBS
- (1) NEW FCOA CABINET (61"Hx30.3"Wx30.3"D).....789 LBS
- (2) FUTURE FCOA CABINET (61"Hx30.3"Wx30.3"D).....789 LBS

B. PLATFORM LOADS

- LIVE LOAD: 100 PSF
- PLATFORM DEAD LOAD: 15 PSF

2.0 EXISTING CONDITIONS

2.1 CONTRACTOR SHALL FIELD VERIFY THAT THE EXISTING CONSTRUCTION ADJACENT TO THIS CONSTRUCTION, OR TO WHICH THIS CONSTRUCTION SHALL BE CONNECTED, IS AS INDICATED ON THIS DRAWING.

2.2 EXISTING CONDITIONS WILL BE CHECKED AND VERIFIED IN FIELD. IF SIGNIFICANT DEVIATIONS OR DETERIORATION ARE ENCOUNTERED AT THE TIME OF CONSTRUCTION A REPAIR PERMIT WILL BE OBTAINED AND CONTRACTOR SHALL NOTIFY STRUCTURAL ENGINEER IMMEDIATELY.

3.0 STEEL NOTES

3.1 MEET OR EXCEED THE FOLLOWING CODES & STANDARDS EXCEPT AS NOTED:

- A. STRUCTURAL STEEL..... AISC SPECIFICATION ALLOWABLE STRESS DESIGN, 14TH EDITION
 - W SHAPES & CHANNELS.....ASTM A992 - 50KSI
 - SHAPES AND PLATES.....ASTM A36
 - PLATES BENT OR COLD FORMED.....ASTM A 283, GRADE C
 - PIPES.....ASTM A 500, GRADE B - 42 KSI
 - TUBES.....ASTM A 500, Fy= 46 KSI
 - STRUCTURAL SHEETS, HOT ROLLED.....ASTM A 570
 - COLD-FORMED STEEL TUBING.....ASTM A 500, GRADE B
 - BOLTS, NUTS & WASHERS FOR FRAMING
 - MEMBERS AND BRACINGS.....ASTM A 325-X
 - BOLTS, NUTS & WASHERS FOR ANCHOR
 - BOLTS AND SECONDARY CONNECTIONS.....ASTM A 307
 - B. WELDS.....AWS E 70XX

EXCEPTION IS TAKEN TO AISC CODE OF STANDARD PRACTICE PARAGRAPH

3.2.1 REGARDING OWNERS AND FABRICATOR'S RESPONSIBILITY FOR CONNECTION DESIGN AND ADEQUACY OF SHOP DRAWINGS. COMPLIANCE WITH THE REQUIREMENTS SHOWN ON DRAWINGS AND/OR SPECIFICATIONS, CONNECTION DESIGN AND DETAILING IS THE CONTRACTOR'S RESPONSIBILITY. ENGINEER'S REVIEW OF SHOP DRAWINGS IS FOR GENERAL CONSIDERATIONS ONLY AND DOES NOT CONSTITUTE AN ACCEPTANCE OF THESE RESPONSIBILITY BY THE OWNER AND/OR ENGINEER.

3.2.2 ALL UNISTRUT, FASTENERS, HARDWARE, ETC. SHALL BE HOT DIPPED GALVANIZED OR SHALL BE STAINLESS STEEL. ZINC PLATED MATERIAL SHALL NOT BE USED

3.2.3 ALL STRUCTURAL STEEL, SHAPES, PLATES, SHALL BE GALVANIZED PER ASTM 123

4.0 GEOTECHNICAL NOTES

4.1 ALL FOOTINGS SHALL BE CONSTRUCTED UPON UNDISTURBED, NATURAL SUBGRADE OR COMPACTED GRANULAR FILL WITH A MINIMUM NET ALLOWABLE BEARING CAPACITY OF 2000 PSF.

4.2 THE SOIL SUBGRADE FOR ALL FOOTINGS AND SLABS SHALL BE INSPECTED AND APPROVED BY THE OWNER'S TESTING AGENCY IMMEDIATELY PRIOR TO PLACING FOUNDATION CONCRETE OR CONCRETE MUD SLABS.

4.3 ALL ORGANIC AND / OR OTHER UNSUITABLE MATERIAL SHALL BE REMOVED FROM FOUNDATION AND SLAB SUBGRADE AND BACKFILL AREAS, AND THEN BACKFILLED WITH ACCEPTABLE GRANULAR FILL COMPACTED TO 95 PERCENT OF MAXIMUM DENSITY AT OPTIMUM MOISTURE CONTENT (ASTM D1557).

4.4 NO FOOTINGS OR STRUCTURAL SLABS SHALL BE PLACED INTO OR AGAINST SUBGRADES CONTAINING FREE WATER, FROST OR ICE. SHOULD WATER OR FROST ENTER A FOOTING/MUD SLAB/STRUCTURAL SLAB EXCAVATION AFTER SUBGRADE APPROVAL, THE SUBGRADE SHALL BE REINSPECTED BY THE OWNER'S SOIL TESTING LABORATORY AFTER REMOVAL OF WATER, FROST, OR ICE.


4.5 THE CONTRACTOR SHALL PROVIDE ALL NECESSARY MEASURES TO PREVENT ANY WATER, FROST, OR ICE FROM PENETRATING ANY FOOTING OR STRUCTURAL/ MUD SLAB SUBGRADE BEFORE AND AFTER PLACING OF CONCRETE, AND UNTIL SUCH SUBGRADES ARE FULLY PROTECTED BY THE PERMANENT BUILDING STRUCTURE.

4.6 ALL FOOTING MUD SLABS SHALL BE THOROUGHLY CLEANED IMMEDIATELY PRIOR TO CONCRETE PLACEMENT.



PLANS PREPARED BY:

CelluSite, LLC

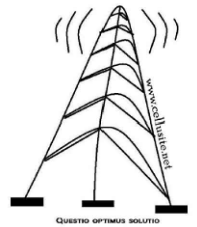

ENGINEERING LICENSE:

DATE	DESCRIPTION	BY	REV
06/03/15	REVIEW CD	BMW	A
06/04/15	REVIEW CD	BMW	B
07/21/15	REVIEW CD	BMW	C
08/20/15	REVIEW CD	BMW	D

SITE INFORMATION:

ML53108I
Christ the Life
Evangelical
Lutheran Church
WI-Waukesha-
Summit
 3031 Summit Ave
 Waukesha, WI 53188
 Waukesha COUNTY


SHEET TITLE:

PLATFORM
NOTES


SHEET NUMBER:

C-7


NOTE:
ALL WOOD COMPONENTS TO BE PRESSURE TREATED UNLESS NOTED OTHERWISE AND ALL METAL COMPONENTS TO BE CORROSION RESISTANT AND COMPATIBLE WITH TREATED LUMBER.

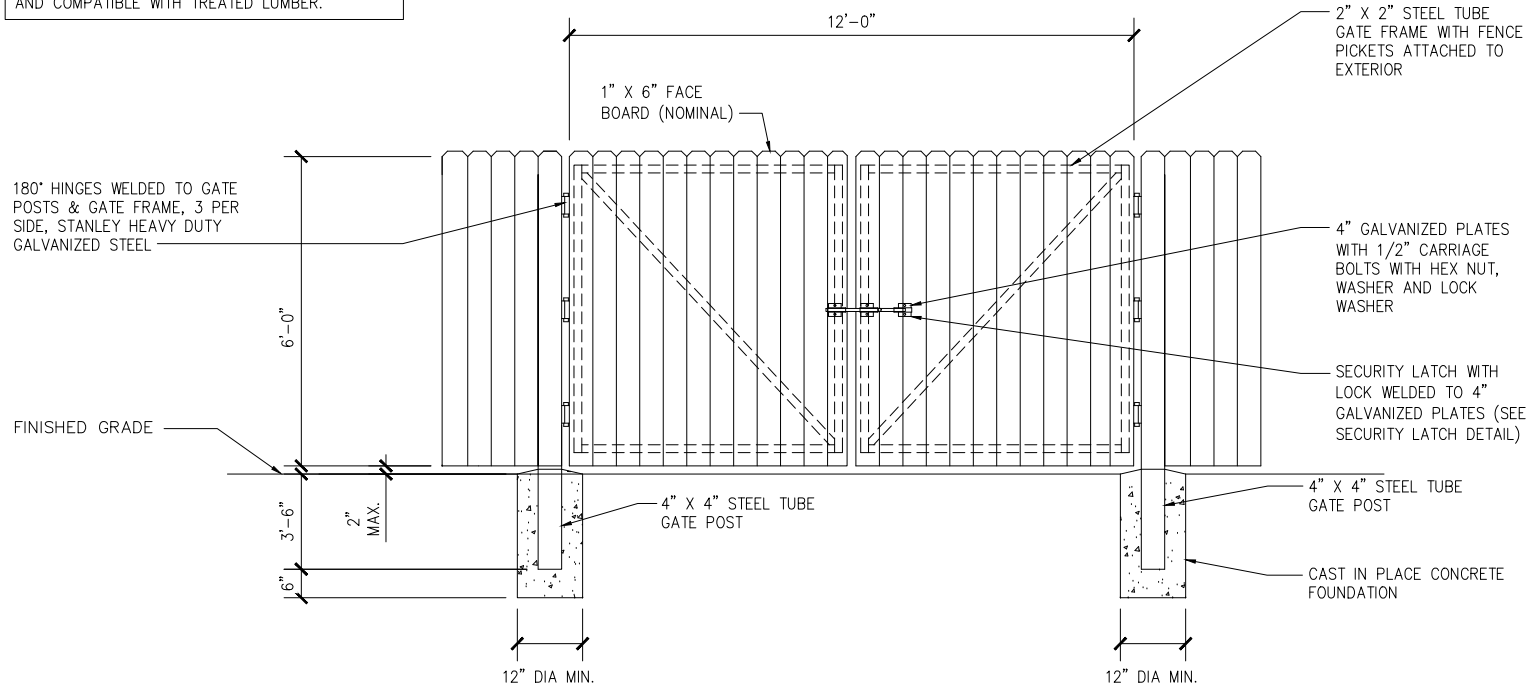


GATE & FENCE ELEVATION
SCALE: NOT TO SCALE

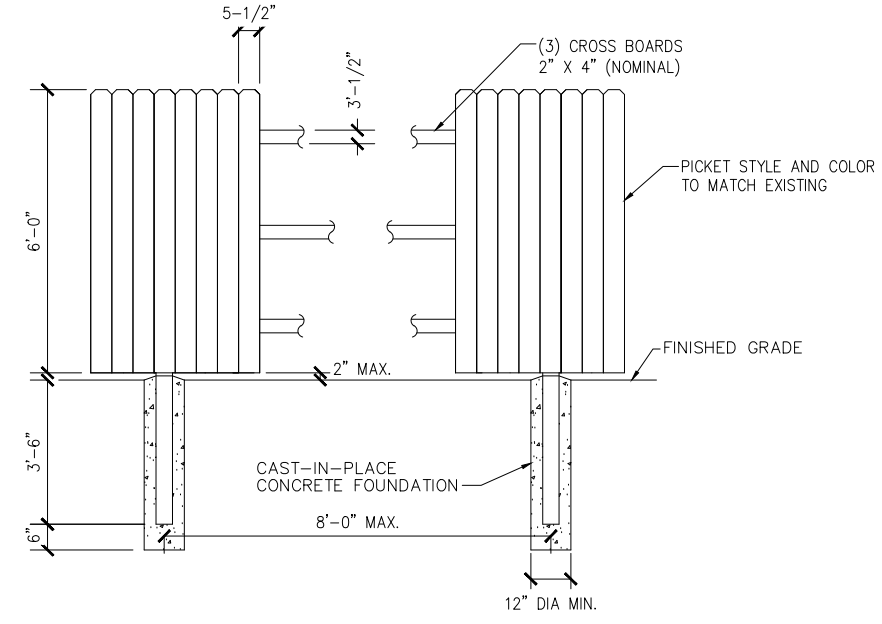


FENCE DETAIL SECTION
SCALE: NOT TO SCALE

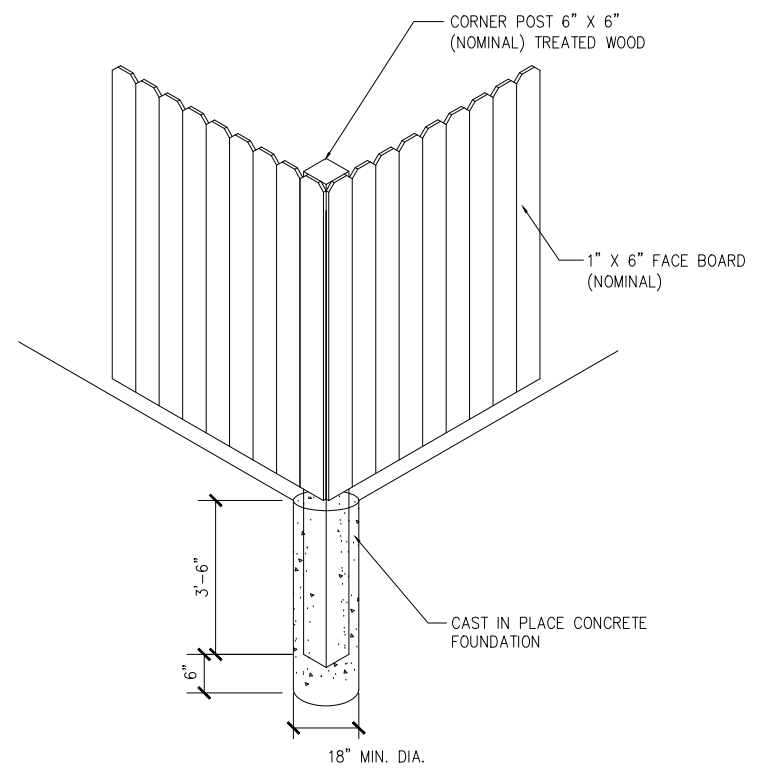

FENCE CORNER DETAIL
SCALE: NOT TO SCALE

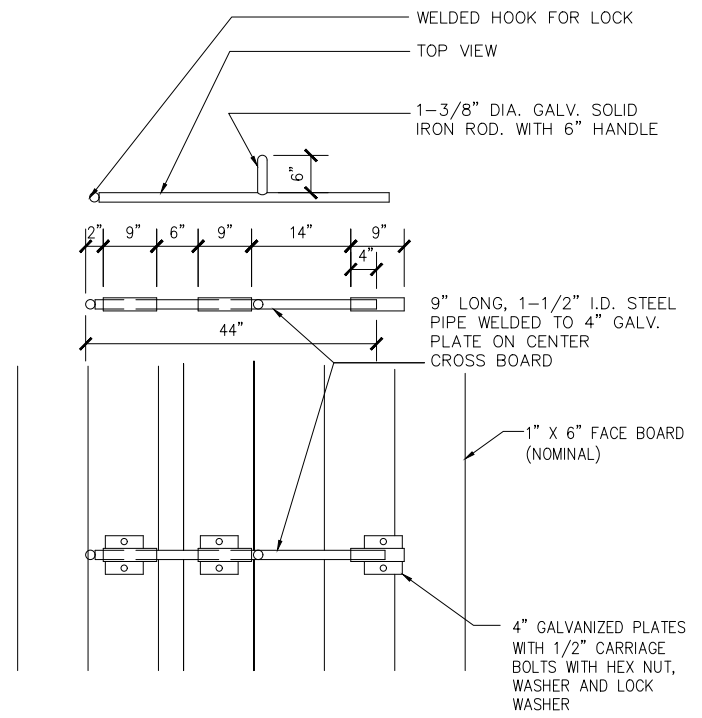


SECURITY LATCH DETAIL
SCALE: NOT TO SCALE

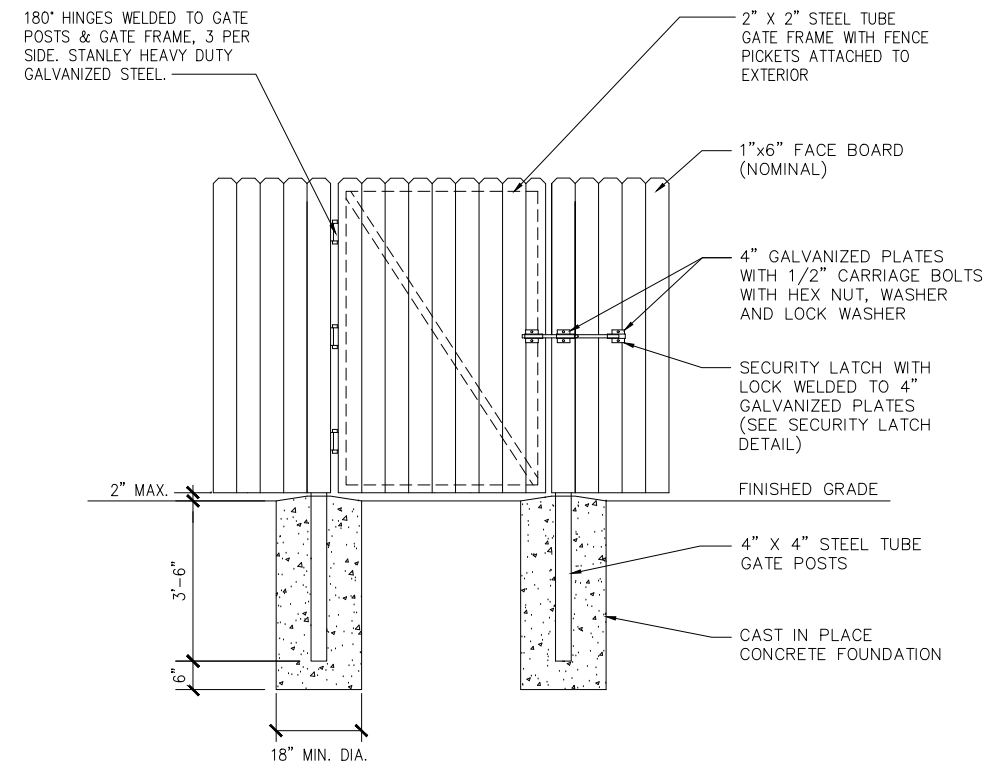

GATE DETAIL
SCALE: NOT TO SCALE



PLANS PREPARED BY:
CelluSite, LLC

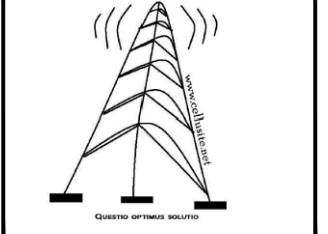

ENGINEERING LICENSE:


DATE	DESCRIPTION	BY	REV
06/03/15	REVIEW CD	BMW	A
06/04/15	REVIEW CD	BMW	B
07/21/15	REVIEW CD	BMW	C
08/20/15	REVIEW CD	BMW	D

SITE INFORMATION:
ML531081
Christ the Life
Evangelical
Lutheran Church
WI-Waukesha-
Summit
3031 Summit Ave
Waukesha, WI 53188
Waukesha COUNTY

SHEET TITLE:
FENCE DETAILS

SHEET NUMBER:
C-8

- NEW T-MOBILE ANTENNA
RAD CENTER @ ±140'-0"
- NEW T-MOBILE PLATFORM
@ ±137'-6"
- NEW C PORT HEIGHT
±135'-0"

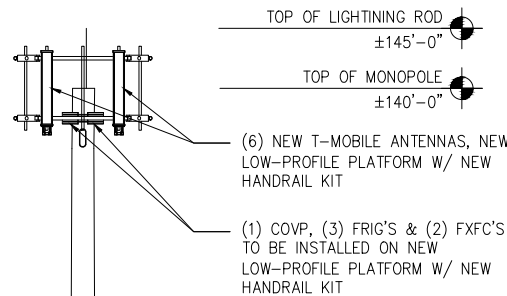


- NOTE:
CELLUSITE'S SCOPE OF WORK DOES NOT INCLUDE A STRUCTURAL EVALUATION OF THIS TOWER OR STRUCTURE. NEW ANTENNAS AND EQUIPMENT SHOWN ON THIS PLAN HAVE NOT BEEN EVALUATED TO VERIFY THE TOWER OR STRUCTURE HAS THE CAPACITY TO ADEQUATELY SUPPORT THESE ANTENNAS. PRIOR TO ANY ANTENNA OR EQUIPMENT INSTALLATION, A STRUCTURAL EVALUATION OF THE TOWER OR STRUCTURE, INCLUDING ALL ANTENNA MOUNTING SYSTEMS & HARDWARE SHOULD BE PERFORMED.
- NOTE:
CONTRACTOR TO VERIFY ALL HEIGHTS AND AZIMUTHS IN FIELD PRIOR TO CONSTRUCTION. CONTRACTOR SHALL NOTIFY T-MOBILE AND ENGINEERING FIRM OF ANY DISCREPANCIES BEFORE PROCEEDING.
- NOTE:
CONTRACTOR TO USE PROPER TORQUE WRENCH WHEN INSTALLING AND TIGHTENING CONNECTORS TO INSURE PROPER FIT.
- NOTE:
CONTRACTOR TO ARRANGE NEW MODULES/EQUIPMENT TO AVOID INTERFERING WITH SAFETY CLIMB.
- NOTE:
CONTRACTOR SHALL BE RESPONSIBLE FOR VERIFYING FINAL RF CONFIGURATION AND NOTIFY T-MOBILE AND ENGINEERING FIRM WITH ANY DISCREPANCIES.
- NOTE:
CONTRACTOR SHALL VERIFY ALL FINAL CONNECTION LOCATIONS WITH T-MOBILE ENGINEER, RF ENGINEER, AND NET-OPS PRIOR TO INSTALLATION.

NEW ±140'-0" MONOPOLE

GRADE 739'-0" AMSL

TOWER ELEVATION
SCALE: 3/16 = 1'-0" 1

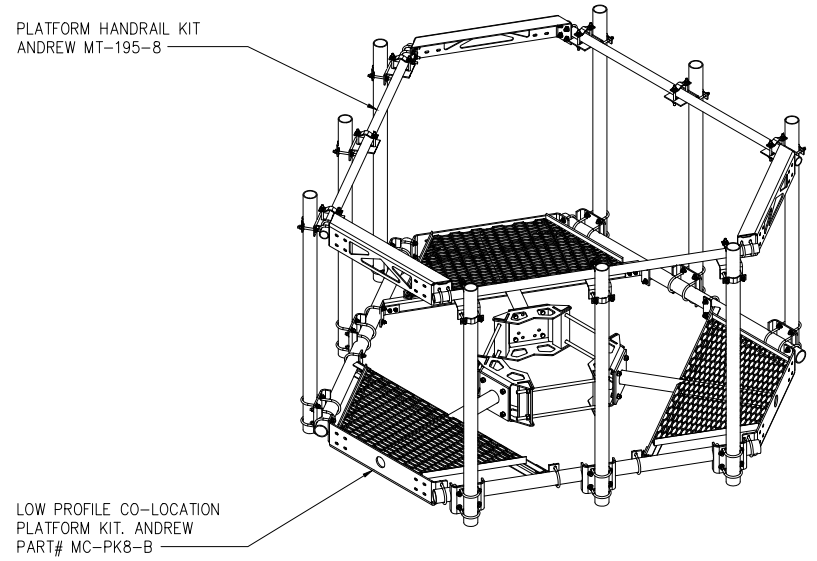

ANTENNA PLATFORM W/ HANDRAIL KIT
SCALE: NOT TO SCALE 2



PLANS PREPARED BY:
CelluSite, LLC

QUESTO OPTIMUS SOLUTIO

ENGINEERING LICENSE:

DATE	DESCRIPTION	BY	REV
06/03/15	REVIEW CD	BMW	A
06/04/15	REVIEW CD	BMW	B
07/21/15	REVIEW CD	BMW	C
08/20/15	REVIEW CD	BMW	D

SITE INFORMATION:
ML531081
Christ the Life
Evangelical
Lutheran Church
WI-Waukesha-
Summit
3031 Summit Ave
Waukesha, WI 53188
Waukesha COUNTY

SHEET TITLE:
TOWER
ELEVATION



SHEET NUMBER:
A-1

PLOT SCALE: 1:1 @ 11"x17"


ANTENNA & CABLE SCHEDULE							
SECTOR	ALPHA		BETA		GAMMA		DELTA
LOCATION	A-2	A-1	B-2	B-1	C-2	C-1	
TECHNOLOGY	LTE	UMTS	LTE	UMTS	LTE	UMTS	
AZIMUTH	45°		140°		270°		
RAD CENTER	±140'-0"		±140'-0"		±140'-0"		
COLOR CODING	RED (5-8)	RED (1-4)	GREEN (5-8)	GREEN (1-4)	BLUE (5-8)	BLUE (1-4)	
MODEL #	ANDREW TMBXX-6516-A2M	ANDREW TMBXX-6516-A2M	ANDREW TMBXX-6516-A2M	ANDREW TMBXX-6516-A2M	ANDREW TMBXX-6516-A2M	ANDREW TMBXX-6516-A2M	
MECHANICAL DOWNTILT	0	0	0	0	0	X	
ELECTRICAL DOWNTILT	3	3	3	3	3	3	
RRU TYPE	FRIG	(2) FXFC'S	FRIG	SHARED FXFC	FRIG	SHARED FXFC	
HCS DIA. & TYPE	1.584" HIGH CAPACITY	-	-	-	-	-	
HCS ACTUAL LENGTH	±155'-0"	-	-	-	-	-	
HCS FACTORY LENGTH	175'-0"	-	-	-	-	-	
FIBER JUMPER LENGTH	15'-0"	15'-0"	15'-0"	-	15'-0"	-	
RF JUMPER LENGTH	6'-0"	12'-0"	6'-0"	20'-0"	6'-0"	6'-0"	

NOTE:
CELLUSITE'S SCOPE OF WORK DOES NOT INCLUDE A STRUCTURAL EVALUATION OF THIS TOWER OR STRUCTURE. NEW ANTENNAS AND EQUIPMENT SHOWN ON THIS PLAN HAVE NOT BEEN EVALUATED TO VERIFY THE TOWER OR STRUCTURE HAS THE CAPACITY TO ADEQUATELY SUPPORT THESE ANTENNAS. PRIOR TO ANY ANTENNA OR EQUIPMENT INSTALLATION, A STRUCTURAL EVALUATION OF THE TOWER OR STRUCTURE, INCLUDING ALL ANTENNA MOUNTING SYSTEMS & HARDWARE SHOULD BE PERFORMED.


NOTE:
ANTENNA INFORMATION OBTAINED FROM T-MOBILE RF DATA CONFIGURATION SHEET DATED 11/20/14

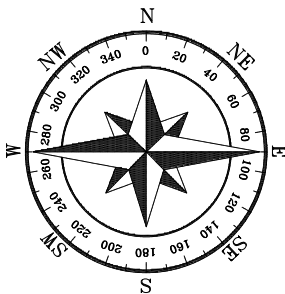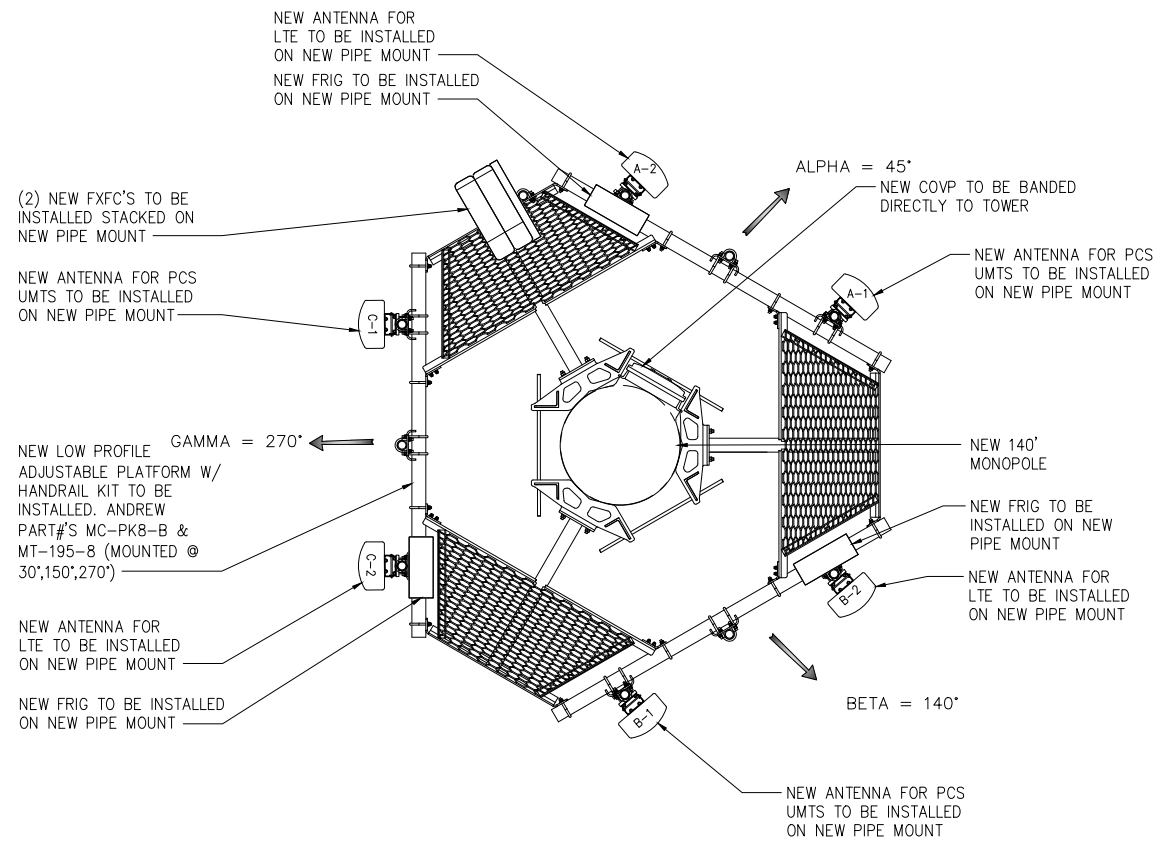

ANTENNA PLAN
SCALE: 1/4"=1'-0"

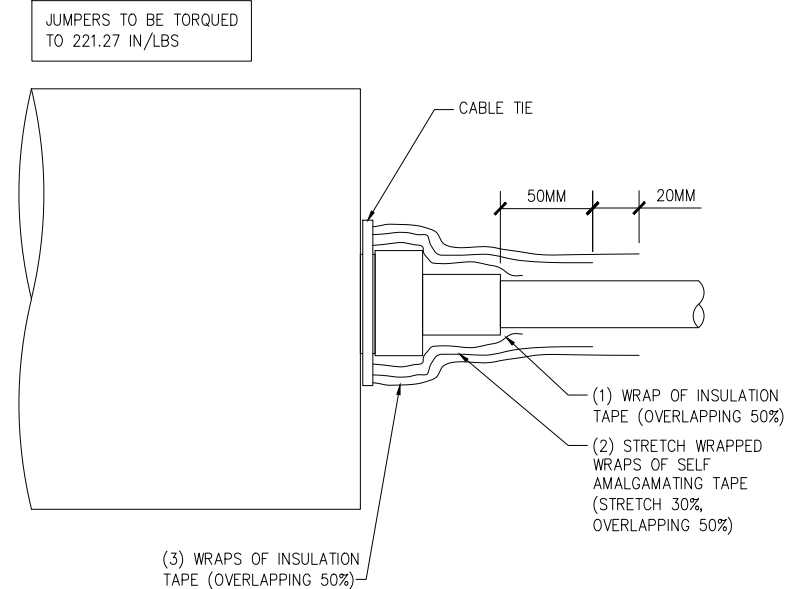

RF JUMPER CONNECTION DETAIL
SCALE: NOT TO SCALE

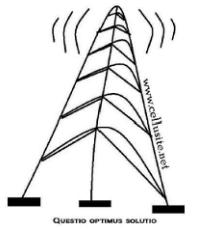


DATE	DESCRIPTION	BY	REV
06/03/15	REVIEW CD	BMW	A
06/04/15	REVIEW CD	BMW	B
07/21/15	REVIEW CD	BMW	C
08/20/15	REVIEW CD	BMW	D

ML531081
Christ the Life
Evangelical
Lutheran Church
WI-Waukesha-
Summit
3031 Summit Ave
Waukesha, WI 53188
Waukesha COUNTY

ANTENNA PLAN


A-2

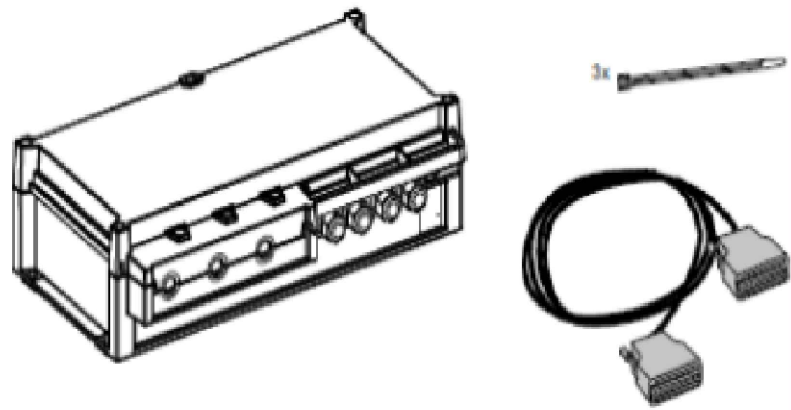

FSEB

SCALE: NOT TO SCALE


1

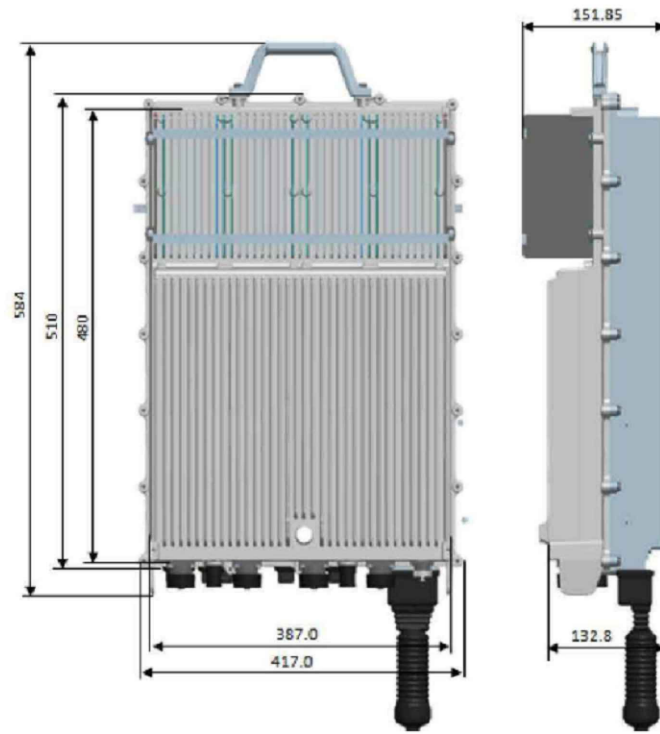

FRIG

SCALE: NOT TO SCALE

2

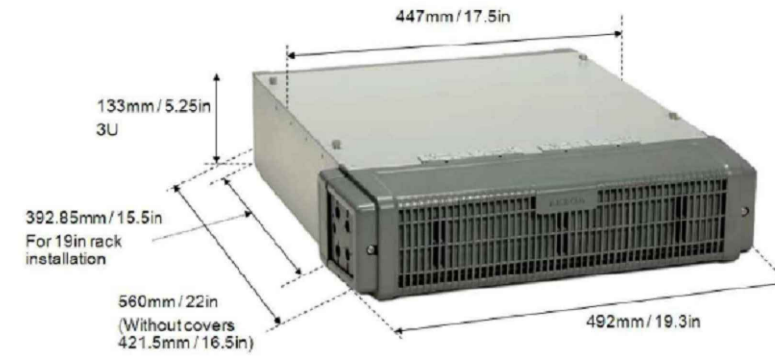

FSMF


SCALE: NOT TO SCALE

2




PLANS PREPARED BY:

CelluSite, LLC

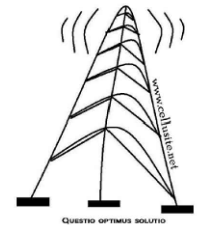

ENGINEERING LICENSE:



DATE	DESCRIPTION	BY	REV
06/03/15	REVIEW CD	BMW	A
06/04/15	REVIEW CD	BMW	B
07/21/15	REVIEW CD	BMW	C
08/20/15	REVIEW CD	BMW	D

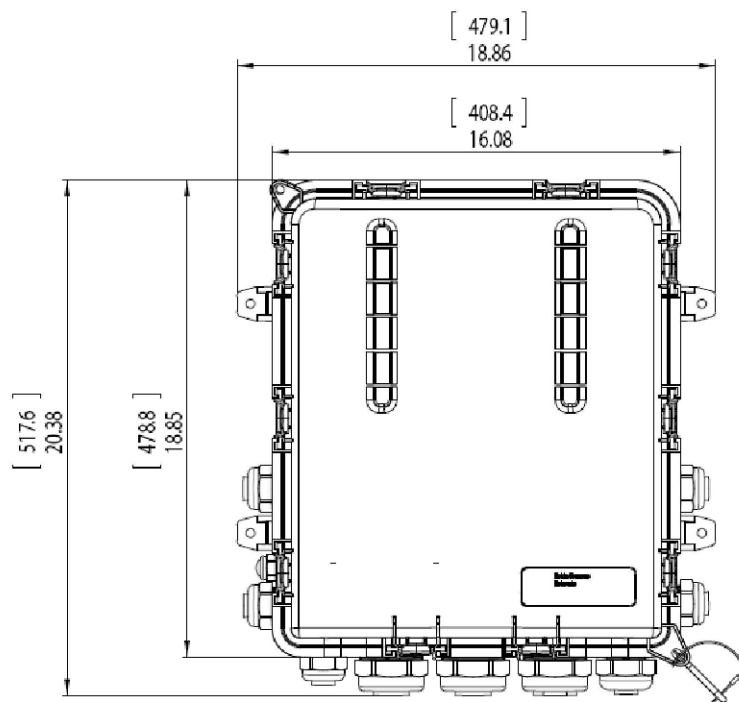

COVP

SCALE: NOT TO SCALE



4

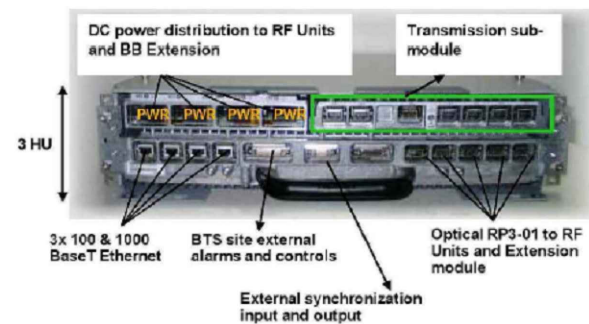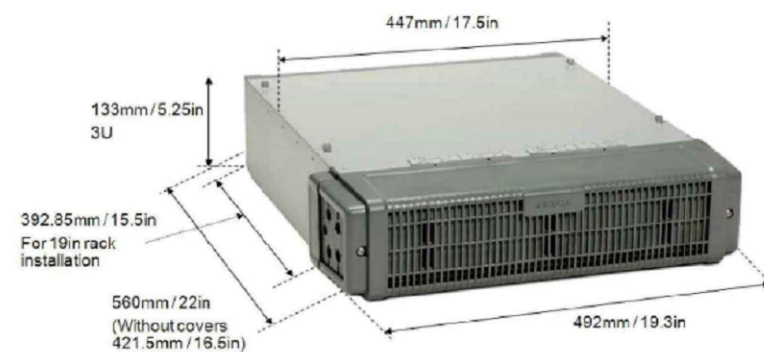

FSME

SCALE: NOT TO SCALE

5

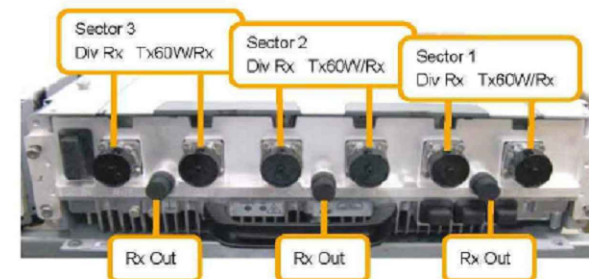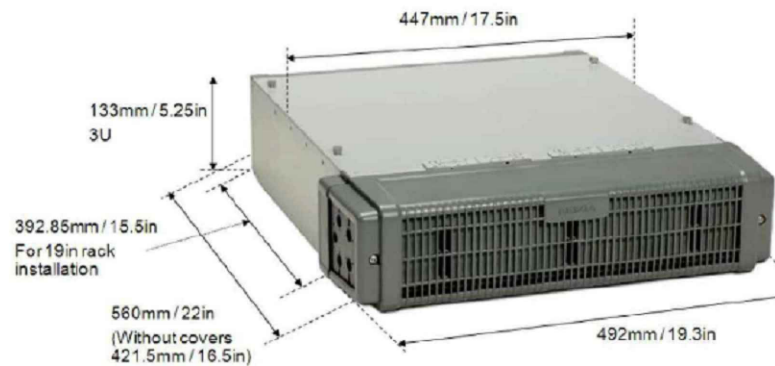

FXFC

SCALE: NOT TO SCALE

6

SITE INFORMATION:

ML53108I
Christ the Life
Evangelical
Lutheran Church
WI-Waukesha-
Summit
3031 Summit Ave
Waukesha, WI 53188
Waukesha COUNTY

SHEET TITLE:

EQUIPMENT
SPECIFICATIONS

SHEET NUMBER:

A-3



[Back to RFDS Search](#)

Modernization RFDS Data Configuration Sheet

Date: 5/14/2015

[Print RFDS](#)

Site Information:

Market:	ML	Radio Vendor:	NSN	Plan Year:	NLP Desc:
Site Id:	ML531081	Site Name:	Christ The Life Evangelical	Structural Owner:	
Type/Class:	Structure (Non-Building) / Monopole				
Address:	3031 Summit Ave	City:	Waukesha	State:	WI Zip: 53188
Latitude:	43.018814	Longitude:	-88.278211	Created Date:	Mar 3 2015
RF Manager:	Prasanth Attaluri	RF Engineer:	Sudhir Kora	Last Save Date:	Mar 20 2015 3:40PM GJOHNSO61

Project Type: NSD RFDS Upgraded? Template? Standard

Cell Site Configuration

Configuration Type:	Configuration 1G		
Final Configuration (Antenna/Line/TMA/RRU):	6/0/0/5	Solution Type:	Tower Top
Final Sector Count:	3	RFDS Status:	Preliminary
		Design Type:	Final
		Drawing Type:	Default

Sector Information

PCS UMTS Design	A	B	C	D	E	F
Antenna RAD Center:	140	140	140			
Antenna Azimuth:	45	140	270			
Mechanical Tilt:	0	0	0			
Electrical Tilt:	3	3	3			
L2100 Design	A	B	C	D	E	F
Antenna RAD Center:	140	140	140			
Antenna Azimuth:	45	140	270			
Mechanical Tilt:	0	0	0			
Electrical Tilt:	3	3	3			

Antenna Configuration (Site Level)	Antenna ReUse Existing?/Qty	Antenna Model	Antenna Qty	Antenna and (or) Ports Shared
PCS UMTS	New /	Andrew - TMBXX-6516-A2M	3	No
L2100	New /	Andrew - TMBXX-6516-A2M	3	No

TMA Configuration (Site Level)	TMA(ReUse existing TMA/New/Not Needed)	TMA Model	TMA Qty	TMA Location
PCS UMTS	Not Needed		0	
L2100	Not Needed		0	

Diplexer/Combiner Configuration	A	B	C	D	E	F
Diplexer Model (1):						
Diplexer Qty (1):						
Diplexer Model (2):						
Diplexer Qty (2):						
Combiner/Duplexer Model:						
Combiner/Duplexer Qty:						

Antenna Fiber/ Coax Solution (Site Level)	Use HCS (Yes/No)?
Use HCS (Yes/No)?	Yes
Use NSN Fiber & OVP for Rooftop (Yes/No)?	No
Use Coax Cable (Yes/No)?	No

Hybrid Cable Configuration (Site Level)

Hybrid Cable Type:	High Capacity HCS - 1.584
Hybrid Cable Length:	150
Hybrid Cable Qty:	1

Hybrid Cable Config(Sector Level)	A	B	C	D	E	F
HCS run between Sectors (e.g. Rooftop/ Watertank etc.)						
Hybrid Cable Length (ft):						

COVP Configuration (Site Level)

COVP Type (1):	Large COVP	COVP Qty (1):	2
COVP Type (2):		COVP Qty (2):	

Coax Configuration

Coax Configuration	A	B	C	D	E	F
Existing Coax Qty:						
Existing Coax Size:						
Re-use existing coax for TDOA (Yes/No)?						
Qty. of excess coax lines to remove?						
New Coax Type:						
New Coax Length/Line:						
New Coax Qty:						
RET Home-Run Cable:						
RET Home-Run Cable Length(ft):						

System Modules (Site Level)

System Modules (Site Level)	System Module Type(1)	System Module Qty(1)	System Module Type(2)	System Module Qty(2)	System Sub Module Type	System Sub Module Qty
PCS UMTS	FSMF	1				
LTE	FSMF	1				

RF Modules (Site Level)

RF Modules (Site Level)	RF Module Type(1)	RF Module Qty(1)	RF Module Type(2)	RF Module Qty(2)
PCS UMTS	FXFC	2		
L2100	FRIG	3		

Sector/BTS/Node-B (Site Level)


Sector/BTS/Node-B (Site Level)	Sector Count:	BTS/Node-B Count:
PCS UMTS	3	1
L2100	3	1

Comments



PLANS PREPARED BY:

CelluSite, LLC

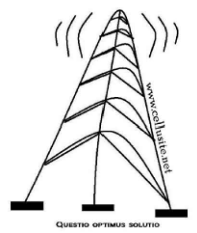

ENGINEERING LICENSE:

DATE	DESCRIPTION	BY	REV
06/03/15	REVIEW CD	BMW	A
06/04/15	REVIEW CD	BMW	B
07/21/15	REVIEW CD	BMW	C
08/20/15	REVIEW CD	BMW	D

SITE INFORMATION:

ML531081
Christ the Life
Evangelical
Lutheran Church
WI-Waukesha-
Summit
 3031 Summit Ave
 Waukesha, WI 53188
 Waukesha COUNTY

SHEET TITLE:

RF DATA SHEET

SHEET NUMBER:

A-4

PLOT SCALE: 1:1 @ 11"x17"

RF DATA SHEET PAGE 1


SCALE: NOT TO SCALE

1

RF DATA SHEET PAGE 2

SCALE: NOT TO SCALE

2

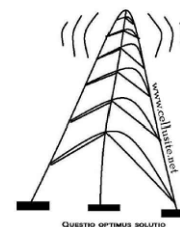


DATE	DESCRIPTION	BY	REV
06/03/15	REVIEW CD	BMW	A
06/04/15	REVIEW CD	BMW	B
07/21/15	REVIEW CD	BMW	C
08/20/15	REVIEW CD	BMW	D

SITE INFORMATION:
ML531081
Christ the Life
Evangelical
Lutheran Church
WI-Waukesha-
Summit
3031 Summit Ave
Waukesha, WI 53188
Waukesha COUNTY

SHEET TITLE:
RISER DIAGRAM

SHEET NUMBER:
A-5

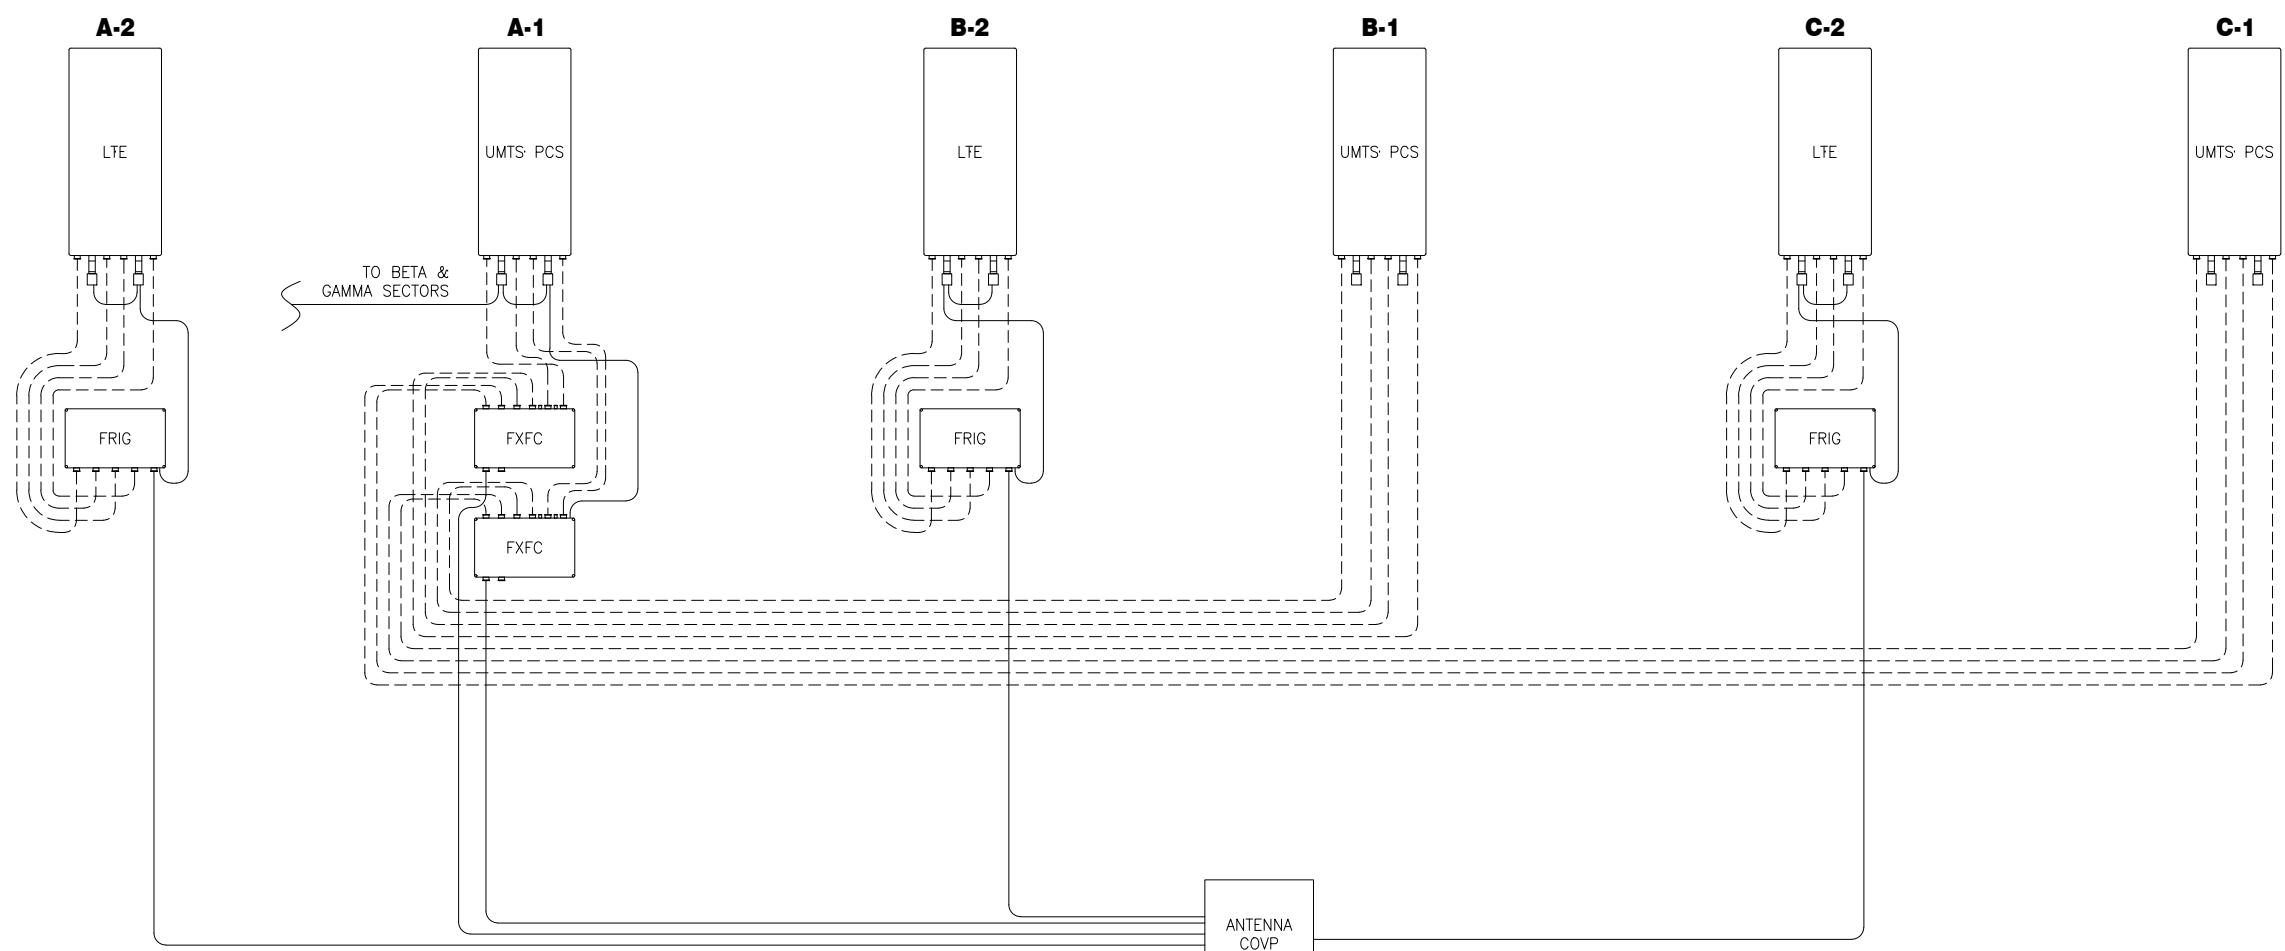

ANTENNA LOCATION
EQUIPMENT LOCATION

LEGEND

--- --- --- ---	RF CABLE
-----	RF JUMPER
-----	MAIN POWER & FIBER
-----	POWER & FIBER JUMPER
-----	AISG RET CABLE
-----	HYBRID CABLE
-----	COAX CABLE
-----	POWER

RISER DIAGRAM
SCALE: NOT TO SCALE


Configuration 1G for greenfield sites with UMTS1900 and LTE AWS

Drawing Date: 6/12/2014

Legend

- LTE
- PCS
UMTS

- RCT Cabling
- RF Cabling
- LMR Cabling
- Fiber & Power
- Hybrid Power Cable Main
- Power & Fiber

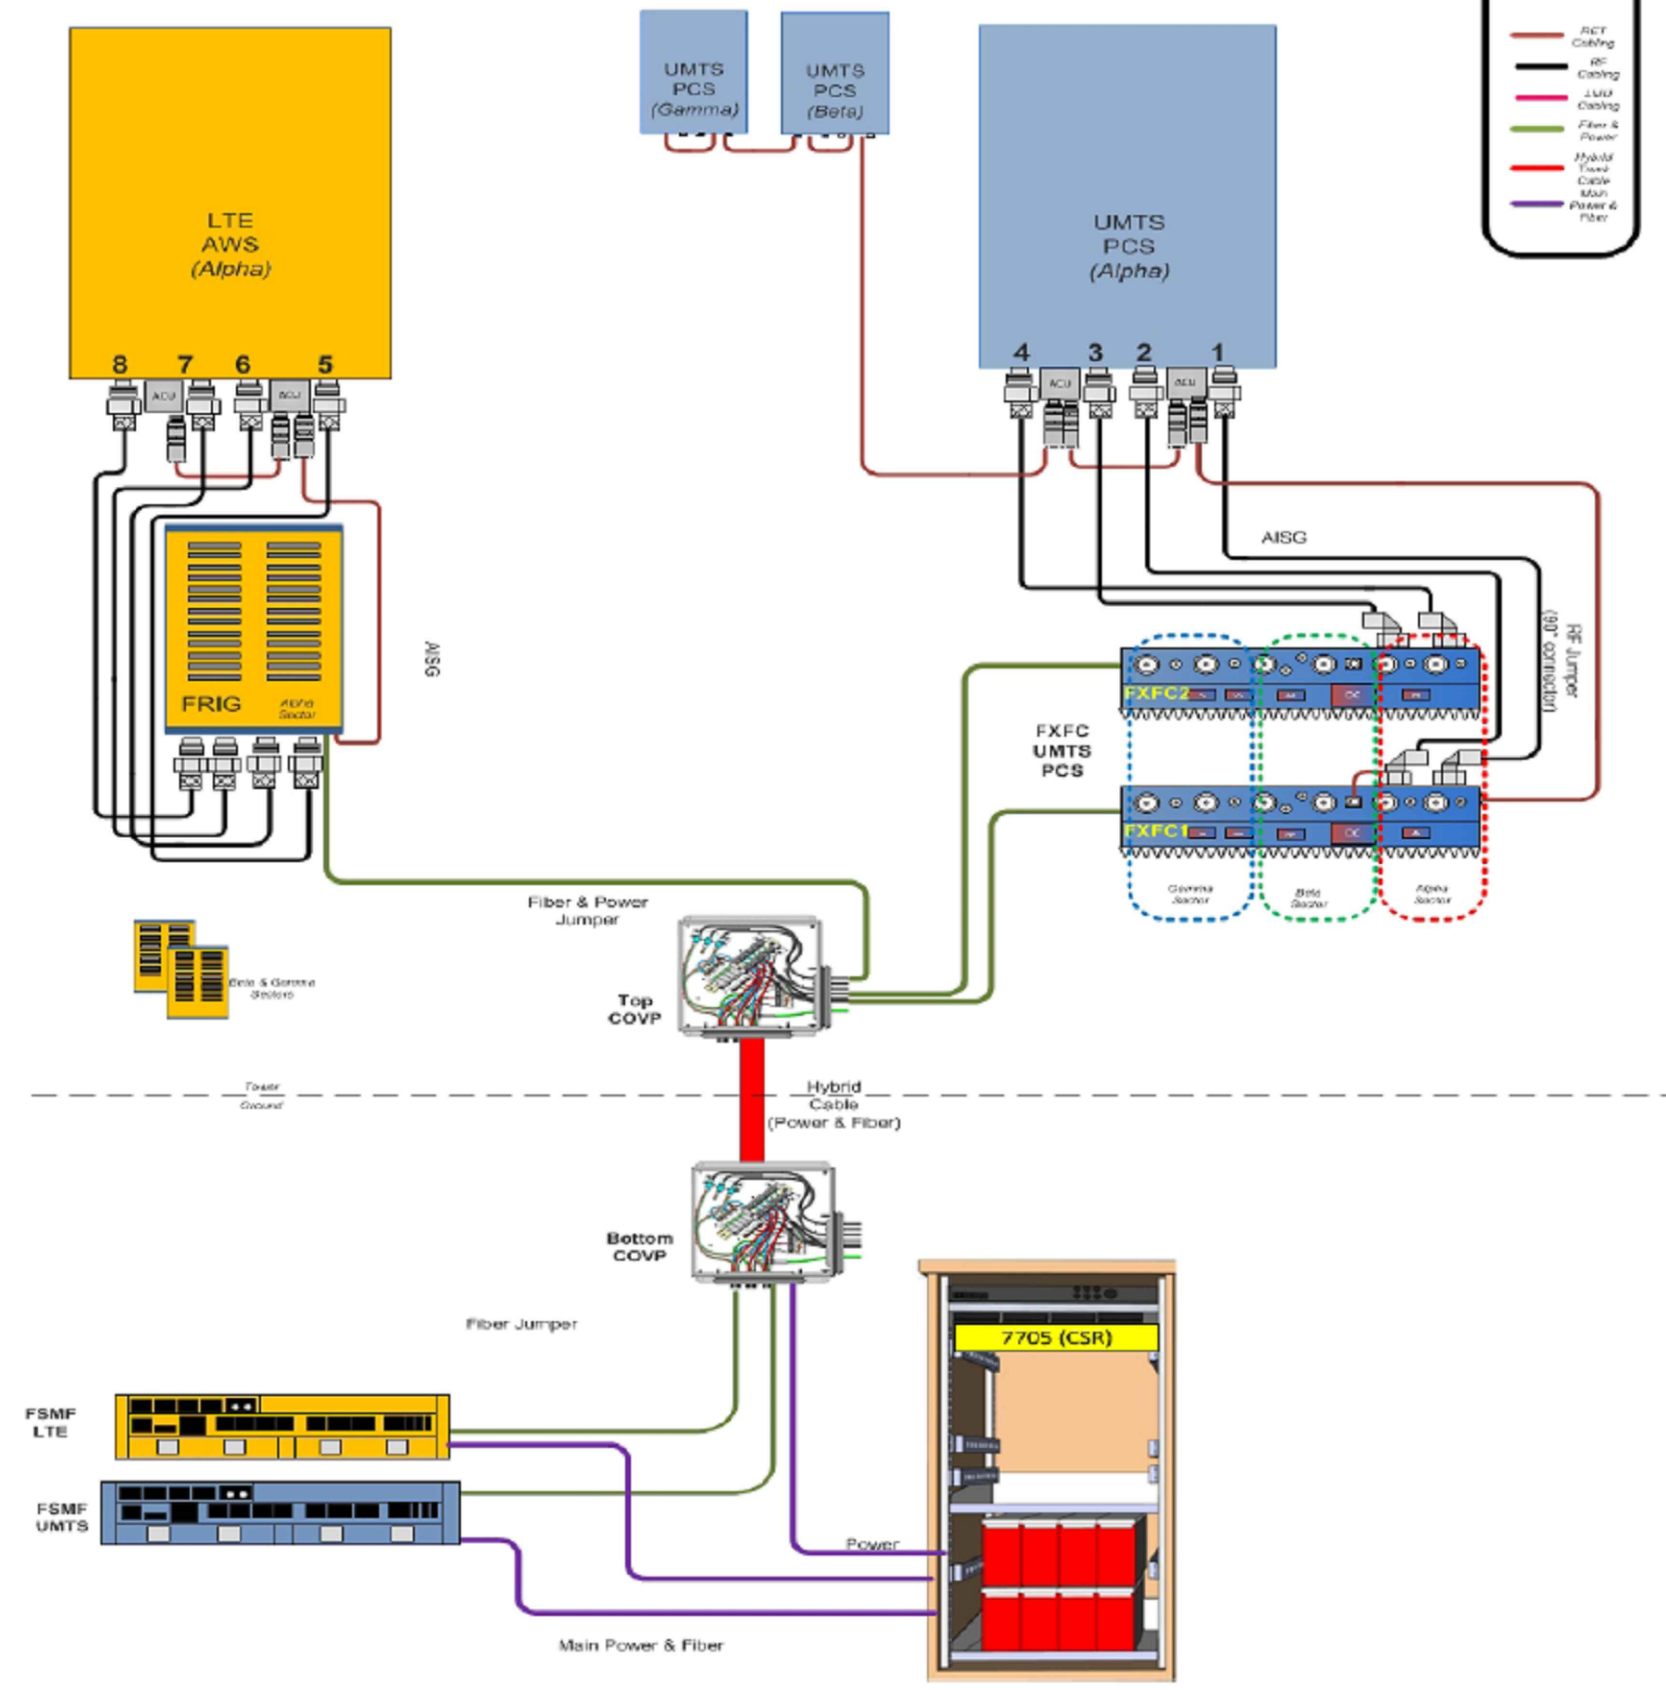

PLANS PREPARED BY:
CelluSite, LLC

ENGINEERING LICENSE:

DATE	DESCRIPTION	BY	REV
06/03/15	REVIEW CD	BMW	A
06/04/15	REVIEW CD	BMW	B
07/21/15	REVIEW CD	BMW	C
08/20/15	REVIEW CD	BMW	D

SITE INFORMATION:

ML531081
Christ the Life
Evangelical
Lutheran Church
WI-Waukesha-
Summit
3031 Summit Ave
Waukesha, WI 53188
Waukesha COUNTY

SHEET TITLE:
ANTENNA
CONFIGURATION
SHEET



SHEET NUMBER:
A-6

ANTENNA CONFIGURATION SHEET
SCALE: NOT TO SCALE

LEGEND

FIBER LINE	F
ELECTRIC LINE	E

NOTE:
ALL UNISTRUT, FASTENERS, HARDWARE, ETC. ARE TO BE EITHER HOT-DIPPED GALVANIZED OR STAINLESS STEEL. GENERAL CONTRACTOR IS NOT TO USE ZINC-PLATED OR PRE-GALVANIZED.

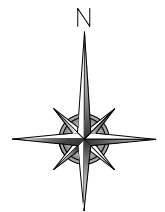
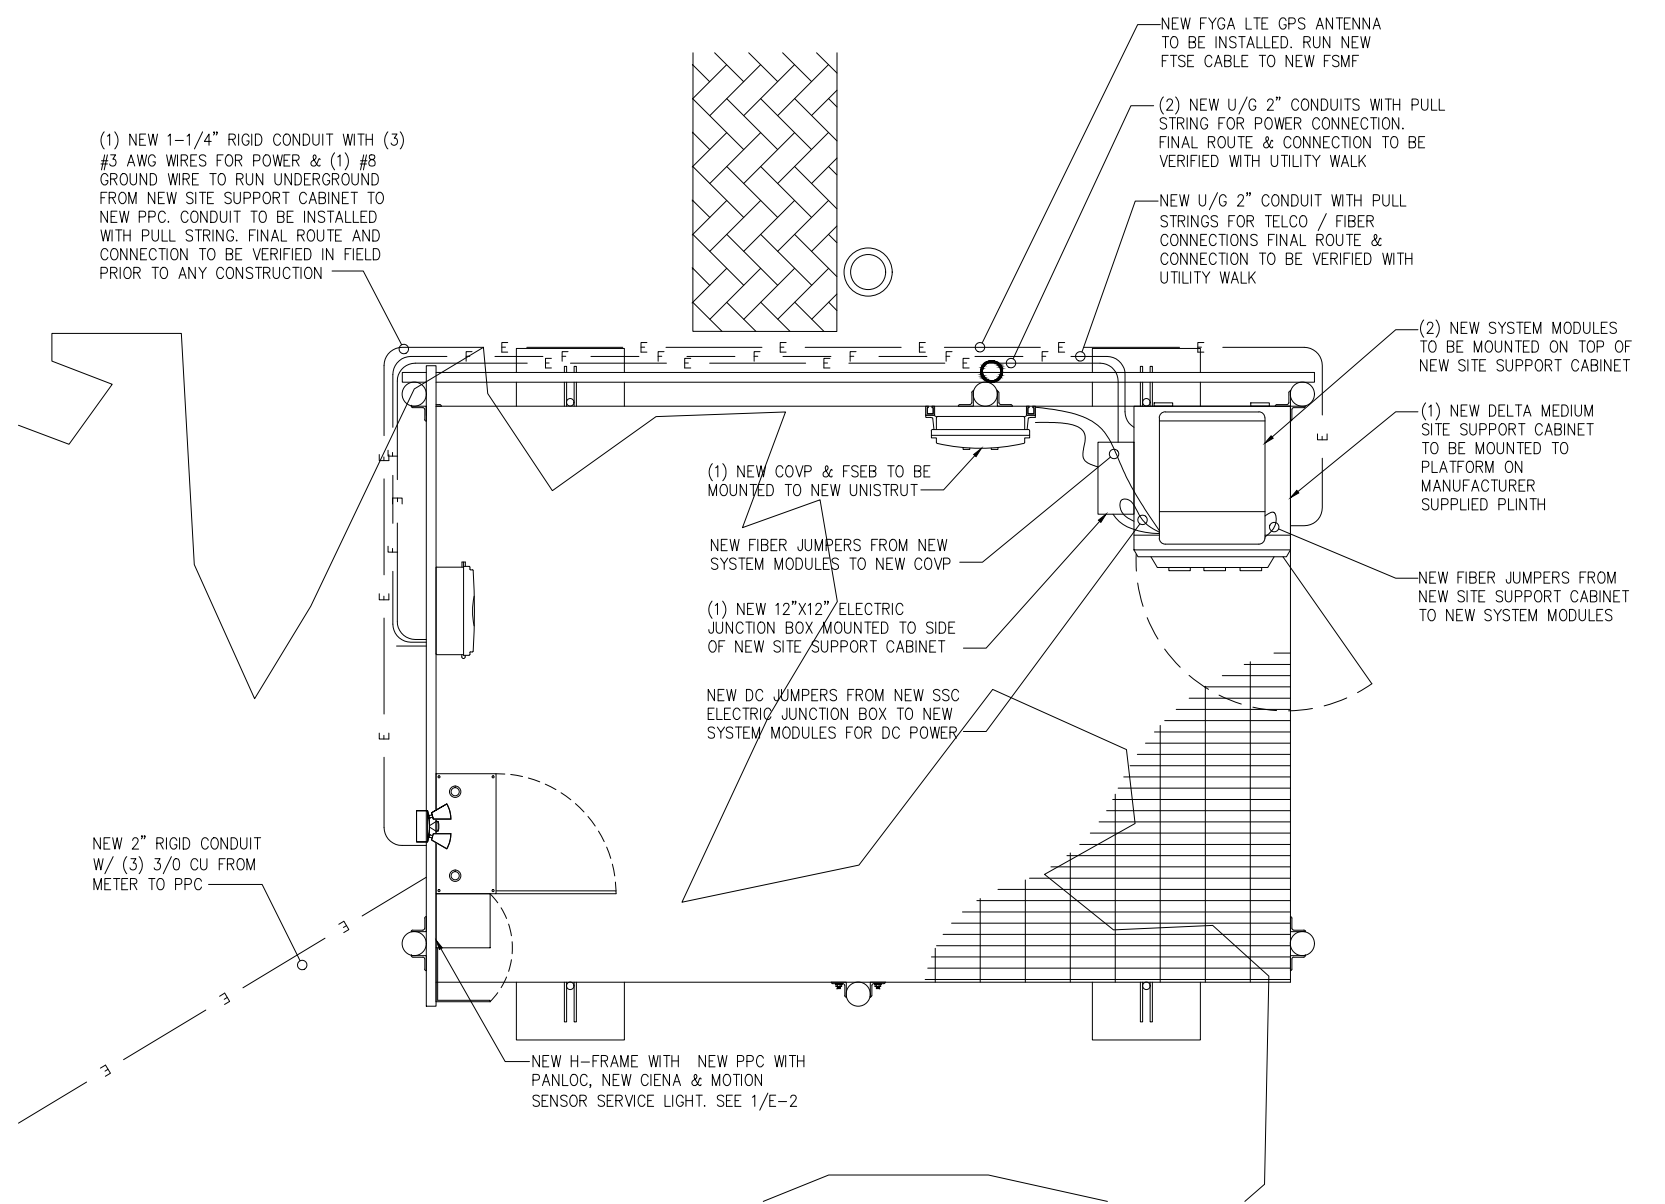


ENLARGED UTILITY PLAN
SCALE: 1"=1'-0"

1

NOTE:
EXISTING UTILITY POLE TO BE UTILIZED FOR NEW POWER CONNECTION. FINAL CONNECTION TO BE VERIFIED WITH UTILITY WALK
EXISTING FIBER MODULE TO BE UTILIZED FOR NEW FIBER CONNECTION. FINAL CONNECTION TO BE VERIFIED WITH UTILITY WALK

NOTE:
CONTRACTOR TO COORDINATE WITH LOCAL UTILITY PROVIDERS TO DETERMINE ROUTE FOR BOTH POWER AND FIBER/TELCO FINAL DESIGN

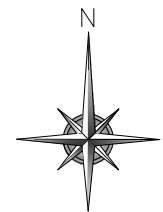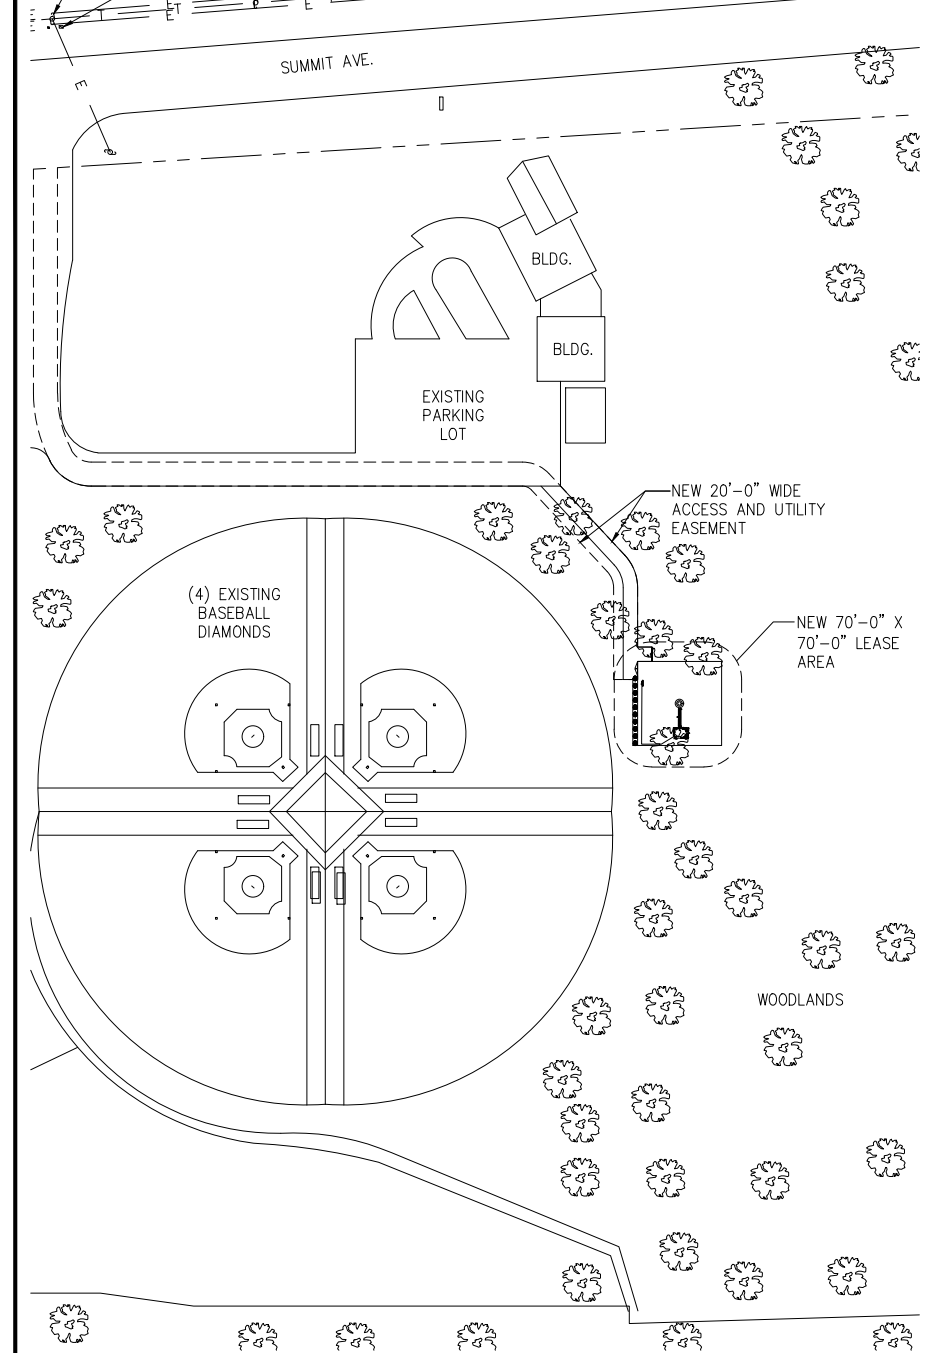

OVERALL UTILITY PLAN
SCALE: 1"=80'-0"

2



PLANS PREPARED BY:
CelluSite, LLC

ENGINEERING LICENSE:

DATE	DESCRIPTION	BY	REV
06/03/15	REVIEW CD	BMW	A
06/04/15	REVIEW CD	BMW	B
07/21/15	REVIEW CD	BMW	C
08/20/15	REVIEW CD	BMW	D

SITE INFORMATION:

ML531081
Christ the Life Evangelical Lutheran Church
WI-Waukesha-Summit
3031 Summit Ave
Waukesha, WI 53188
Waukesha COUNTY


SHEET TITLE:
UTILITY PLANS

SHEET NUMBER:
E-1

PLOT SCALE: 1:1 @ 11"x17"

PLANS PREPARED BY:

CelluSite, LLC

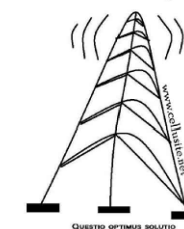

ENGINEERING LICENSE:

DATE	DESCRIPTION	BY	REV
06/03/15	REVIEW CD	BMW	A
06/04/15	REVIEW CD	BMW	B
07/21/15	REVIEW CD	BMW	C
08/20/15	REVIEW CD	BMW	D

SITE INFORMATION:

ML531081
Christ the Life
Evangelical
Lutheran Church
WI-Waukesha-
Summit
3031 Summit Ave
Waukesha, WI 53188
Waukesha COUNTY


SHEET TITLE:

H-FRAME &
UTILITY DETAILS

SHEET NUMBER:

E-2


PLOT SCALE: 1:1 @ 11"x17"

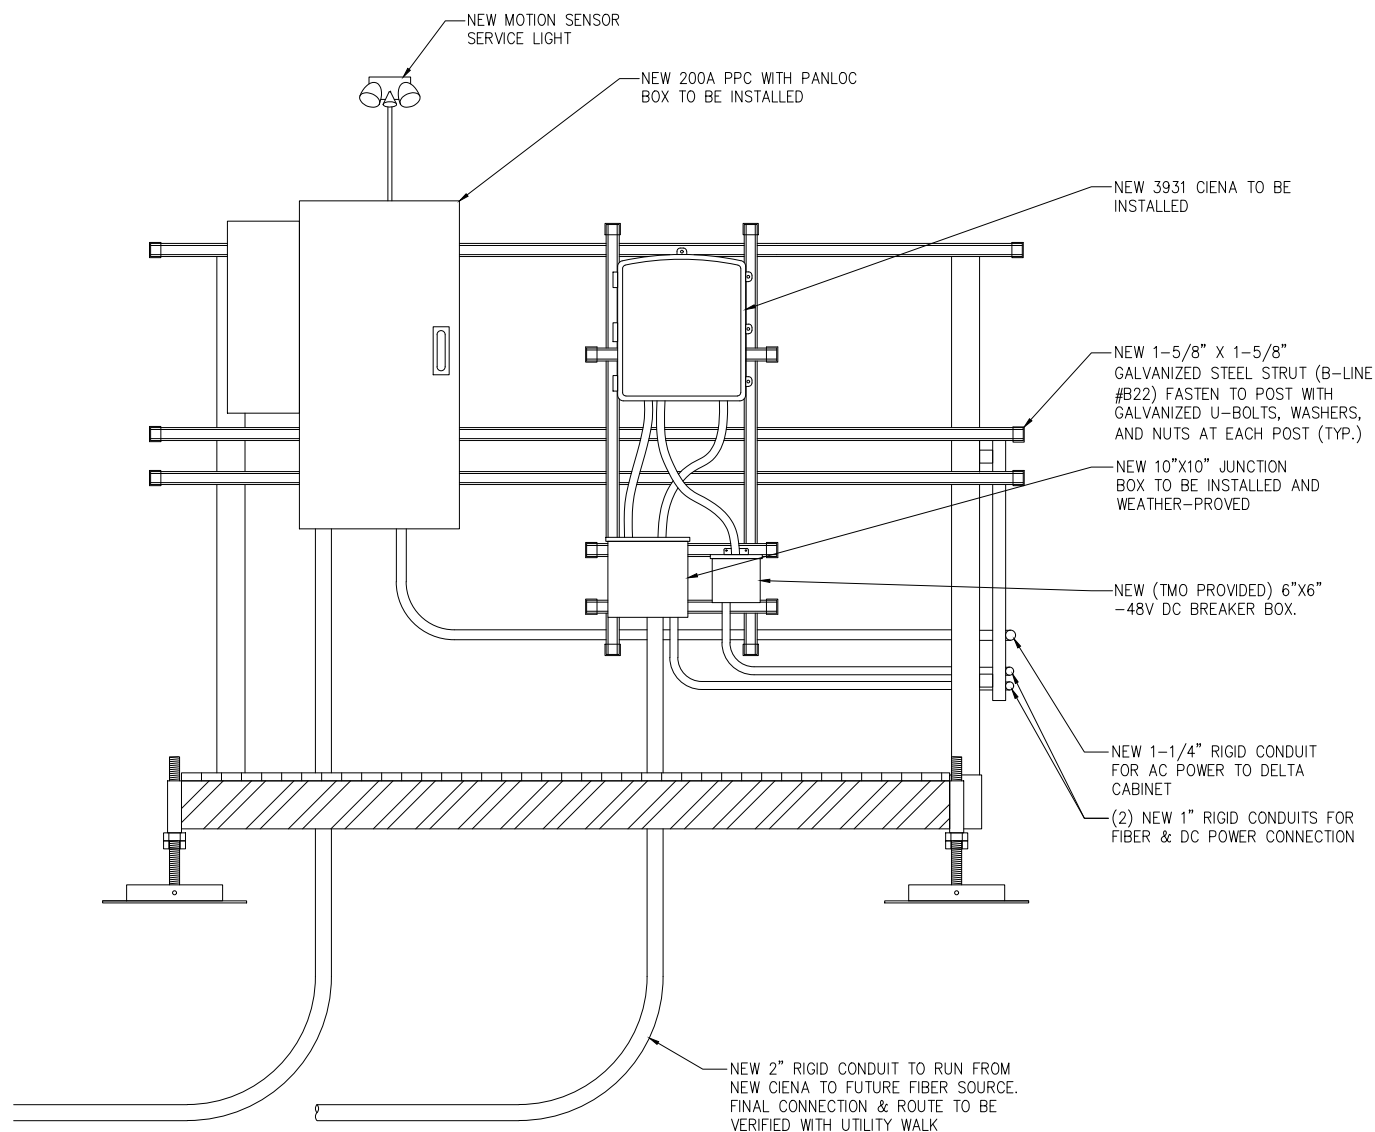

H-FRAME DETAIL

SCALE: NOT TO SCALE

1

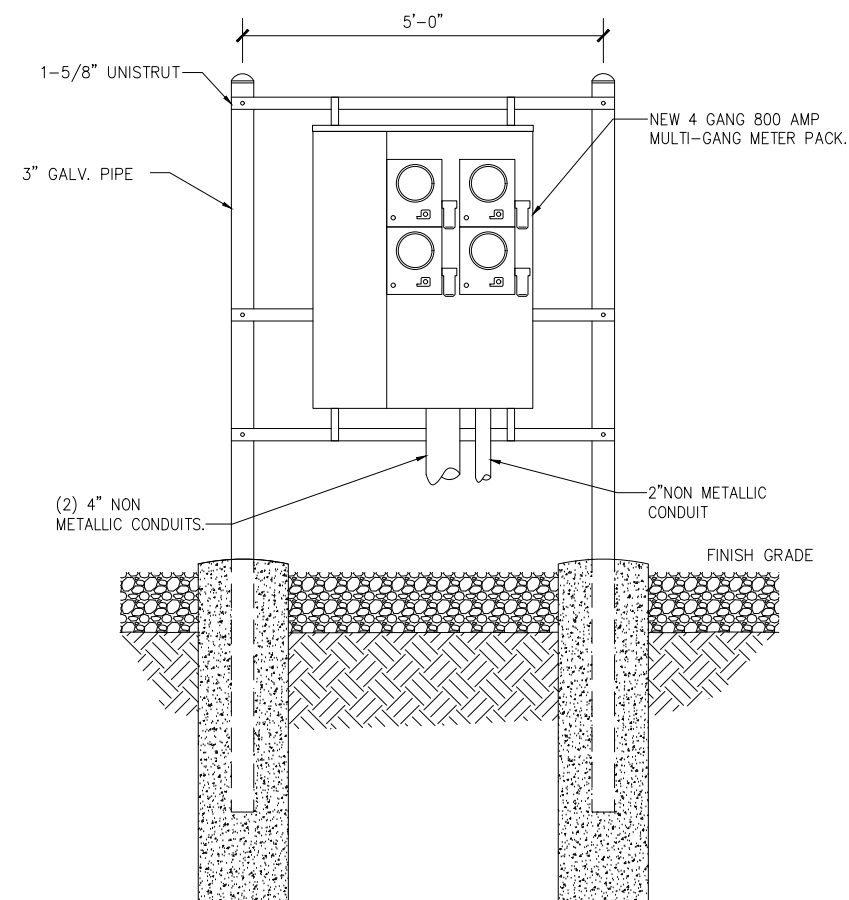


UTILITY H-FRAME DETAIL

SCALE: NOT TO SCALE

3

USE THIS SECTION UNDER PAVEMENT OR VEHICLE TRAFFIC AREA

USE THIS SECTION UNDER GRASS OR LAWN AREA

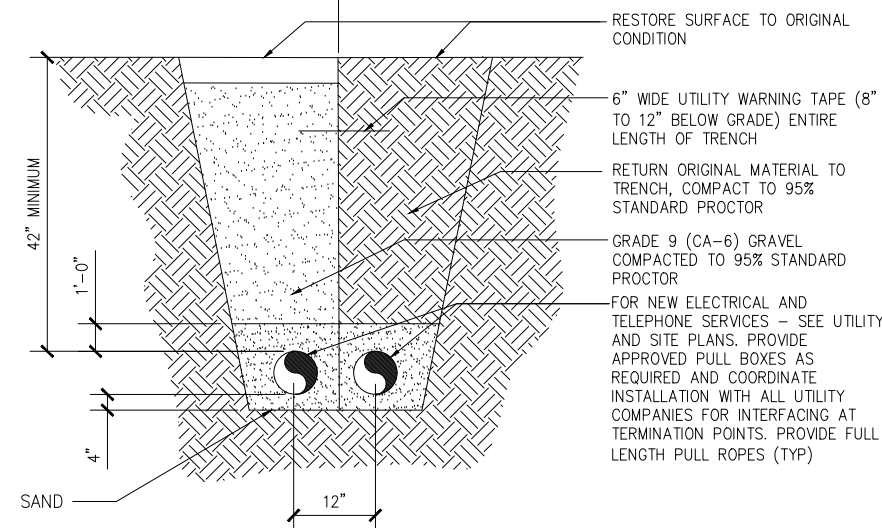


BURIED CONDUIT DETAIL

SCALE: NOT TO SCALE

2

PLANS PREPARED BY:

CelluSite, LLC

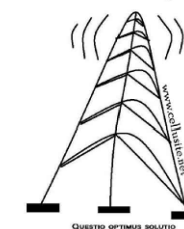

ENGINEERING LICENSE:

T-MOBILE PROJECT NAME:		NSD				MODEL NUMBER:		TBD				WIRE:		3	
VOLTAGE:		240V/120				PHASE:		1				AIC:		22,000	
MAIN BREAKER:		200 AMP				BUS S RATING:		200 AMP S				GROUND BAR:		YES	
MOUNT:		H-FRAME				NEUTRAL BAR:		YES				INTERNAL TVSS:		YES	
ENCLOSURE TYPE:		NEMA 3R				N to GROUND BOND:		YES							
PANEL STATUS:		NEW													

CKT	LOAD DESCRIPTION	BREAKER AMPS	BREAKER POLES	BREAKER STATUS	SERVICE LOAD VA	USAGE FACTOR	PHASE A VA	PHASE B VA	USAGE FACTOR	SERVICE LOAD VA	BREAKER STATUS	BREAKER POLES	BREAKER AMPS	LOAD DESCRIPTION	CKT
1	SITE SUPPORT CABINET	100	2	ON	4200	1.25	5250		0.00	0	N/A	---	---	---	2
3	---	---	---	ON	4200	1.25		5250	0.00	0	N/A	---	---	---	4
5	SERVICE LIGHT	20	1	ON	500	1.00	500		0.00	0	N/A	---	---	---	6
7	---	---	---	N/A	0	0.00		0	0.00	0	N/A	---	---	---	8
9	---	---	---	N/A	0	0.00		0	0.00	0	N/A	---	---	---	10
11	---	---	---	N/A	0	0.00		0	0.00	0	N/A	---	---	---	12
13	---	---	---	N/A	0	0.00		0	0.00	0	N/A	---	---	---	14
15	---	---	---	N/A	0	0.00		0	0.00	0	N/A	---	---	---	16
17	---	---	---	N/A	0	0.00		0	0.00	0	N/A	---	---	---	18
19	---	---	---	N/A	0	0.00		0	0.00	0	N/A	---	---	---	20
21	---	---	---	N/A	0	0.00		0	0.00	0	N/A	---	---	---	22
23	GFCI OUTLET	20	1	ON	180	1.00		180	0.00	0	N/A	---	---	---	24
							5750	5430	VA			TOTAL KVA	11.18		
												AMPS	46.58		

PANEL SCHEDULE
SCALE: NOT TO SCALE


DATE	DESCRIPTION	BY	REV
06/03/15	REVIEW CD	BMW	A
06/04/15	REVIEW CD	BMW	B
07/21/15	REVIEW CD	BMW	C
08/20/15	REVIEW CD	BMW	D

SITE INFORMATION:
ML531081
Christ the Life
Evangelical
Lutheran Church
WI-Waukesha-
Summit
3031 Summit Ave
Waukesha, WI 53188
Waukesha COUNTY


SHEET TITLE:
UTILITY RISER
DIAGRAM & PANEL
SCHEDULE

SHEET NUMBER:
E-3

PLOT SCALE: 1:1 @ 11"x17"

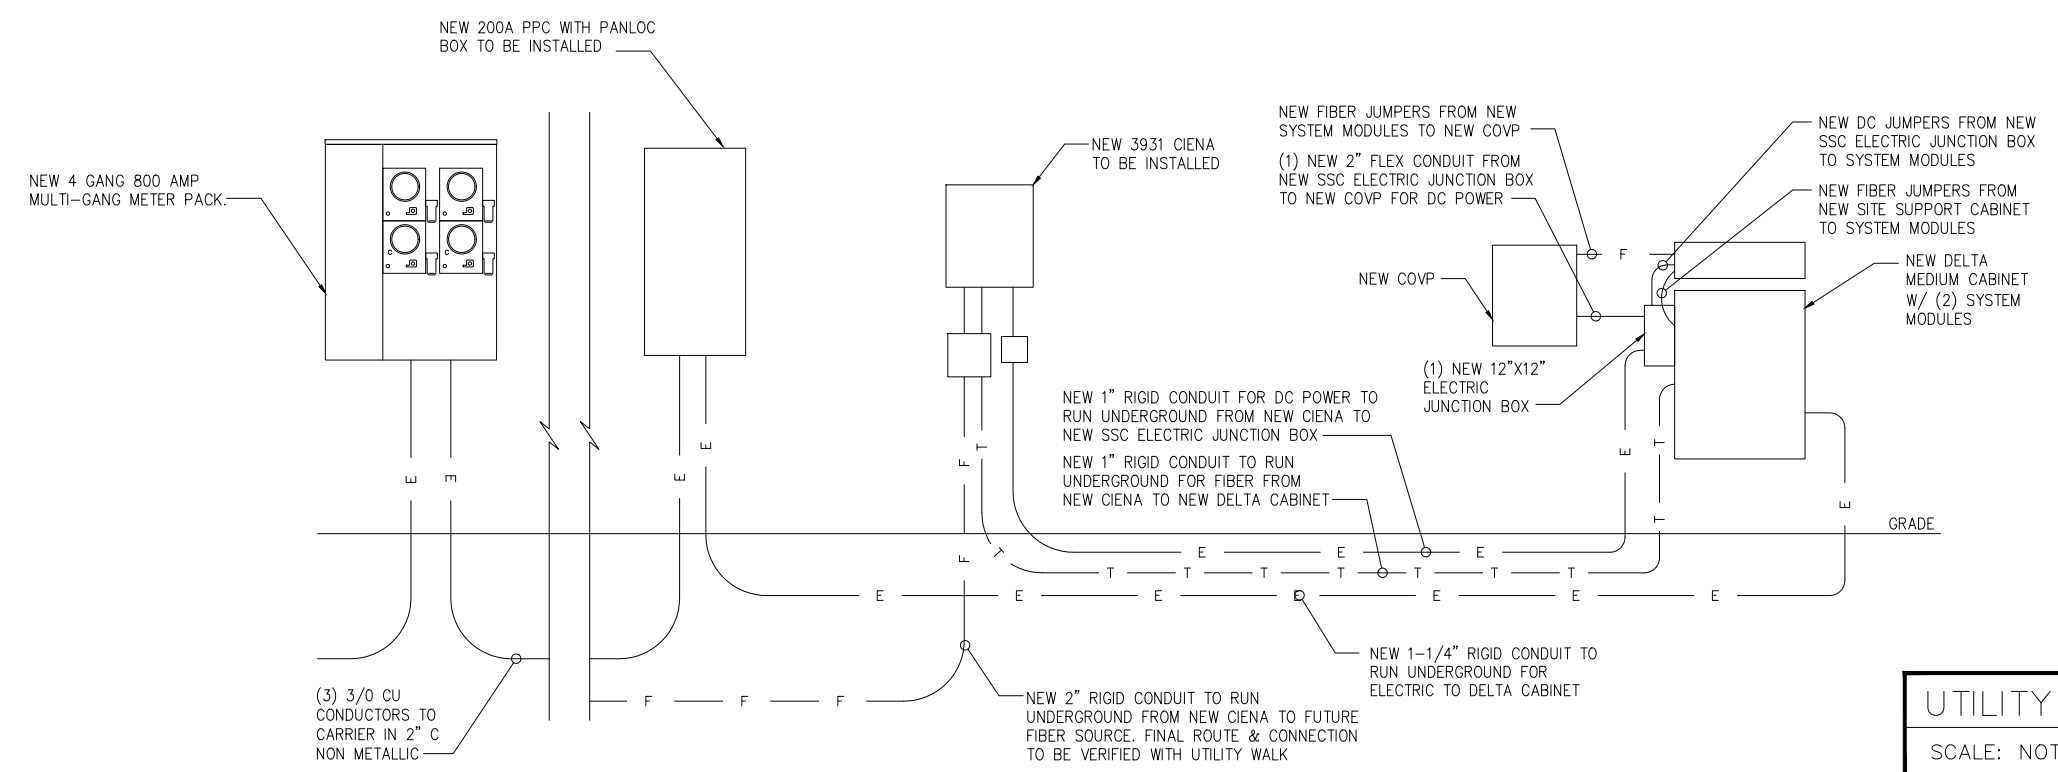

UTILITY RISER DIAGRAM
SCALE: NOT TO SCALE

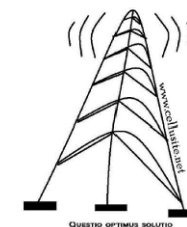

DATE	DESCRIPTION	BY	REV
06/03/15	REVIEW CD	BMW	A
06/04/15	REVIEW CD	BMW	B
07/21/15	REVIEW CD	BMW	C
08/20/15	REVIEW CD	BMW	D


SITE INFORMATION:
ML531081
Christ the Life
Evangelical
Lutheran Church
WI-Waukesha-
Summit
3031 Summit Ave
Waukesha, WI 53188
Waukesha COUNTY

SHEET TITLE:
GROUNDING
PLAN


SHEET NUMBER:
GR-1

LEGEND

■	CADWELD
□	MECHANICAL CONNECTION
▲	COMPRESSION FITTING

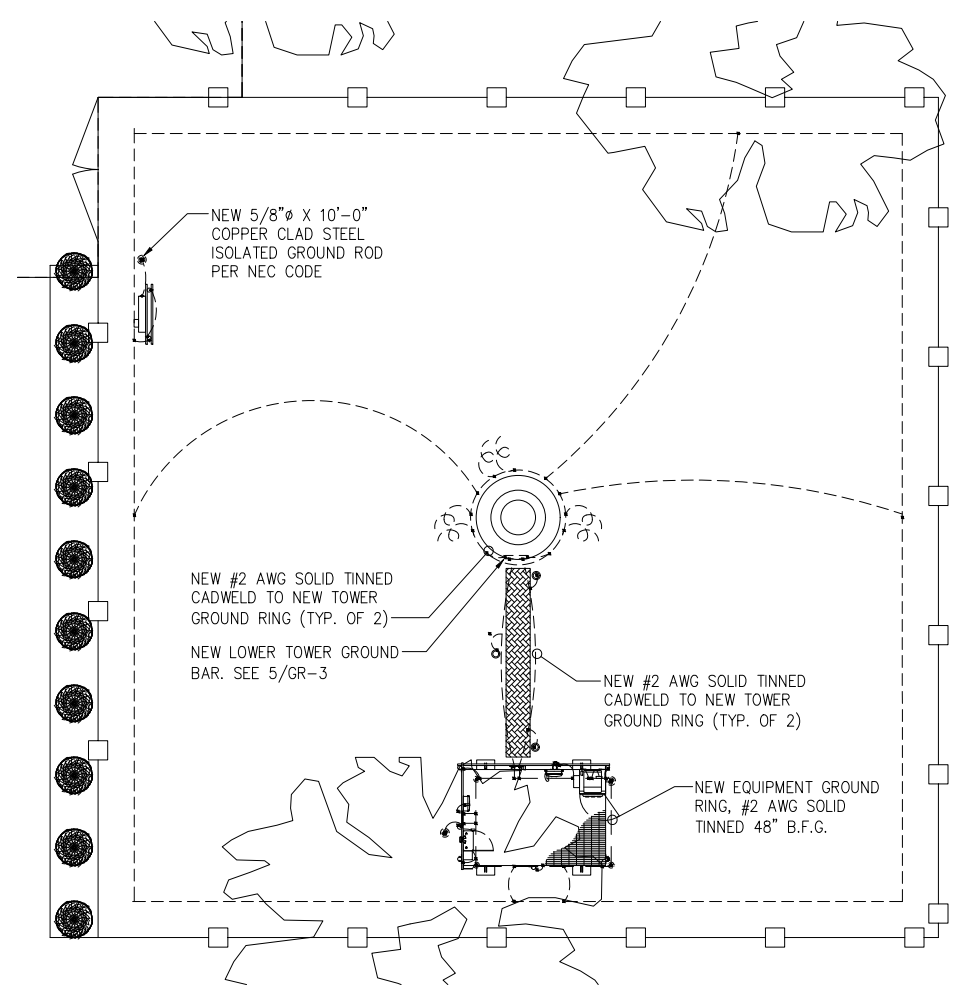

OVERALL GROUNDING PLAN
SCALE: 1/8"=1'-0" 2

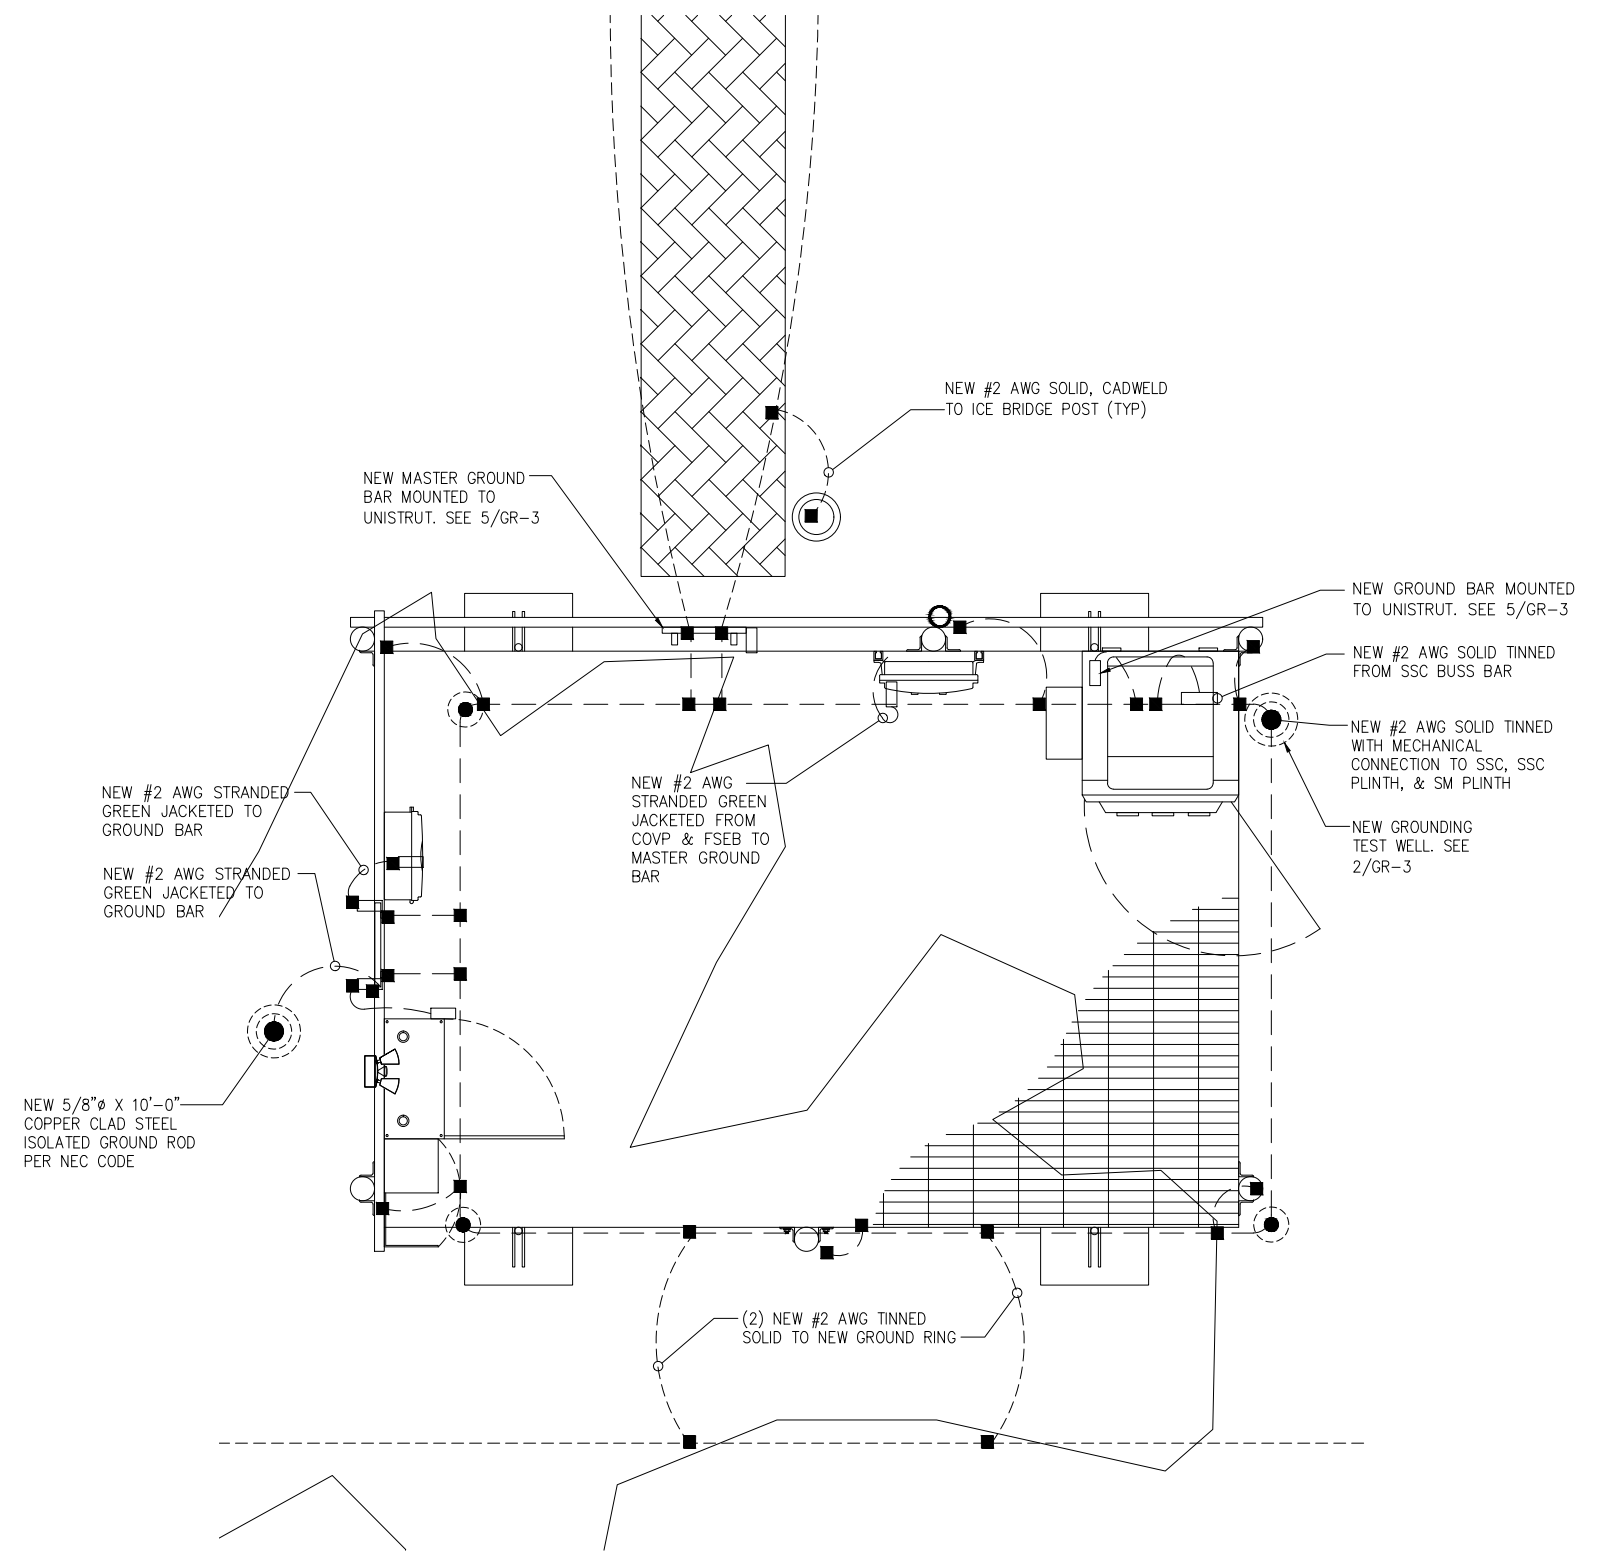


ENLARGED GROUNDING PLAN
SCALE: 3/4"=1'-0" 1

NOTES:

1. ALL ELECTRICAL WORK SHALL CONFORM TO THE NATIONAL ELECTRICAL CODE (EDITION ADOPTED BY LOCAL JURISDICTION) AND APPLICABLE LOCAL CODES.
2. GROUNDING SHALL COMPLY WITH ARTICLE 250 OF THE NATIONAL ELECTRICAL CODE.
3. ALL ELECTRICAL ITEMS SHALL BE U.L. APPROVED OR LISTED.
4. WIRES AND CABLES FOR POWER AND LIGHTING SHALL BE COPPER WITH TYPE XHHW, THWN, OR THHN INSULATION. SOLID CONDUCTORS FOR #10 AWG AND SMALLER, STRANDED FOR LARGER THAN #10 AWG. MINIMUM SIZE #12 AWG.
5. WIRES AND CABLES FOR POWER SHALL BE INSTALLED IN GALVANIZED RIGID STEEL CONDUIT OR FLEXIBLE LIQUID TIGHT CONDUIT AS INDICATED ON DRAWING.
6. CONTRACTOR TO OBTAIN ALL PERMITS, PAY PERMIT FEES, AND BE RESPONSIBLE FOR SCHEDULING INSPECTIONS.
7. COORDINATE WITH UTILITY COMPANIES SERVICE ENTRANCE REQUIREMENTS.
8. PROVIDE ALL LABOR AND MATERIAL DESCRIBED ON THIS DRAWING, AND ALL ITEMS INCIDENTAL TO COMPLETING AND PRESENTING THIS PROJECT AS FULLY OPERATIONAL.
9. GROUNDING CONNECTIONS SHALL BE EXOTHERMIC TYPE ("CADWELD") TO ANTENNA MASTS, AND THE GROUND BARS. REMAINING GROUNDING CONNECTIONS SHALL BE COMPRESSION FITTINGS.
10. GROUND COAXIAL CABLE SHIELDS AT BOTH ENDS WITH COAX CABLE GROUNDING KITS & INSTALL WEATHER PROOFING KIT AT EACH CONNECTION.
11. ROUTE GROUNDING CONDUCTORS ALONG THE SHORTEST AND STRAIGHTEST PATH POSSIBLE, EXCEPT AS OTHERWISE INDICATED. GROUNDING LEADS SHOULD NEVER BE BENT AT RIGHT ANGLE, ALWAYS MAKE AT LEAST 12" RADIUS BENDS. #6 WIRE CAN BE BENT AT 6" RADIUS WHEN NECESSARY.
12. CONTRACTOR TO PROVIDE GROUND RING AS SHOWN ON GROUNDING SITE PLAN AND GROUNDING RISER DIAGRAM. CONTRACTOR SHALL TEST AND VERIFY THAT THE IMPEDANCE DOES NOT EXCEED 5 OHMS TO GROUND BY MEANS OF A BIDDLE-MEGGER TESTER. GROUNDING AND OTHER OPERATIONAL TESTING SHALL BE WITNESSED BY THE OWNER'S REPRESENTATIVE.
13. CONTRACTOR TO PROVIDE TELEPHONE CONDUIT AS SHOWN ON PLANS.
14. CONTRACTOR TO PROVIDE ELECTRIC CONDUIT AS SHOWN ON PLANS.
15. NOTIFY LOCAL UTILITY SERVICE PRIOR TO ANY INSTALLATION.
16. ALL EQUIPMENT FURNISHED BY OTHERS SHALL BE PROVIDED WITH PROPER MOTOR STARTERS, DISCONNECTS, CONTROLS, ETC. BY THE ELECTRICAL CONTRACTOR UNLESS SPECIFICALLY NOTED OTHERWISE. THE ELECTRICAL CONTRACTOR SHALL INSTALL AND COMPLETELY WIRE ALL ASSOCIATED EQUIPMENT IN ACCORDANCE WITH MANUFACTURER'S WIRE DIAGRAMS AND AS REQUIRED FOR A COMPLETE OPERATING INSTALLATION. ELECTRICAL CONTRACTOR SHALL VERIFY AND COORDINATE ELECTRICAL CHARACTERISTICS AND REQUIREMENTS OF EQUIPMENT PRIOR TO ROUGH-IN OF CONDUIT AND WIRING TO AVOID CONFLICTS WHERE APPLICABLE.
17. GROUNDING CONDUCTORS SHALL BE COPPER OR SOLID TINNED COPPER. ALL CONNECTIONS MADE BELOW GRADE SHALL BE SOLID TINNED COPPER. ALL CONNECTIONS ABOVE GRADE STRANDED IS PERMITTED.
18. ALL CADWELDS ABOVE FINISHED GRADE SHALL BE PAINTED WITH CO-GALVANIZED ZINC ENRICHED PAINT TO MATCH COLOR OBJECT BONDED TO.
19. CONNECT COAX GROUND KITS TO MASTER GROUND BAR AT BASE OF TOWER.
20. CONNECT COAX GROUND KITS TO GROUND BUS AT TOP OF TOWER.
21. CONNECT LNA GROUND TO GROUND BUS AT TOP OF TOWER.
22. ALL GROUNDING CONNECTIONS TO BE MADE USING EXOTHERMIC WELD PROCESS UNLESS OTHERWISE APPROVED BY DESIGNER.
23. ELECTRICAL CONTRACTOR TO PULL BONDING JUMPER @ PURCELL ONLY IF DISCONNECT GROUND IS TIED TO GROUND FIELD INSTEAD OF SEPARATE GROUND ROD.
24. PLAN DRAWINGS SHOWN HEREIN DO NOT NECESSARILY DEPICT ELECTRICAL REQUIREMENTS OF INDIVIDUAL EQUIPMENT AND DEVICES SUCH AS THE EQUIPMENT GROUNDING REQUIREMENTS, POWER REQUIREMENTS AND TELCO RACEWAY REQUIREMENTS.
25. PLAN DRAWINGS SHOWN HEREIN ARE DIAGRAMMATIC AND DO NOT NECESSARILY DEPICT THE EXACT EQUIPMENT QUANTITIES, LOCATION, LAYOUT AND CONFIGURATION. REFER TO ARCHITECTURAL PLANS FOR EXACT EQUIPMENT LOCATION, LAYOUT AND CONFIGURATION.
26. REFER TO ARCHITECTURAL PLANS FOR THE LOCATION OF POWER AND TELCO POINT OF CONNECTIONS, THE DISTANCE OF THE RUN, AND THE SUGGESTED CONDUIT ROUTING. FIELD VERIFY EXISTING CONDITIONS SPECIFICALLY FOR CONDUIT ROUTING PRIOR TO BID.
27. NUMBER OF ANTENNAS REPRESENTED IN THIS DETAIL ARE FOR SHOWING CLARITY OF GROUND SYSTEM REQUIREMENTS ONLY. SEE RF INFO FOR ANTENNA QUANTITY.
28. CONTRACTOR TO 'NOALOX' ALL CONNECTIONS TO GROUND BARS.
29. ALL GROUND WIRES ENTERING GROUND SHALL HAVE PVC SLEEVE.

TYPICAL ANTENNA SECTOR

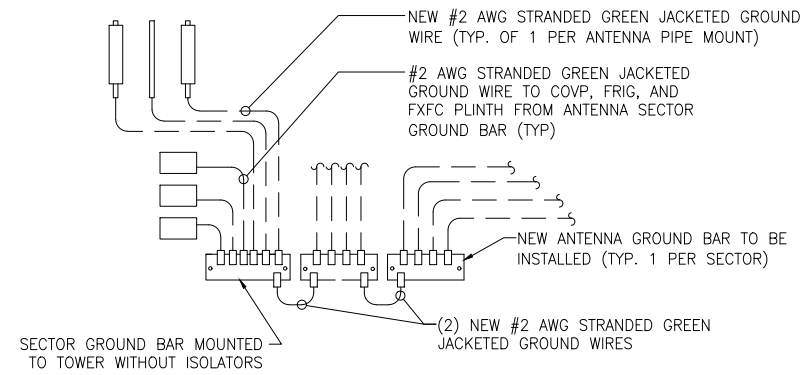


LEGEND

- — — GROUNDING WIRE
- EXOTHERMIC CONNECTION (CADWELD)
- MECHANICAL CONNECTION/DOUBLE HOLE LUG TYPE CONNECTION
- ⚡ BOND TO TOWER




PLANS PREPARED BY:

CelluSite, LLC

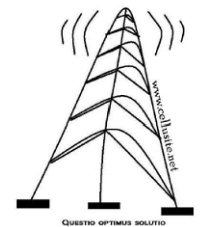

ENGINEERING LICENSE:

DATE	DESCRIPTION	BY	REV
06/03/15	REVIEW CD	BMW	A
06/04/15	REVIEW CD	BMW	B
07/21/15	REVIEW CD	BMW	C
08/20/15	REVIEW CD	BMW	D

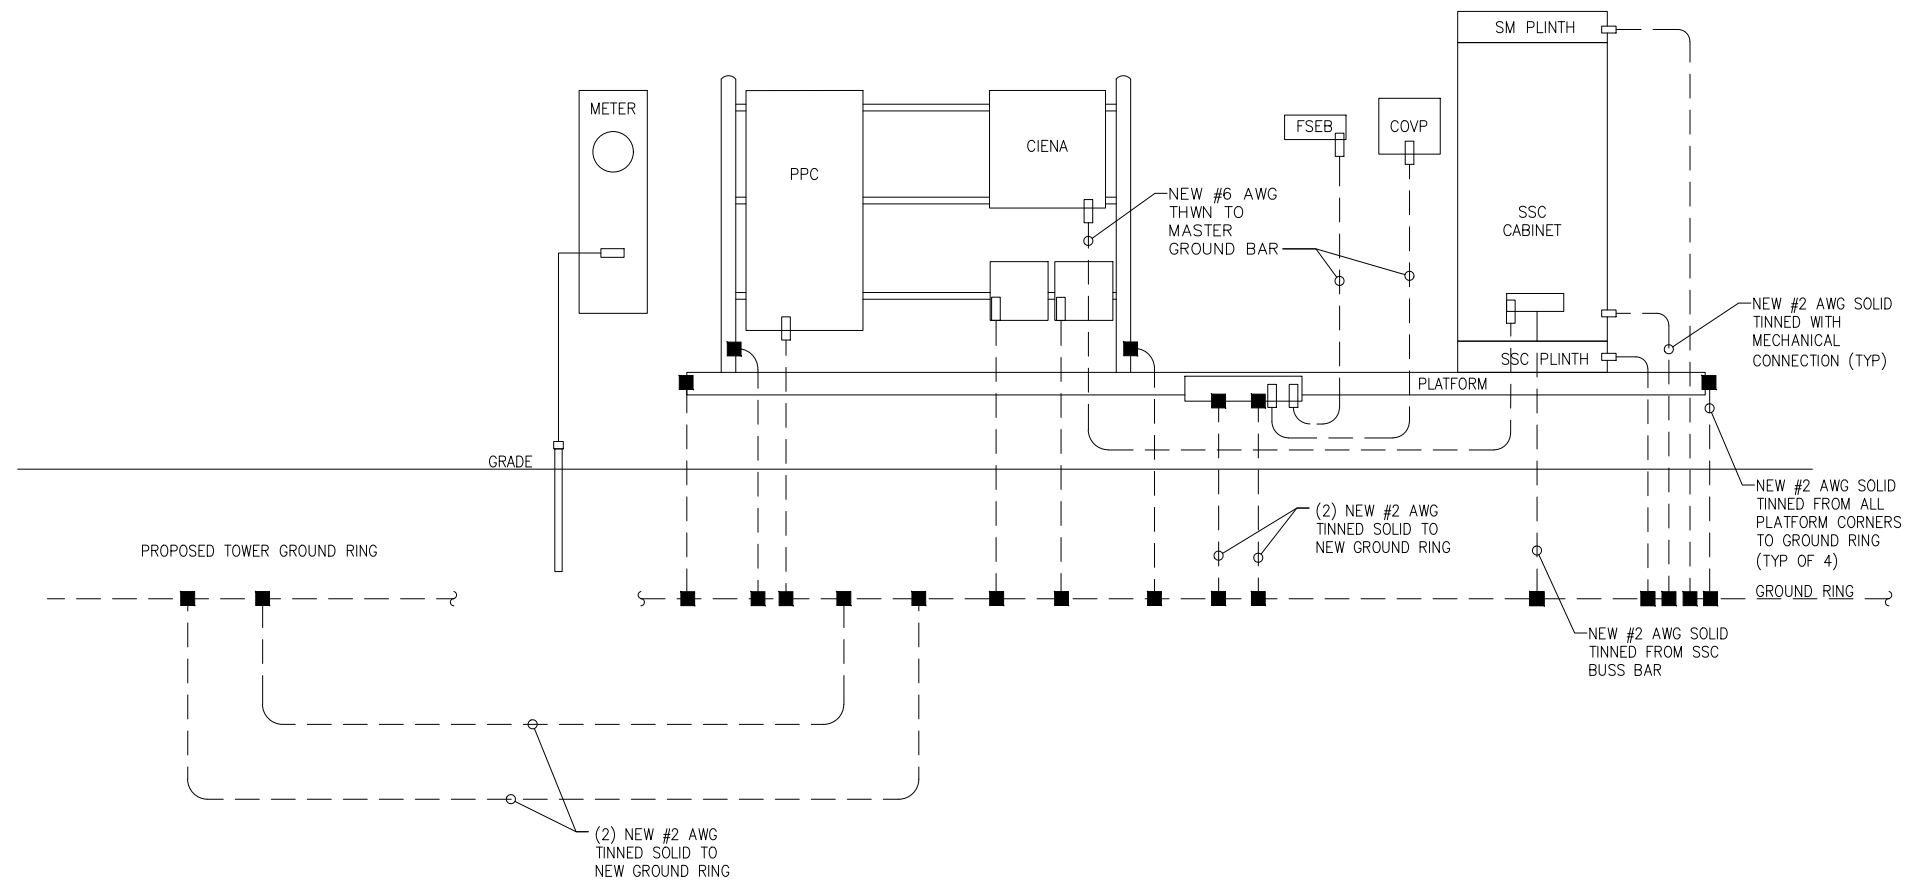

GROUNDING RISER
SCALE: NONE

1

SITE INFORMATION:

ML531081
Christ the Life
Evangelical
Lutheran Church
WI-Waukesha-
Summit
3031 Summit Ave
Waukesha, WI 53188
Waukesha COUNTY


SHEET TITLE:

GROUNDING
RISER

SHEET NUMBER:

GR-2

PLOT SCALE: 1:1 @ 11"x17"

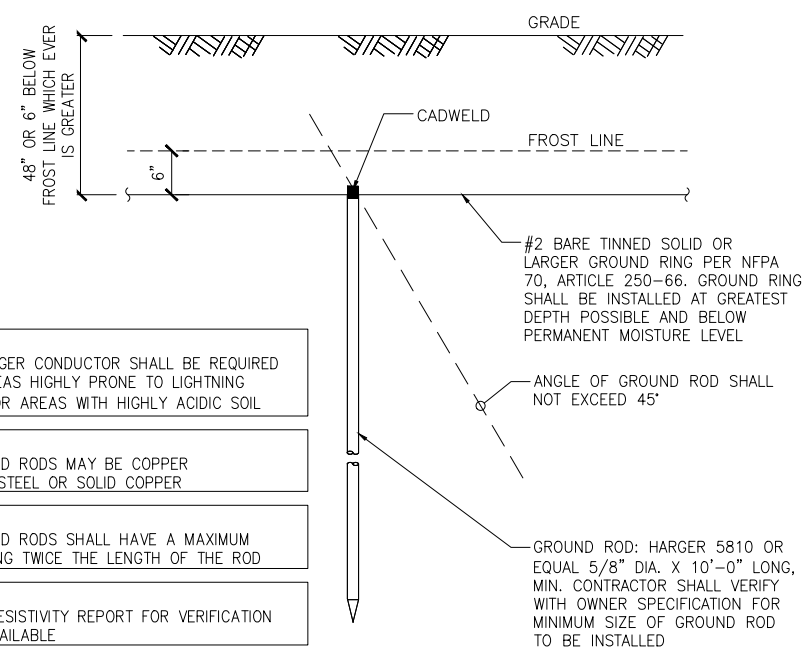


- NOTE: A LARGER CONDUCTOR SHALL BE REQUIRED IN AREAS HIGHLY PRONE TO LIGHTNING AND/OR AREAS WITH HIGHLY ACIDIC SOIL
- NOTE: GROUND RODS MAY BE COPPER CLAD STEEL OR SOLID COPPER
- NOTE: GROUND RODS SHALL HAVE A MAXIMUM SPACING TWICE THE LENGTH OF THE ROD
- NOTE: SEE RESISTIVITY REPORT FOR VERIFICATION AS AVAILABLE
- NOTE: GROUND RODS INSTALLED WITHIN CLOSE PROXIMITY TO TOWER OR WHEN SOIL IS AT OR BELOW 2,000 OHM-CM, SHALL BE GALVANIZED TO PREVENT GALVANIC CORROSION OF TOWER, (SEE ANSI/TIA-EIA-222)

GROUND ROD DETAIL

SCALE: NOT TO SCALE


1

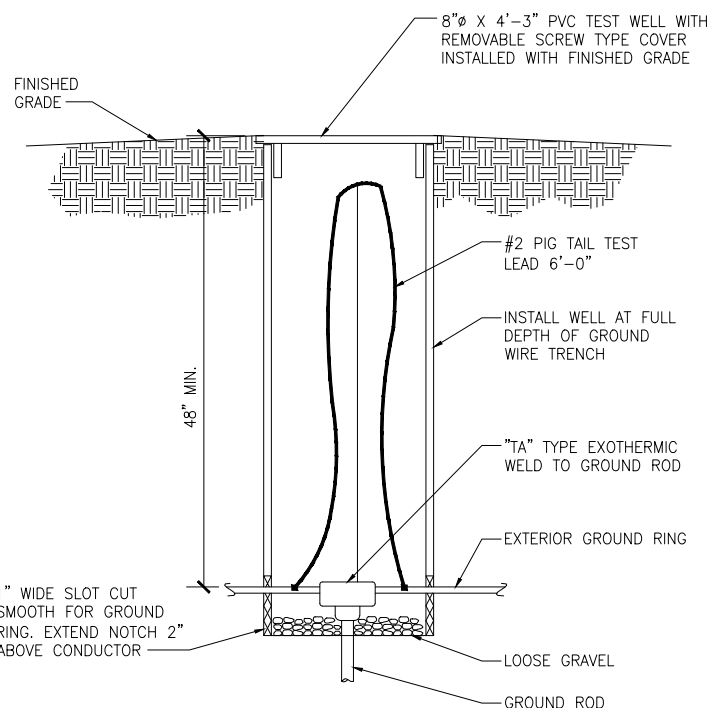

TEST WELL DETAIL

SCALE: NOT TO SCALE

2

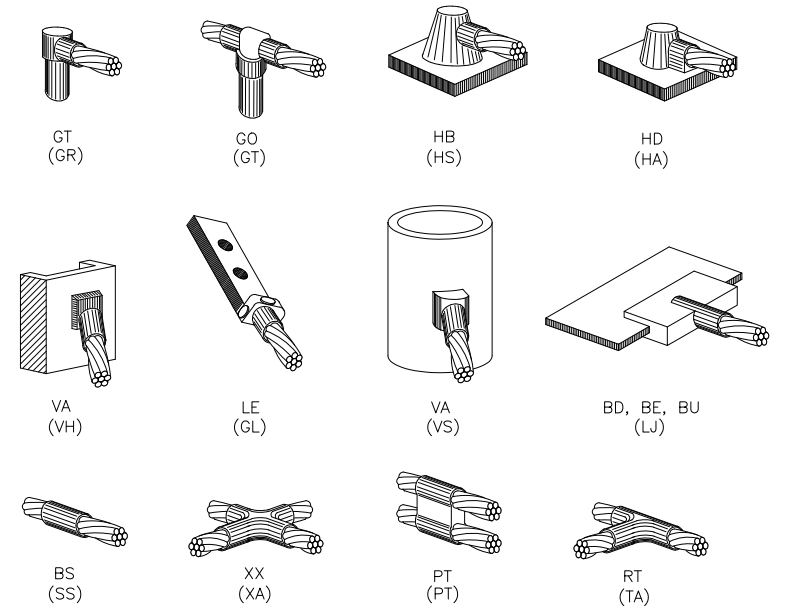


NOTE: THE FOLLOWING SYMBOLS SHOWN ARE HARGER ULTRAWELD EXOTHERMIC CONNECTIONS WITH PART NUMBERS BELOW. THESE CONNECTIONS MAY BE CROSS-REFERENCED WITH CADWELD CONNECTIONS WHICH ARE SHOWN.

EXOTHERMIC WELD TYPES

SCALE: NOT TO SCALE

3

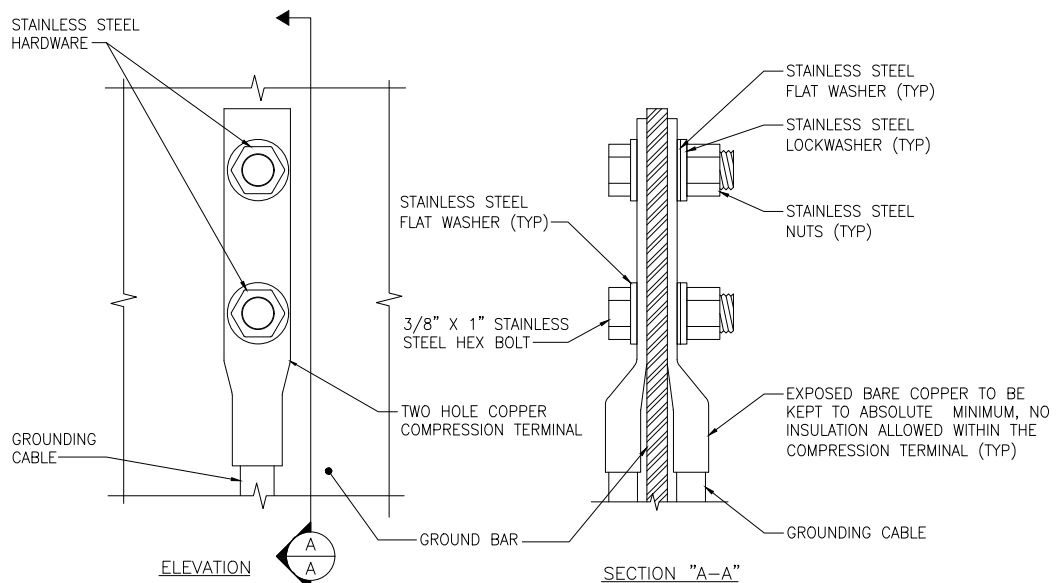


- OXIDE INHIBITING COMPOUND TO BE USED AT ALL LOCATIONS
- NO CRIMPING OF SOLID #2. USE CADWELD ONLY

GROUND BAR CONNECTION DETAIL

SCALE: NOT TO SCALE

4

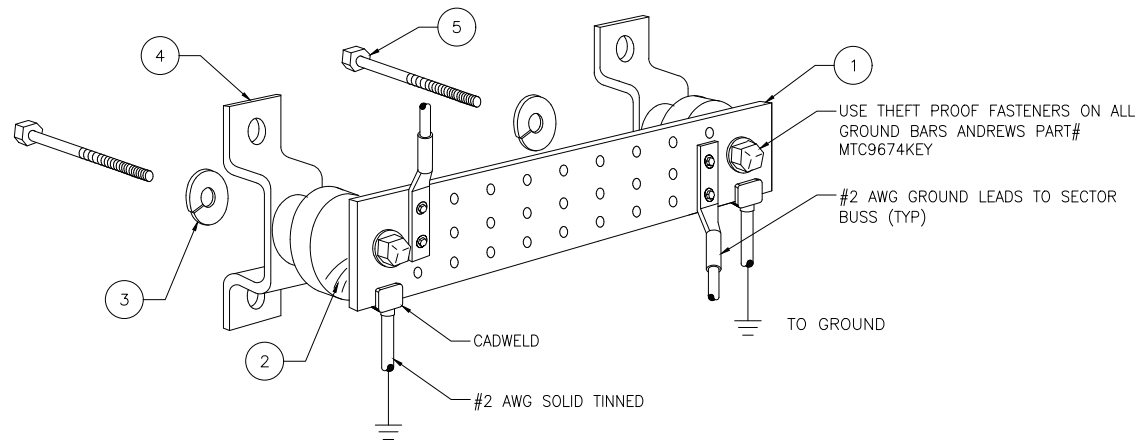

KEY NOTES

- 1/4" THK ELECTRICAL TINNED GROUND BAR HARGER OR APPROVED EQUAL HOLE CENTERS TO MATCH NEMA DOUBLE LUG CONFIGURATION
- INSULATORS
- 3/8" STAINLESS STEEL LOCKWASHERS
- WALL MOUNTING BRACKET
- 3/8" STAINLESS STEEL BNLF BOLTS

- NOTE: HARDWARE SHALL BE STAINLESS STEEL
- NOTE: CONTRACTOR SHALL GROUP INCOMING WIRES
- NOTE: CONTRACTOR TO APPLY 'KOPR-SHIELD' TO ALL CONNECTIONS


GROUND BAR DETAIL

SCALE: NOT TO SCALE

5



PLANS PREPARED BY:
CelluSite, LLC

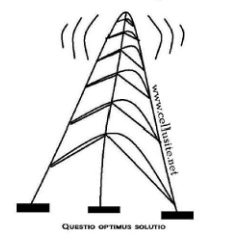

ENGINEERING LICENSE:

DATE	DESCRIPTION	BY	REV
06/03/15	REVIEW CD	BMW	A
06/04/15	REVIEW CD	BMW	B
07/21/15	REVIEW CD	BMW	C
08/20/15	REVIEW CD	BMW	D

SITE INFORMATION:
ML531081
Christ the Life
Evangelical
Lutheran Church
WI-Waukesha-
Summit
3031 Summit Ave
Waukesha, WI 53188
Waukesha COUNTY

SHEET TITLE:

GROUNDING
DETAILS

SHEET NUMBER:

GR-3

PLOT SCALE: 1:1 @ 11"x17"