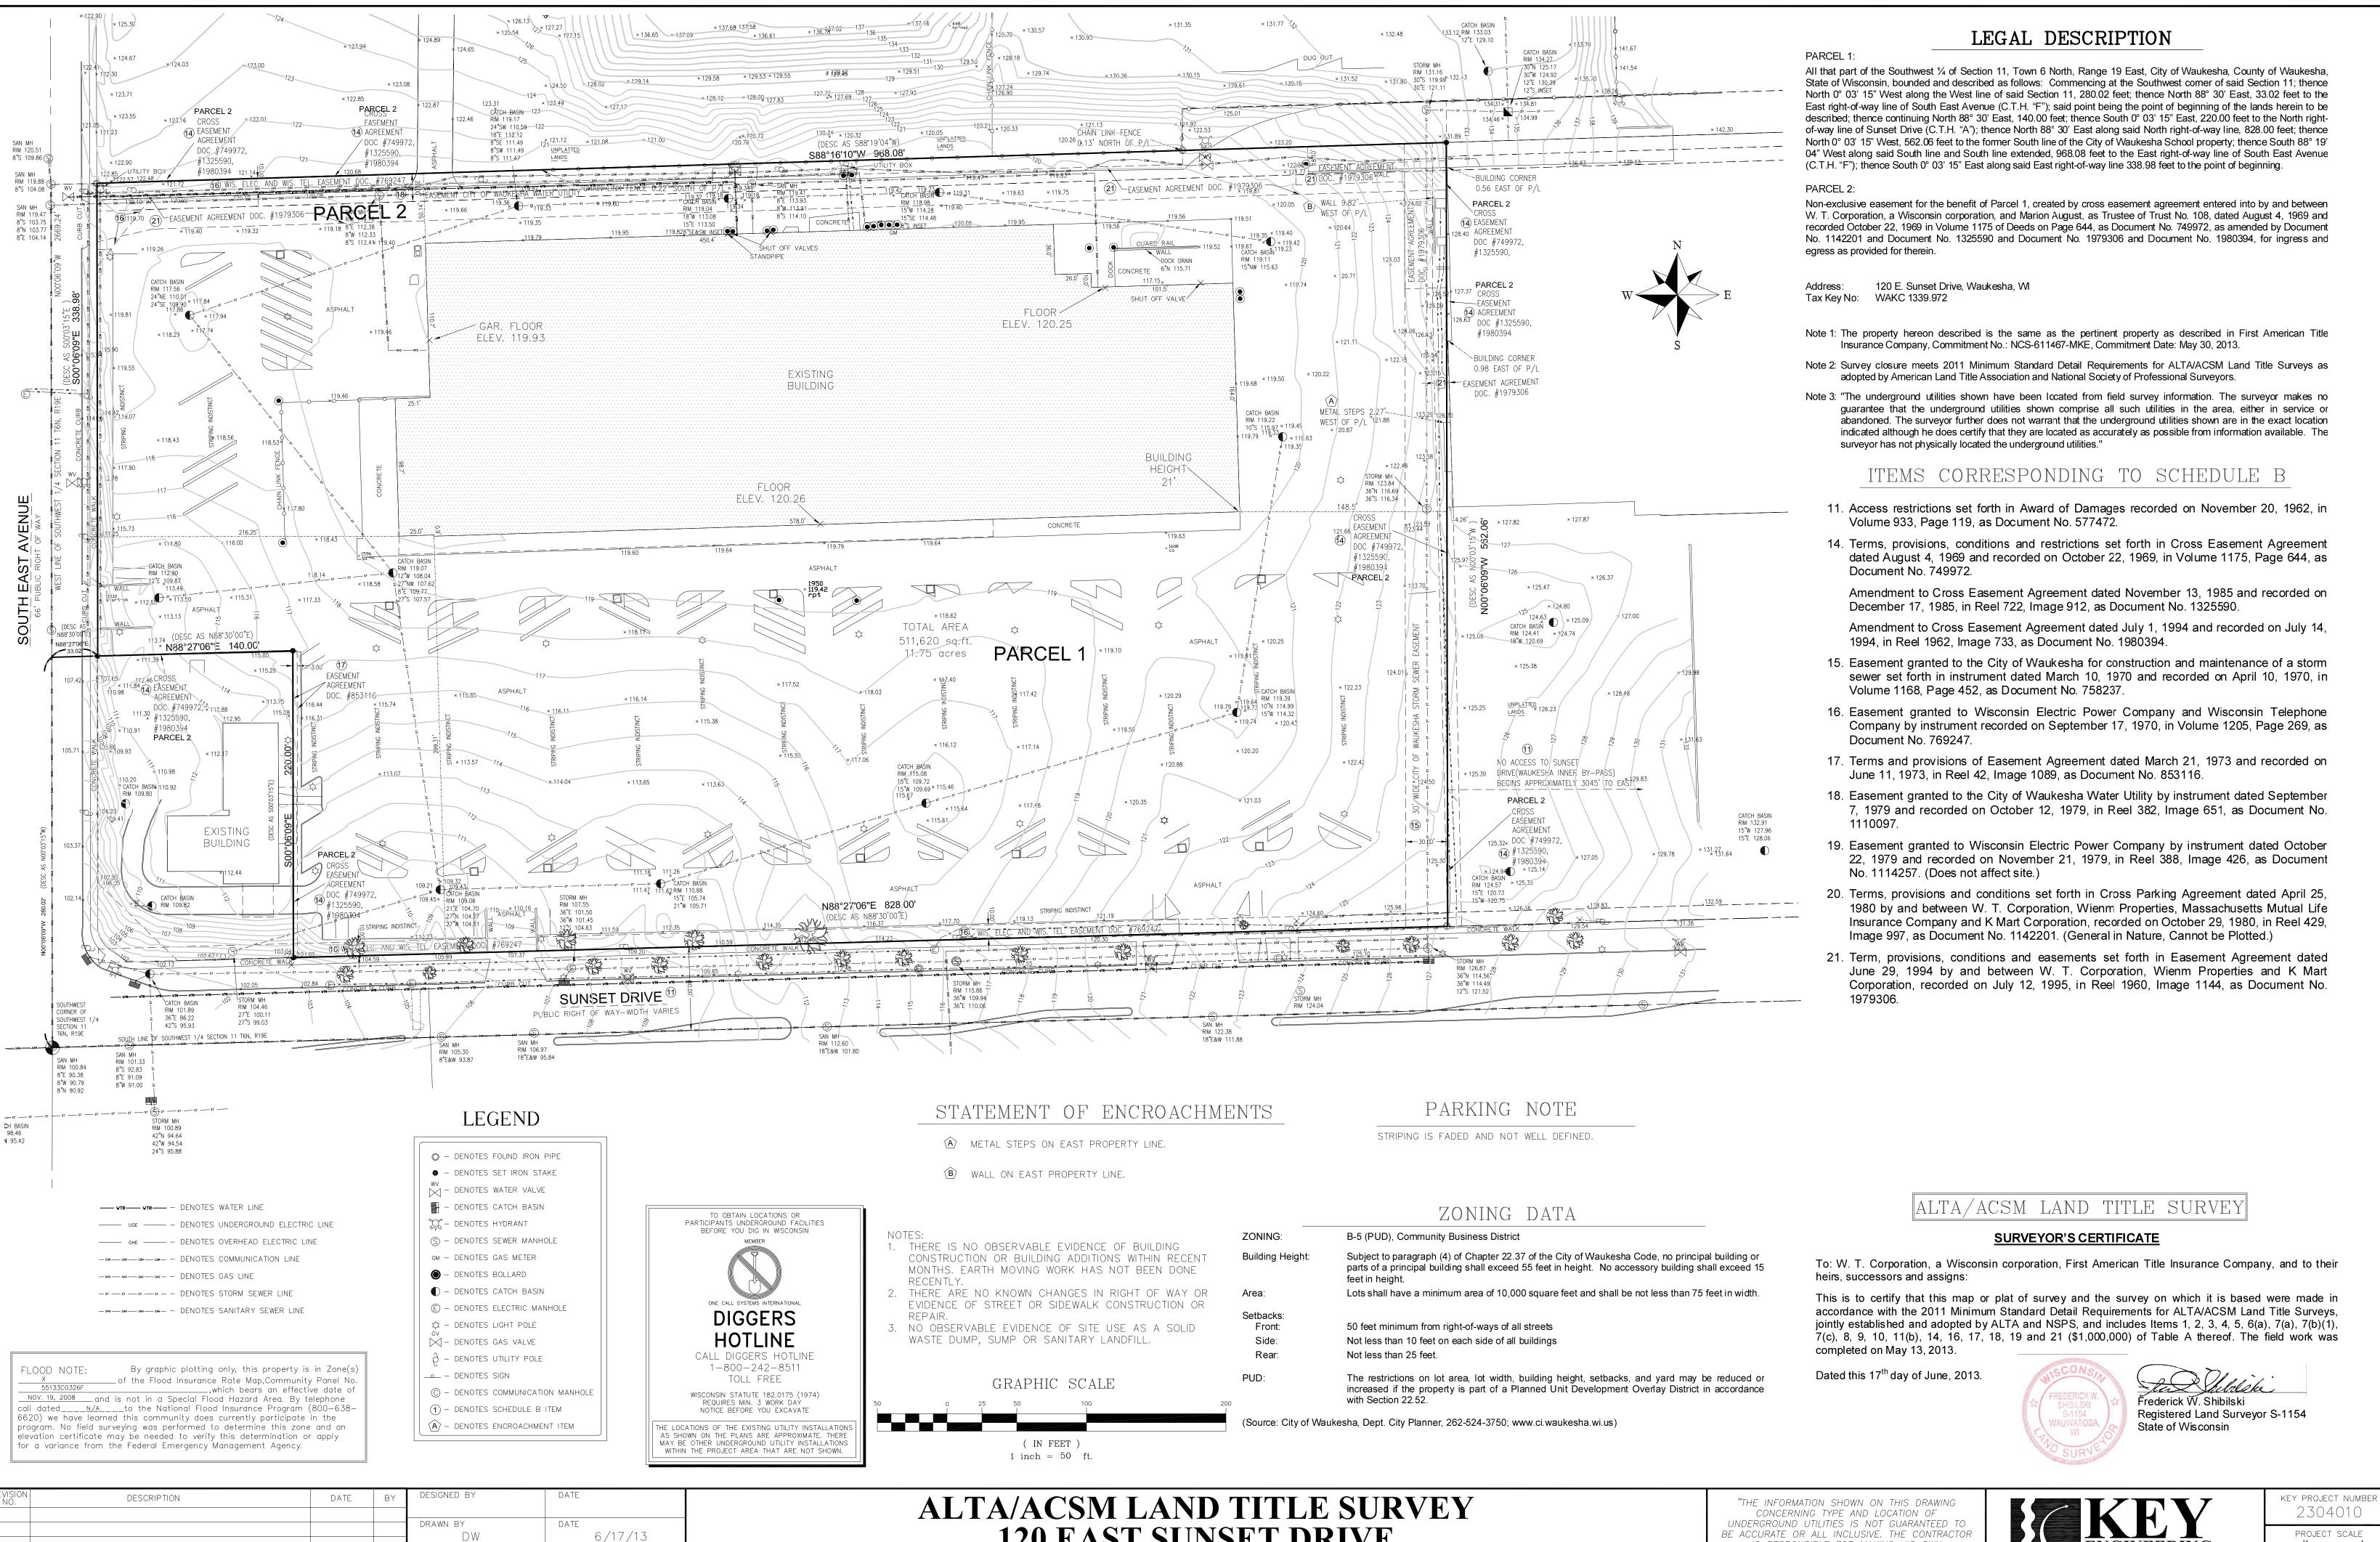




Sto ARCHITECTURE, LLC

4417 N. MURRAY AVENUE

SHOREWOOD, WI 53211



120 EAST SUNSET DRIVE VACANT COMMERCIAL BUILDING WAUKESHA, WI

APPROVED BY

CADFILE

XREF

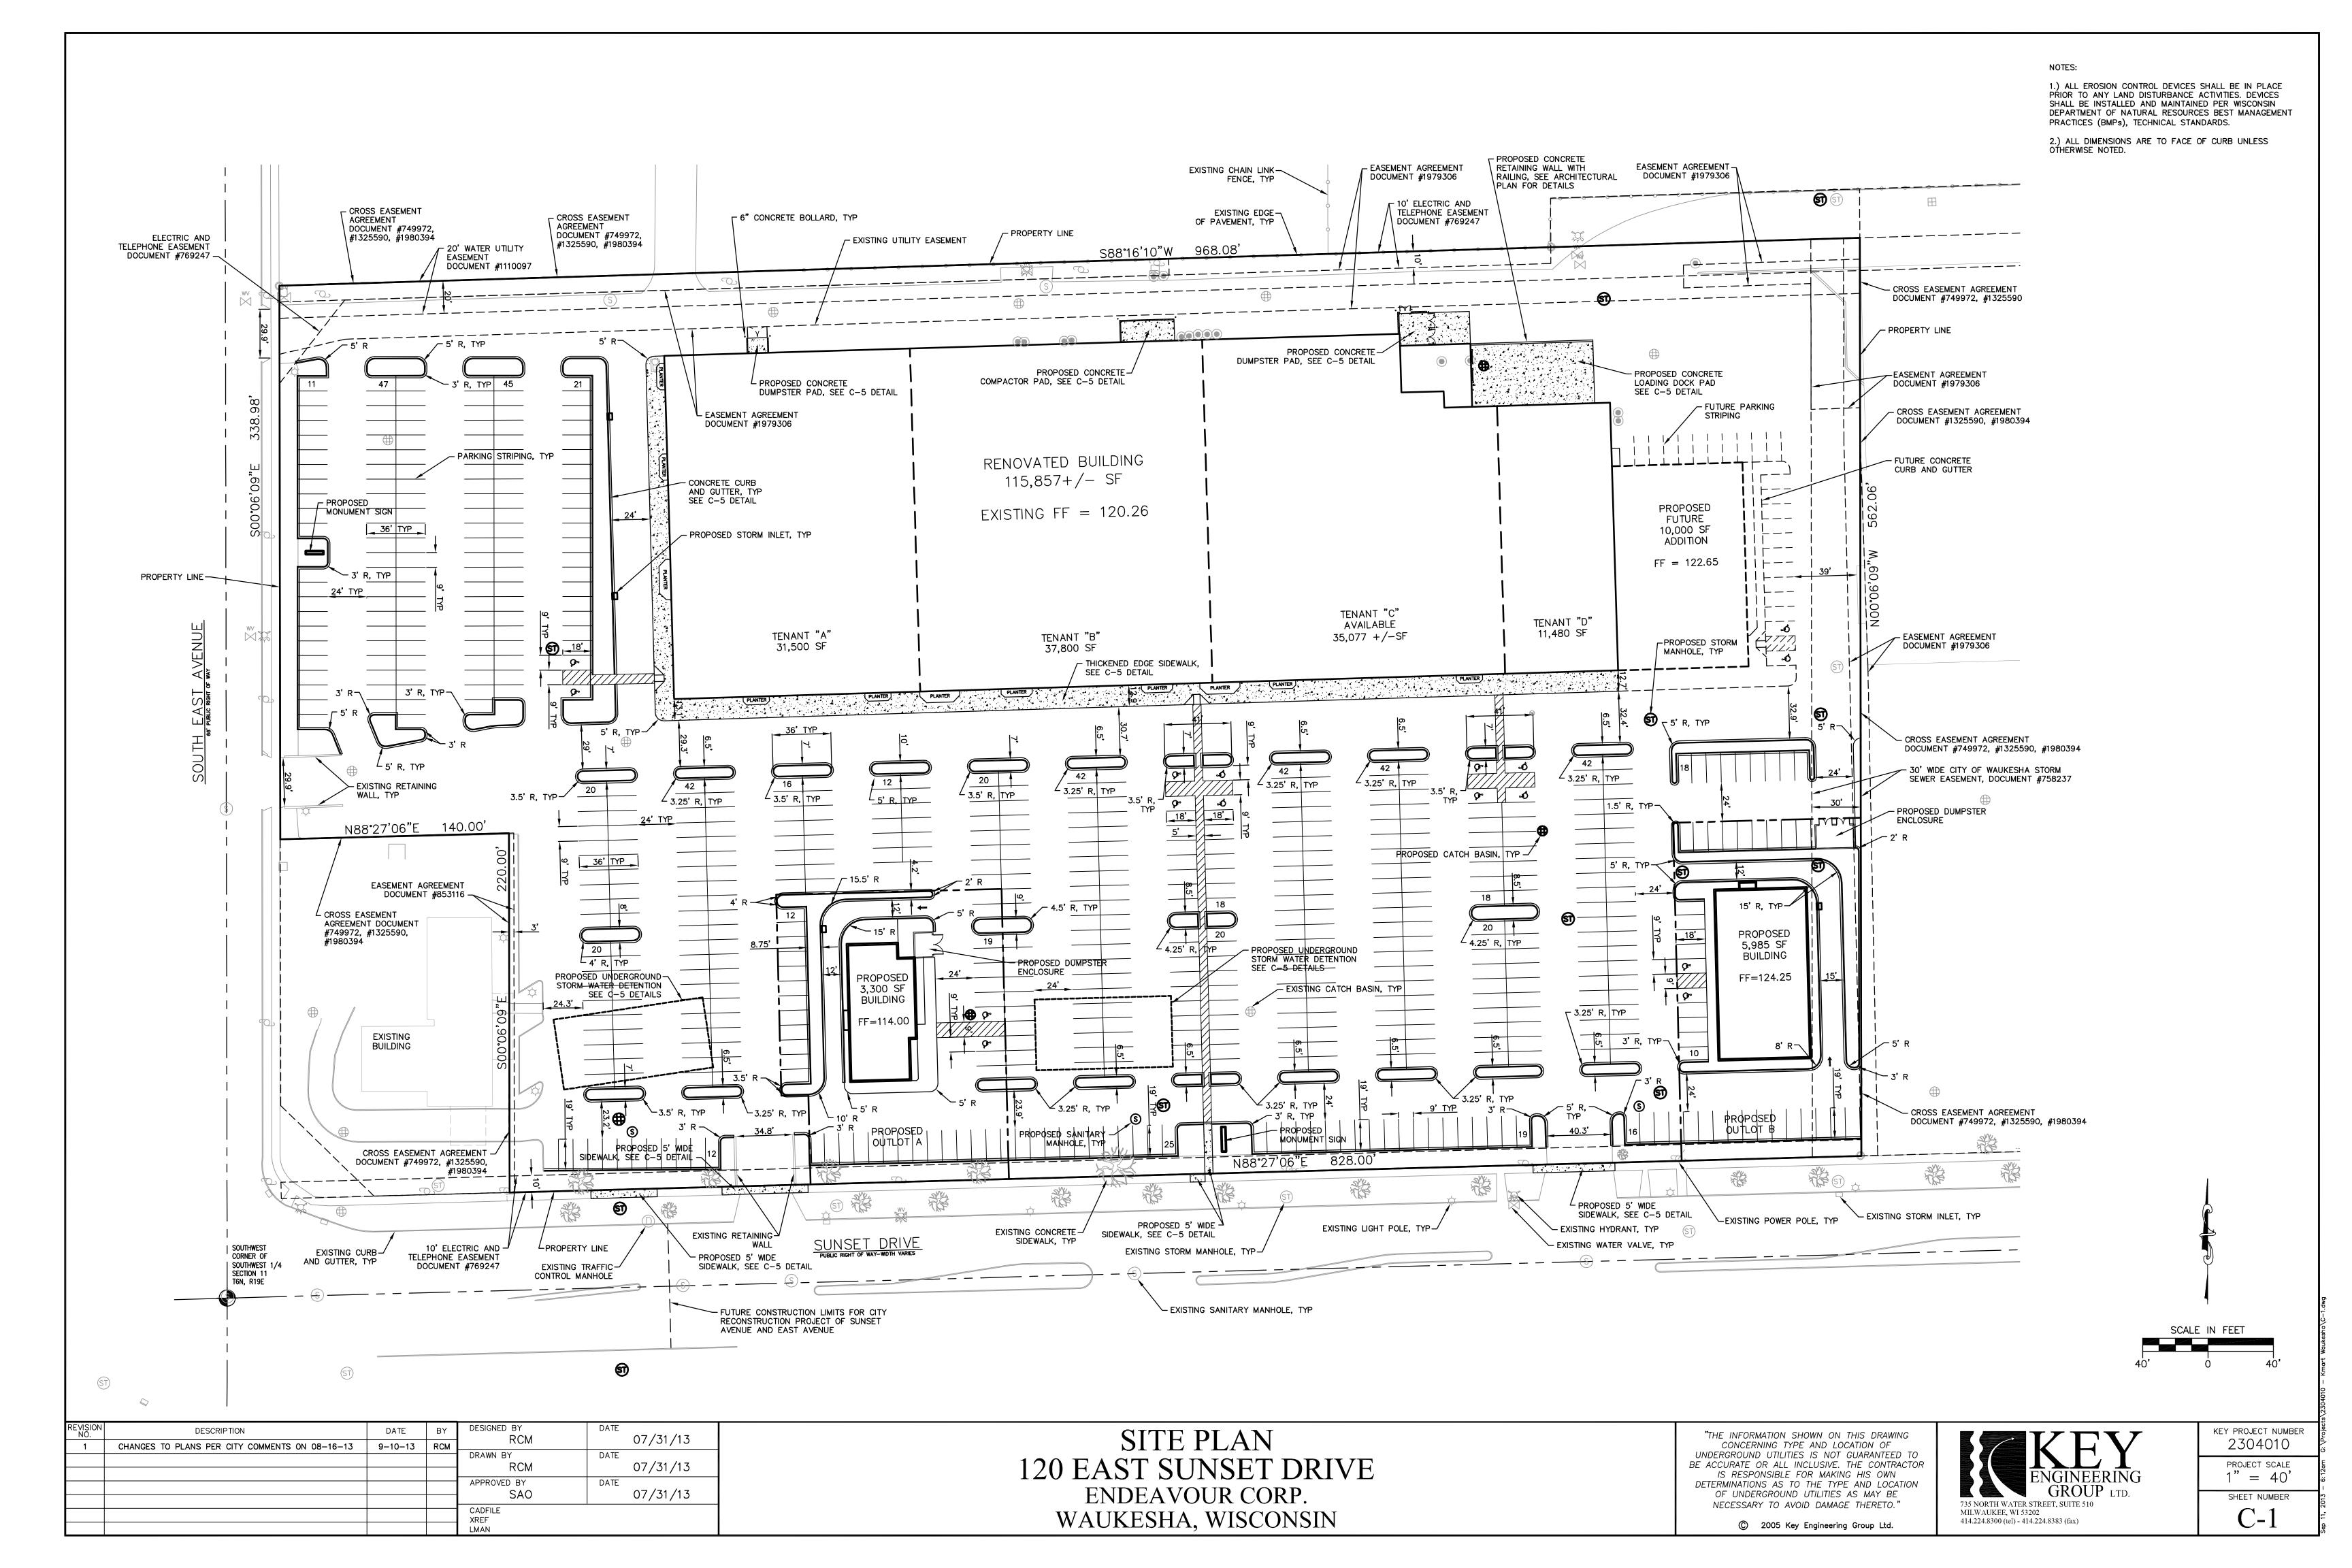
BE ACCURATE OR ALL INCLUSIVE. THE CONTRACTO IS RESPONSIBLE FOR MAKING HIS OWN DETERMINATIONS AS TO THE TYPE AND LOCATION OF UNDERGROUND UTILITIES AS MAY BE NECESSARY TO AVOID DAMAGE THERETO."

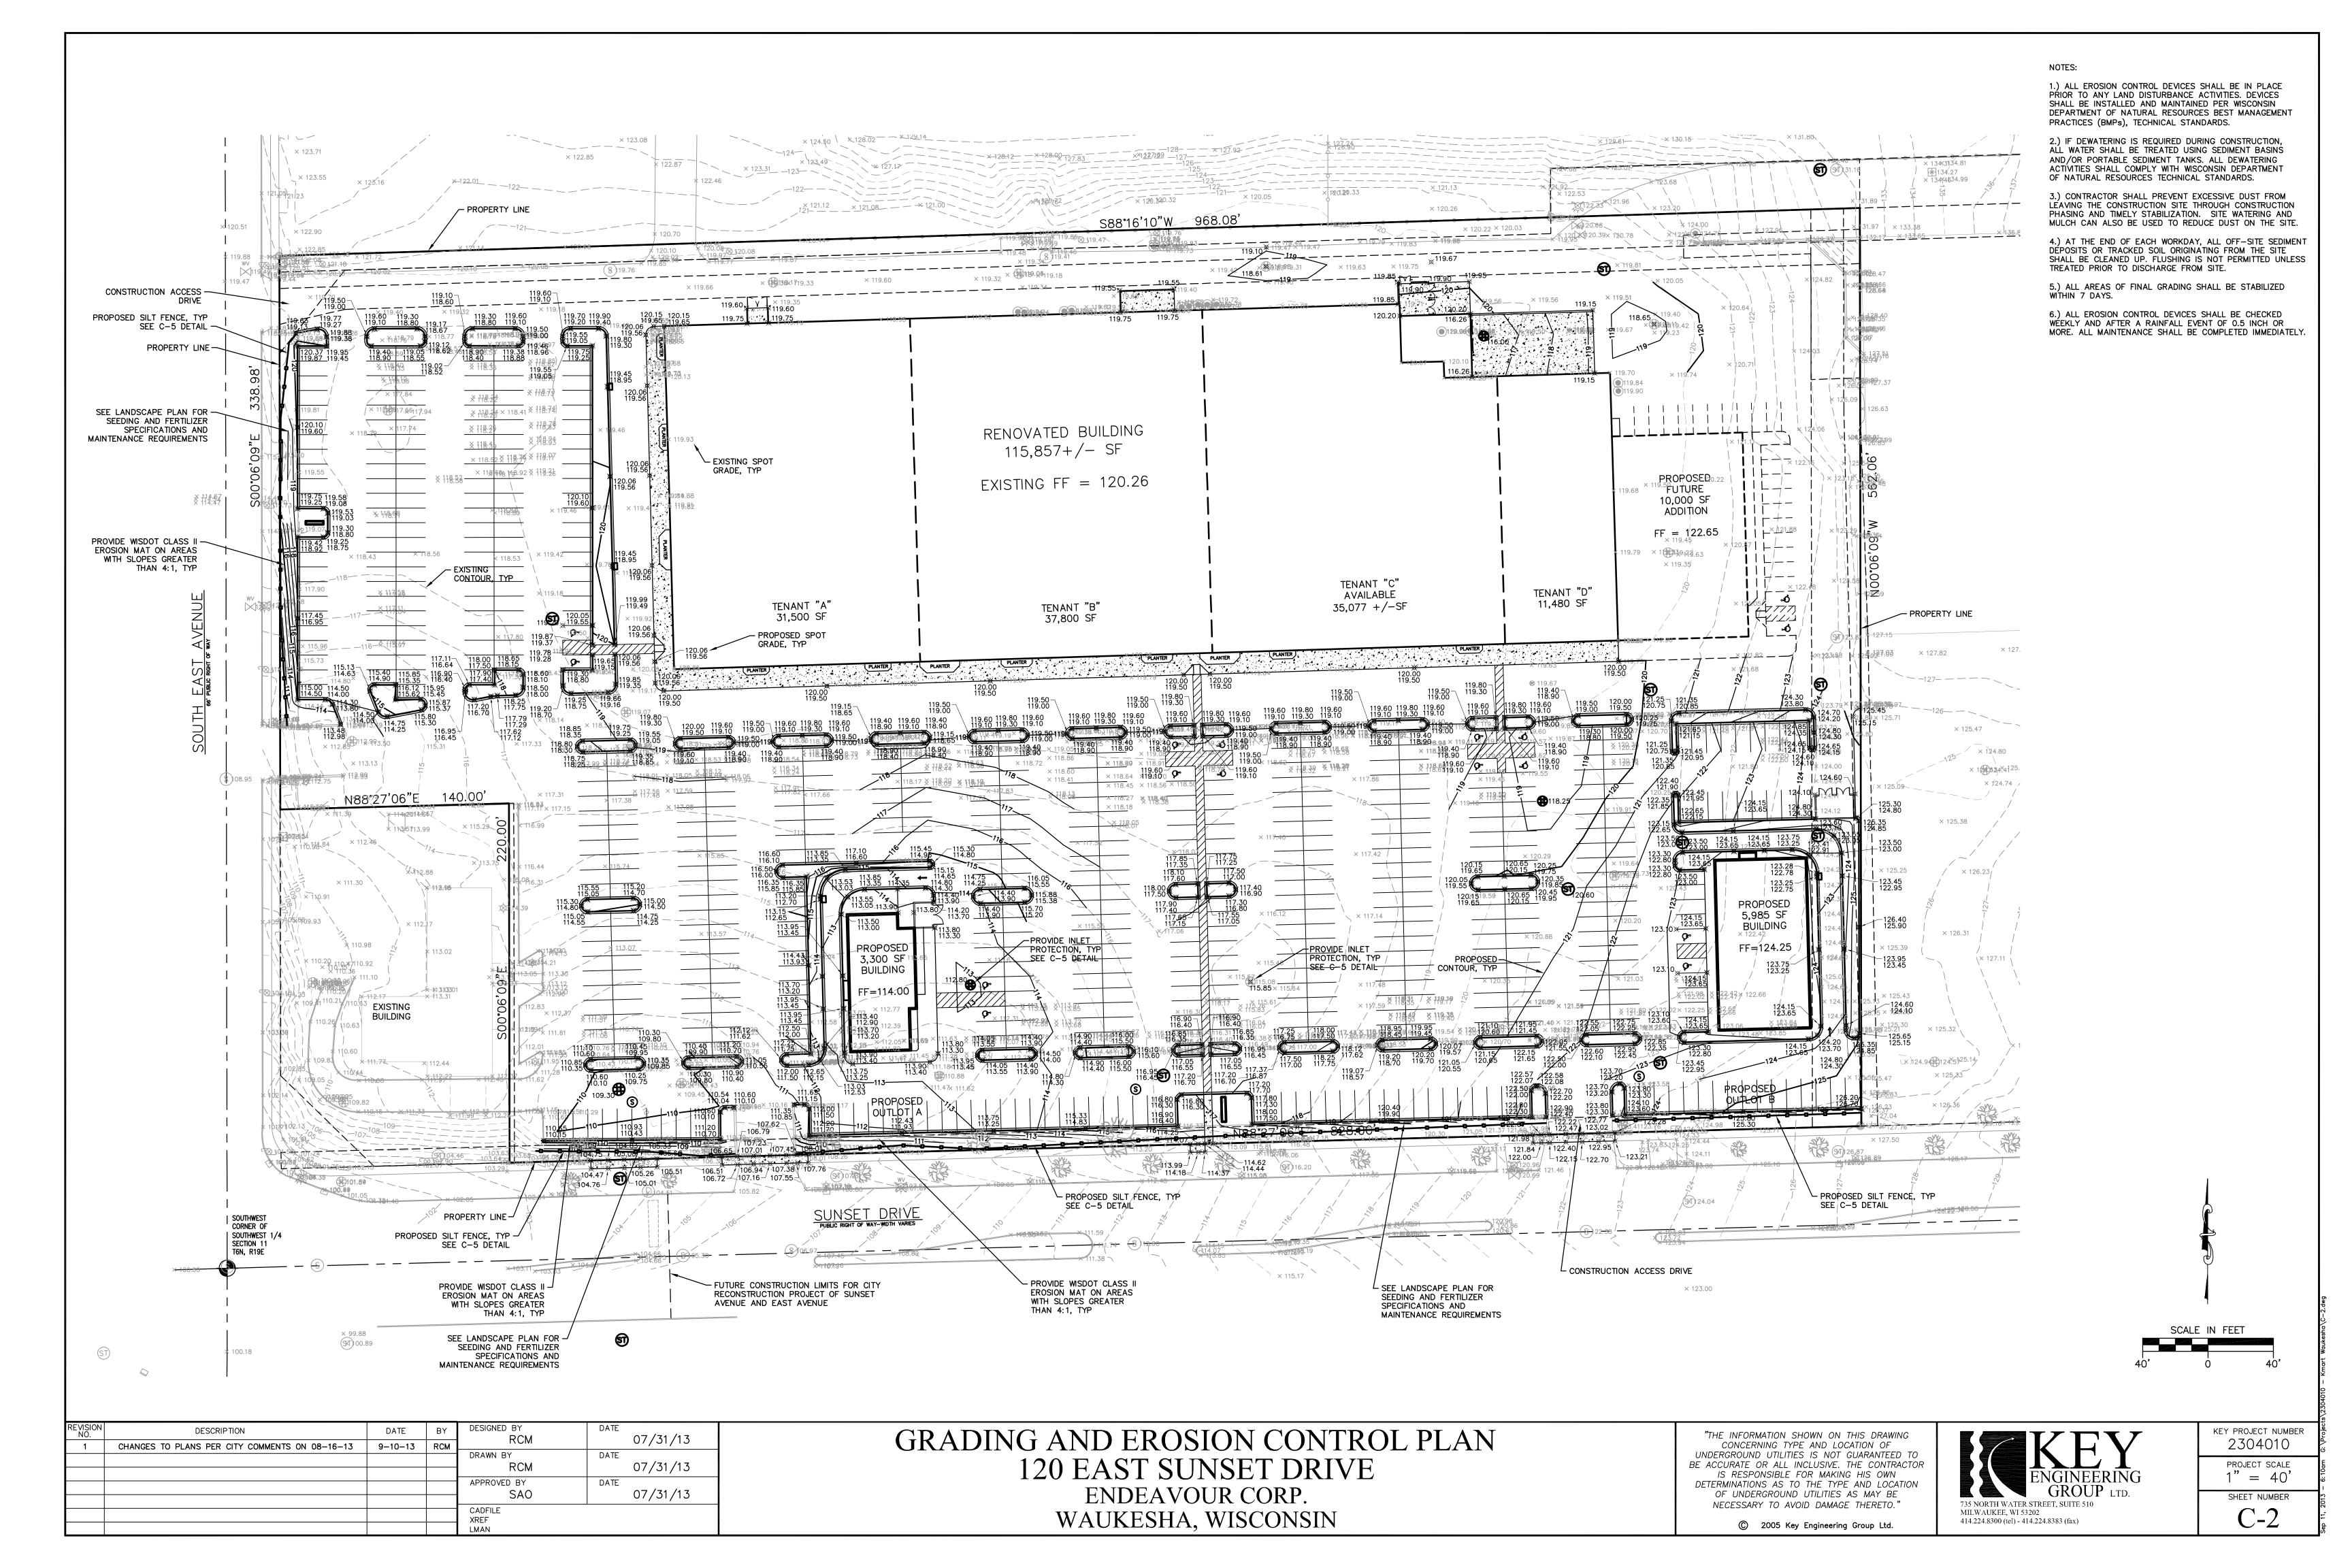
735 NORTH WATER STREET, SUITE 1000 MILWAUKEE, WI 53202 414.224.8300 (tel) - 414.224.8383 (fax)

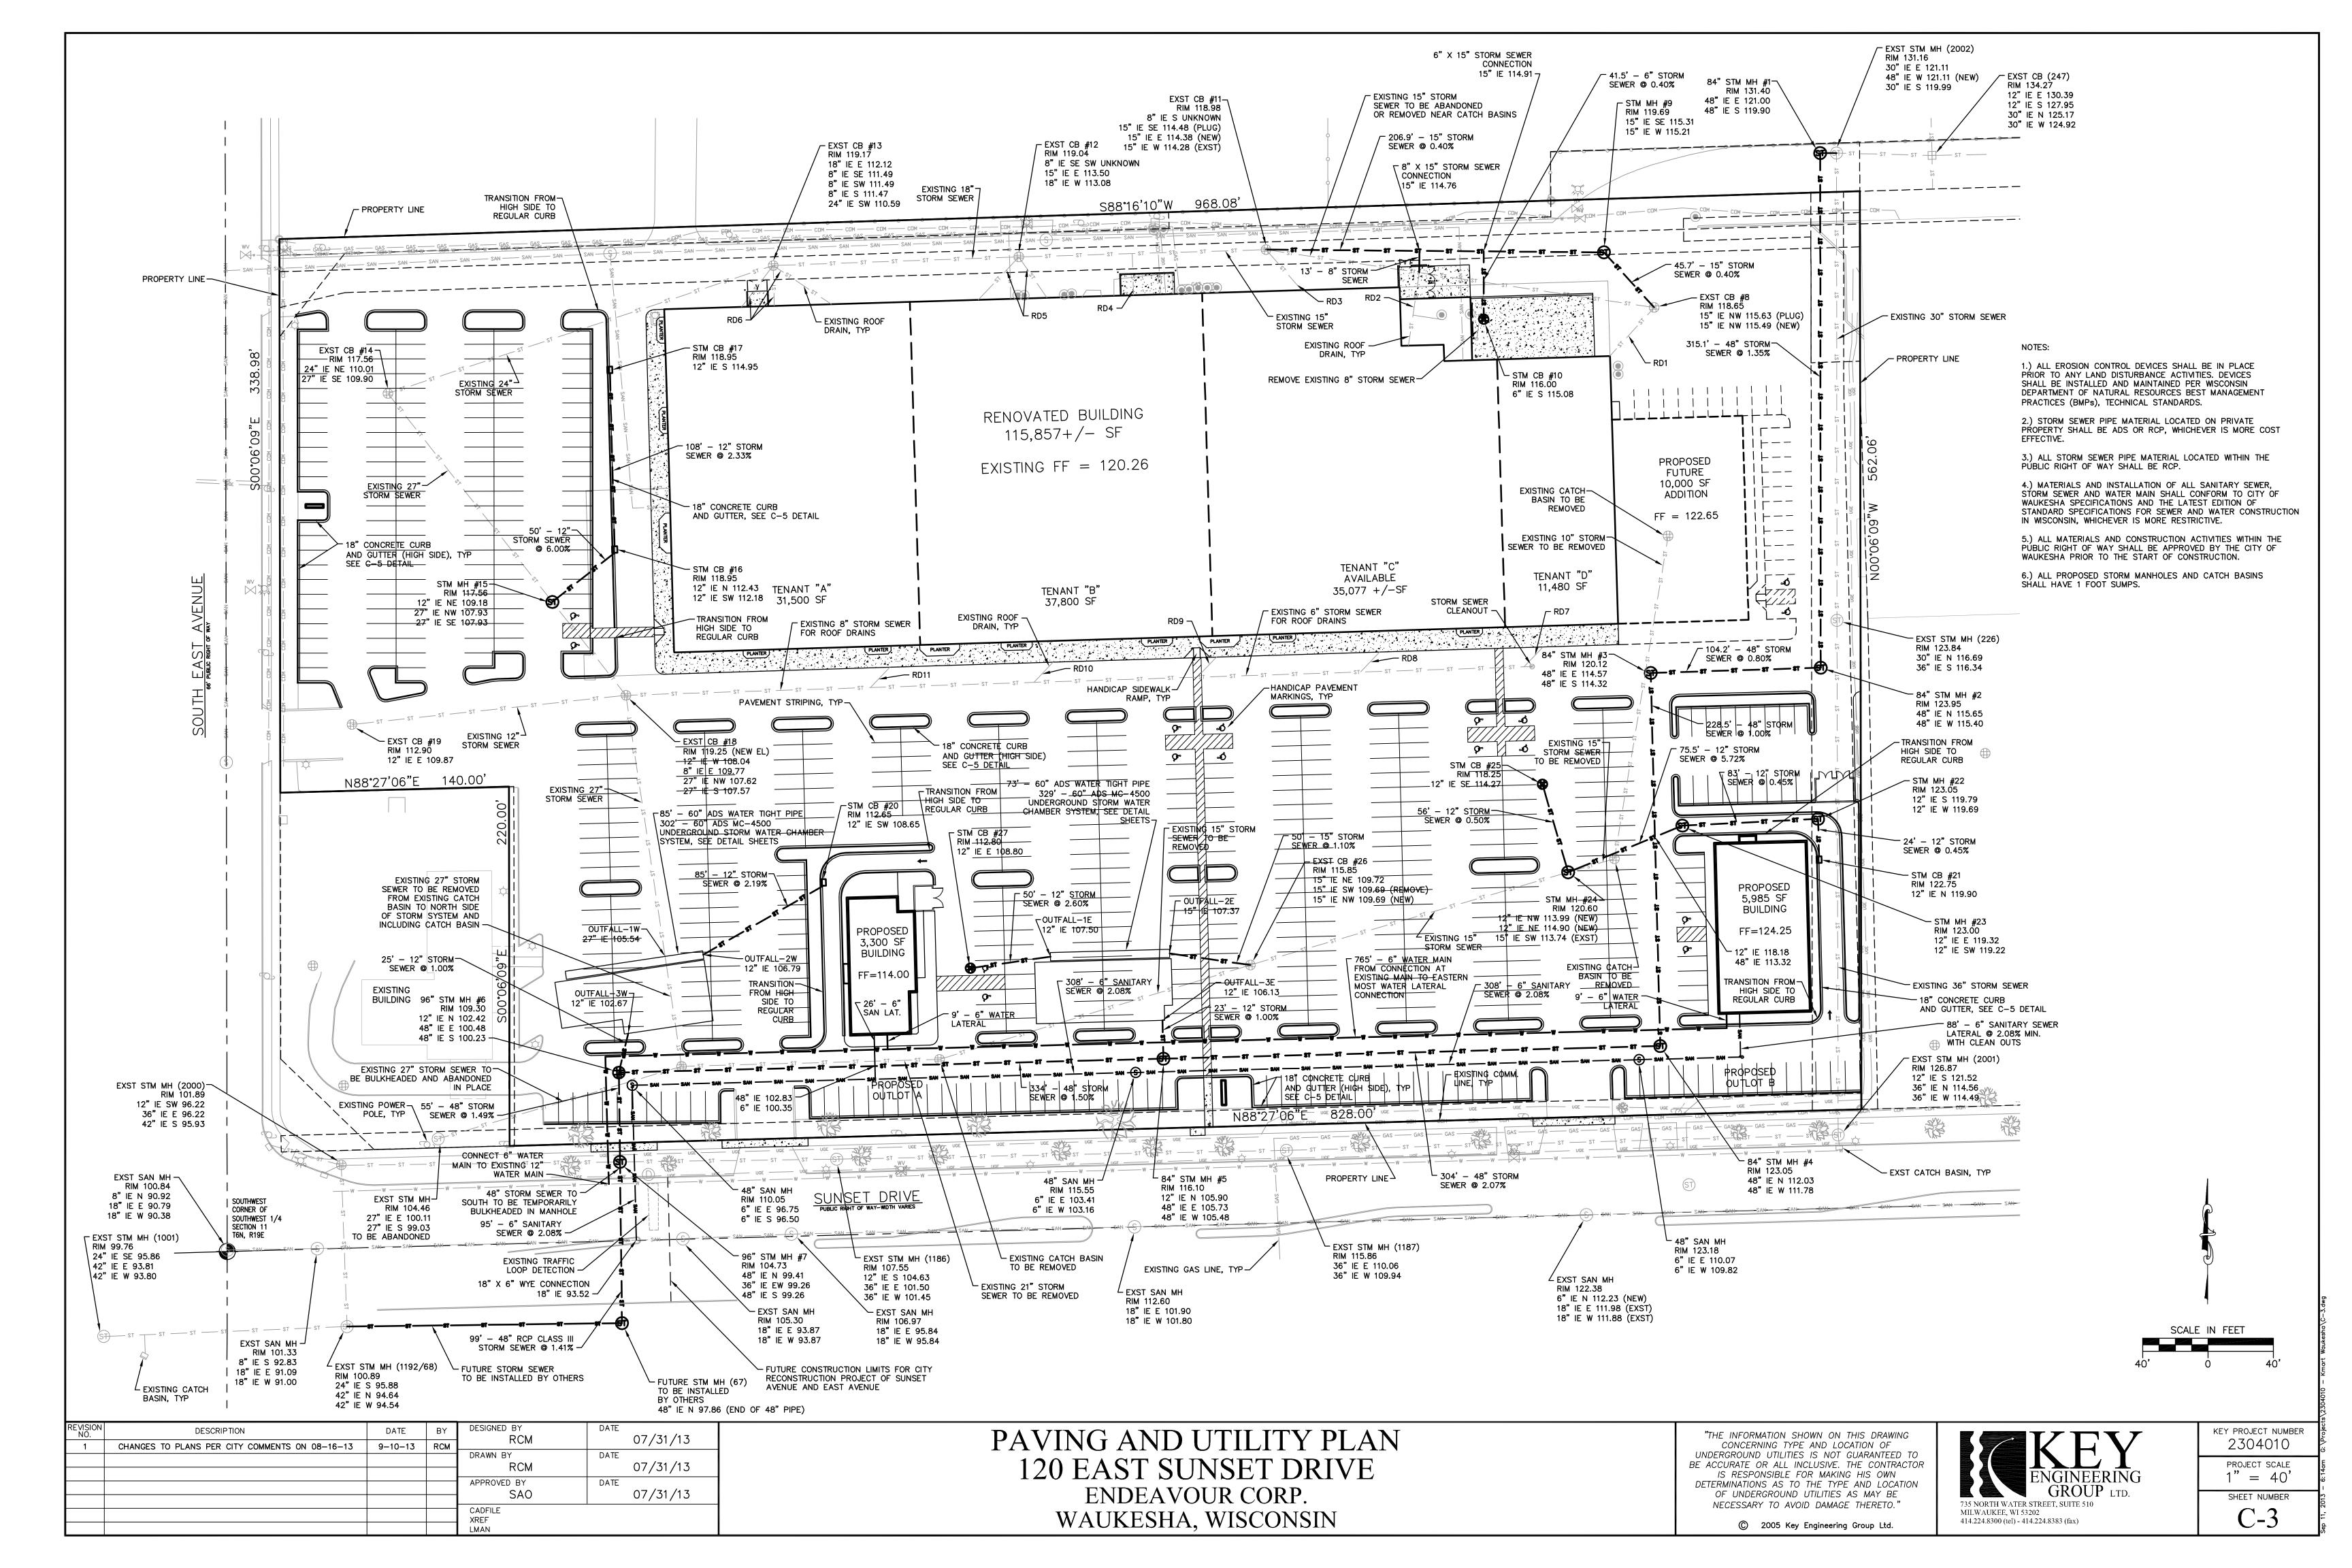
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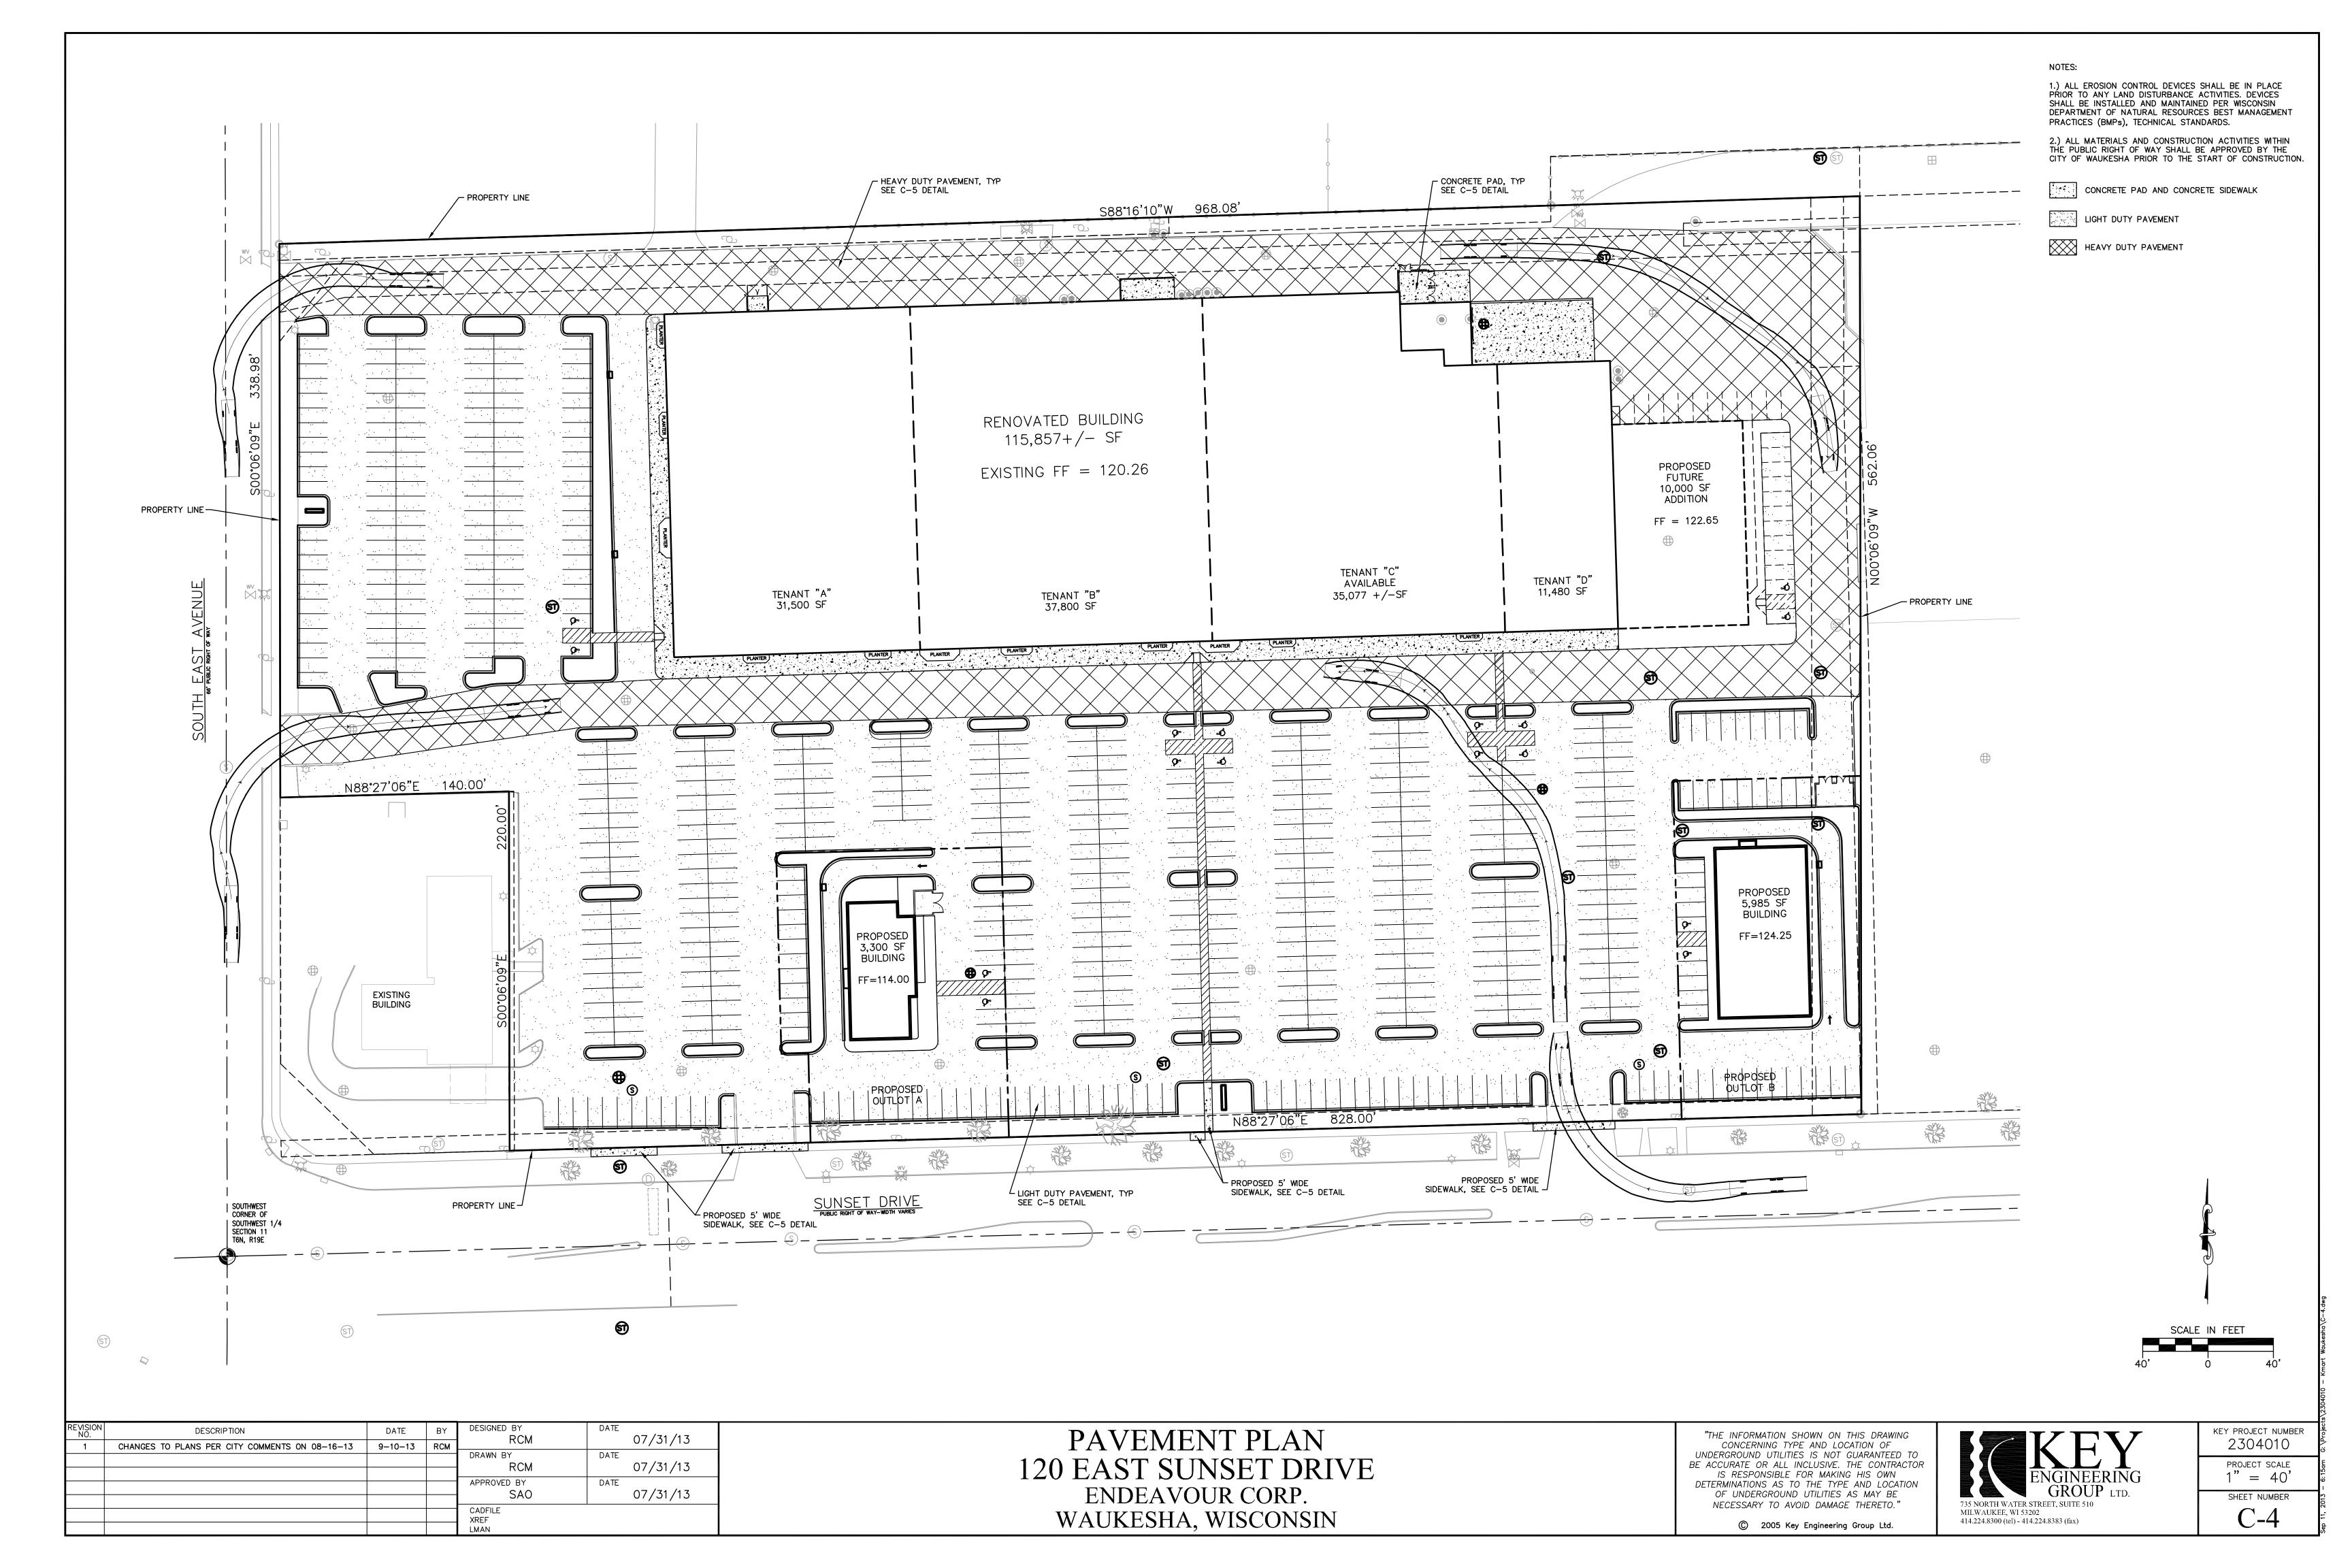
SHEET NUMBER **C-1**

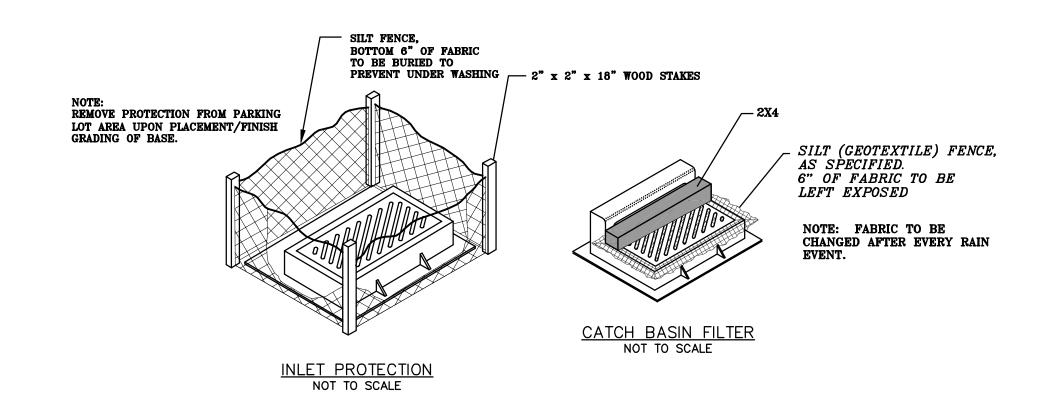
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____5" CONCRETE SIDEWALK

— 4" - 1 1/4" CRUSHED

AGGREGATE TB

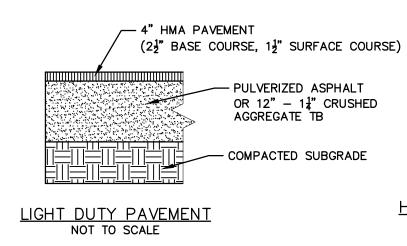
<u>SIDEWALK - WIDTH VARIES</u>

1.5% IN PUBLIC RIGHT OF WAY

__COMPACTED

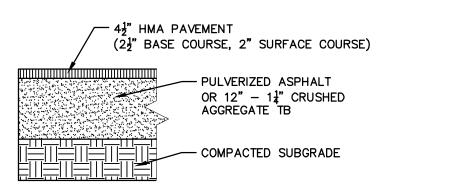
LANDSCAPE AREA

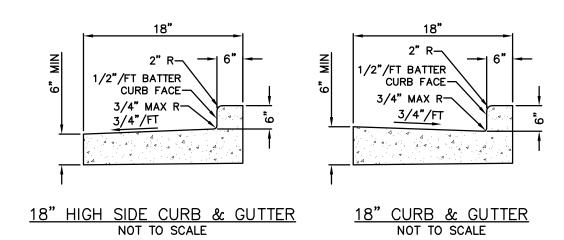
SEE LANDSCAPE PLAN
FOR DETAILS



SEE PLAN SHEET

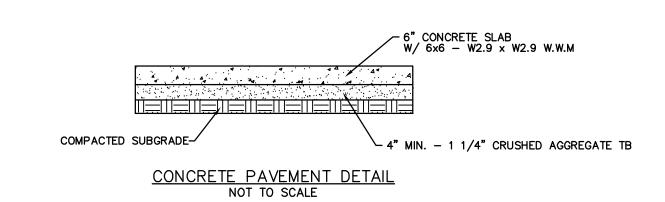
TYPICAL PERIMETER SIDEWALK NOT TO SCALE





NOT TO SCALE

GEOTEXTILE FABRIC
WITH ALTERNATE
SUPPORT COMPONENTS

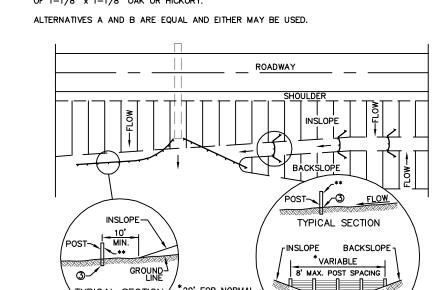


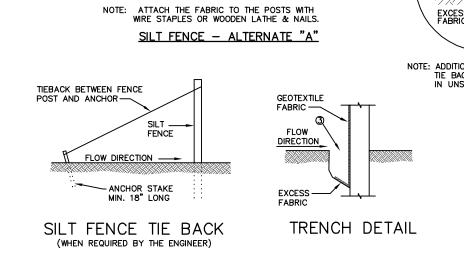
HEAVY DUTY PAVEMENT NOT TO SCALE

SILT FENCE GENERAL NOTES:

DETAIL OF CONSTRUCTION NOT SHOWN ON THIS DRAWING SHALL CONFORM TO THE PERTINENT REQUIREMENTS OF THE STANDARD SPECIFICATIONS AND APPLICABLE SPECIAL PROVISIONS. WHEN POSSIBLE THE SILT FENCE SHOULD BE CONSTRUCTED IN AN ARC OR HORSESHOE SHAPE, WITH THE ENDS POINTING UPSLOPE TO MAXIMIZE BOTH STRENGTH AND EFFECTIVENESS.

- ① CROSS BRACE WITH 2" x 4" WOODEN FRAME OR EQUIVALENT AT TOP OF POSTS AS DIRECTED BY THE ENGINEER.
- S EXCAVATE A TRENCH A MINIMUM OF 4" WIDE AND 6" DEEP TO BURY AND ANCHOR THE GEOTEXTILE FABRIC, FOLD MATERIAL TO FIT TRENCH AND BACKFILL AND COMPACT TRENCH WITH EXCAVATED SOIL.
- WIRE SUPPORT FENCE SHALL BE 14 GAGE MINIMUM WOVEN WIRE WITH A MAXIMUM MESH SPACING OF 6". SECURE TOP OF GEOTEXTILE FABRIC TO TOP OF FENCE WITH STAPLES OR WIRE RINGS AT 12" C-C.
- (5) GEOTEXTILE FABRIC SHALL BE REINFORCED WITH AN INDUSTRIAL POLY— PROPYLENE NETTING WITH A MAXIMUM MESH SPACING OF 3/4" OR EQUAL. A HEAVY DUTY NYLON TOP SUPPORT CORD OR EQUIVALENT IS REQUIRED.
- (6) STEEL POSTS SHALL BE STUDDED "TEE" OR "U TYPE" WITH A MINIMUM WEIGHT OF 1.28 lbs/lin. ft. (WITHOUT ANCHOR). FIN ANCHORS SUFFICIENT TO RESIST POST MOVEMENT ARE REQUIRED. WOOD POSTS SHALL BE A MINIMUM SIZE OF 4" DIA. OR 1-1/2" x 3-1/2" EXCEPT WOOD POSTS FOR GEOTEXTILE FABRIC REINFORCED WITH NETTING SHALL BE A MINIMUM SIZE OF 1-1/8" x 1-1/8" OAK OR HICKORY.





PLAN VIEW TYPICAL APPLICATIONS OF SILT FENCE

**GEOTEXTILE FABR

SILT FENCE INSTALLATION DETAIL

REVISION NO.	DESCRIPTION	DATE	BY	DESIGNED BY RCM	DATE 07/31/13
1 1	CHANGES TO PLANS PER CITY COMMENTS ON 08-16-13	9-10-13	RCM		• •
				drawn by RCM	DATE 07/31/13
				APPROVED BY SAO	DATE 07/31/13
				CADFILE XREF LMAN	

STANDARD DETAILS 120 EAST SUNSET DRIVE ENDEAVOUR CORP. WAUKESHA, WISCONSIN

"THE INFORMATION SHOWN ON THIS DRAWING CONCERNING TYPE AND LOCATION OF UNDERGROUND UTILITIES IS NOT GUARANTEED TO BE ACCURATE OR ALL INCLUSIVE. THE CONTRACTOR IS RESPONSIBLE FOR MAKING HIS OWN DETERMINATIONS AS TO THE TYPE AND LOCATION OF UNDERGROUND UTILITIES AS MAY BE NECESSARY TO AVOID DAMAGE THERETO."

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KEY PROJECT NUMBER 2304010 NOT TO SCALE SHEET NUMBER

C-5

PRU	JECT INFORMATION
ENGINEERED PRODUCT MANAGER:	MARK SCHOLLE 612-269-7692 MARK.SCHOLLE@ADS-PIPE.COM
ADS SALES REP:	CHUCK DODGE 262-483-0606 CHUCK.DODGE@ADS-PIPE.COM
PROJECT NO:	40155





KMART (PIPE DETAILS)

WAUKESHA. WISCONSIN

ADS RETENTION/DETENTION PIPE SYSTEM SPECIFICATION

THIS SPECIFICATION DESCRIBES ADS RETENTION/DETENTION PIPE SYSTEMS FOR USE IN NON-PRESSURE GRAVITY-FLOW STORM WATER COLLECTION SYSTEMS UTILIZING A CONTINUOUS OUTFALL STRUCTURE.

ADS RETENTION/DETENTION SYSTEMS MAY UTILIZE ANY OF THE VARIOUS PIPE PRODUCTS BELOW:

- N-12° WTIB PIPE (PER AASHTO) SHALL MEET AASHTO M 294, TYPE S OR ASTM F2306 N-12* WTIB PIPE (PER ASTM F2648) SHALL MEET ASTM F2648
- N-12° MEGA GREEN ™WTIB SHALL MEET ASTM F2648
- ALL PRODUCTS SHALL HAVE A SMOOTH INTERIOR AND ANNULAR EXTERIOR CORRUGATIONS. ALL STIB PIPE PRODUCTS ARE AVAILABLE AS PERFORATED OR NON-PERFORATED. WTIB PIPE PRODUCTS ARE ONLY AVAILABLE AS NON-PERFORATED. PRODUCT-SPECIFIC PIPE SPECIFICATIONS ARE

WTIB PIPE SHALL BE JOINED USING A BELL AND SPIGOT JOINT. THE JOINT SHALL BE WATERTIGHT ACCORDING TO THE REQUIREMENTS OF ASTM D3212. GASKETS SHALL MEET THE REQUIREMENTS OF ASTM F477, 12-60 INCH (300-1500 mm) DIAMETERS SHALL HAVE A BELL REINFORCED WITH A POLYMER COMPOSITE BAND. THE BELL TOLERANCE DEVICE SHALL BE INSTALLED BY THE MANUFACTURER.

PIPE AND FITTING CONNECTIONS SHALL BE WITH A BELL AND SPIGOT CONNECTION UTILIZING A SPUN-ON OR WELDED BELL AND VALLEY OR SADDLE GASKET, THE JOINT SHALL MEET THE WATERTIGHT REQUIREMENTS OF ASTM D3212, AND GASKETS SHALL MEET THE REQUIREMENTS OF ASTM F477. DETENTION SYSTEMS ARE SUBJECT TO GREATER LEAKAGE THAN TYPICAL SINGLE RUN STORM SEWER APPLICATIONS AND THEREFORE ARE NOT APPROPRIATE FOR APPLICATIONS REQUIRING LONG-TERM FLUID CONTAINMENT OR HYDROSTATIC PRESSURE. FOR ADDITIONAL DETAILS REFER TO TECHNICAL NOTE 7.01 "RAINWATER HARVESTING WITH HDPE PIPE CISTERNS"

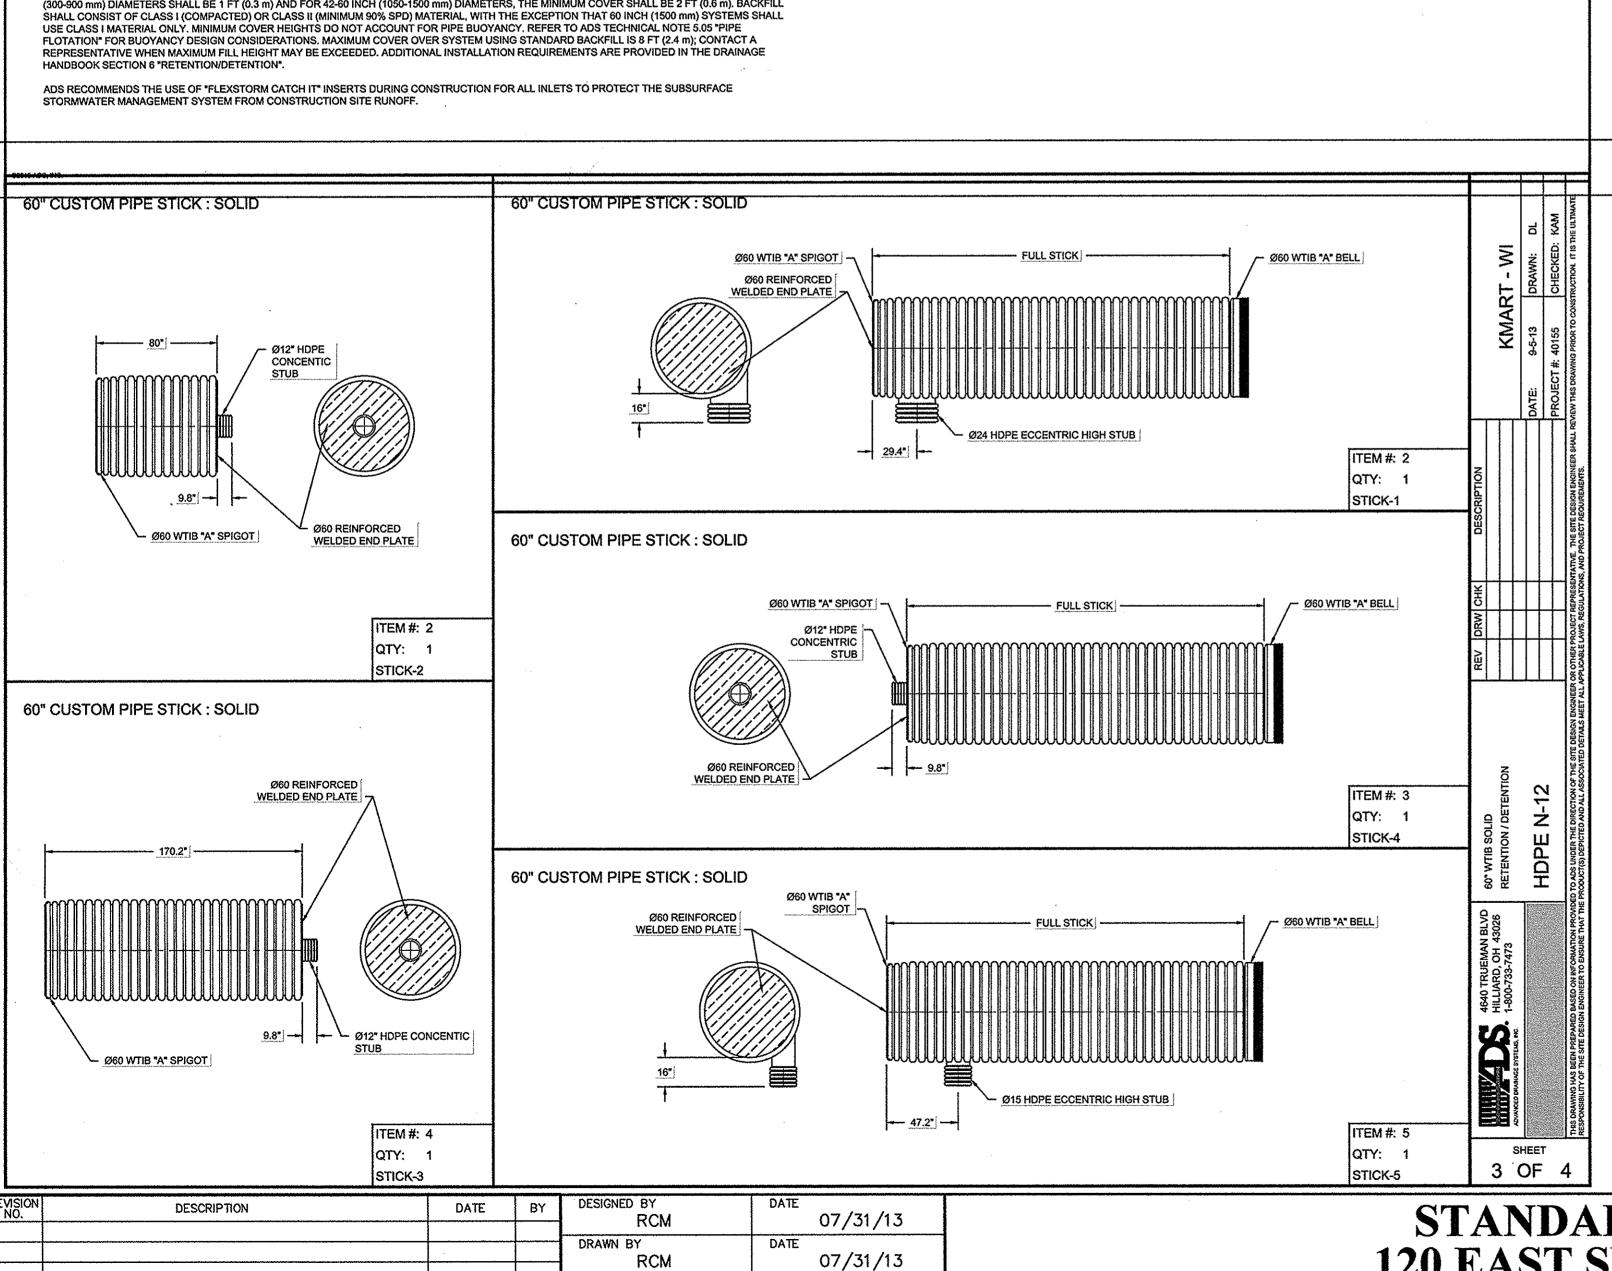
FITTINGS SHALL CONFORM TO ASTM F2306 AND MEET JOINT PERFORMANCE INDICATED ABOVE FOR FITTINGS CONNECTIONS. CUSTOM FITTINGS ARE AVAILABLE AND MAY REQUIRE SPECIAL INSTALLATION CRITERION.

INSTALLATION SHALL BE IN ACCORDANCE WITH ASTM D2321 AND ADS RECOMMENDED INSTALLATION GUIDELINES. WITH THE EXCEPTION THAT MINIMUM COVER IN NON-TRAFFIC AREAS FOR 12-60 INCH (300-1500 mm) DIAMETERS SHALL BE 1 FT (0.3 m). MINIMUM COVER IN TRAFFICKED AREAS FOR 12-36 INCH (300-900 mm) DIAMETERS SHALL BE 1 FT (0.3 m) AND FOR 42-60 INCH (1050-1500 mm) DIAMETERS, THE MINIMUM COVER SHALL BE 2 FT (0.6 m). BACKFILL

- 1) ALL ELEVATIONS, DIMENSIONS AND LOCATIONS OF RISERS, INLETS AND OUTLETS, SHALL BE VERIFIED BY THE ENGINEER PRIOR TO RELEASING FOR FABRICATION.
- 2) IN SITUATIONS WHERE A FINE-GRAINED BACKFILL MATERIAL IS USED ADJACENT. TO THE PIPE SYSTEM, AND ESPECIALLY INVOLVING GROUND WATER CONDITIONS, CONSIDERATION SHOULD BE GIVEN TO THE USE OF GASKETED PIPE JOINTS. AT THE VERY LEAST THE PIPE JOINTS SHOULD BE WRAPPED IN A SUITABLE, NON-WOVEN GEOTEXTILE FABRIC TO PREVENT INFILTRATION OF FINES INTO THE PIPE SYSTEM.
- 3) CONSIDERATION FOR CONSTRUCTION EQUIPMENT LOADS MUST BE TAKEN INTO ACCOUNT.
- 4) ALL PIPE DIMENSIONS ARE SUBJECT TO MANUFACTURERS TOLERANCES.
- 5) ALL RISERS TO BE FIELD EXTENDED OR TRIMMED TO FINAL GRADE.

CUSTOMER

THE UNDERSIGNED HERBY APPROVES THE ATTACHED PAGES.

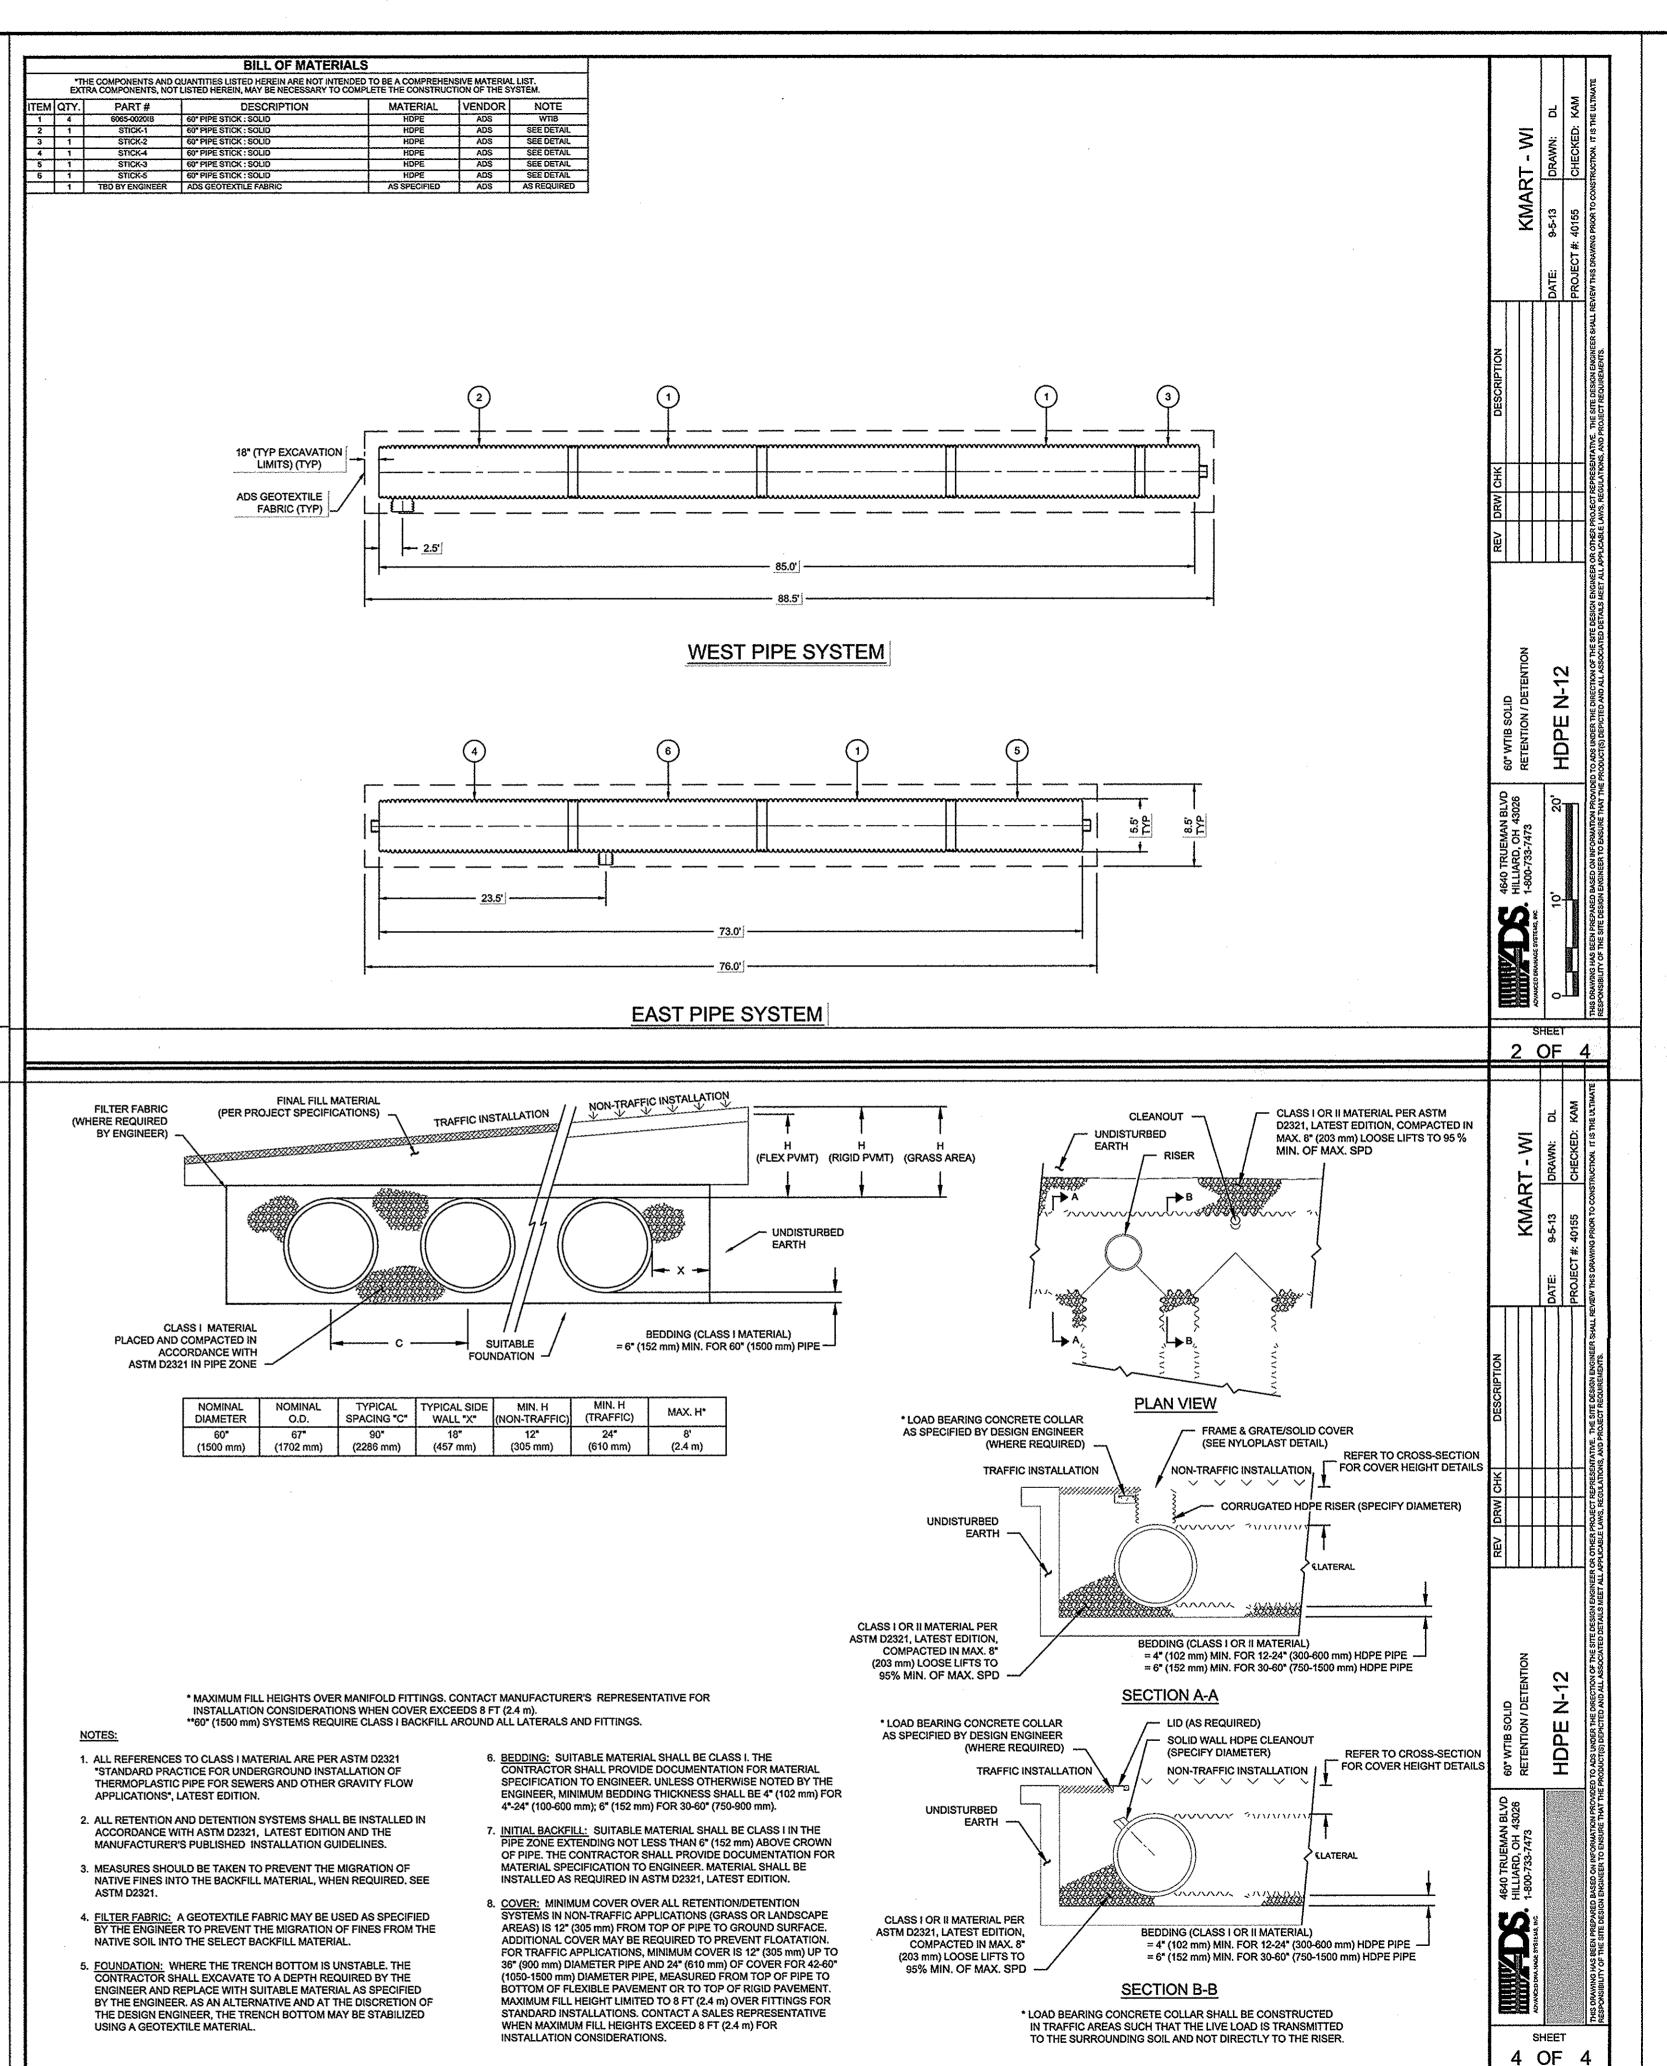


07/31/13

APPROVED BY

CADFILE

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STANDARD DETAILS 120 EAST SUNSET DRIVE ENDEAVOUR CORP. WAUKESHA, WISCONSIN

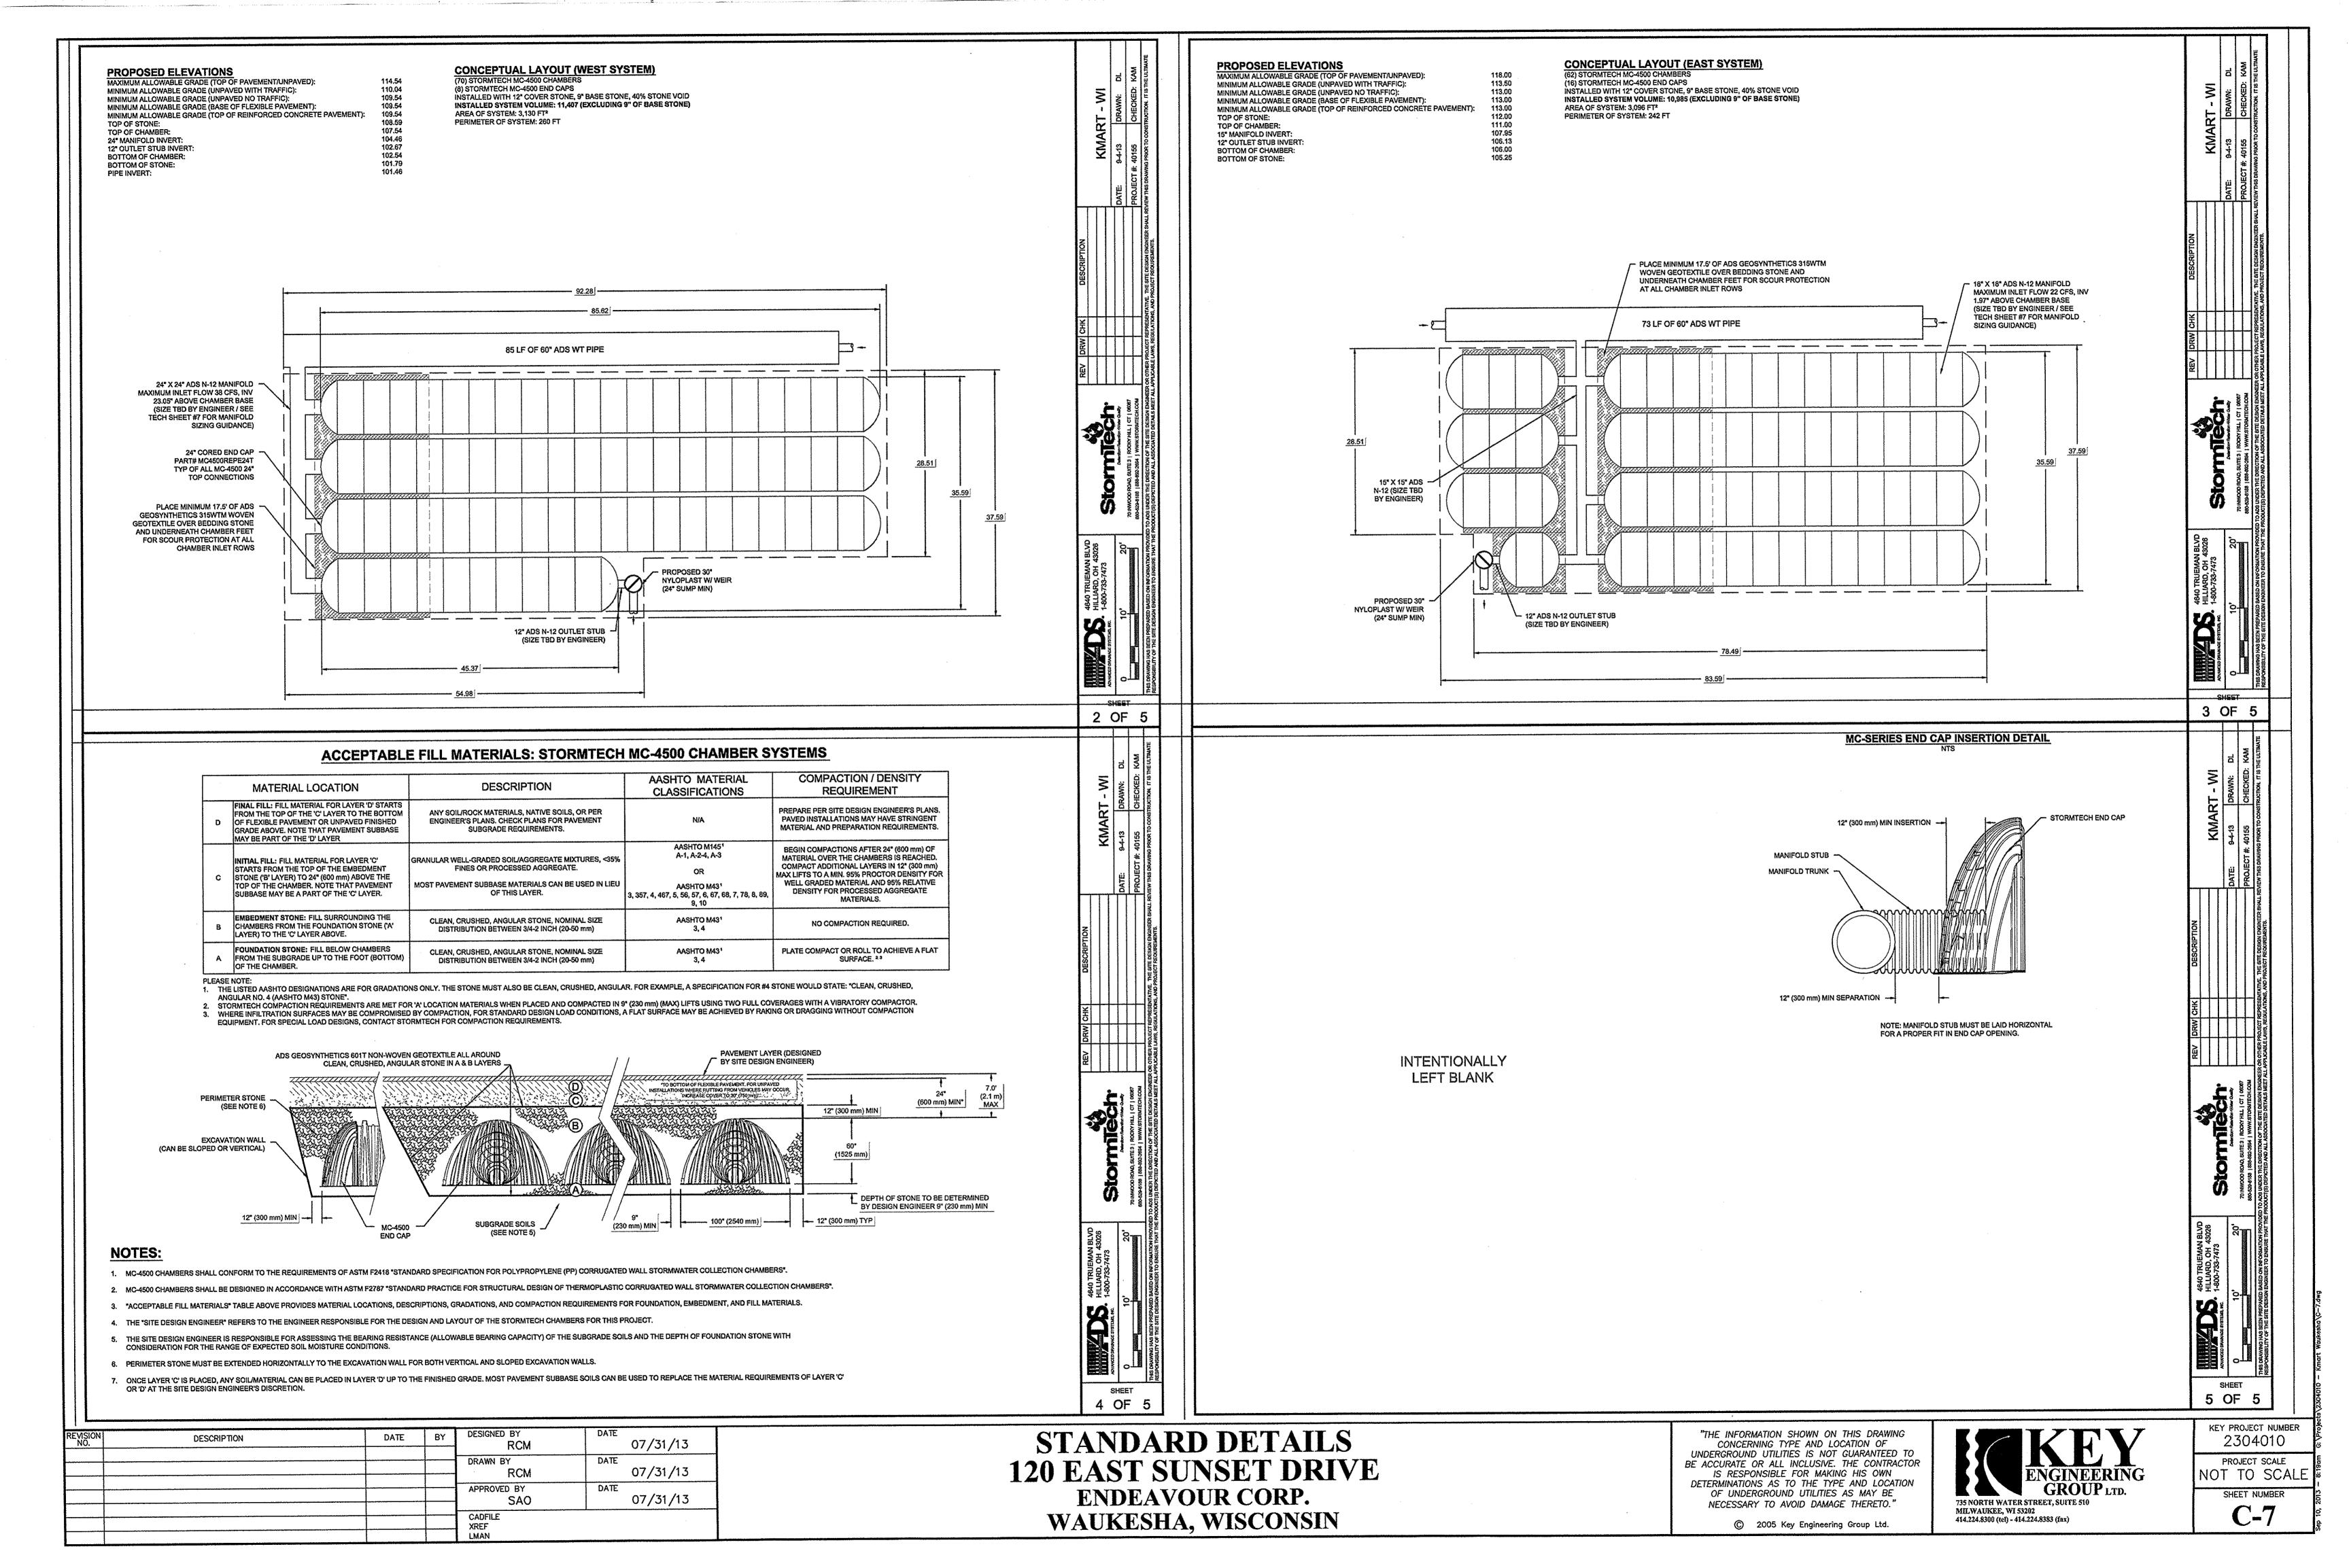
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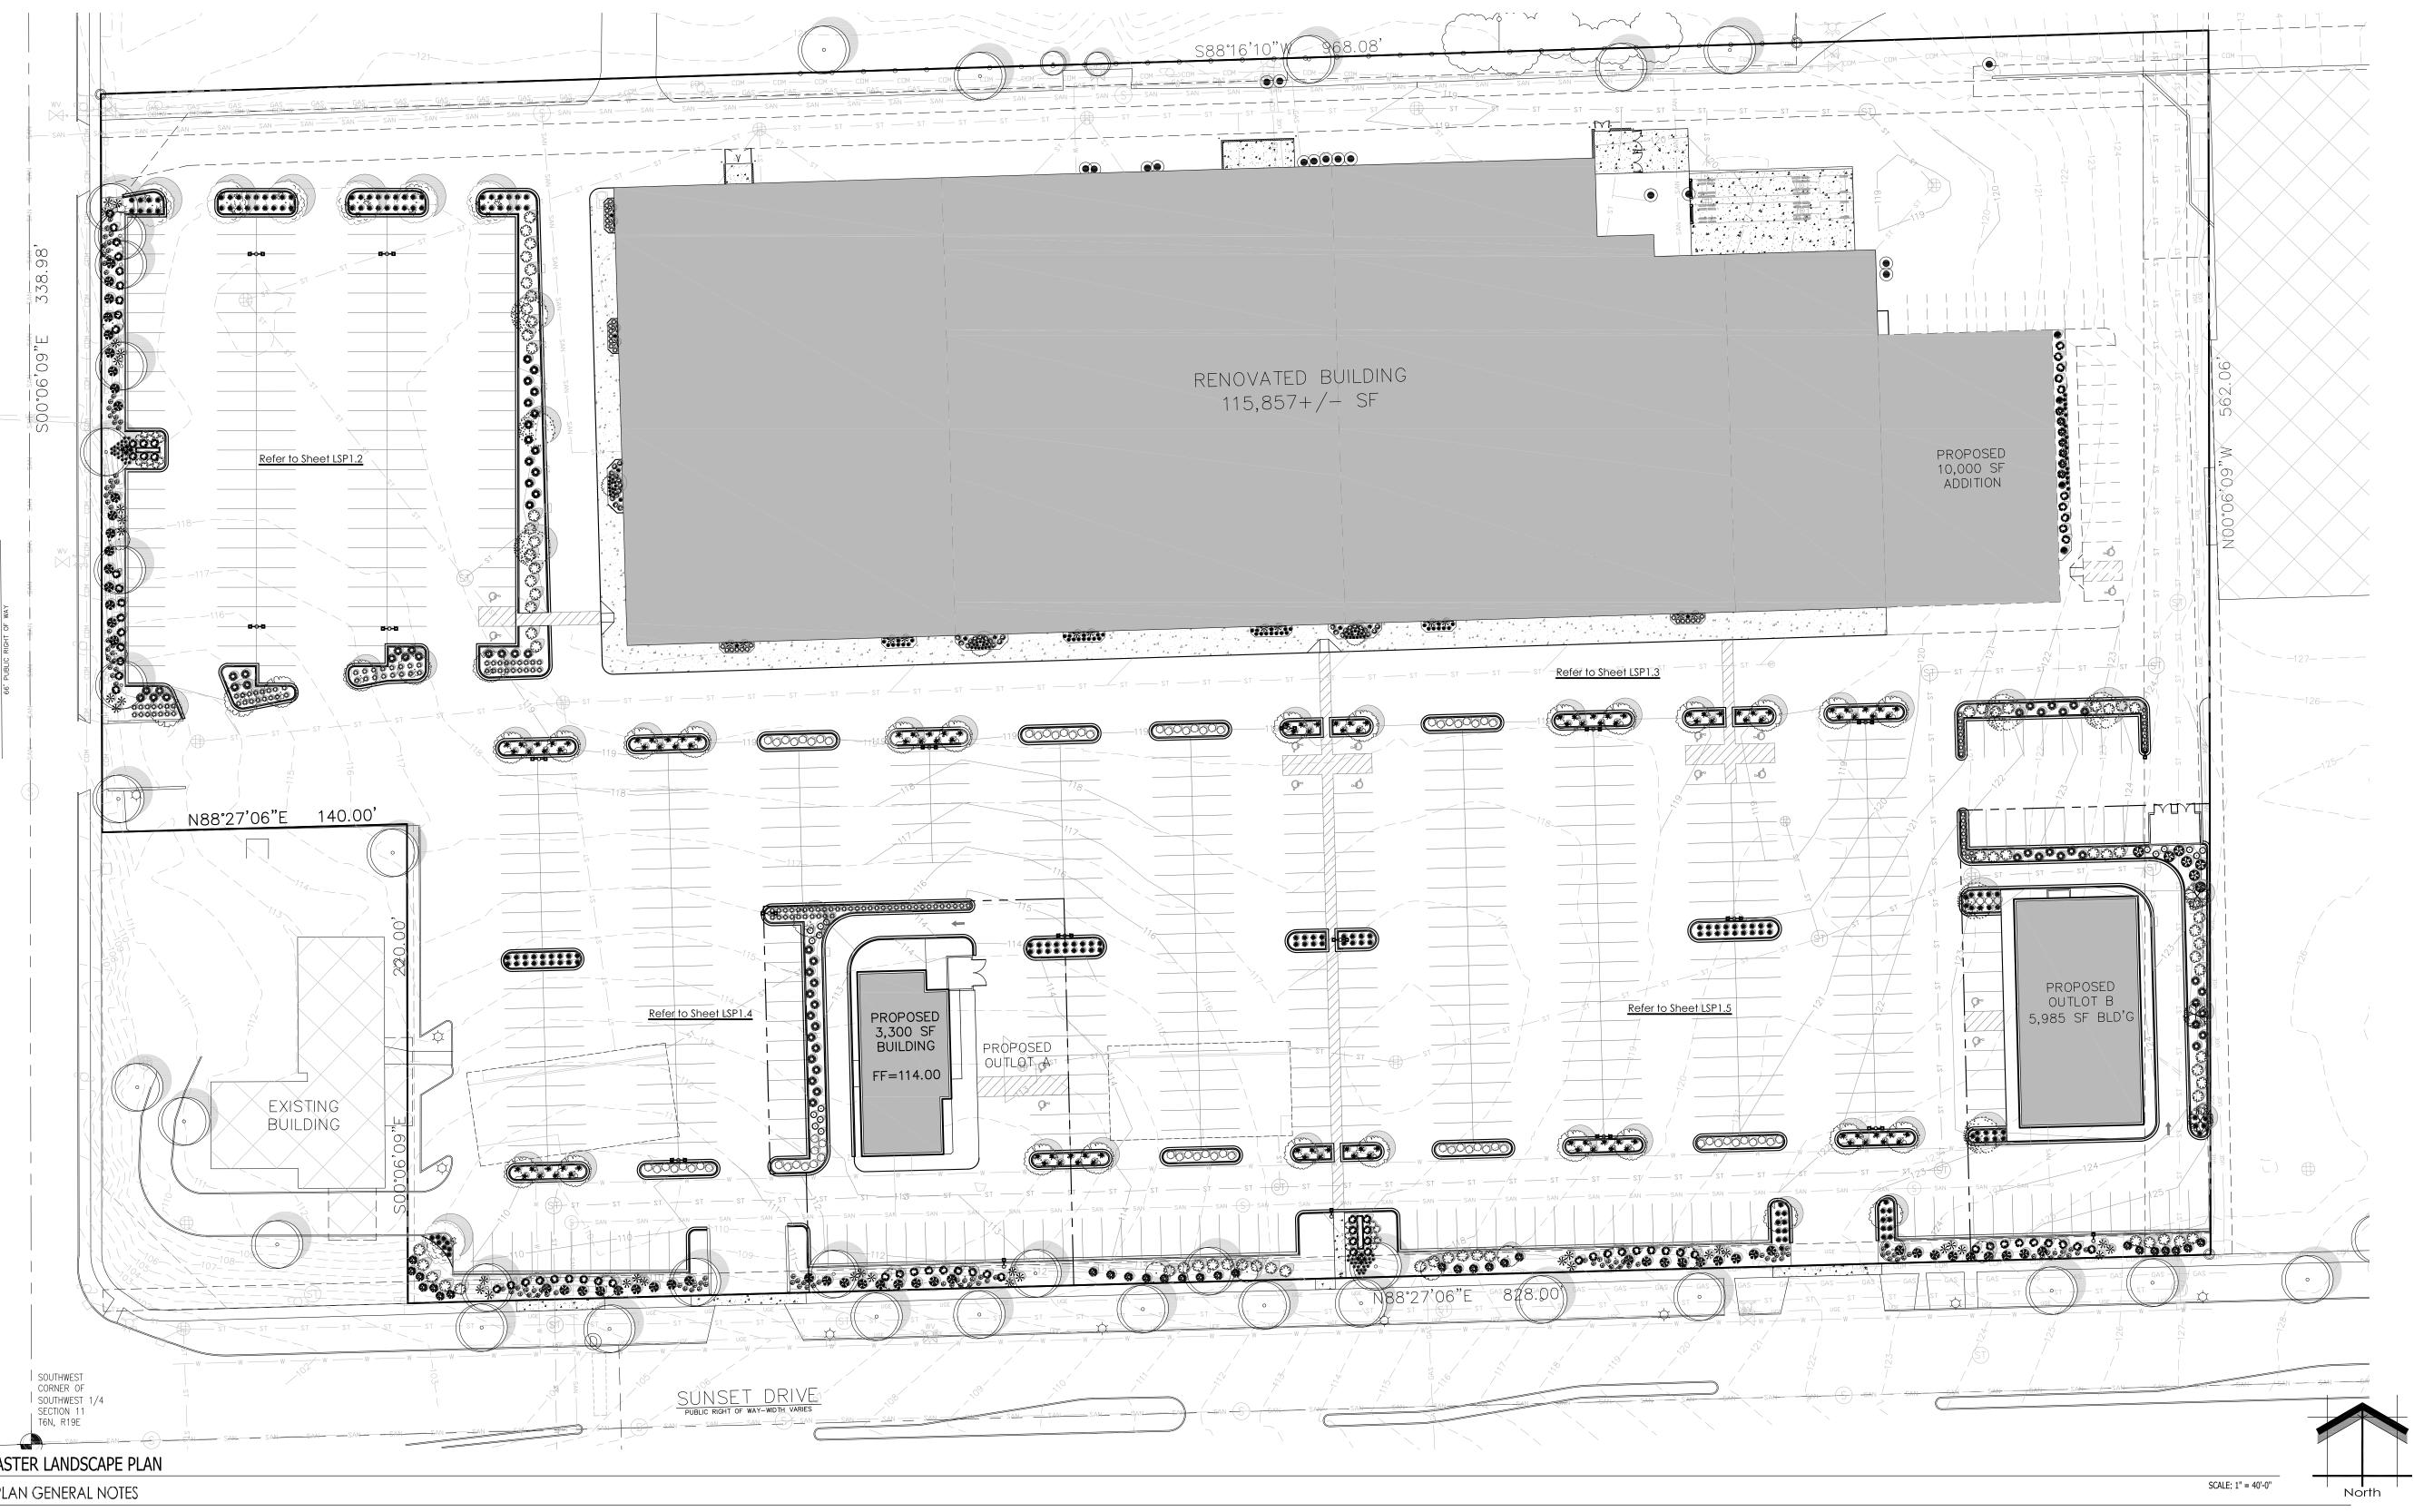
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KEY PROJECT NUMBER 2304010 PROJECT SCALE NOT TO SCALI SHEET NUMBER

C-6





PROPOSED MASTER LANDSCAPE PLAN

LANDSCAPE PLAN GENERAL NOTES

* * PLANT MATERIAL SHOWN ON LANDSCAPE PLAN IS DEPICTED AT MATURE GROWTH. * *

AT LEAST SEVENTY-TWO HOURS PRIOR TO ANY EXCAVATION, CONTRACTOR SHALL VERIFY UTILITY LOCATIONS AS GIVEN BY THE ELECTRIC, GAS, TELEPHONE, WATER, SEWER, AND CABLE TELEVISION COMPANIES, UTILITIES OR ENTITIES. REVIEW WITH OWNER'S REPRESENTATIVE SITE MECHANICAL, SITE ELECTRICAL AND LIGHTING, SITE GRADING AND DRAINAGE, SITE IRRIGATION AND ALL OTHER DRAWINGS PERTAINING TO UNDERGROUND UTILITY LOCATIONS. RECORD SET OF INFORMATION THE SAME AS IN POSSESSION OF OWNER'S REPRESENTATIVE. ALSO REVIEW OWNER'S "MARK SETS" OF ALL OF THESE DRAWINGS IN POSSESSION OF THE CONTRACTOR OR OWNER. MARK ALL SUCH UTILITIES ON THE SITE PRIOR TO COMMENCING. COORDINATE WITH OWNER BEFORE AND DURING CONSTRUCTION. REPAIR ANY DAMAGE TO ANY SYSTEM THAT IS CAUSED BY LANDSCAPE CONTRACTOR AT NO COST TO OWNER.

- 2. ALL PLANTINGS SHALL COMPLY WITH STANDARDS AS DESCRIBED IN AMERICAN STANDARD OF NURSERY STOCK ANSI Z60.0 1986. DEVIATIONS FROM THESE PLANS SHALL BE NOTED ON THE RECORD DRAWING BY THE CONTRACTOR AND
- ONLY WITH PRIOR APPROVAL OF THE LANDSCAPE ARCHITECT AND OWNER'S REPRESENTATIVE. VERBAL AGREEMENTS OR REVISIONS WITHOUT A CHANGE ORDER WILL NOT BE RECOGNIZED BY LANDSCAPE
- ALL PLANTS MUST BE BID AND SELECTED PER THE SPECIES SPECIFIED ON THE PLANS. THE SIZES OF PLANT MATERIAL LISTED HEREIN IS A MINIMUM ACCEPTABLE SIZE. ADDITIONALLY, IF EXCESSIVE PRUNING REDUCES THE CROWN THE PLANT SHALL BE REPLACED.
- PROTECT PUBLIC FROM CONSTRUCTION WITH BARRIERS AND BARRICADES.

OR TO REPAIR DAMAGE DONE BY OTHERS.

- ALL AREAS THAT WERE DISTURBED DURING CONSTRUCTION AND AREAS NOT COVERED WITH PAVEMENT, BUILDING, PLANTING BEDS, OR TREE PITS ARE TO BE TOPSOILED 6" DEEP (MIN.) AND SHALL BE SODDED/SEEDED WITH SPECIFIED LAWN GRASS. LANDSCAPE CONTRACTOR SHALL INCLUDE COST PER SQUARE YARD FOR ADDITIONAL SEED OPERATIONS AS MAY BE POSSIBLY REQUIRED TO REESTABLISH ADJACENT TURF GRASS AREAS WHICH MAY BECOME DAMAGED DURING THE CONSTRUCTION PROCESS
- 7. Contractor is responsible for furnishing all materials, tools, equipment, labor, and plants 16. NECESSARY FOR PROPER PLANTING AND INSTALLATION OF ALL LANDSCAPE MATERIAL.

- 8. QUANTITIES ON PLANT MATERIALS LIST ARE FOR CONVENIENCE OF BIDDING ONLY. CONTRACTOR IS responsible for all plants shown on landscape plans and coverage of all areas DELINEATED. THE PLANS ARE TO SUPERSEDE THE PLANT LIST IN ALL CASES. CONTRACTOR IS RESPONSIBLE FOR ALL ESTIMATING AND BIDDING, ALL AREAS, QUANTITIES MATERIALS
 - SHOULD BE FIELD VERIFIED WITH SITE CONDITIONS. WHERE DISCREPANCIES OCCUR BETWEEN THE LANDSCAPE PLANS AND/OR ARCHITECTURAL AND/OR THE CIVIL DRAWINGS (AND ANY OTHER SITE DRAWINGS) THE DISCREPANCIES MUST BE BROUGHT TO THE
- LANDSCAPE ARCHITECTS ATTENTION FOR COORDINATION AND RESOLUTION. ALL DISEASED, NOXIOUS OR INAPPROPRIATE MATERIALS SHALL BE REMOVED FROM THE PROPOSED SITE PRIOR TO THE START OF CONSTRUCTION AND DURING THE MAINTENANCE PERIOD.
- GENERAL CONTRACTOR SHALL LEAVE THE SITE FREE OF CONSTRUCTION DEBRIS. ALL LAWN AND PLANTING AREAS SHALL SLOPE TO DRAIN A MINIMUM OF 2% UNLESS NOTED OTHERWISE AND REVIEWED WITH OWNER'S REPRESENTATIVE FOR FINAL APPROVAL.
- FINISH GRADES FOR SHRUB AND GROUND COVER AREAS SHALL BE HELD 1" BELOW TOP OF ADJACENT PAVEMENTS AND CURBS, UNLESS NOTED OTHERWISE ON THE PLANS. REFER TO LSP1.2 FOR FURTHER
- ALL PERENNIAL, ANNUAL AND GROUND COVER AREAS TO RECEIVE A BLEND OF ORGANIC SOIL AMENDMENTS PRIOR TO PLANTING. TILL THE FOLLOWING MATERIALS INTO EXISTING TOPSOIL TO A DEPTH OF APPROXIMATELY 8". A DEPTH OF 12" IN TREE PITS. PROPORTIONS AND QUANTITIES MAY REQUIRE ADJUSTMENT DEPENDING ON THE CONDITION OF EXISTING SOIL. REFER TO LSP1.2 FOR FURTHER INFORMATION.
 - PER EVERY 100 SQUARE FEET ADD: -ONE - 2 CUBIC FOOT BALE OF PEAT MOSS, -2 POUNDS OF 5-10-5 GARDEN FERTILIZER,

-1/4 CUBIC YARD OF COMPOSTED MANURE,

CLAY AND STONES. REFER TO LSP1.2 FOR FURTHER INFORMATION.

PLANT STARTER OR OTHER COMPOSTED, ORGANIC MATERIAL, ALL SHRUBS TO BE POCKET PLANTED WITH A 50/50 MIX OF PLANT STARTER AND EXISTING SOIL. INSTALL TOPSOIL INTO ALL BEDS AS NEEDED TO ACHIEVE PROPER GRADE. REMOVE ALL EXCESSIVE GRAVEL,

- 17. PLANT ALL TREES SLIGHTLY HIGHER THAN FINISHED GRADE AT ROOT FLARE. BACK FILL HOLE WITH 2/3 EXISTING TOPSOIL AND 1/3 PEAT MOSS. AVOID ANY AIR POCKETS. DISCARD ANY GRAVEL CLAY OR STONES. REFER TO LSP1.2 FOR FURTHER INFORMATION.
- 18. ALL TREES TO BE INSTALLED, STAKED AND GUYED ACCORDING TO DETAILS. REFER TO LSP1.2 FOR FURTHER INFORMATION.
- 19. PROVIDE A 4'-0" 5'-0" DIAMETER MULCH RING ALL LAWN TREES.
- 20. ALL PLANTINGS TO BE WATERED AT THE TIME OF PLANTING, THROUGHOUT CONSTRUCTION AND UPON COMPLETION OF PROJECT AS REQUIRED.
- WHERE SPECIFIED, ALL PLANT BEDS, PITS AND TREE RINGS ARE TO RECEIVE A MINIMUM OF 2'-3" DRESSING OF SHREDDED HARDWOOD OAK BARK MULCH SHAVINGS (OR BROWN ENVIRO-MULCH) FREE OF GROWTH, WEEDS, FOREIGN MATTER DETRIMENTAL TO PLANT LIFE OR GERMINATION INHIBITING INGREDIENTS. LANDSCAPE CONTRACTOR TO PROVIDE A SAMPLE TO OWNER FOR APPROVAL. CONTRACTOR TO TAKE CARE WITH INSTALLATION NOT TO DAMAGE OR COVER PLANTS. REFER TO LSP1.2 FOR FURTHER INFORMATION.
- 22. LAWN INSTALLATION: CONTRACTOR TO FURNISH AND PREPARE TOPSOIL (3" MIN) AND SEED BED (REMOVE ALL STONES 1" OR LARGER), APPLY STARTER FERTILIZER AND SEED UNIFORMLY. PROVIDE A MULCH COVERING SUITABLE TO GERMINATE AND ESTABLISH TURF. EROSION CONTROL MESH SHOULD BE USED IN SWALES AND STEEP GRADES WHERE APPLICABLE. METHODS OF INSTALLATION MAY VARY AT THE DISCRETION OF CONTRACTOR. IT IS HIS/HER RESPONSIBILITY TO ESTABLISH AND GUARANTEE A SMOOTH, UNIFORM, QUALITY TURF. IF STRAW MULCH IS USED AS A COVERING, A TACKIFIER MAY BE NECESSARY TO AVOID WIND DAMAGE.

RECOMMENDED SEED MIX: PREMIUM 60 GRASS SEED MIX REINDER'S (262) 786-3300

10% FIESTA III PERENNIAL RYE GRASS

20% AMERICAN KENTUCKY BLUE GRASS 20% ALPINE KENTUCKY BLUE GRASS 20% LANGARA KENTUCKY BLUE GRASS 20% VICTORY CHEWINGS FESCUE

10% CUTTER PERENNIAL RYE GRASS APPLY AT A RATE OF 175 POUNDS PER ACRE. REFER TO SUPPLIERS SPECIFICATIONS AND INSTALLATION CUT SHEETS FOR FURTHER INFORMATION

- 24. DURING THE INITIAL "30 DAY MAINTENANCE PERIOD" THE LANDSCAPE CONTRACTOR IS REQUIRED TO PROVIDE AND ON-GOING PLEASANT VISUAL ENVIRONMENT WHEREAS ANY PLANT WHICH IS NOT RESPONDING TO TRANSPLANTING OR THRIVING SHALL IMMEDIATELY BE REPLACED. NEW LAWNS SHALL WATERED AND REPAIRED AND WEEDS MUST CONSTANTLY BE REMOVED, NO EXCEPTIONS WILL BE GRANTED.
- 25. LANDSCAPE / SITE DEMOLITION CONTRACTOR TO VERIFY LOCATIONS OF EXISTING TREES AND SHRUBS BE SALVAGED AND CLEARLY TAG THEM WITH MARKING TAPE AND CONSTRUCTION FENCE.

TO OBTAIN LOCATION OF PARTICIPANT'S UNDERGROUND FACILITIES BEFORE YOU DIG IN WISCONSIN WISCONSIN STATUTE 182.0175 (1974) REQUIRES A MINIMUM OF 3 DAYS NOTICE BEFORE YOU EXCAVATE

(NOT INCLUDING SATURDAY, SUNDAY OR LEGAL HOLIDAYS)

UNDERGROUND SEWER AND UTILITY INFORMATION AS SHOWN IS OBTAINED FROM THE RECORDS OF

CERTIFIED TO. THE LOCATIONS OF EXISTING UTILITY INSTALLATIONS AS SHOWN ON THIS SURVEY ARE APPROXIMATE. THERE MAY BE OTHER UNDERGROUND UTILITY INSTALLATIONS WITHIN THE PROJECT AREA THAT ARE NOT SHOWN.

MUNICIPALITY AND LOCAL UTILITY COMPANIES. THE

TO OBTAIN LOCATION OF PARTICIPANT'S UNDERGROUND FACILITIES BEFORE YOU DIG IN ACCURACY OF WHICH CAN NOT BE GUARANTEED OR WISCONIN CALL THE MILWAUKEE UTILITY ALERT NETWORK <u>(800)-242-8511</u>, (262) 432-7910 (877) 500-9592 www.Diggershotline.com



LANDSCAPE Landscape Architecture

11525 W. North Avenue Suite 1B Wauwatosa, WI 53226 Tel (414) 476-1204 www.insitelandscape.com mdavis@insitelandscape.com

and Master Planning Design Consulting

<u>Project:</u>

SUNSET REDEVELOPMENT

120 E. Sunset Drive Waukesha, WI

Issuance and Revisions:

|Number | Description

07/31/13

09/10/13

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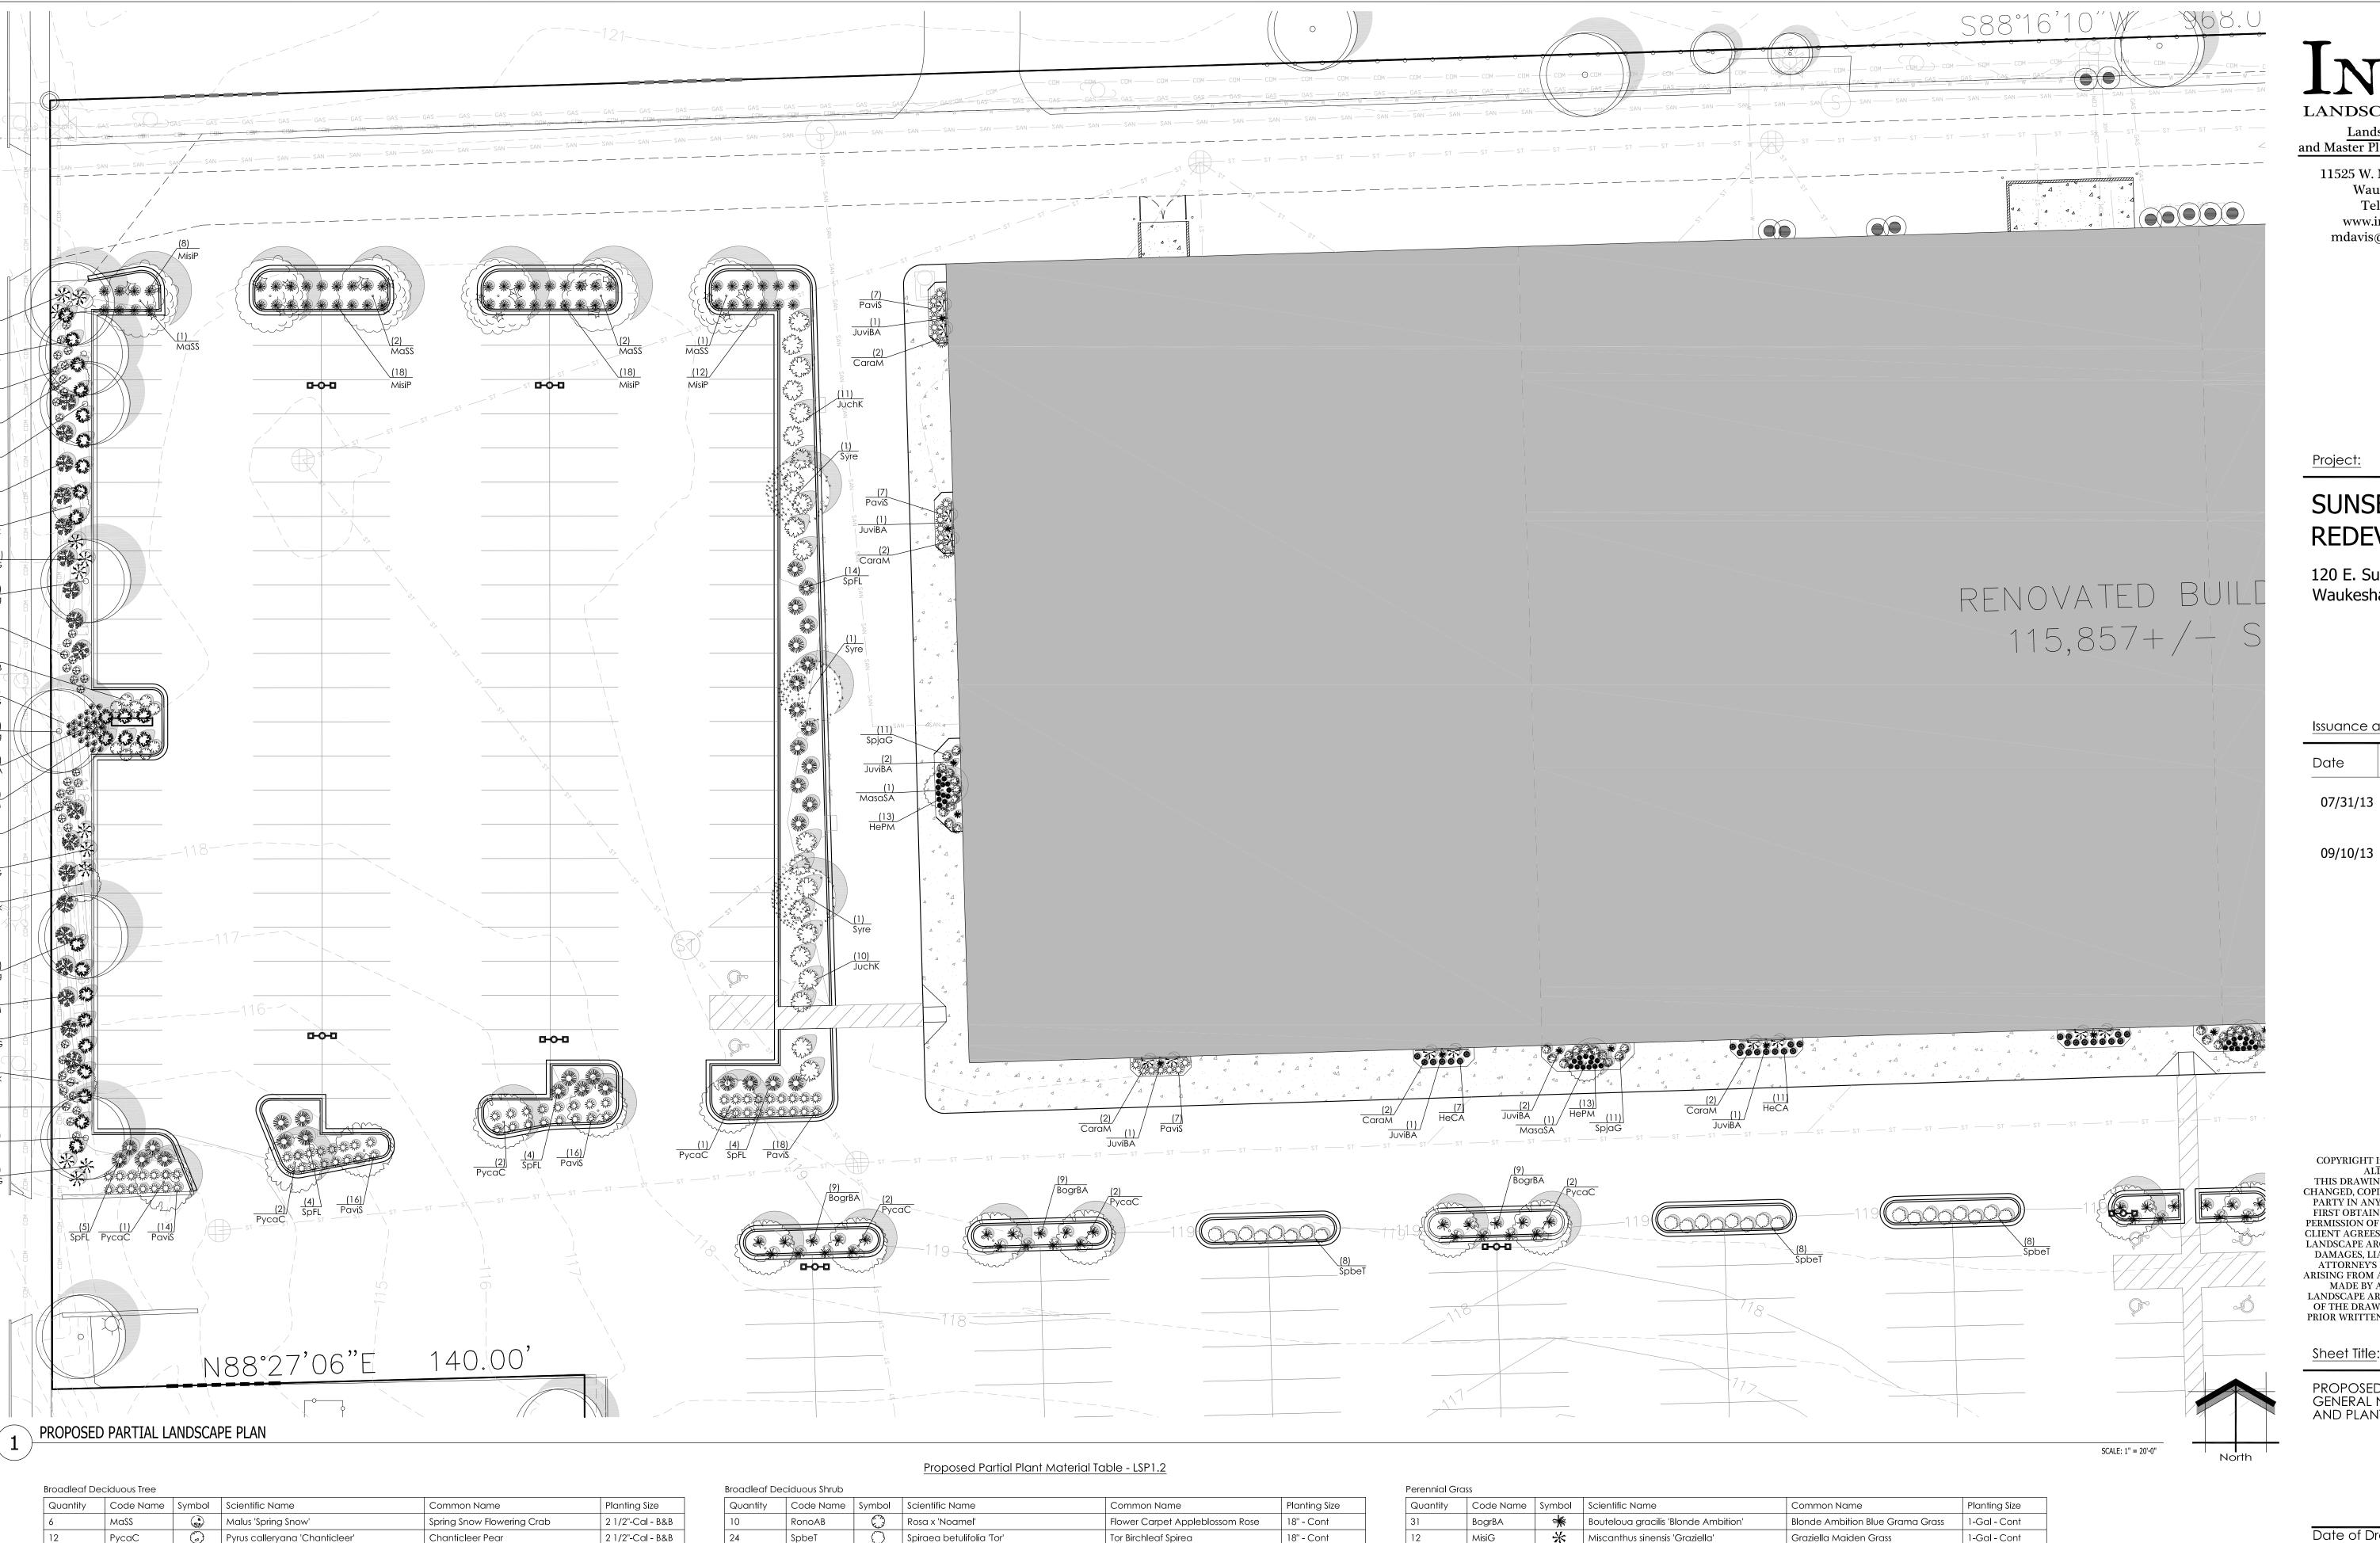
PRIOR WRITTEN CONSENT OF THE LANDSCAPE ARCHITECT.

<u>Sheet Title:</u>

PROPOSED LANDSCAPE PLAN, GENERAL NOTES, AND PLANT MATERIAL TABLE

Date of Drawing:	09/10
Scale:	1'' = 40
Drawn By:	M
Job Number:	L13-(

Sheet Number:



Landscape Architecture and Master Planning Design Consulting

11525 W. North Avenue Suite 1B Wauwatosa, WI 53226 Tel (414) 476-1204 www.insitelandscape.com mdavis@insitelandscape.com

SUNSET REDEVELOPMENT

120 E. Sunset Drive Waukesha, WI

Issuance and Revisions:

Number Description

Submittal

09/10/13

Commission Re-Submittal

Plan Commission

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<u>Sheet Title</u>:

PROPOSED LANDSCAPE PLAN, GENERAL NOTES, AND PLANT MATERIAL TABLE

Date of Drawing:	09/10/13
Scale:	1" = 20'-0"
Drawn By:	MCD
Job Number:	L13-064

Sheet Number:

Broadleat Dec	ciduous Shrub				
Quantity	Code Name	Symbol	Scientific Name	Common Name	Planting Size
10	RonoAB	0	Rosa x 'Noamel'	Flower Carpet Appleblossom Rose	18" - Cont
24	SpbeT	\bigcirc	Spiraea betulifolia 'Tor'	Tor Birchleaf Spirea	18" - Cont
22	SpjaG	33,25	Spiraea japonica 'Galen'	Double Play Artist Spirea	18" - Cont
32	SpFL		Spiraea x 'Fire Light'	Fire Light Spirea	18" - Cont
18	WeflM	#	Weigela florida 'Minuet'	Minuet Weigela	18" - 24"- Cont
Conifer Evergr	een Shrub				
Quantity	Code Name	Symbol	Scientific Name	Common Name	Planting Size
21	JuchK	24.V24	Juniperus chinensis 'Kallay's Comapact'	Kallay's Comapact Juniper	18" - 24" - B&B
24	JupfSG	(1)	Juniperus x pfizeriana 'MonSan'	Sea of Gold Juniper	18" - 24" - B&B
Broadleaf Dec	ciduous Vine				
Quantity	Code Name	Symbol	Scientific Name	Common Name	Planting Size

Campsis radicans 'Monbal'

Balboa Sunset Trumpet Creeper

2 1/2"-Cal - B&B

Planting Size

2"-Cal - B&B

2"-Cal - B&B

Planting Size

5' - 6' - B&B

Existing

Ivory Silk tree lilac

Common Name

Firebird Crabapple

Common Name

Adirondack Flowering Crab

Existing

Syringa reticulata

Malus "Adirondack"

Malus sargentii 'Select A'

Juniperus virginiana 'Blue Arrow'

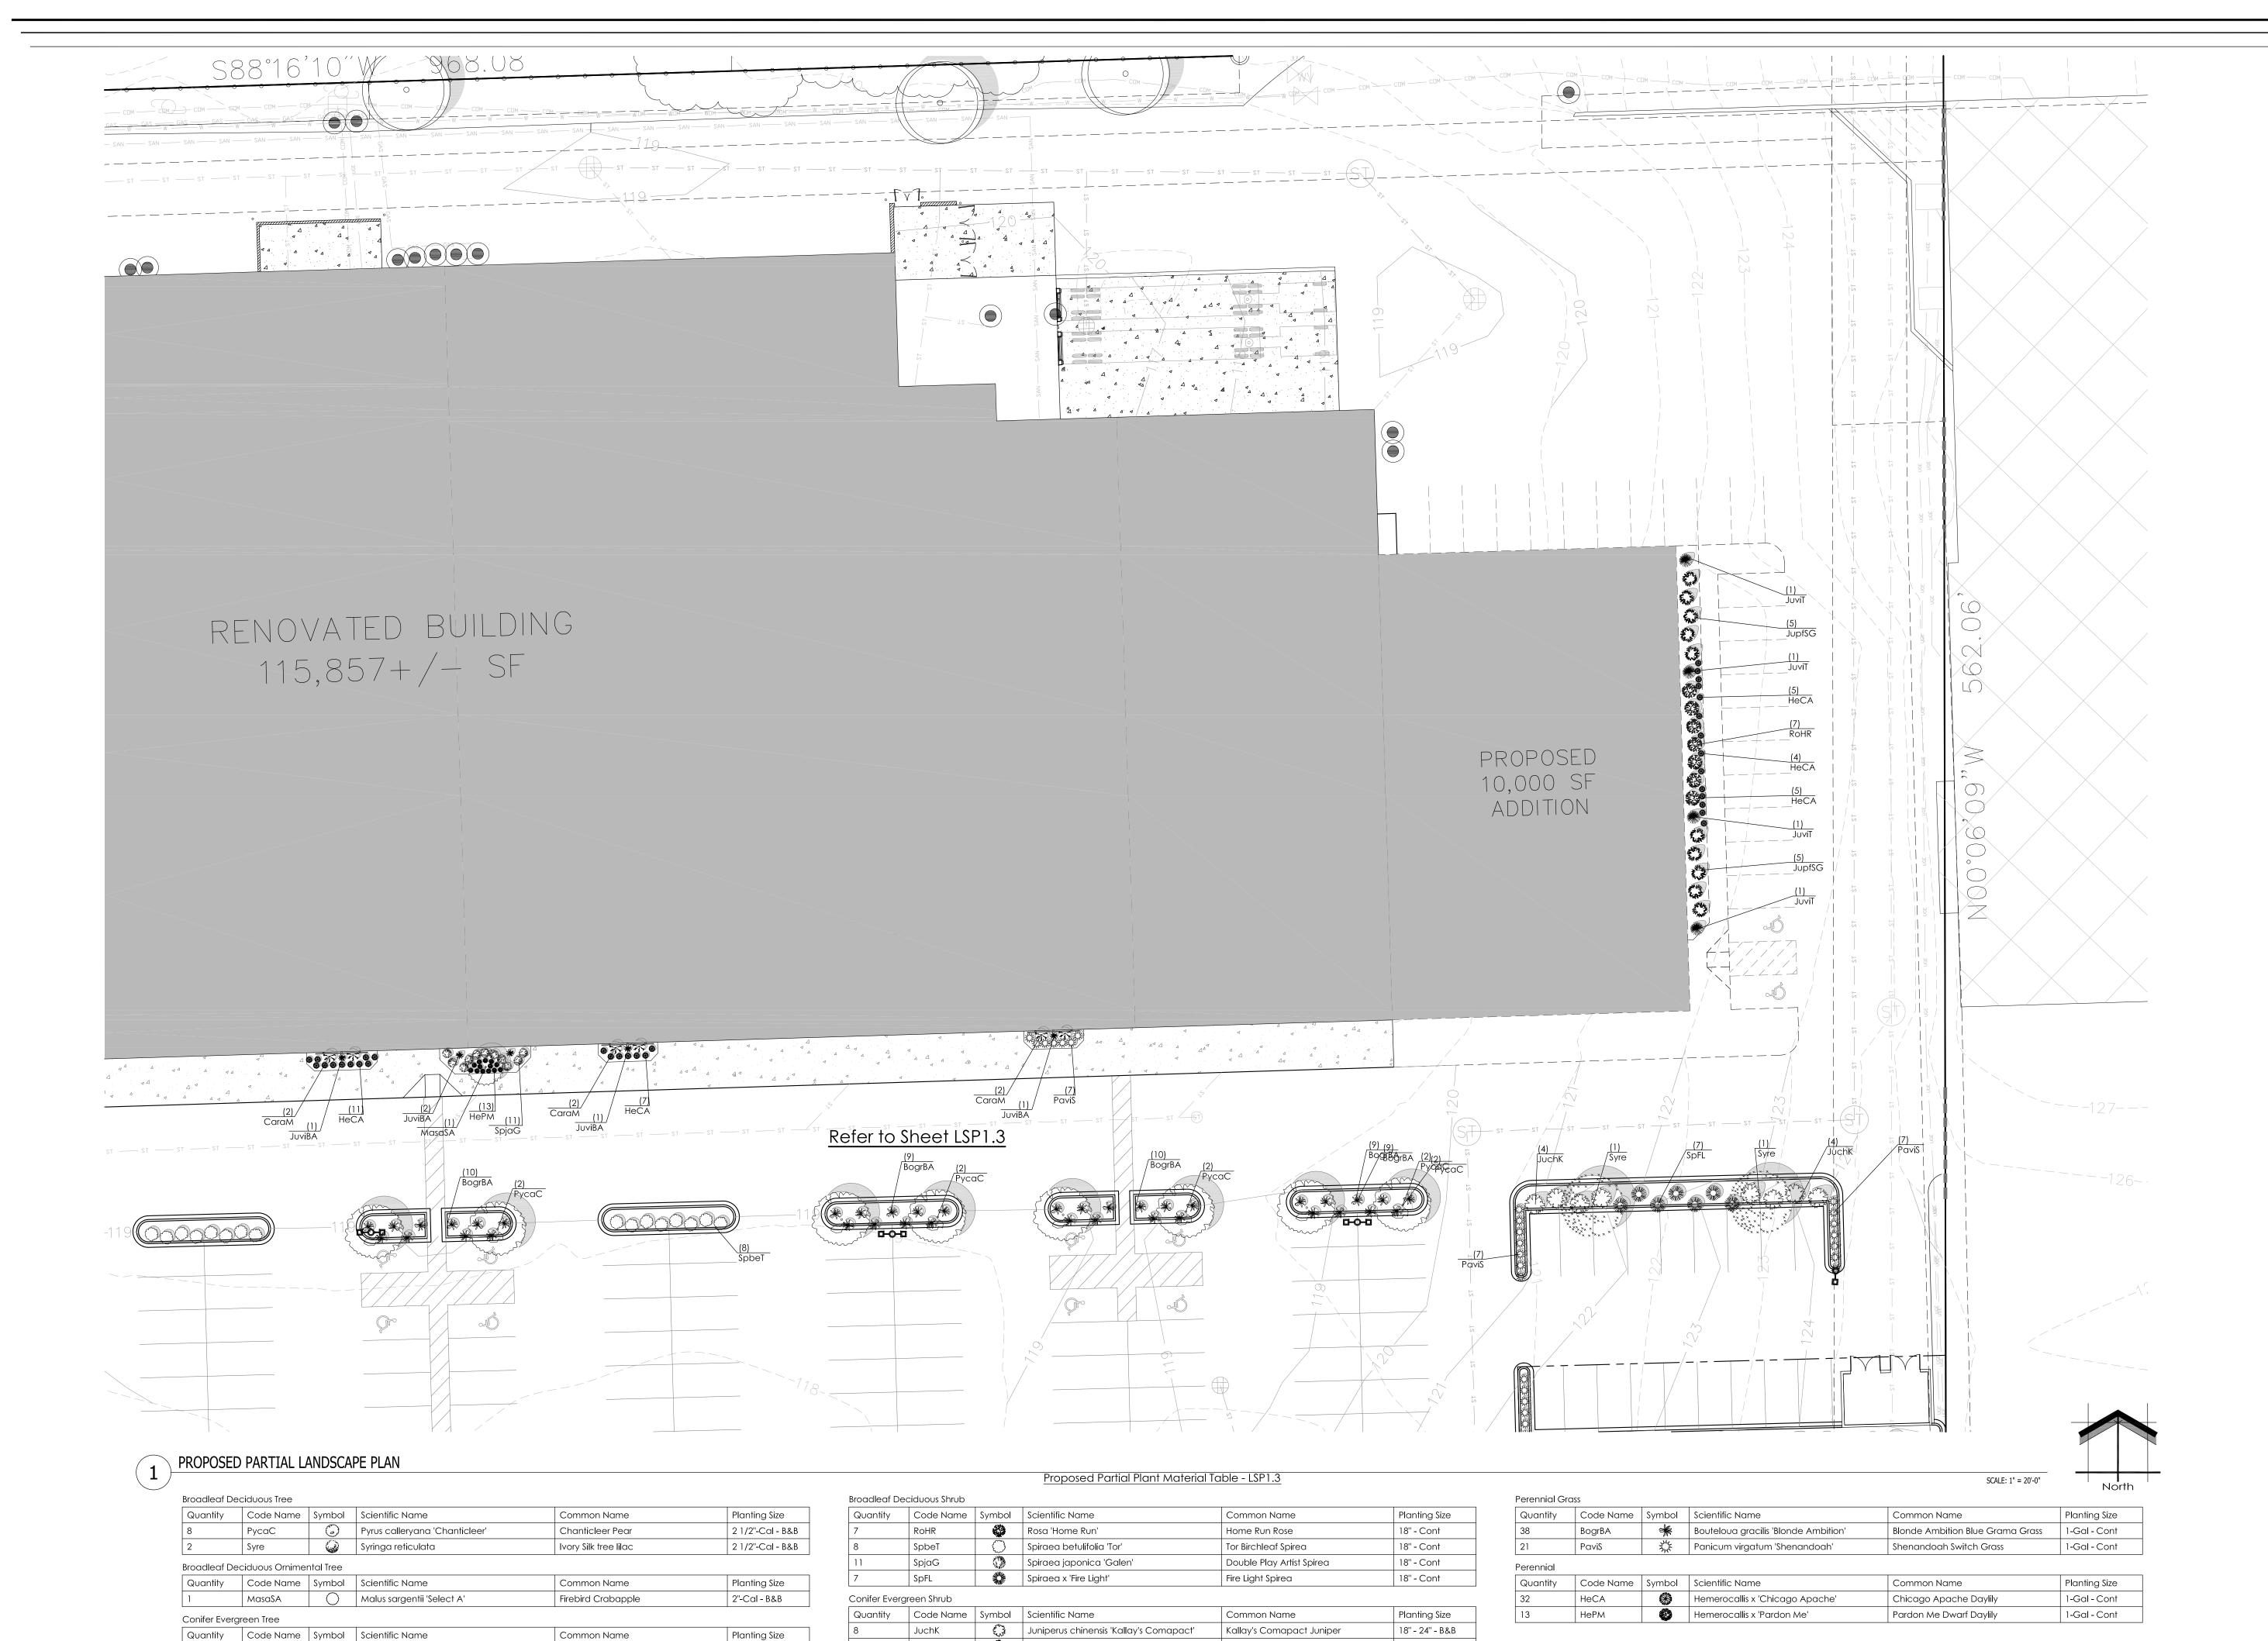
| Code Name | Symbol | Scientific Name

| Code Name | Symbol | Scientific Name

Broadleaf Deciduous Ornimental Tree

Conifer Evergreen Tree

Quantity	Code Name	Symbol	Scientific Name	Common Name	Planting Size
31	BogrBA	*	Bouteloua gracilis 'Blonde Ambition'	Blonde Ambition Blue Grama Grass	1-Gal - Cont
12	MisiG	*	Miscanthus sinensis 'Graziella'	Graziella Maiden Grass	1-Gal - Cont
56	MisiP	*	Miscanthus sinensis 'Purpuracens'	Purple Silver Grass	1-Gal - Cont
85	PaviS	ZW.	Panicum virgatum 'Shenandoah'	Shenandoah Switch Grass	1-Gal - Cont
	Carla Nava	Cls al	C-ikG- NI	Common Name	Diametica e Cia
	Code Name	Symbol	Scientific Name	Common Name	Planting Size
	Code Name HeAJ	Symbol	Scientific Name Hemerocallis x 'Alabama Jubilee'	Common Name Alabama Jubilee Daylily	Planting Size 1-Gal - Cont
Perennial Quantity 40 18		<u>'</u>			
Quantity 40	HeAJ	⊗	Hemerocallis x 'Alabama Jubilee'	Alabama Jubilee Daylily	1-Gal - Cont



JupfSG

Code Name | Symbol | Scientific Name

Broadleaf Deciduous Vine

Juniperus virginiana 'Blue Arrow'

juniperus virginiana taylor

Blue Arrow Juniper

Taylor Redcedar

5' - 6' - B&B

5' - 6' - B&B

JuviBA

Juniperus x pfizeriana 'MonSan'

Campsis radicans 'Monbal'

18" - B&B

Planting Size

3' - 4' - B&B

Sea of Gold Juniper

Common Name

Balboa Sunset Trumpet Creeper

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Projec

SUNSET REDEVELOPMENT

120 E. Sunset Drive Waukesha, WI

Issuance and Revisions:

Date Number Description

07/31/13 Plan Commission Submittal

09/10/13

Commission Re-Submittal

Re-Submittai

Revisions for Plan

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Sheet Title:

PROPOSED LANDSCAPE PLAN, GENERAL NOTES, AND PLANT MATERIAL TABLE

Date of Drawing:	09/10/13
Scale:	1" = 20'-0'
Drawn By:	MCD
Job Number:	L13-064

Sheet Number:

LSP1.3

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Sheet Title

SCALE: 1" = 20'-0"

PROPOSED LANDSCAPE PLAN, GENERAL NOTES, AND PLANT MATERIAL TABLE

Proposed Partial Plant Material Table - LSP1.4

Broadleaf Deciduous Tree Quantity Code Name Symbol Scientific Name Common Name Planting Size Malus 'Spring Snow' 2 1/2"-Cal - B&B Spring Snow Flowering Crab 2 1/2"-Cal - B&B Pyrus calleryana 'Chanticleer' Chanticleer Pear Existing Existing Extg Broadleaf Deciduous Ornimental Tree Quantity | Code Name | Symbol | Scientific Name Common Name Planting Size Adirondack Flowering Crab Malus "Adirondack" 2"-Cal - B&B Conifer Evergreen Tree Quantity Code Name Symbol Scientific Name Common Name Planting Size Thuja occidentalis 'Holmstrup' Holmstrup Dwarf Arborvitae 5' - 6' - B&B

PROPOSED PARTIAL LANDSCAPE PLAN

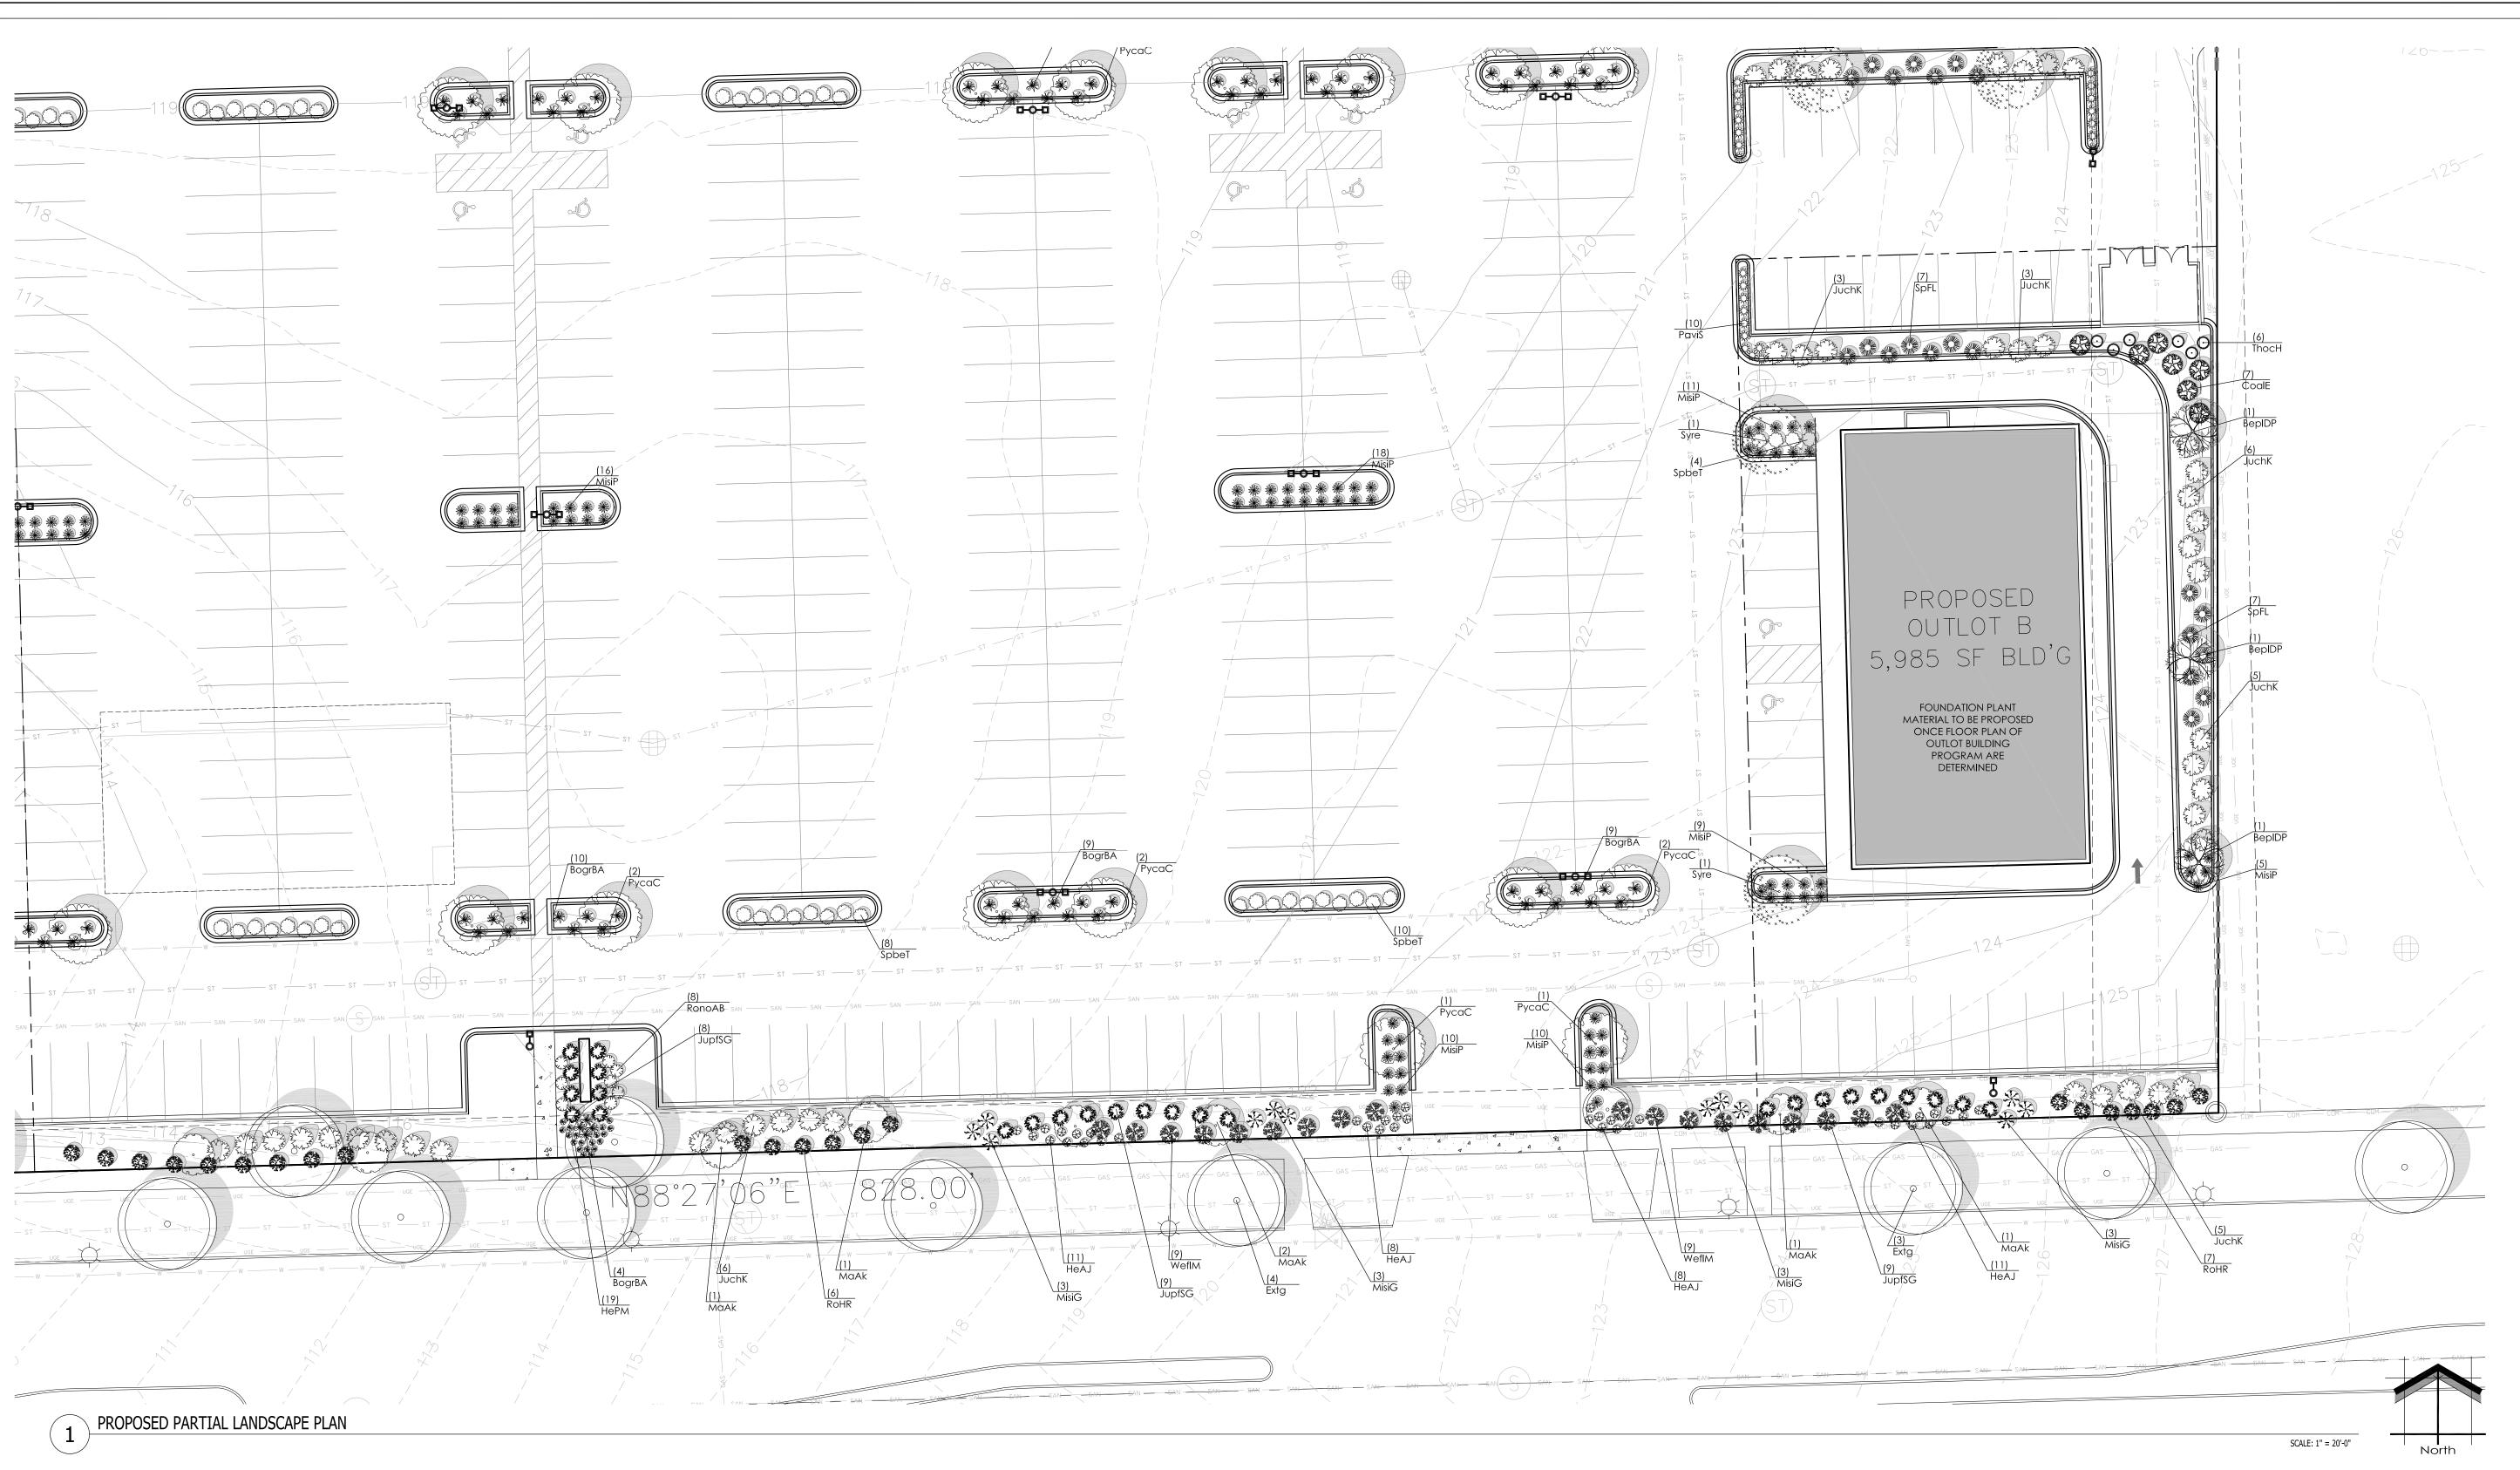
Quantity	Code Name	Symbol	Scientific Name	Common Name	Planting Size
16	RoHR	49	Rosa 'Home Run'	Home Run Rose	18" - Cont
25	SpbeT		Spiraea betulifolia 'Tor'	Tor Birchleaf Spirea	18" - Cont
15	SpFL		Spiraea x 'Fire Light'	Fire Light Spirea	18" - Cont
18	WeflM	*	Weigela florida 'Minuet'	Minuet Weigela	18" - 24"- Cont
Conifer Ever	green Shrub				
Quantity	Code Name	Symbol	Scientific Name	Common Name	Planting Size
14	JuchK	E ALLE	Juniperus chinensis 'Kallay's Comapact'	Kallay's Comapact Juniper	18" - 24" - B&B
18	JupfSG	2	Juniperus x pfizeriana 'MonSan'	Sea of Gold Juniper	18" - 24" - B&B

Quantity	Code Name	Symbol	Scientific Name	Common Name	Planting Size
18	BogrBA	*	Bouteloua gracilis 'Blonde Ambition'	Blonde Ambition Blue Grama Grass	1-Gal - Con
12	MisiG	*	Miscanthus sinensis 'Graziella'	Graziella Maiden Grass	1-Gal - Con
44	MisiP	*	Miscanthus sinensis 'Purpuracens'	Purple Silver Grass	1-Gal - Con
41	PaviS	ZW.	Panicum virgatum 'Shenandoah'	Shenandoah Switch Grass	1-Gal - Con
Perennial		1			
Quantity	Code Name	Symbol	Scientific Name	Common Name	Planting Size
38	HeAJ	(X)	Hemerocallis x 'Alabama Jubilee'	Alabama Jubilee Daylily	1-Gal - Con

Date of Drawing:	09/10/13
Scale:	1" = 20'-0"
Drawn By:	MCD
Job Number:	L13-064

LSP1.4

Sheet Number:



Quantity	Code Name	Symbol	Scientific Name	Common Name	Planting Size
3	BepIDP	₩	Betula platyphylla 'Dakota Pinnacle'	Dakota Pinnacle Birch	2 1/2"-Cal - B&B
8	PycaC	0	Pyrus calleryana 'Chanticleer'	Chanticleer Pear	2 1/2"-Cal - B&B
2	Syre	0	Syringa reticulata	Ivory Silk tree lilac	2 1/2"-Cal - B&B
7	Extg	0	Existing	Existing	Existing
Broadleaf D	eciduous Ornime	ntal Tree			
Quantity	Code Name	Symbol	Scientific Name	Common Name	Planting Size
6	MaAk	0	Malus "Adirondack"	Adirondack Flowering Crab	2"-Cal - B&B
Conifer Ever	green Tree				
		Cymala al	Scientific Name	Common Name	Planting Size
Quantity	Code Name	Symbol	3clerillic Name	Common Name	i idining size

Proposed Partial Plant Material Table - LSP1.5

Quantity	Code Name	Symbol	Scientific Name Common Name		Planting Size
7	CoalE	&	Cornus alba 'Elegantissima'	Variegated red twig dogwood	1-Gal - Cont
13	RoHR	4	Rosa 'Home Run'	Home Run Rose	18" - Cont
8	RonoAB	0	Rosa x 'Noamel'	Flower Carpet Appleblossom Rose	18" - Cont
22	SpbeT		Spiraea betulifolia 'Tor'	Tor Birchleaf Spirea	18" - Cont
14	SpFL		Spiraea x 'Fire Light'	Fire Light Spirea	18" - Cont
18	WeflM	*	Weigela florida 'Minuet'	Minuet Weigela	18" - 24"- Cont
Conifer Ever	green Shrub				
Quantity	Code Name	Symbol	Scientific Name	Common Name	Planting Size
28	JuchK	E CAN	Juniperus chinensis 'Kallay's Comapact'	Kallay's Comapact Juniper	18" - 24" - B&B
26	JupfSG		Juniperus x pfizeriana 'MonSan' Sea of Gold Juniper		18" - 24" - B&B

Perennial Gras	SS		
Quantity	Code Name	Symbol	Scientific Name
32	BoarB A	*	Routeloua aracilis

32	BogrBA	**	Bouteloua gracilis 'Blonde Ambition'	Blonde Ambition Blue Grama Grass	1-Gal - Cont		
12	MisiG	*	Miscanthus sinensis 'Graziella'	Graziella Maiden Grass	1-Gal - Cont		
78	MisiP	*	Miscanthus sinensis 'Purpuracens'	Purple Silver Grass	1-Gal - Cont		
10	PaviS	ZW.	Panicum virgatum 'Shenandoah'	Shenandoah Switch Grass	1-Gal - Cont		
Perennial Perennial							
Quantity	Code Name	Symbol	Scientific Name	Common Name	Planting Size		
38	HeAJ	673	Llama ara a cilia y 'Alcila cina ci lubila al	Alabama Jubilee Daylily	1 C! C+		
	Пемл		Hemerocallis x 'Alabama Jubilee'	Alabama Jubilee Dayiliy	1-Gal - Cont		

Common Name

Planting Size

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<u>Project:</u>

SUNSET REDEVELOPMENT

120 E. Sunset Drive Waukesha, WI

<u>Issuance and Revisions:</u>

Date Number Description

07/31/13

09/10/13

Revisions for Plan Commission Re-Submittal

Plan Commission Submittal

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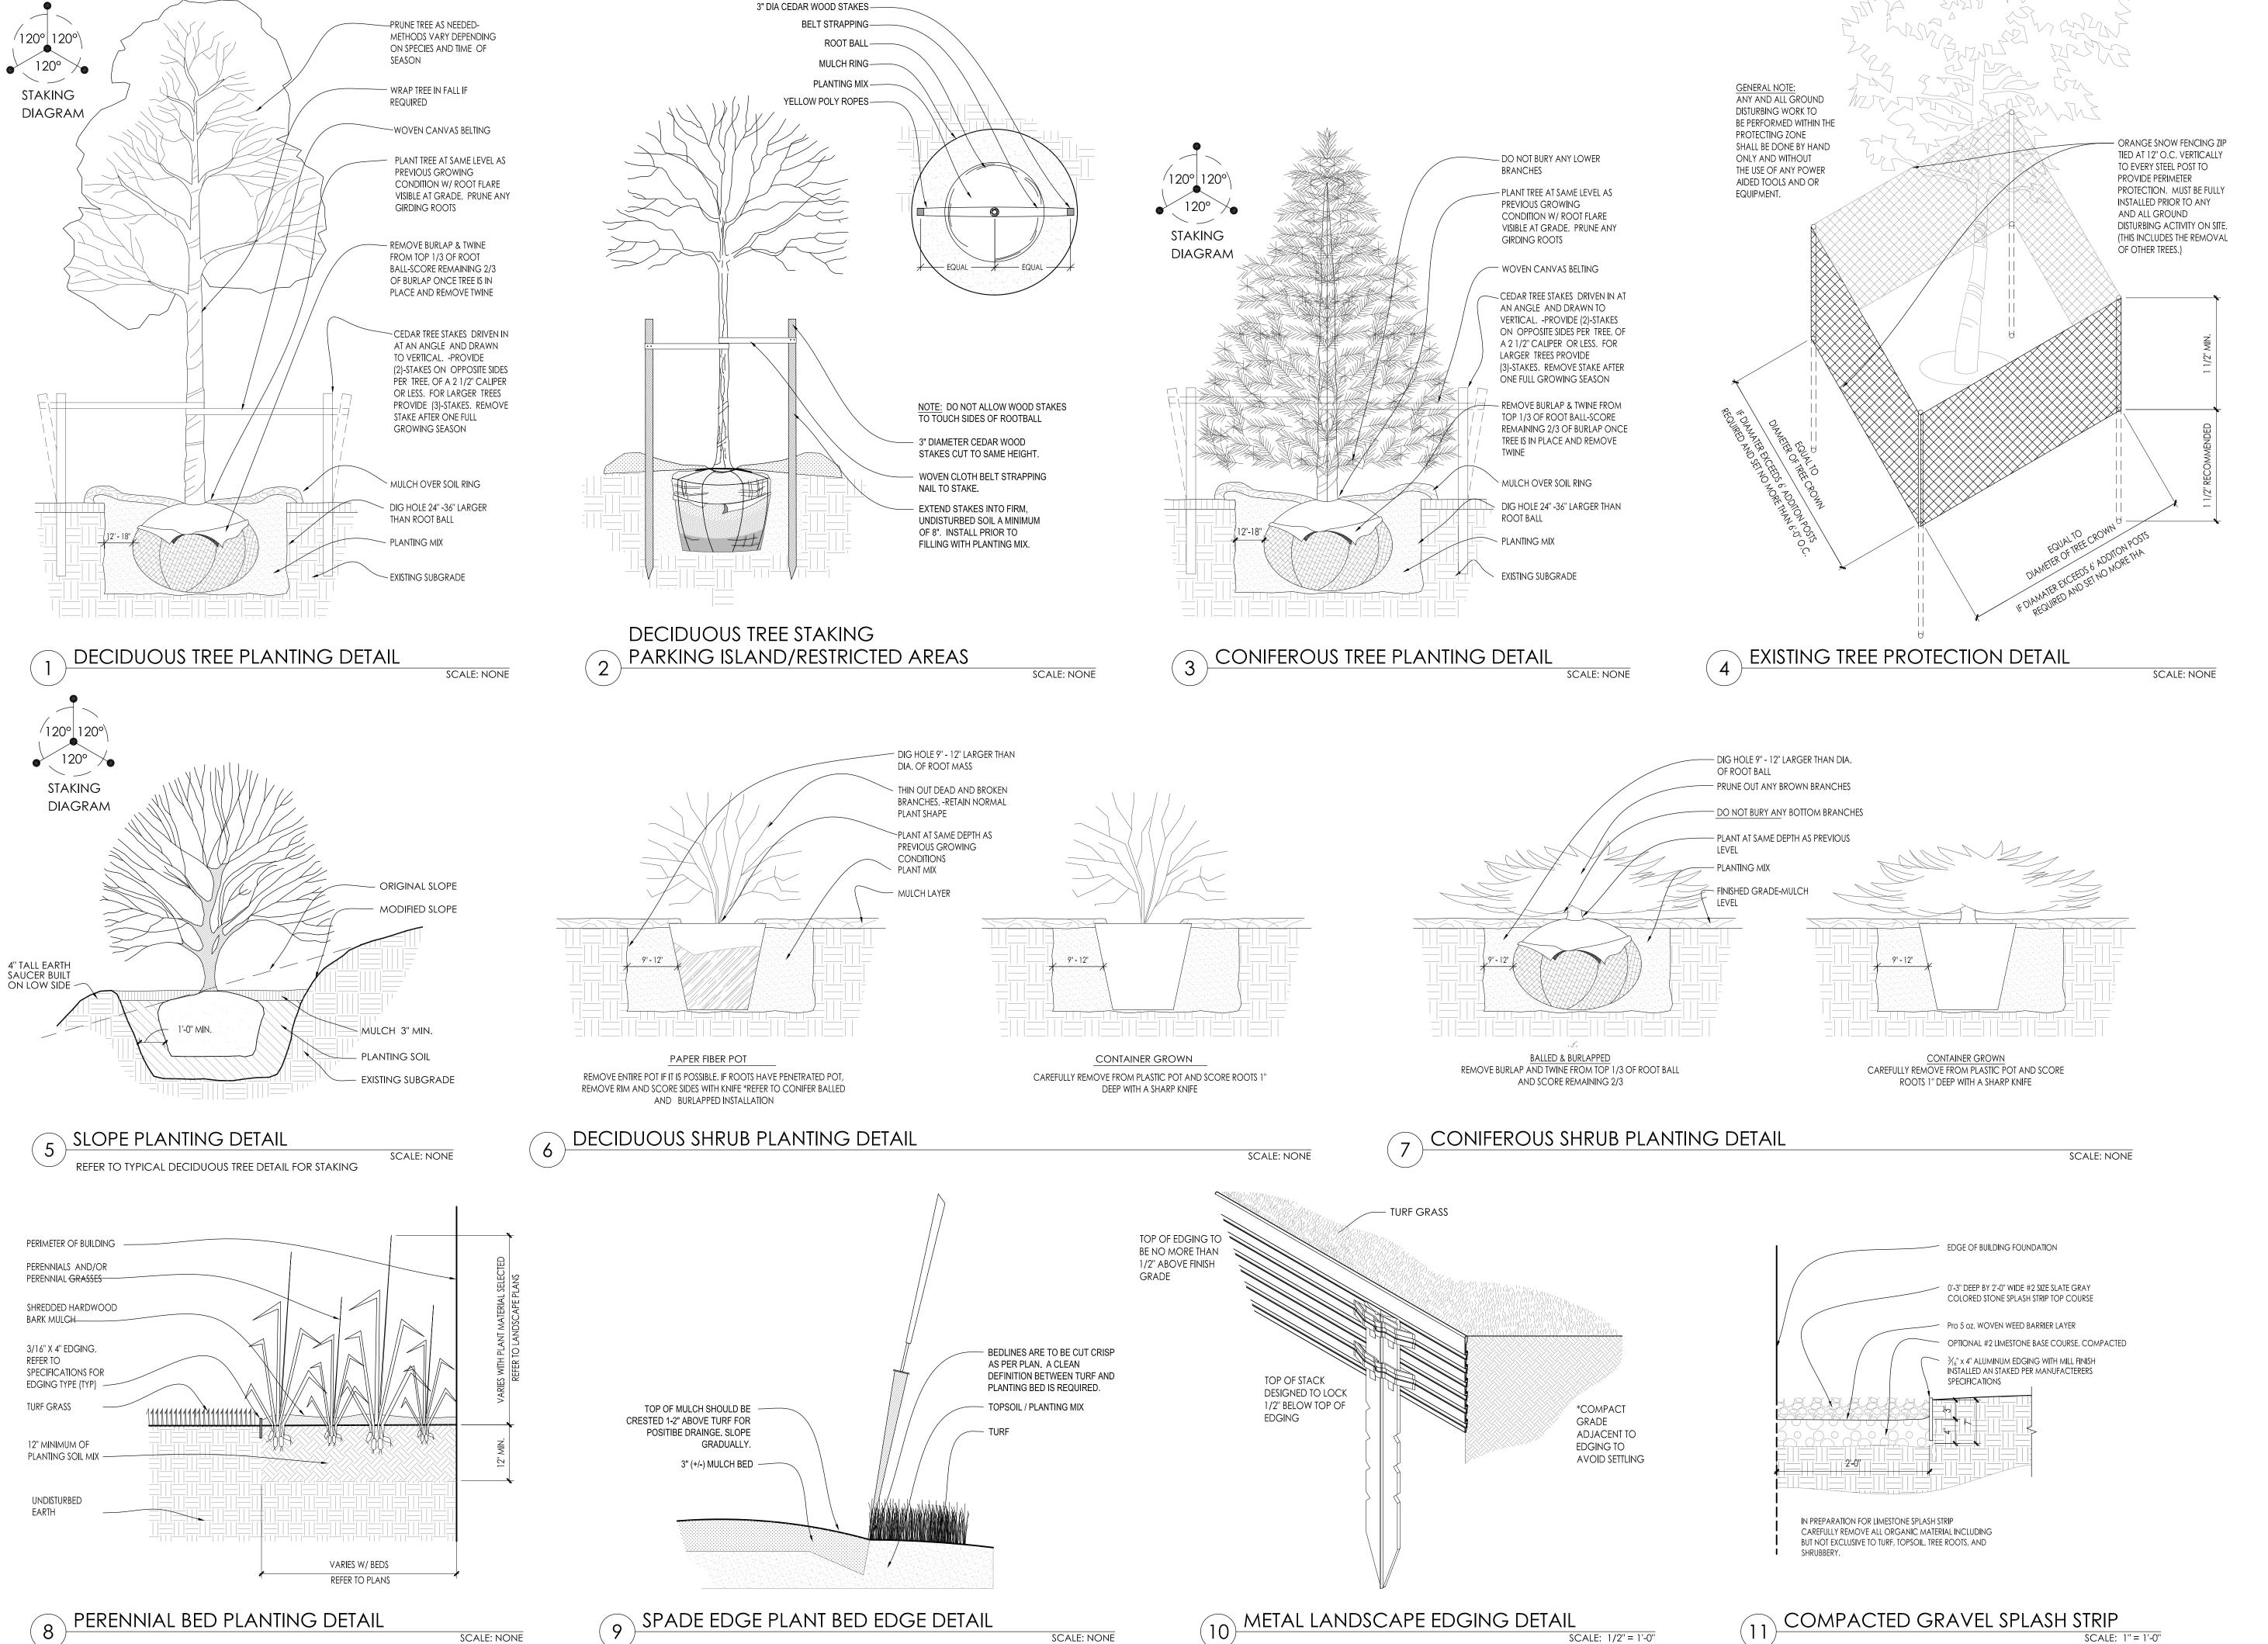
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PROPOSED LANDSCAPE PLAN, GENERAL NOTES, AND PLANT MATERIAL TABLE

Date of Drawing:	09/10/13
Scale:	1'' = 20'-0'
Drawn By:	MCD
Job Number:	1 13-06/

Sheet Number:

LSP1.5



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120 E. Sunset Drive Waukesha, WI

Issuance and Revisions:

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09/10/13

Commission Re-Submittal

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<u>Sheet Title:</u>

PROPOSED LANDSCAPE PLAN, PLANTING DETAILS

Date of Drawing:	09/10/13
Scale:	As Noted
Drawn By:	MCD
Job Number:	L13 - 064

Sheet Number:

LSP1.6

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CAST-IN-PLACE CONC. BASE

- INSTALL (4) 5/8" DIA. REINFORCING RODS, SPACE 5" FROM ANCHOR
BOLTS. MAINTAIN 1 1/2" min
CONC. COVER ON SIDES,

BOTTOM & TOP. — EXTEND CONDUIT MIN. 24" INTO

TRENCH, DIRECT BURY ELEC. FEED OR PROVIDE CONDUIT PER LOCAL

- 5/8"x 10'-0"COPPER GROUND ROD

CAST CONCRETE BASE.

PROPOSED PHOTOMETRIC LIGHT LEVEL CALCULATIONS PLAN, GENERAL NOTES,

Date of Drawing:	09/10/13
Scale:	1" = 40'-0"
Drawn By:	MCD
Job Number:	L13-064

Sheet Number:

BEST ESTIMATIONS.

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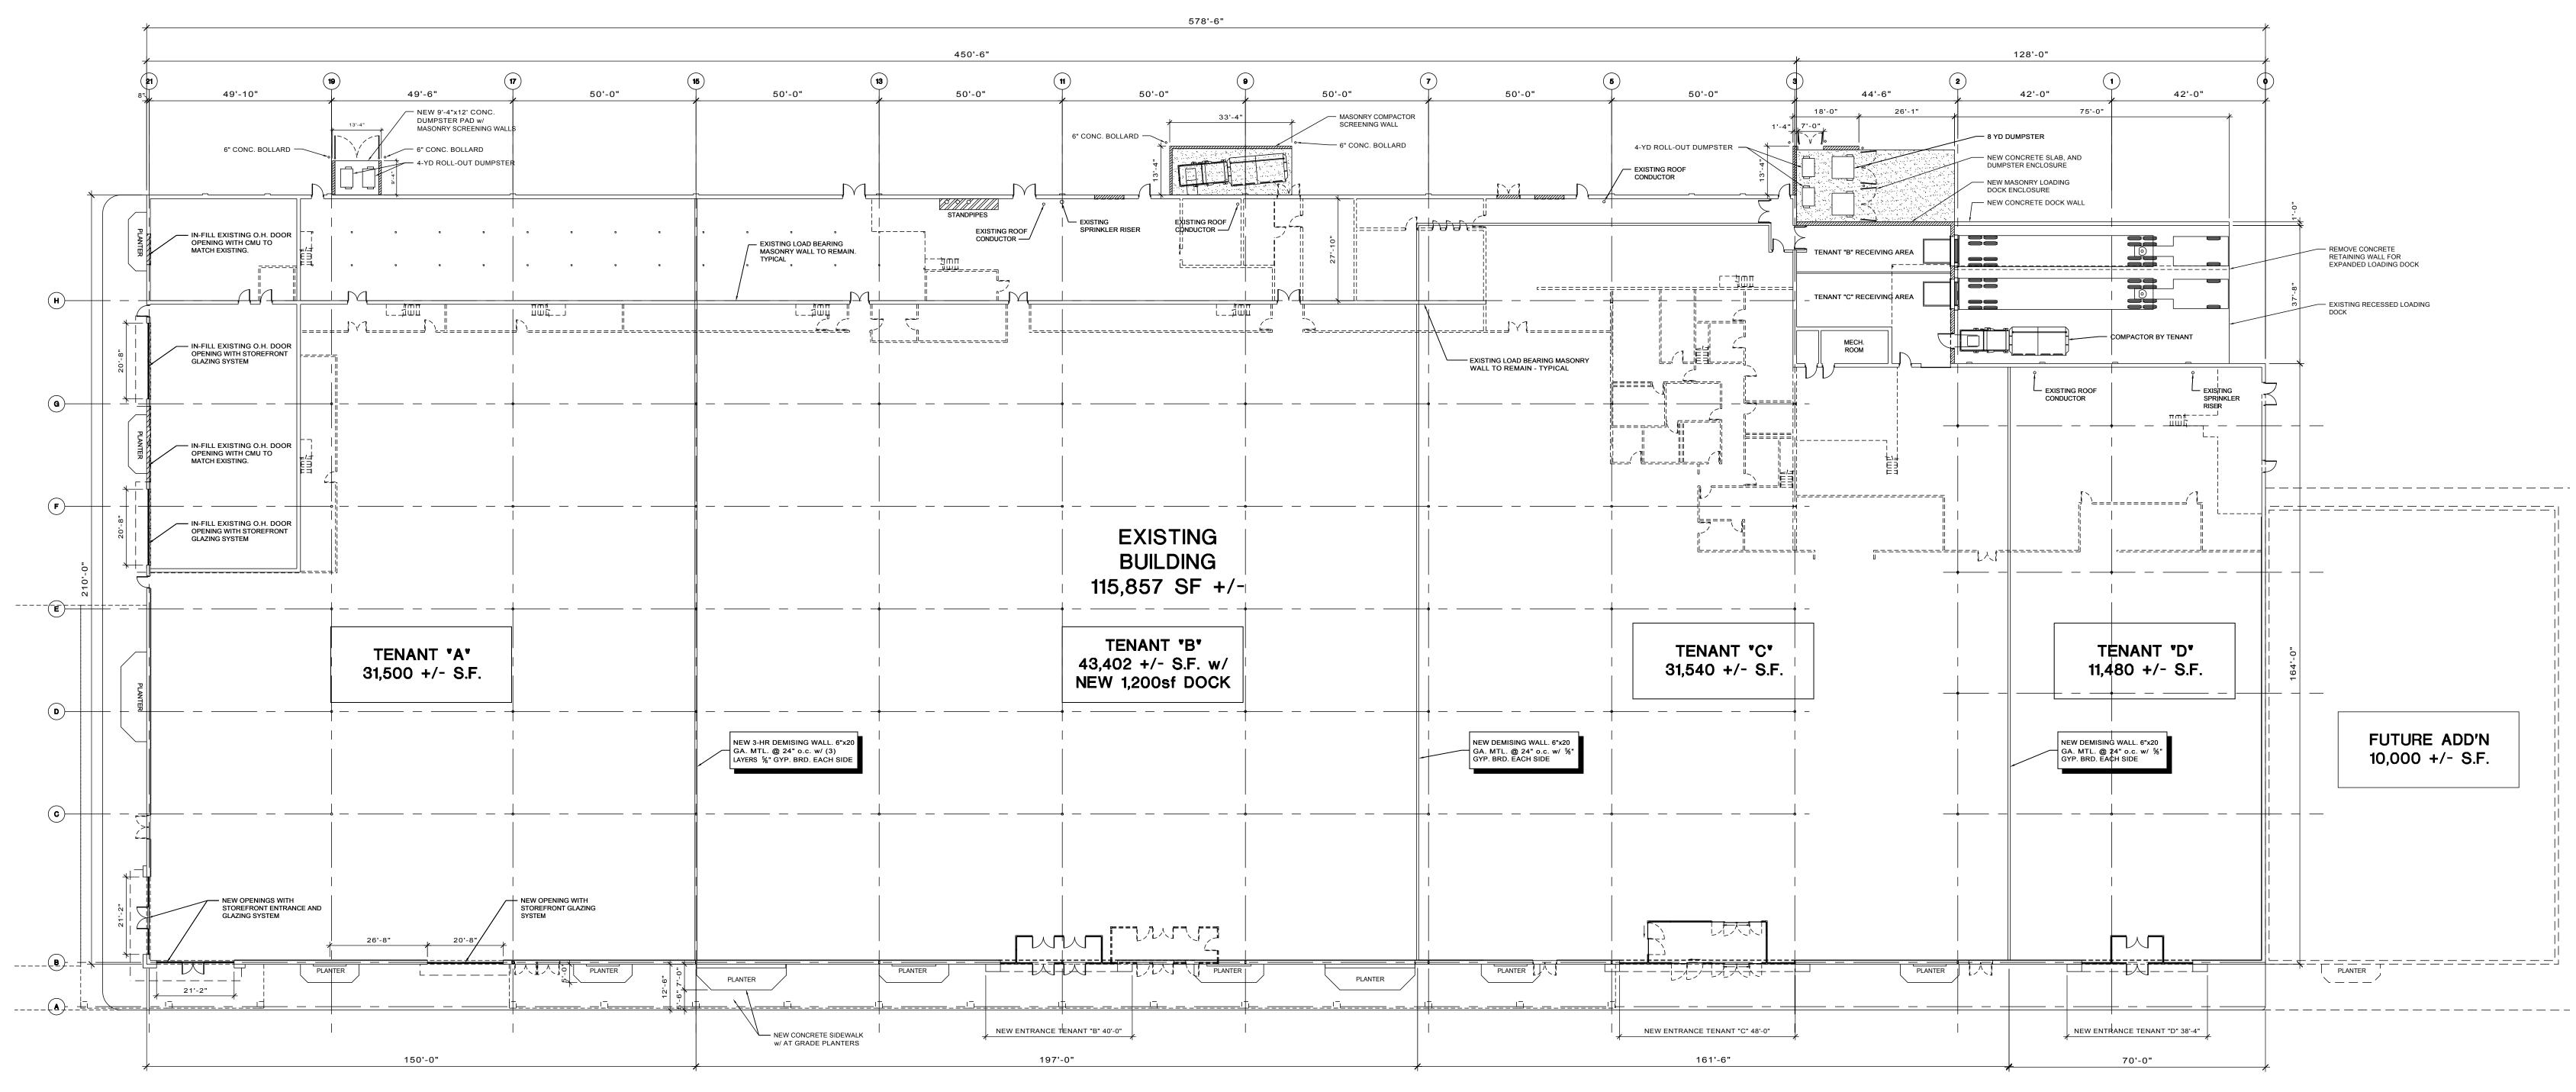
STATISTICS						
Description	Symbol	Avg	Max	Min	Max/Min	Avg/Min
Calc Zone #1	+	2.9 fc	28.6 fc	0.0 fc	N / A	N / A

FOR FURTHER INFORMATION REGARDING FIXTURE PLEASE REFER TO MANUFACTURES CUT SHEETS

MPTR-2S-400 ARCHITECTURAL AREA LUMINAIRE FIXTURE 40000 1.00 452 TYPE III FORWARD THROW w/ 400 W PSMV MPTR-3S-HORIZONTAL BURN & FLAT CLEAR - MOUNTING HEIGHT 20' TEMPERED GLASS LENS & DARK-SKY ON A 4'-0" BASE COMPLIANT HARDWARE HOUSE SIDE SHIELDING IN A BLACK FINISH AND AN OPTIONAL PHOTOCELL CONTROL SOVEREIGN SERIES CANOPY FIXTURE TYPE V 175 w/ PULSE START METAL HALIDE LAMP PSMV-C73.ies & A DIFFUSED FLAT TEMPERED LENS AND A TAMPER PROOF HARDWARE(COLOR TO BE DETERMINED) CHALLENGER WALL SCONCE SERIES 1- 100W PSMV CLEAR CHWS-FT-100- 9000 1.00 129 MEDIUM TYPE III FORWARD THROUGH w/ 100 W PSMV & FLAT CLEAR TEMPERED GLASS

LENS w/ DIFFUSING REFLECTOR & DARK-SKY COMPLIANT HARDWARE HOUSE SIDE SHIELDING IN A BLACK FINISH AND AN

OPTIONAL PHOTOCELL CONTROL



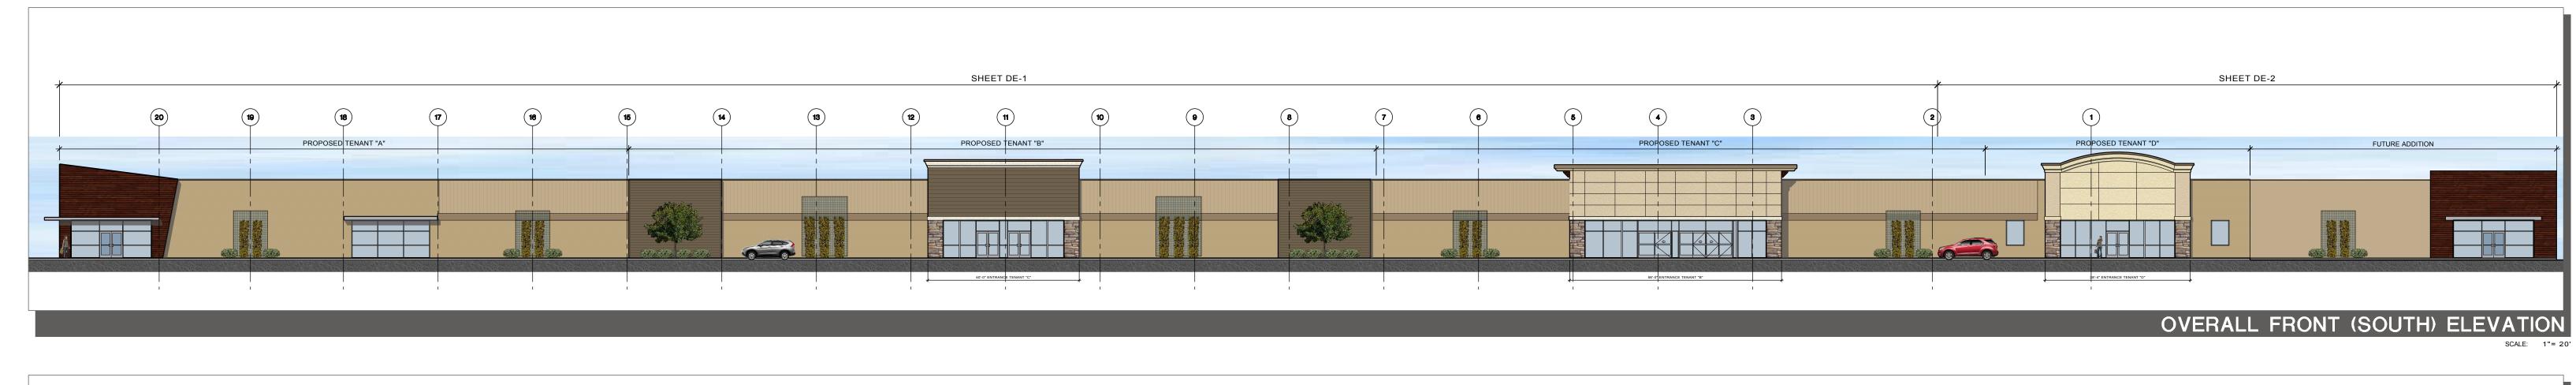


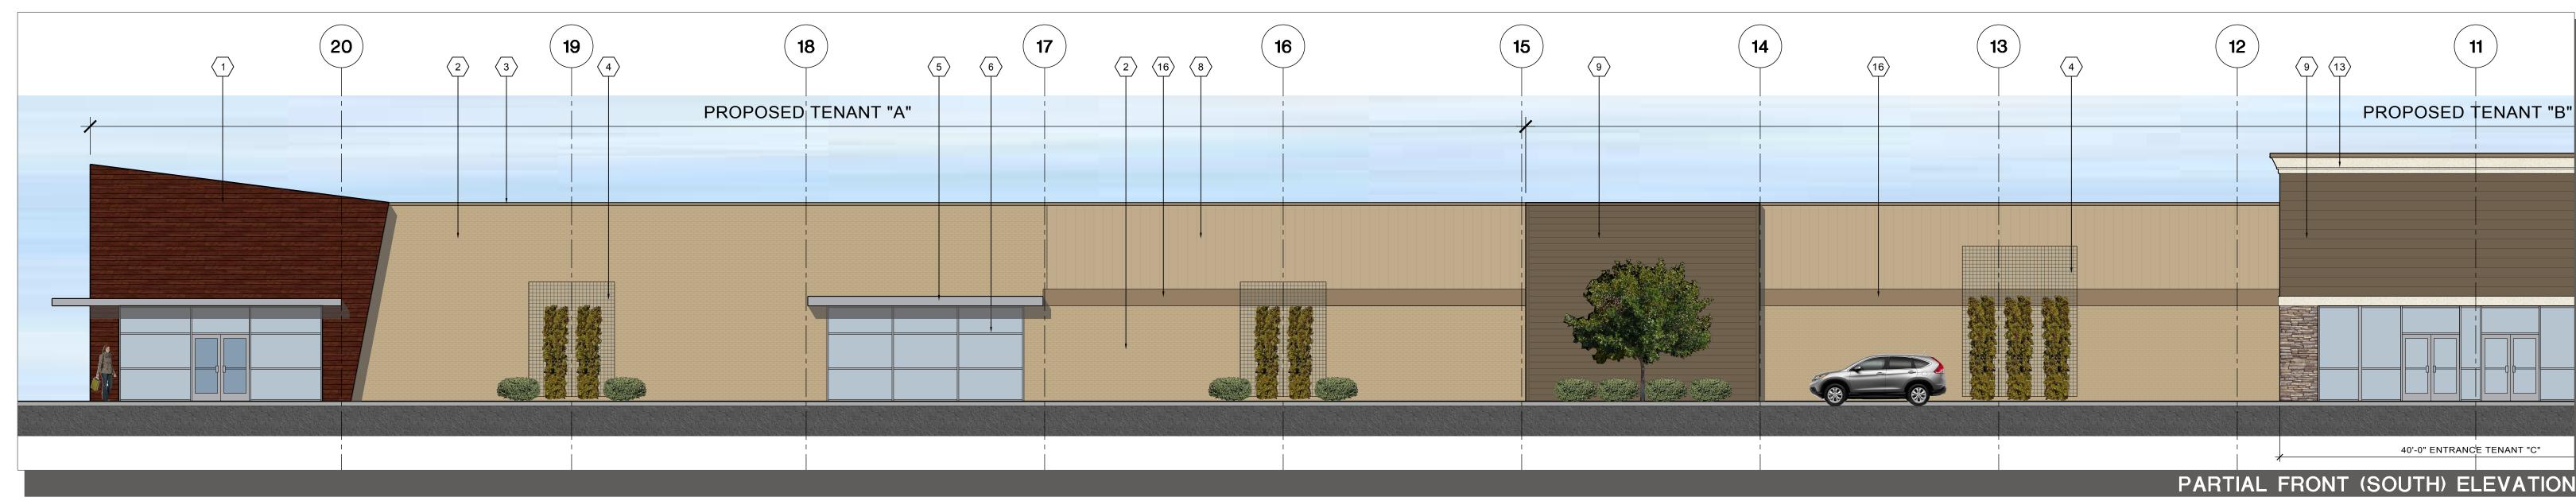


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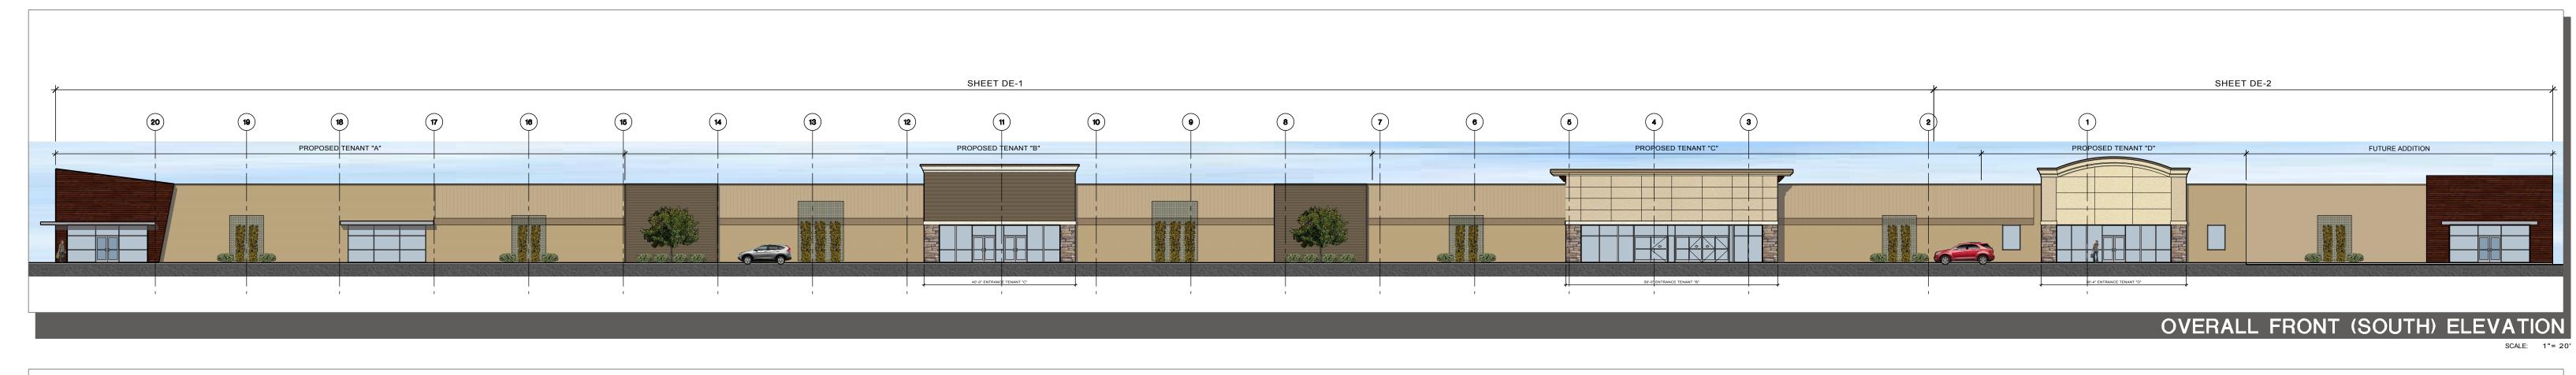




- FIBER CEMENT SIDING, STAINED, CEDAR LAP SIDING BY CERTAINTEED. COLOR "MAHOGANY"
- 2 PAINT EXISTING BRICK SW 6143 BASKET BEIGE
- (3) PAINT EXISTING METAL COPING. COLOR SIERRA TAN
- 4 NEW "GREENGRID" LANDSCAPE TRELLIS.
- NEW SUNSCREEN METAL CANOPY CLEAR ANODIZED ALUMINUM
- 6 NEW ALUMINUM STOREFRONT w/1" INSULATED, LOW-E, CLEAR GLAZING CLEAR ANODIZED ALUMINUM
- 7 COMPACTOR DOOR PAINTED TO MATCH MASONRY
- PATCH EXISTING METAL PANELS AND PAINT TO MATCH BRICK FIBER CEMENT, SMOOTH LAP SIDING BY CERTAINTEED. COLOR SABLE BROWN
- CULTURED STONE MOUNTAIN LEDGE BY ELDORADO STONE
 - EIFS NEW SANDPEBBLE FINISH EIFS, COLOR DRYVIT: 471- BEIGE
 - EIFS NEW SANDPEBBLE FINISH EIFS, COLOR DRYVIT: 457B WHOLE WHEAT
- EIFS NEW SANDPEBBLE FINISH EIFS, COLOR DRYVIT: 386A PURE CREAM
- MASONRY TRASH ENCLOSURE PAINT TO MATCH BUILDING AND COMPOSITE WOOD GATES.
- (15) DOCK SEAL AND DOCK BUMPER

(16) METAL FASCIA - COLOR SIERRA TAN







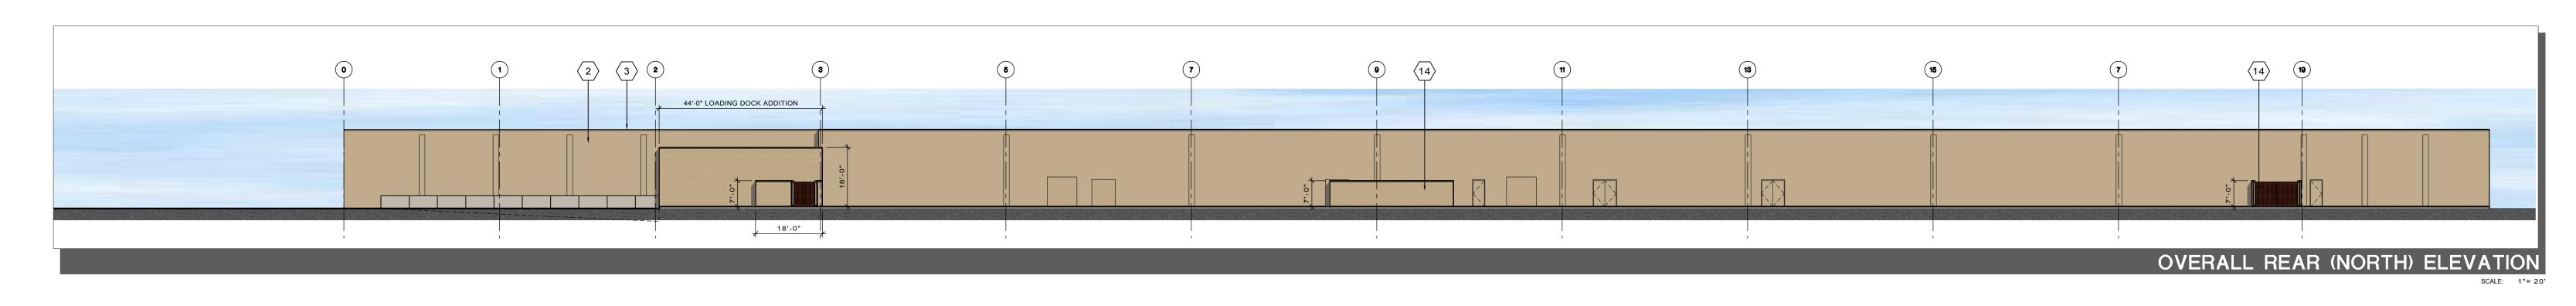


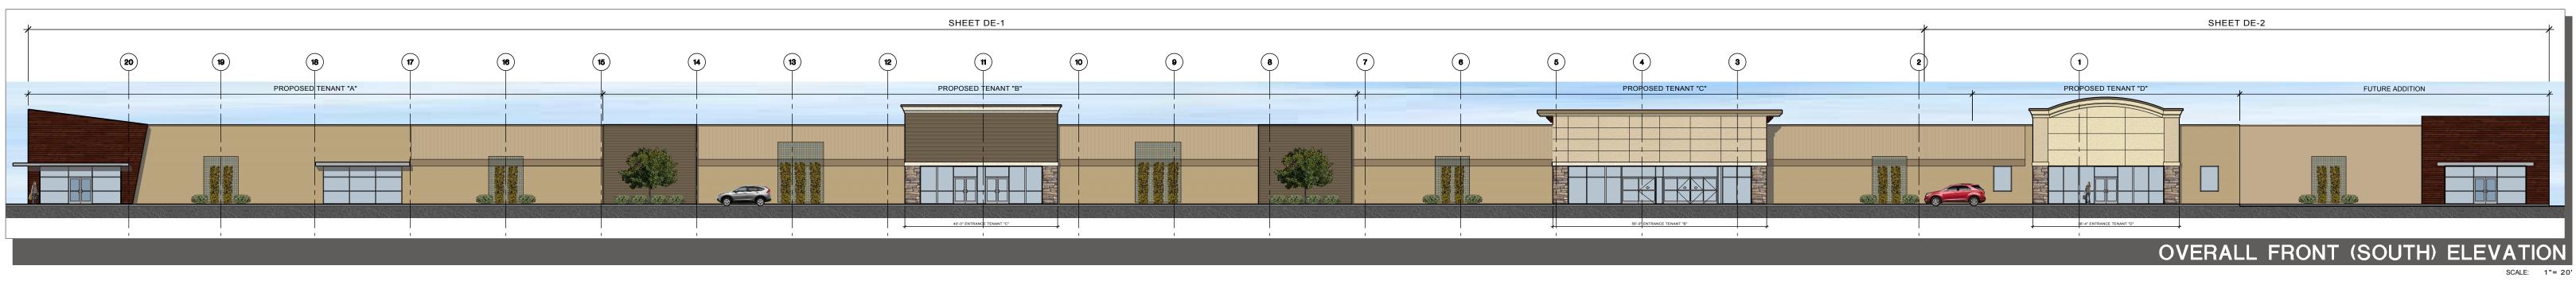
MATERIAL FINISH LEGEND

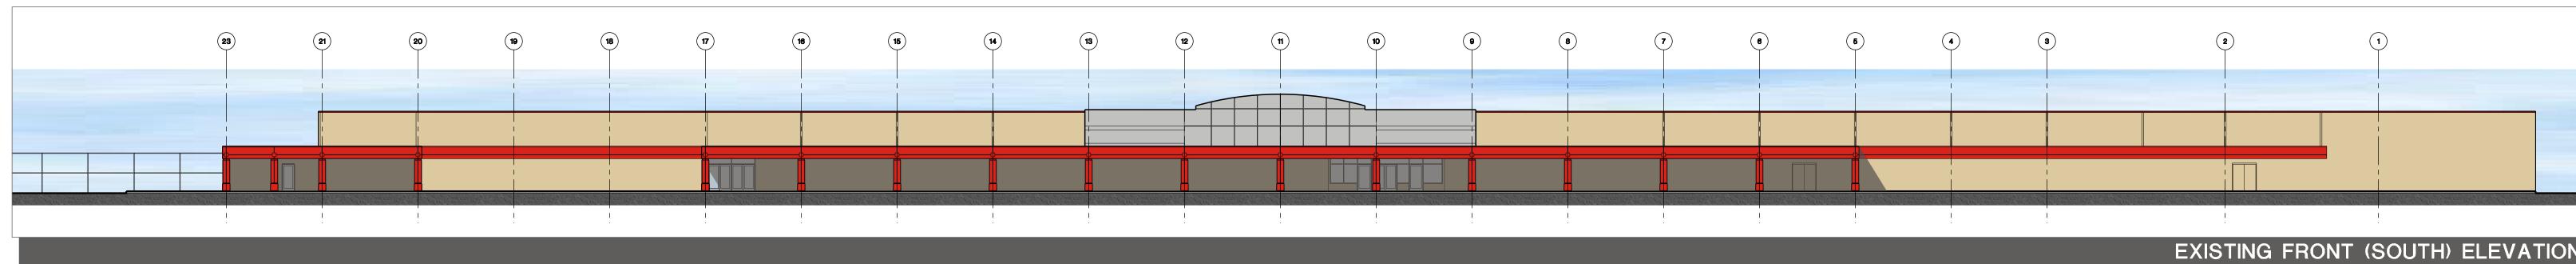
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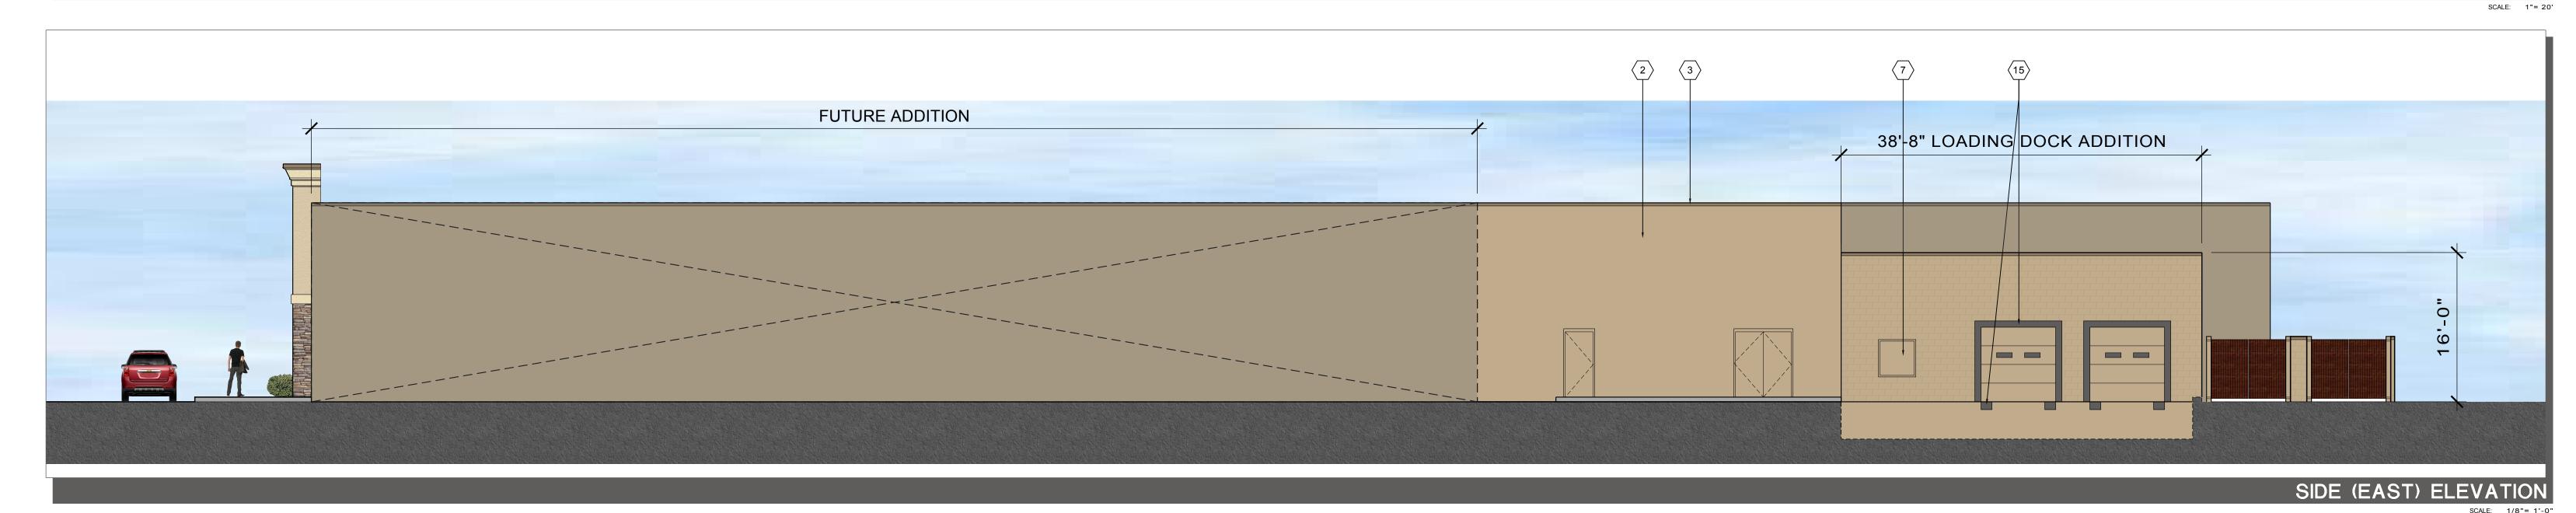
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MATERIAL FINISH LEGEND

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15 DOCK SEAL AND DOCK BUMPER

(16) METAL FASCIA - COLOR SIERRA TAN

