

ZONING ZONED: MIN. BUILDING SETBACKS (FT): STREET YARD: XX' INTERIOR SIDE YARD: XX' REAR YARD: XX' FRONT & STREET YARD: XX' PAVING SETBACKS (FT): INTERIOR SIDE YARD: XX' REAR YARD: XX' MAX. BUILDING HEIGHTS (FT): PRINCIPAL BUILDING: XX' ACCESSORY BUILDING: XX'

SITE STATISTICS			
NAME	AREA	AREA RATIO	
BUILDABLE AREA	30,458 SF	34%	
EXISTING PAVING	22,981 SF	26%	
NEW PAVING	16,834 SF	19%	
PROPOSED BUILDING A	5,275 SF	6%	
PROPOSED BUILDING B	5,850 SF	7%	
PROPOSED BUILDING C	3,500 SF	4%	
PROPOSED RETENTION /	5,072 SF	6%	
DETENTION POND			
GRAND TOTAL	89,969 SF	100%	

### PARKING

PARKING REQUIREMENTS: TOTAL STALLS REQUIRED: TOTAL STALLS PROPOSED: TOTAL ACCESSIBLE STALLS REQUIRED: TOTAL ACCESSIBLE STALLS PROPOSED:

#### **GENERAL SITE NOTES:**

1. VISIT JOB SITE TO VERIFY EXISTING SITE CONDITIONS PRIOR TO STARTING CONSTRUCTION. MEET WITH GENERAL CONTRACTOR PRIOR TO STARTING.

2. REMOVE EXISTING TREES ALONG WITH ROOTS AS REQUIRED @ PROPOSED BUILDING AND PAVING AREAS.

3. STRIP AND REMOVE ALL REMAINDER VEGETATION & X"+/- TOP SOIL FROM WITHIN THE BUILDING AND PAVING AREAS. STOCKPILE REUSABLE, UNCOTAMINATED TOPSOIL AND PROVIDE FOR ALL EXCESS MATERIAL TO BE TRUCKED OFF SITE. RESPREAD SALVAGED TOPSOIL OVER DISTURBED AREAS TO APPROX. 4" DEPTH AFTER CONSTRUCTION IS FINISHED.

4. CUT (OR FILL) THE BUILDING AREA +5.0' BEYOND PERIMETER OF THE BUILDING

5. CUT THE FLOOR AREA TO THE SUB-GRADE ELEVATION. (THE PERIMETER FOUNDATION FOOTINGS TO BE EXCAVATED BY CONC. CONTR. TO THE REQUIRED DEPTHS PER THE FOUNDATION PLAN). BENCH GRADE BACK PER CURRENT OSHA CODE STANDARDS PART #1926 IF REQ'D BY THE G.C. FOR THE PROJECT

6. PROOF ROLL BUILDING AREA FOR ANY SOFT MATERIALS. REPORT ANY SOFT SPOTS TO THE GENERAL CONTRACTOR.

7. ALL FILL MATERIAL FOR BRINGING GRADES UP TO SUB-GRADE ELEVATIONS SHALL BE GRANULAR OR CLEAN COMPACTABLE CLAY AND

8. ALL EXTERIOR BACKFILL MATERIAL FOR STANDARD FROST FOUNDATION WALLS SHALL BE CLEAN COMPACTABLE CLAY.

9. ALL BACKFILL & FILL MATERIALS SHALL BE INSPECTED AND APPROVED BY ANDERSON-ASHTON PRIOR TO PLACEMENT. ALL FILL MATERIALS SHALL BE COMPACTED IN 8" MAX. LIFTS @ 95% MODIFIED PROCTOR.

10. PREPARE THE PAVING AREA AS SHOWN ON THE CONSTRUCTION DOCUMENTS to +/- 0.10'

11. PREPARE ALL SWALES AS SHOWN ON PLAN TO PROVIDE POSITIVE DRAINAGE DURING CONSTRUCTION.

12. RETURN AFTER THE BUILDING IS ENCLOSED & FINISH GRADE AND

TOPSOIL AROUND PERIMETER OF BUILDING. ALSO, FINISH GRADE AROUND ELECTRICAL, TELEPHONE, GAS, SEWER, WATER AND UTILITY TRENCHES.

13. GRADING CONTRACTOR SHALL FIX AND REPAIR PARKING AREA AND DRIVES AS REQUIRED AFTER UTILITY AND OTHER WORK THAT MAY DISTURB THE SOIL AND/OR GRAVEL BASE BEOFRE PAVING BEGINS. GRADING CONTRACTOR SHALL SMOOTH DRUM ROLL ALL PARKING AREAS AND DRIVES BEFORE PAVING BEGINS.

14. GRADING CONTRACTOR SHALL BE PREPARRED TO HANDLE ALL SPOILS WHICH MAY INCLUDE ON SITE STORAGE AND TRUCKING OFF SITE. GRADER TO GET PRIOR APPROVAL FROM G.C. FOR PLACEMENT OF STOCKPILE SITES PRIOR TO STARTING STRIPPING OF TOPSOIL.

15. AWARDED GRADING CONTRACTOR SHALL BE RESPONSIBLE FOR THE LABOR AND MATERIAL NEEDED FOR SUPPLYING ANY TRAFFIC CONTROL BARRIERS OR SIGNS AS NEEDED PER LOCAL OR D.O.T. CODES & REGULATIONS DUE TO ANY ROAD WORK OUTSIDE OF PROPERTY LINES

16. THE GROUND IMMEDIATELY ADJACENT TO THE FOUNDATION SHALL BE SLOPED AWAY FROM BUILDING AT A SLOPE OF NOT LESS THAN ONE UNIT VERTICAL IN 20 UNITS HORIZONTAL (5% SLOPE) FOR A MIN DISTANCE OF 10' MEASURED PERP. TO THE FACE OF THE FOUNDATION WALL.

#### **ASPHALT PAVING WORK**

1. FURNISH AND INSTALL A 8" CRUSHED AGGREGATE BASE AT THE ASPHALT PAVING PARKING AREAS.

2. FINE GRADE AND COMPACT STONE BASE.

3. FURNISH AND INSTALL A 4" (TWO LIFT) AVG. THICKNESS COMPACTED ASPHALT PAVEMENT AT TRUCK/DRIVE AREAS

4. FURNISH AND INSTALL ALL PARKING STALL STRIPING, H.C. SYMBOLS, & H.C. SIGNS ON METAL POSTS.


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DRAFTED BY: DESIGNER: ISSUE:8/23/2023 10:59:38 AM SUBMITTAL DATEXX-XX-XX DESIGN NO. CONSTRUCTION NO.

ARCHITECTURAL SITE

REVISIONS



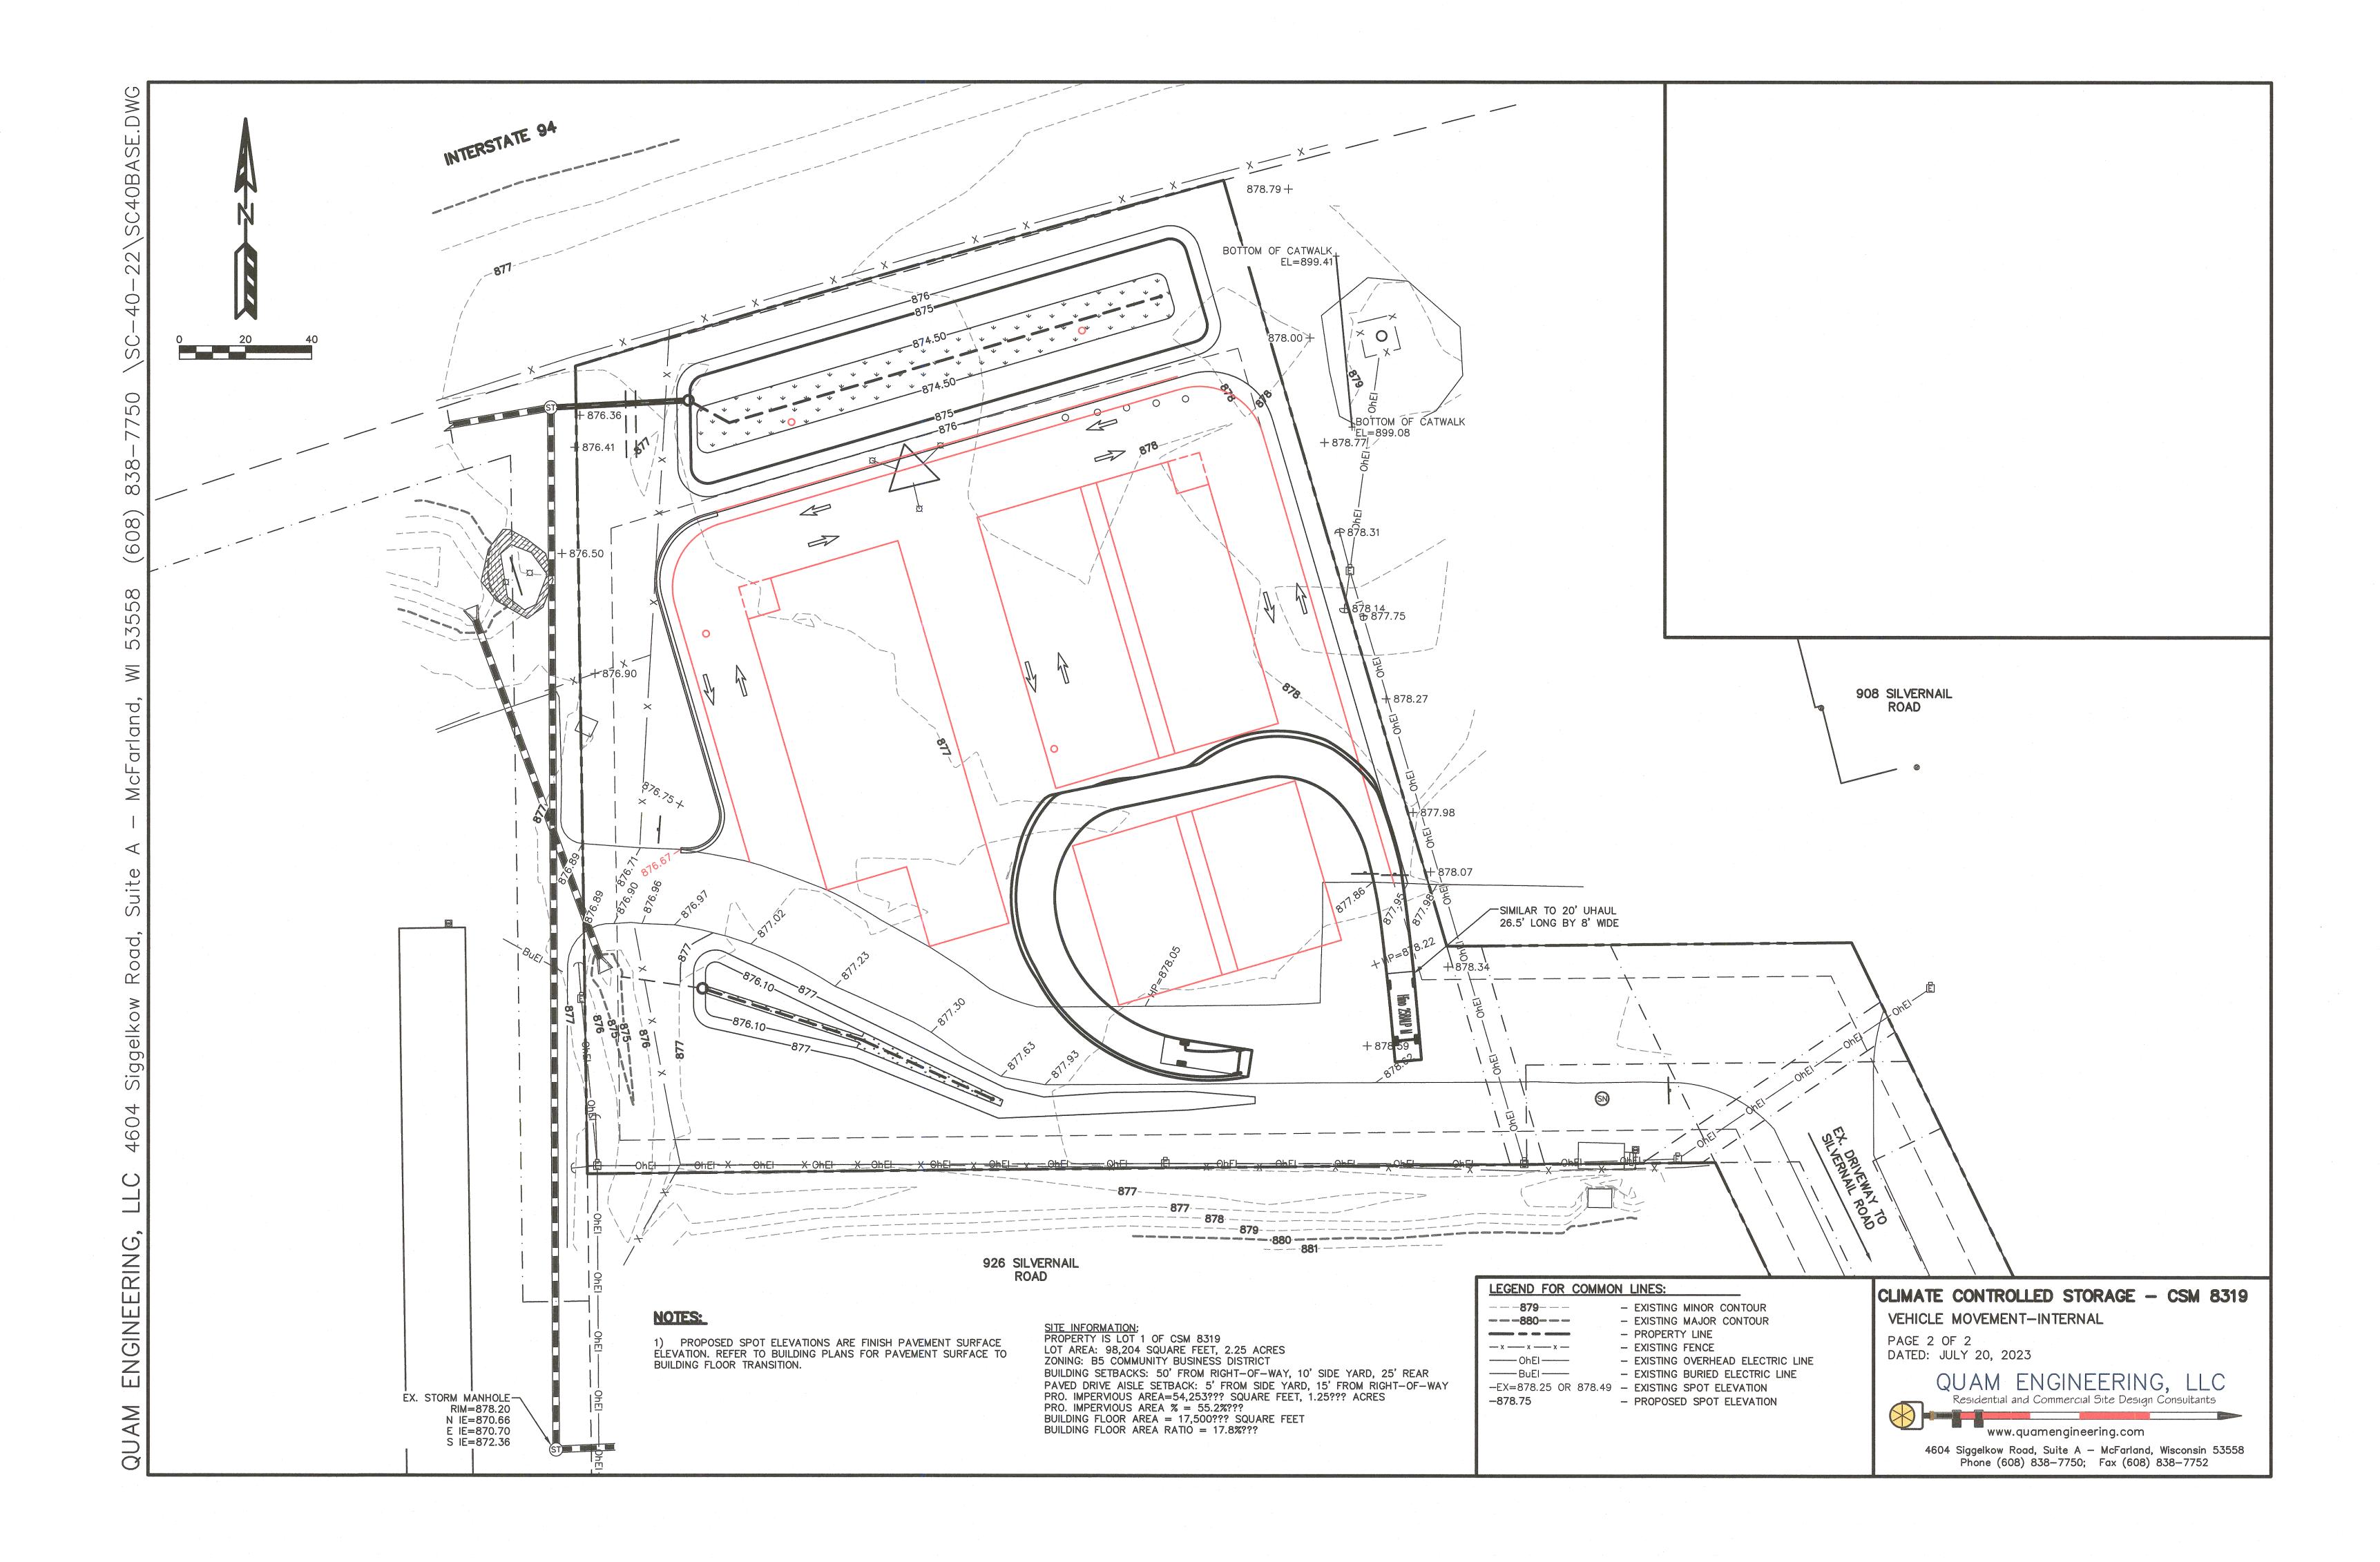

LOT ZONING .

LOT AREA · · ·

REFER TO GRADING PLAN, GENERAL NOTES AND SPECIFICATIONS FOR FURTHER INFORMATION.

(5) REMOVE EXISTING TREE IN ITS ENTIRETY. GRIND STUMP TO A DEPTH OF 8"-12" BELOW THE SOIL SURFACE

DEBRIS AND BARK CHIPS.

INCH BIODEGRADABLE NORTH AMERICAN GREEN BIOSTAKE.

INSTALLATION. REFER TO GRADING PLAN FOR FURTHER INFORMATION.

TO LSP1, 2, GENERAL NOTES AND SPECIFICATIONS FOR FURTHER INFORMATION.

AND PREPARE FOR NEWTURF GRASS SEEDING OR NEW SPECIFIED PLANT MATERIAL. REMOVE ALL

ADJACENT SURFACE ROOTS AS REQUIRED FOR NEW INSTALLATION. REMOVE AND HAUL AWAY ALL

(6) BIONET - \$150BN-SHORT-TERM BIODEGRADABLE DOUBLE-NET STRAW BLANKET (0.23 INCHES) INSTALLED AT

RAIN WATER RENEWAL SEED MIX FROM AGRECOL FOR LOWER 3/3 OF THE STORMWATER MANAGEMENT

INSTALLATION INSTRUCTIONS REGARDING THE PRAIRIE GRASS FOR PROPER GERMINATION AND

(9) ALL PLANT MATERIAL WITHIN THE ECONOMY PRAIRIE SEED MIX) TO BE INSTALLED WITH A 4'-0" DIAMETER

SURVIVABILITY. ALSO REFER TO GENERAL NOTES FOR PREPARATION OF TOP SOIL AND SEED

BOWL. APPLY AT A RATE OF 33 LBS/ACRE. IT IS VERY IMPORTANT TO FOLLOW THE MANUFACTURERS

(8) ECONOMY PRAIRIE SEED MIX FROM AGRECOL FOR UPPER 1/3rd OF THE STORMWATER MANAGEMENT BOWL. A

RATE OF 38.5 LBS/ACRE. IT IS VERY IMPORTANT TO FOLLOW THE MANUFACTURERS INSTALLATION INSTRUCTIONS

REGARDING THE PRAIRIE GRASS FOR PROPER GERMINATION AND SURVIVABILITY. REFER TO GENERAL NOTES

FOR PREPARATION OF TOP SOIL & SEED INSTALLATION AND TO GRADING PLAN FOR FURTHER INFORMATION.

BIO-DEGRADABLE WOVEN/FIBEROUS RING. A LESSER/TEMPORARY MULCH RING IS INTENDED FOR INITIAL FIRST

SEASON ROOT ESTABLISHMENT. AFTER THE FIRST GROWING SEASON IT IS EXPECTED THAT THE TREE / LARGE SHRUB

WOULD BE ESTABLISHED AND WOULD NO LONGER REQUIRE A MULCH RING AND THE NO-MOW LOW GROW GRASS WILL ESTABLISH ITSELF AND COVER THE TREE RING / ROOT BALL ALONG WITH THE REST OF THE BERMED AREA. REFER

BIO RETENTION BASINS ABOVE STORM-WATER SEED MIX AND BELOW PROPOSED RIPRAP - INSTALL WITH 4

#### **EXISTING CONDITIONS GENERAL NOTES**

- 1. INFORMATION PERTAINING TO EXISTING CONDITIONS GIVEN ON THESE LANDSCAPE DRAWINGS REPRESENTS TO THE BEST OF OUR KNOWLEDGE THE ACTUAL EXISTING FIELD CONDITIONS, INSITE LANDSCAPE DESIGN, INC. MAKES NO WARRANTY AS TO THEIR ACCURACY. CONTRACTOR TO FIELD VERIFY EXISTING CONDITIONS IMPERATIVE TO THEIR NEW WORK, REPORT ANY DISCREPANCIES BETWEEN THE DRAWINGS AND FIELD CONDITIONS TO THE LANDSCAPE ARCHITECT FOR REVIEW. ANY WORK PERFORMED PRIOR TO RESOLUTION OF DISCREPANCIES BY THE LANDSCAPE ARCHITECT IS SUBJECT TO REMOVAL AND REPLACEMENT AT NO ADDITIONAL COST TO THE CONTRACT
- 2. THE LOCATIONS OF EXISTING UTILITY INSTALLATIONS AS SHOWN ON THIS PLAN ARE APPROXIMATE, THERE MAY BE UNDERGROUND UTILITY INSTALLATIONS WITHIN THE PROJECT AREA OF DISTURBANCE THAT ARE NOT SHOWN. THE CONTRACTOR SHALL BE RESPONSIBLE FOR VERIFYING THE EXISTENCE AND LOCATION OF ALL UNDERGROUND UTILITIES.
- VERIFY ALL EXISTING CONDITIONS, DIMENSIONS, AND ALIGNMENT OF WALLS. BRING ANY DISCREPANCIES TO THE LANDSCAPE ARCHITECTS ATTENTION PRIOR TO FABRICATION / CONSTRUCTION BEGINS. 4. VERIFY LOCATION OF ACCESS PANELS W/ MECHANICAL AND ELECTRICAL EQUIPMENT FOR ACCESSIBILITY OF MECHANICAL & ELECTRICAL ITEMS, VERIFY LOCATIONS OF ALL BURIED UTILITIES AND STRUCTURES AND
- LOCATIONS OF ALL OVERHEAD WIRES. VERIFY LOCATION OF ALL EXISTING EASEMENTS. INSITE LANDSCAPE DESIGN, INC, ASSUMES NO RESPONSIBILITY FOR DAMAGES, LIABILITY OR COSTS RESULTING FROM CHANGES OR ALTERATIONS MADE TO THIS PLAN WITHOUT THE EXPRESSED WRITTEN CONSENT OF

#### LANDSCAPE PLAN GENERAL NOTES

1. AT LEAST SEVENTY-TWO HOURS PRIOR TO ANY EXCAVATION, CONTRACTOR SHALL VERIFY UTILITY LOCATIONS AS GIVEN BY THE ELECTRIC, GAS, TELEPHONE, WATER, SEWER, AND CABLE TELEVISION COMPANIES, UTILITIES OR ENTITIES. REVIEW WITH OWNER'S REPRESENTATIVE SITE MECHANICAL, SITE ELECTRICAL AND LIGHTING, SITE GRADING AND DRAINAGE, SITE IRRIGATION AND ALL OTHER DRAWINGS PERTAINING TO UNDERGROUND UTILITY LOCATIONS. RECORD SET OF INFORMATION THE SAME AS IN POSSESSION OF OWNER'S REPRESENTATIVE. ALSO REVIEW OWNER'S "MARK SETS" OF ALL OF THESE DRAWINGS IN POSSESSION OF THE CONTRACTOR OR OWNER. MARK ALL SUCH UTILITIES ON THE SITE PRIOR TO COMMENCING. COORDINATE WITH OWNER BEFORE AND DURING CONSTRUCTION. REPAIR ANY DAMAGE TO ANY SYSTEM THAT IS CAUSED BY LANDSCAPE CONTRACTOR

- 2. ALL PLANTINGS SPECIFIED FOR THE CLIMATE CONTROLED STORAGE PROJECT PLANTING TABLES SHALL COMPLY WITH STANDARDS AS DESCRIBED IN AMERICAN STANDARD OF NURSERY STOCK ANSI Z60.1 2014 AND ANSI STANDARDS FOR PLANTING 2012.
- ALL DEVIATIONS FROM THE APPROVED CLIMATE CONTROLED STORAGE PROJECT PLANS SHALL BE NOTED ON THE RECORD DRAWINGS BY THE CONTRACTOR AND MAY BE EXECUTED ONLY WITH PRIOR APPROVAL FROM THE LANDSCAPE ARCHITECT AND OWNER'S REPRESENTATIVE. VERBAL AGREEMENTS OR REVISIONS WITHOUT A CHANGE ORDER WILL NOT BE RECOGNIZED BY LANDSCAPE ARCHITECT AND OWNER.
- 4. ALL PLANTS MUST BE BID AND SELECTED PER THE SPECIES SPECIFIED ON THE PLANS. ANY SPECIES SUBSTITUTIONS MUST BE APPROVED IN WRITING BY LANDSCAPE ARCHITECT. THE SIZES OF PLANT MATERIAL LISTED HEREIN IS A MINIMUM ACCEPTABLE SIZE. ADDITIONALLY, IF EXCESSIVE PRUNING REDUCES THE CROWN THE PLANT SHALL BE REPLACED.
- 5. PROTECT PUBLIC FROM CONSTRUCTION WITH BARRIERS AND BARRICADES.

PLANT MATERIAL SHOWN ON LANDSCAPE PLAN IS DEPICTED AT MATURE GROWTH.

- 6. ALL AREAS THAT WERE DISTURBED DURING CONSTRUCTION AND AREAS NOT COVERED WITH PAVEMENT, BUILDING, PLANTING BEDS, OR TREE PITS ARE TO BE TOPSOILED 3" DEEP (MIN.) AND SHALL BE SODDED/SEEDED WITH SPECIFIED LAWN GRASS. LANDSCAPE CONTRACTOR SHALL INCLUDE COST PER SQUARE YARD FOR ADDITIONAL SEED OPERATIONS AS MAY BE POSSIBLY REQUIRED TO REESTABLISH ADJACENT TURF GRASS AREAS WHICH MAY BECOME DAMAGED DURING THE CONSTRUCTION PROCESS OR TO REPAIR DAMAGE DONE BY OTHERS.
- 7. CONTRACTOR IS RESPONSIBLE FOR FURNISHING ALL MATERIALS, TOOLS, EQUIPMENT, LABOR, AND PLANTS NECESSARY FOR PROPER PLANTING AND INSTALLATION OF ALL LANDSCAPE MATERIAL.
- 8. QUANTITIES ON PLANT MATERIALS LIST ARE FOR CONVENIENCE OF BIDDING ONLY. CONTRACTOR IS RESPONSIBLE FOR ALL PLANTS SHOWN ON LANDSCAPE PLANS AND COVERAGE OF ALL AREAS DELINEATED. THE PLANS ARE TO SUPERSEDE THE PLANT LIST IN ALL CASES.
- 9. CONTRACTOR IS RESPONSIBLE FOR ALL ESTIMATING AND BIDDING, ALL AREAS, QUANTITIES MATERIALS SHOULD BE FIELD VERIFIED WITH SITE CONDITION.
- 10. WHERE DISCREPANCIES OCCUR BETWEEN THE LANDSCAPE PLANS AND/OR ARCHITECTURAL AND/OR THE CIVIL DRAWINGS (AND ANY OTHER SITE DRAWINGS) THE DISCREPANCIES MUST BE BROUGHT TO THE LANDSCAPE ARCHITECTS ATTENTION FOR COORDINATION AND RESOLUTION.
- 11. ALL DISEASED, NOXIOUS OR INAPPROPRIATE MATERIALS SHALL BE REMOVED FROM THE PROPOSED SITE PRIOR TO THE START OF CONSTRUCTION AND DURING THE MAINTENANCE PERIOD.
- GENERAL CONTRACTOR SHALL LEAVE THE SITE FREE OF CONSTRUCTION DEBRIS.
- 13. ALL LAWN AND PLANTING AREAS SHALL SLOPE TO DRAIN A MINIMUM OF 2% UNLESS NOTED OTHERWISE AND REVIEWED WITH OWNER'S REPRESENTATIVE FOR FINAL APPROVAL.
- 14. FINISH GRADES FOR SHRUB AND GROUND COVER AREAS SHALL BE HELD 1" BELOW TOP OF ADJACENT PAVEMENTS AND CURBS, UNLESS NOTED OTHERWISE ON THE PLANS. REFER TO
- 15. ALL PERENNIAL, ANNUAL AND GROUND COVER AREAS TO RECEIVE A BLEND OF ORGANIC SOIL AMENDMENTS PRIOR TO PLANTING. TILL THE FOLLOWING MATERIALS INTO EXISTING TOPSOIL TO A DEPTH OF APPROXIMATELY 8". A DEPTH OF 12" IN TREE PITS. PROPORTIONS AND QUANTITIES MAY REQUIRE ADJUSTMENT DEPENDING ON THE CONDITION OF EXISTING SOIL. REFER TO LSP1.2 FOR FURTHER INFORMATION.
- PER EVERY 100 SQUARE FEET ADD: ONE 2 CUBIC FOOT BALE OF PEAT MOSS, 2 POUNDS OF 5 -10 -5 GARDEN FERTILIZER, 1/4 CUBIC YARD OF COMPOSTED MANURE OR OTHER
- 16. ALL SHRUBS TO BE POCKET PLANTED WITH A 50/50 MIX OF COMPOSTED, ORGANIC MATERIAL AND EXISTING SOIL. INSTALL TOPSOIL INTO ALL BEDS AS NEEDED TO ACHIEVE PROPER GRADE. REMOVE ALL EXCESSIVE GRAVEL, CLAY AND STONES. REFER TO LSP1.2 FOR FURTHER INFORMATION.
- 17. PLANT ALL TREES SLIGHTLY HIGHER THAN FINISHED GRADE AT ROOT FLARE. BACK FILL HOLE WITH 2/3 EXISTING TOPSOIL AND ORGANIC SOIL AMENDMENTS SPECIFIED IN NOTE 15 AVOID ANY AIR POCKETS. DISCARD ANY GRAVEL CLAY OR STONES. REFER TO LSP1.2 FOR FURTHER INFORMATION.
- 18. ALL TREES TO BE INSTALLED, STAKED AND GUYED ACCORDING TO DETAILS. REFER TO ANSI STANDARDS FOR PLANTING 2012 AND DETAILS ON LSP1.2 FOR FURTHER INFORMATION
- 19. PROVIDE A 4'-0" 5'-0" DIAMETER MULCH RING AT THE ROOT BALL FLARE OF ALL LAWN TREES.
- ALL PLANTINGS TO BE WATERED AT THE TIME OF PLANTING, THROUGHOUT CONSTRUCTION AND UPON COMPLETION OF PROJECT AS REQUIRED.
- 21. WHERE SPECIFIED, ALL PLANT BEDS, PITS AND TREE RINGS ARE TO RECEIVE A MINIMUM OF 2" 3" DRESSING OF SHREDDED HARDWOODM OAK BARK MULCH SHAVINGS FREE OF GROWTH, WEEDS, FOREIGN MATTER DETRIMENTAL TO PLANT LIFE OR GERMINATION INHIBITING INGREDIENTS. LANDSCAPE CONTRACTOR TO PROVIDE A SAMPLE TO OWNER FOR APPROVAL. CONTRACTOR TO TAKE CARE WITH INSTALLATION NOT TO DAMAGE OR COVER PLANTS. REFER TO LSP1.2 FOR FURTHER INFORMATION.
- 22. LAWN INSTALLATION: CONTRACTOR TO FURNISH AND PREPARE TOPSOIL (3" MIN) AND SEED BED (REMOVE ALL STONES 1" OR LARGER), APPLY STARTER FERTILIZER AND SEED UNIFORMLY. PROVIDE A MULCH COVERING SUITABLE TO GERMINATE AND ESTABLISH TURF. EROSION CONTROL MESH SHOULD BE USED IN SWALES AND STEEP GRADES WHERE APPLICABLE. METHODS OF INSTALLATION MAY VARY AT THE DISCRETION OF CONTRACTOR. IT IS HIS/HER RESPONSIBILITY TO ESTABLISH AND GUARANTEE A SMOOTH, UNIFORM, QUALITY TURF. IF STRAW MULCH IS USED AS A COVERING, A TACKIFIER MAY BE NECESSARY TO AVOID WIND DAMAGE.
- 23. DELUXE 50 GRASS SEED MIX REINDER'S (800) 785-3301
- 20% KENTUCKY BLUE GRASS 15% NEWPORT KENTUCKY BLUE GRASS
- 15% SR 2100 Kentucky Bluegrass
- 25% Creeping Red Fescue
- 15% Replicator Perennial Ryegrass
- 10% Fiesta 4 Perennial Ryegrass
- APPLY AT A RATE OF 200 POUNDS PER ACRE. REFER TO SUPPLIERS SPECIFICATIONS & INSTALLATION CUT SHEETS FOR FURTHER FORMATION
- 24. DURING THE INITIAL "30 DAY MAINTENANCE PERIOD" THE LANDSCAPE CONTRACTOR IS REQUIRED TO PROVIDE AND ON-GOING PLEASANT VISUAL ENVIRONMENT WHEREAS ANY PLANT WHICH IS NOT RESPONDING TO TRANSPLANTING OR THRIVING SHALL IMMEDIATELY BE REPLACED. NEW LAWNS SHALL BE WATERED AND REPAIRED AND WEEDS MUST CONSTANTLY BE REMOVED, NO EXCEPTIONS WILL BE GRANTED.
- MAINTENANCE IS THE RESPONSIBILITY OF THE PROPERTY OWNER TO MAINTAIN REQUIRED LANDSCAPING IN ACCORDANCE WITH THE MUNICIPALITY'S PROPERTY MAINTENANCE CODE AND AN APPROVED MAINTENANCE PLAN. THE MAINTENANCE MUST INCLUDE, AT A MINIMUM, METHODS FOR PROVIDING THE FOLLOWING:
  - NECESSARY IRRIGATION (if REQUIRED)
- INTEGRATED PEST MANAGEMENT,
- PROPER FERTILIZATION TREE CARE AND PRUNING, SHRUB TIP CLIPPING AND SHAPING AS REQUIRED
- REPLACEMENT OF LOST VEGETATION, AND ALL DISEASED, DAMAGED, OR DEAD MATERIAL WILL BE REPLACED BY THE END OF THE FOLLOWING PLANTING SEASON IN
- WEED MANAGEMENT AND BED CARE.
- 25. ALL NEWLY PLANTED TREES AND SHRUBS ARE TO RECIEVE AN APPLICATION OF AN ANTI-TRANSPIRANT SPRAY THAT WILL EFFECTIVELY REDUCE THE WATER LOSS OF TRANSPIRATION OF PLANT MATERIAL AND REDUCE THE STRESS OF TRANSPLANTATION. IT IS RECOMENDED AS PART OF THE ONGOING MAINTENANCE THAT ANY BROADLEAF EVERGREEN AND CONIFEROUS TREE AND SHRUBS (EXCLUDING ARBORVITAE) RECIEVE AN APPLIATION OF AN ANTI-DESICANT SPRAY TO REDUCE THE LOSS OF MOISTURE DUE TO WINTER DESICCATION.
- 26. MAINTENANCE. THE OWNER SHALL TEND AND MAINTAIN ALL PLANT MATERIALS IN A HEALTHY GROWING CONDITION AS PER THE APPROVED PLAN. PLANTINGS SHALL BE REPLACED WHEN NECESSARY AND KEPT FREE FROM REFUSE & DEBRIS. ALL PLANTING MATERIAL WHICH IS DYING OR DAMAGED BEYOND RECOVERY SHALL BE REPLACED WITHIN SIX (6) MONTHS OR BY THE NEXT PLANTING SEASON, WHICHEVER COMES FIRST.
- LANDSCAPE / SITE DEMOLITION CONTRACTOR TO VERIFY LOCATIONS OF EXISTING TREES AND SHRUBS TO BE SALVAGED AND CLEARLY TAG THEM WITH MARKING TAPE AND



UNDERGROUND SEWER AND UTILITY INFORMATION TO OBTAIN LOCATION OF AS SHOWN IS OBTAINED FROM THE RECORDS OF MUNICIPALITY AND LOCAL UTILITY COMPANIES. THE ACCURACY OF WHICH CAN NOT BE GUARANTEED OR CERTIFIED TO. THE LOCATIONS CALL THE MILWAUKEE UTILITY OF EXISTING UTILITY INSTALLATIONS AS SHOWN ON

THIS SURVEY ARE APPROXIMATE. THERE MAY BE

OTHER UNDERGROUND UTILITY INSTALLATIONS

WITHIN THE PROJECT AREA THAT ARE NOT SHOWN.

PARTICIPANT'S UNDERGROUND FACILITIES BEFORE YOU DIG IN WISCONIN ALERT NETWORK www.Diggershotline.com (800)-242-851 **I** 



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# **CLIMATE STORAGE**

Silvernail Road Waukesha, WI 53072

Issuance and Revisions

05/26/23 Plan Commission Submittal Revisions Based on Cleint Comments

Number | Description

Construction

Document

Submittal

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Sheet Title:

PROPOSED LANDSCAPE PLAN, GENERAL NOTES AND PLANT MATERIAL TABLE

Date of Drawing: 08/25/23 Scale: 1'' = 30'-0''Drawn By: Job Number: L23-035

Sheet Number:

to be Removed Removed PROPOSED LANDSCAPE PLAN SCALE: 1'' = 30'-0"North Proposed Plant Material Table LANDSCAPE PLAN CODED CONSTRUCTION NOTES Broadleaf Deciduous Tree | Code Name | Symbol | Scientific Name Planting Size Comments Common Name LANDSCAPE / SITE DEMOLITION CONTRACTOR TO VERIFY LOCATIONS OF EXISTING TREES TO BE Acer pseudosieboldianum 'Northwind' | Northwind Korean Maple 2 1/2"-Cal - B&B SALVAGED AND CLEARLY TAG THEM WITH MARKING TAPE AND CONSTRUCTION FENCE. **AcpsN** BeniH 10' - 12' Cal - B&B LANDSCAPE INSTALLATION CONTRACTOR TO COORDINATE INSTALLATION OF NEW Betula Nigra "Heritage" Heritage River Birch PLANT MATERIAL AND THE COORDINATION WITH EXISTING TREES TO BE SALVAGED. Ginko biloba 'Princeton Sentry' 2 1/2"-Cal - B&B **GibiPS** Princeton Sentry Maidenhair Tree (1) PLANTING BED MULCH AREA. DRESS WITH 2"-3" OF SHREDDED HARDWOOD BARK 1 1/2" Cal - B&B MaAk Malus "Adirondack" Adirondack Flowering Crab MULCH. TAKE CARE WITH INSTALLATION NOT TO DAMAGE OR COVER PLANTS. Wildfire Black Gum 2 1/2"-Cal - B&B NysyW Nyssa sylvatica 'Wildfire' REFER TO GENERAL NOTES AND SPECIFICATIONS FOR FURTHER INFORMATION. (2) EARTHEN BED EDGE (SHOVEL POINT) LANDSCAPE EDGE. TYPICAL ALL PLANT MATERIAL 2 1/2"-Cal - B&B Qubi Quercus bicolor Swamp White Oak AREAS. DRESS WITH 2"-3" OF SHREDDED HARDWOOD BARK MULCH. REFER TO GENERAL Existing to Remain Existing Extg Existing to Remain NOTES AND SPECIFICATIONS FOR FURTHER INFORMATION. Extg 12" Cal Demo Existing to be Removed Existing to be Removed (3) MULCHED 4'-0" DIA. TREE RING BED AREA W/ EARTHEN BED EDGE (SHOVEL POINT) Existing to be Removed | Extg 10" Cal Demo | 4 LANDSCAPE EDGE AS REQUIRED. DRESS WITH 2"-3" OF SHREDDED HARDWOOD BARK Extg Existing to be Removed MULCH. REFER TO LSP1.2, GENERAL NOTES AND SPECIFICATIONS FOR FURTHER Conifer Evergreen Tree INFORMATION. (4) SEEDED AREAS OF TURF GRASS. REPAIR ANY AND ALL TURF DAMAGE FROM THE CONSTRUCTION Quantity | Code Name | Symbol | Scientific Name Comments Common Name Planting Size PROCESS. IT IS VERY IMPORTANT TO FOLLOW THE MANUFACTURERS INSTALLATION INSTRUCTIONS Existing to be Removed Existing to be Removed | Extg 14" Cal Demo Extg REGARDING THE TURF GRASS FOR PROPER GERMINATION AND SURVIVABILITY OF THE SEED MIX AND REFER TO GENERAL NOTES FOR PREPARATION OF TOP SOIL AND SEED INSTALLATION. ALSO, Extg Existing to be Removed Existing to be Removed | Extg 12" Cal Demo |

Existing to be Removed | Extg 18" Cal Demo | 4

Existing to be Removed | Extg 8" Cal Demo

Existing to be Removed | Extg 10" Cal Demo |

Planting Size

18" - 24"- Cont

18" - 24"- Cont

18" - 24"- Cont

Comments

Common Name

Stormwater Management Areas

Dwarf Burning Bush

Dwarf Artic Blue Leaf Willow

Upper Third of the Bowl - Economy Prairie Seed Mix Storm Water Management Pond area from Cardno Quantity Symbol Supplier

Existing to be Removed

Existing to be Removed

Euonymus alatus 'compatus'

Salix purpurea "Nana"

Existing to be Removed

Cardno Economy Prairie Seed Mix - mixture contains 7 native permanent grass/ sedge 3,700 sq. ft species and 15 native forb species. Apply at 10 PLS pounds per acre. Refer to VERIFY cut sheets for mix specifics and installation instructions.

Cornus stolonifera 'Farrow' | Arctic Fire Red Twig Dogwood

lower Two-Thirds of the Bowl - Stormwater Prairie Seed Mix @ Storm Water Management Pond area from Cardno

Quantity	Symbol	Supplier	Туре
5,800 sq. ft. VERIFY			Rainwater Renewal Seed Mix - mixture contains 15 native permanent grass/ sedge species and 19 native forb species. Refer to cut sheets for mix specifics and installation instructions.

## Comments

be Removed

to be Removed

1. Straight central leader, full & even crown. Prune only after planting.

Quantity | Code Name | Symbol | Scientific Name

2. Well balanced, multi-stemmed tree with a minimum of (3) strong canes and full appearance. 3. Prune existing tree, remove any dead, diseased or hazardous limbs. Thin out as required and raise canopy for safety and viability for both pedestrians and

4. Remove tree in its entirety and grind stump to a minimum of 6" below adjacent grade. Remove grinding chips and fill hole with topsoil. Sow with specified turf grass seed as required.

5. Full, well rooted plant, evenly shaped. 6. Male only

Extg


Extg

Extg

EualC

SapuN

Broadleaf Deciduous Shrub

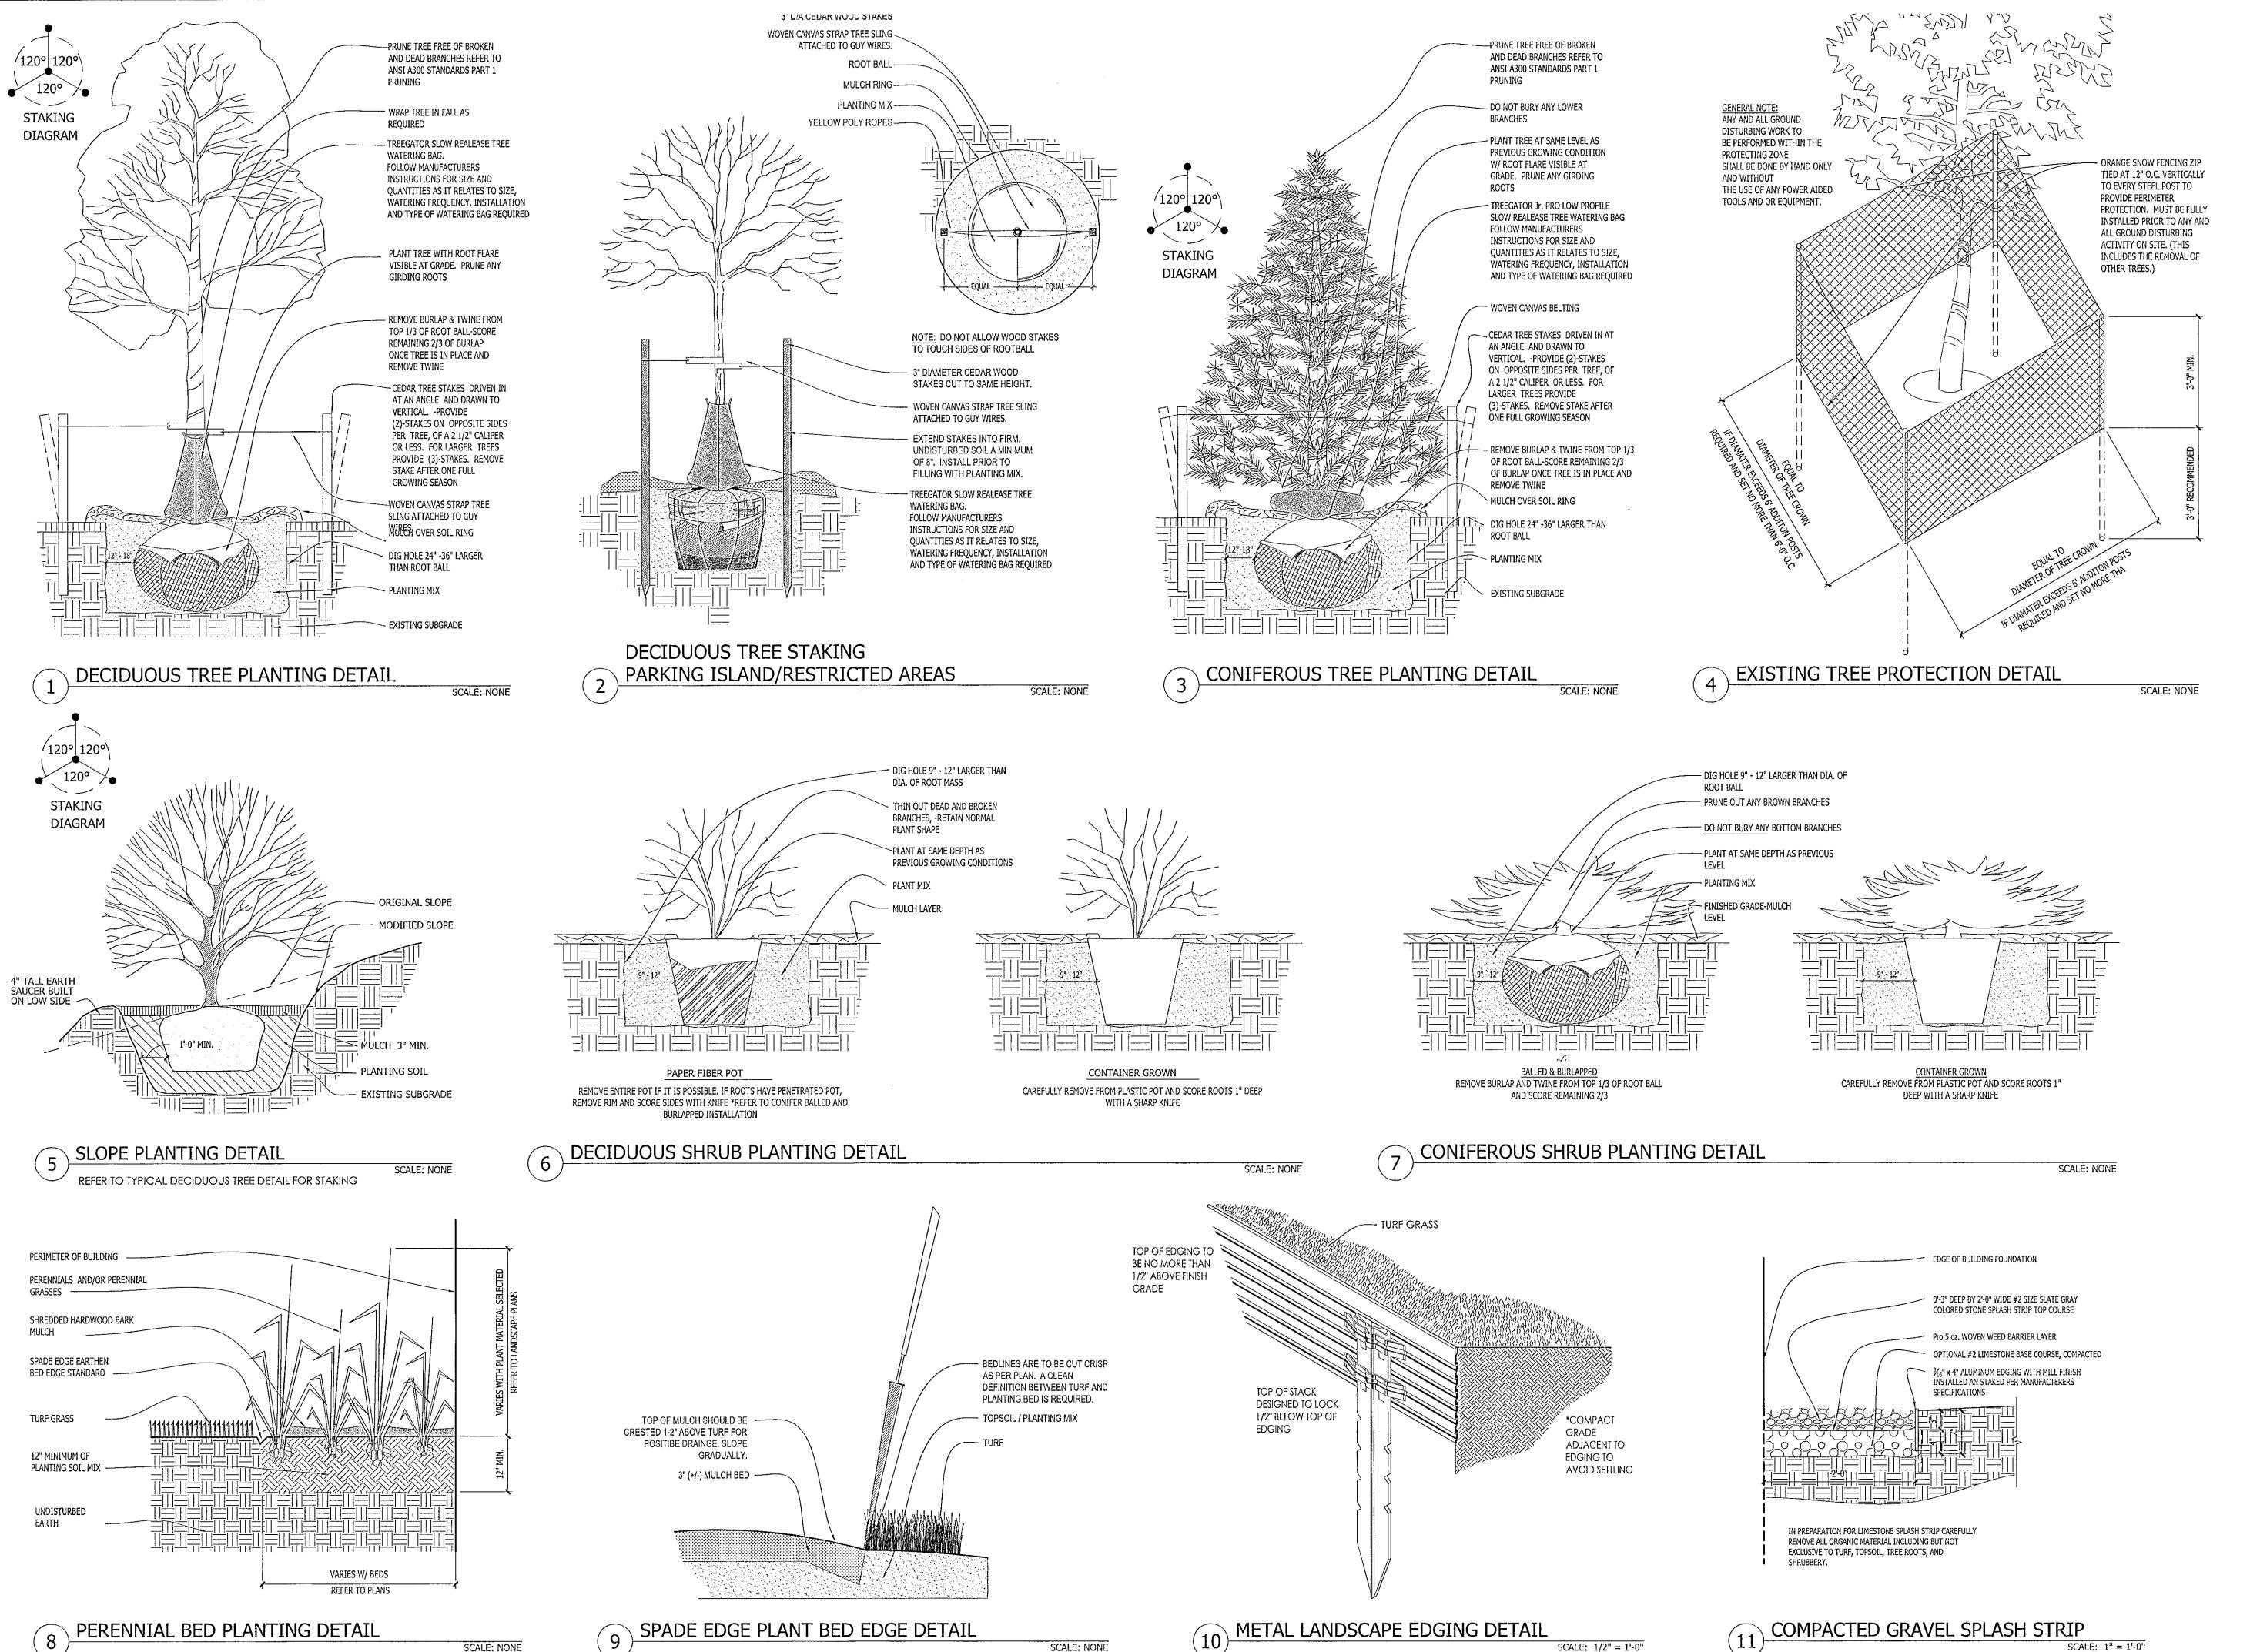

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mdavis@insitedesigninc.com

<u>Project:</u>

# CLIMATE CONTROLED STORAGE

Silvernail Road Waukesha, WI 53072

<u>Issuance and Revisions:</u>

O5/26/23 Plan Commission Submittal

O6/06/23 Revisions Based on Cleint Comments

O8/25/23 Construction

Document Submittal

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Shoot Title

PROPOSED LANDSCAPE PLAN, PLANTING DETAILS

Date of Drawing:

Scale:

As Noted

Drawn By:

MCD

Job Number:

L23-035

LSP1.2

Sheet Number:























