



PLUNKETT RAYSICH ARCHITECTS, LLP

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Sheet Index

ARCHITECTURAL

DEMOLITION PLAN FIRST FLOOR PLAN **EXTERIOR ELEVATIONS**

Project Information

6/20/16 Project Date: PRA Project Number: 150222-03 Construction Document Set Issuance:

Applicable Codes and Zoning

2014 Wisconsin Commercial Building Code (SPS 360-366) **DHS Chapter 132 - Nursing Homes** 2009 International Existing Building Code 2009 International Building Code Institutional occupancy, Group I-2 Zoning: City of Waukesha ordinances


Type of Construction

New Construction: addition/remodeling
Type of construction, unprotected, type IB - Fully-Sprinklered

ADA Access Route

Refer to Sheet 050

Project Location

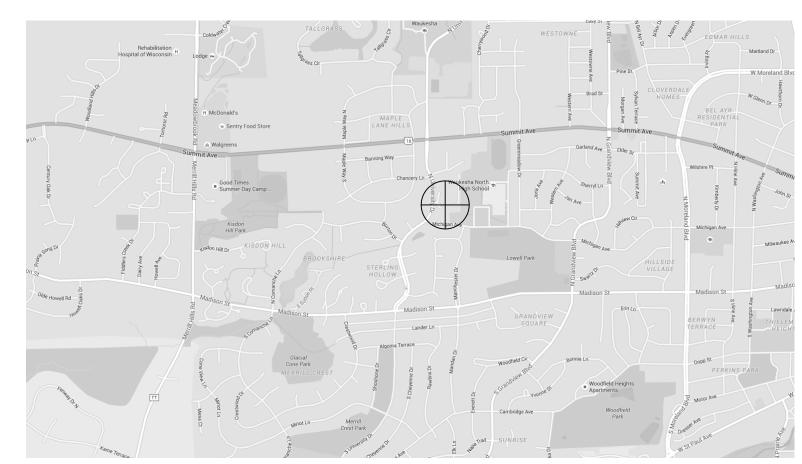

Project Team

Cost Estimate Stier Construction

Tel (262) 574-0306

Structural Graef

Tel (414) 259-1500

SITE PLAN - SYMBOLS LEGEND

NEW LIGHT FIXTURES TEST BORINGS SITE PLAN NOTE SITE PLAN DEMOLITION NOTE

▲ BF → BARRIER FREE ACCESS & ROUTE

— - - — CONSTRUCTION LIMITS

NEW CONCRETE SLAB / WALK / STOOP

NEW STANDARD DUTY ASPHALT PAVING

NEW HEAVY DUTY ASPHALT PAVING

SITE PLAN - GENERAL NOTES

- A. FIELD VERIFY DIMENSIONS AND CONDITIONS AT JOB SITE.
- B. REFER TO SITE SURVEY, GRADING PLAN, SITE UTILITIES PLAN, STORMWATER MANAGEMENT PLAN, EROSION CONTROL PLAN, LANDSCAPING PLAN, PLUMBING PLAN, HVAC PLAN AND ELECTRICAL PLAN FOR ADDITIONAL INFORMATION PERTAINING TO SITE PLANNING.
- C. MARK ALL UTILITIES. ALL DAMAGED UTILITY OR SERVICES ARE TO BE IMMEDIATELY REPAIRED AT NO ADDITIONAL COST TO THE OWNER.
- D. FIELD VERIFY EXISTING FLOOR ELEVATIONS.




SITE PLAN NOTES

- (1) CONCRETE CURB AND GUTTER. REFER TO DETAIL
- 2) CURB RAMP. REFER TO DETAIL
- 3) BARRIER-FREE ACCESSIBLE PARKING SIGNAGE. REFER TO DETAIL 4) "VAN ACCESSIBLE" SIGNAGE. REFER TO DETAIL
- 4" PARKING LOT STRIPING / PAVEMENT MARKINGS. REFER TO DETAIL PRECAST WHEEL STOP.
- CONCRETE STOOP AND SLAB. REFER TO DETAIL
- 8 STOP SIGN.

SITE PLAN DEMOLITION NOTES

- 1 SAWCUT EXISTING PAVEMENT.
- 2 REMOVE EXISTING TREE OR SHRUBS. RELOCATE / REPLANT ANY VALUABLE SPECIES IN OWNER SPECIFIED LOCATION ON PROPERTY.

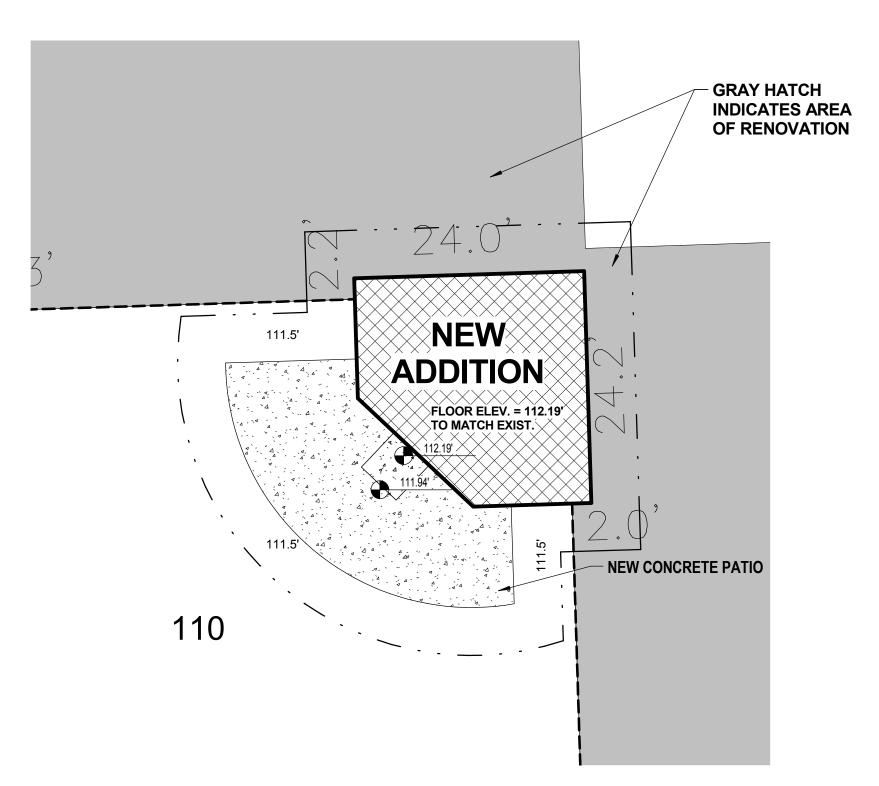

2 ENLARGED SITE PLAN A002 1" = 10'-0"



Subacute Remodel/Addition


WAUKESHA

Job No.: 150222-03 Sheet No.:

Revisions

Drawn By:



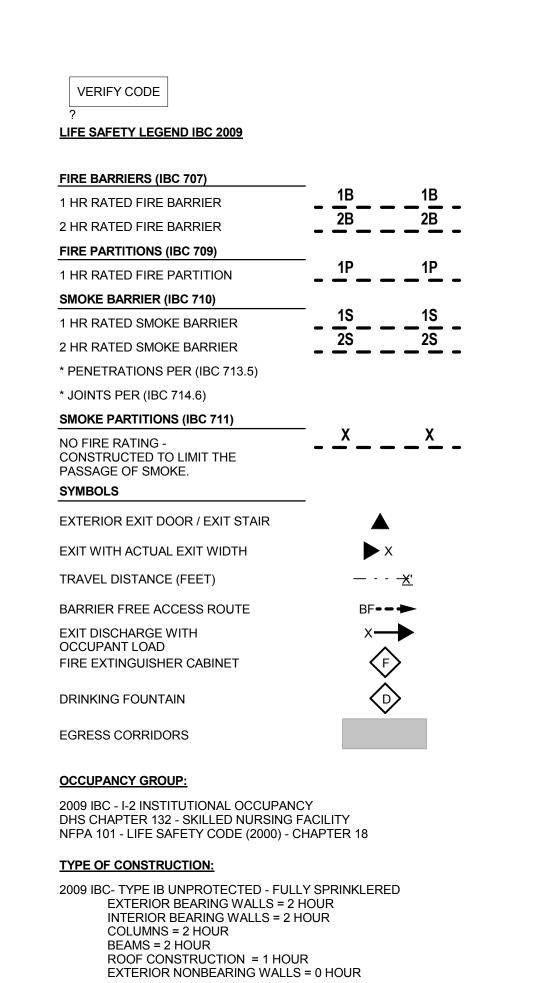

| 7052 | CODE WORKSHEET - SMOKE COMPARTMENT SCHEDUL | | |
|-------------|--|---|--|
| Level | Name | Area | |
| | | | |
| FIRST FLOOR | NEW SMOKE | 9,472 SF | |
| PLAN-OLD | COMPARTMENT 5 | | |
| FIRST FLOOR | EXISTING SMOKE | 7,233 SF | |
| PLAN-OLD | COMPARTMENT 1 | | |
| FIRST FLOOR | EXISTING SMOKE | 4.398 SF | |
| PLAN-OLD | COMPARTMENT 3 | ,,,,,,,,,,,,,,,,,,,,,,,,,,,,,,,,,,,,,,, | |
| FIRST FLOOR | EXISTING SMOKE | 4.428 SF | |
| PLAN-OLD | COMPARTMENT 2 | 1,120 | |
| FIRST FLOOR | EXISTING SMOKE | 1.910 SF | |
| PLAN-OLD | COMPARTMENT 4 | 1,5 15 51 | |

First Floor Building Area

| Footprint: | 27,442 SQ FT |
|------------|--------------|
| Existing: | 17,970 SQ FT |
| Remodel: | 9,472 SQ FT |
| New: | 505 SQ FT |
| Total: | 27,442 SQ FT |


DENGROVE - WAUKESHA - Subacute Remodel/Addition

LINDENGROVE - 425 N. University Drive Waukesha, WI 53188

Drawn By:
TEF
Date:
6/20/16

Job 15022 Shee

150222-03
Sheet No.:

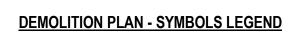

EXISTING WALLS TO REMAIN EXISTING ITEM TO REMAIN = = = = = = = = EXISTING WALLS TO BE REMOVED ----- EXISTING ITEM TO BE REMOVED DEMOLITION PLAN KEYNOTE EXISTING DOOR TO REMAIN ---- CONSTRUCTION LIMITS EXISTING DOOR TO BE REMOVED

DEMOLITION PLAN - GENERAL NOTES

ROOM FINISH SCHEDULE.

- A. VERIFY ALL DIMENSIONS AND CONDITIONS AT JOB SITE. PORTIONS OF EXISTING CONSTRUCTION MAY HAVE BEEN REMOVED BY OWNER.
- B. VERIFY EXACT COMPOSITION OF EXISTING WALLS TO BE REMOVED.
- C. REMOVE FLOOR FINISHES, INCLUDING SETTING BED IN CERAMIC TILE AREAS, WHERE NEW FLOORING IS INDICATED IN
- D. REMOVE SUSPENDED CEILINGS AND RELATED HANGERS, OR GYPSUM BOARD/ PLASTER CEILINGS WHERE NEW CEILINGS ARE INDICATED ON REFLECTED CEILING PLAN OR ROOM FINISH SCHEDULE.
- E. REMOVE ALL COLUMN FINISHES, INCLUDING GYPSUM BOARD AND FURRINGS, FROM EXISTING STRUCTURAL
- REMOVE ALL INTERIOR AND WALL MOUNTED ITEMS IN AREAS TO BE REMODELED (REFER TO ROOM FINISH SCHEDULE) INCLUDING BUT NOT LIMITED TO, CABINETRY, EQUIPMENT, LOCKERS, TOILET PARTITIONS, SHELVING, HOOKSTRIPS,
- HANDRAILS, CLOSET POLES, CHALK AND TACK BOARDS, MIRRORS, WALL AND CEILING TRIM, BASE. REFER TO PLUMBING, HVAC AND ELECTRICAL PLANS FOR ADDITIONAL DEMOLITION ITEMS AND NOTES. COORDINATE WORK WITH DESIGN/BUILID PLUMBING, HVAC AND ELECTRICAL REQUIREMENTS.
- COORDINATE DEMOLITION OF LOAD BEARING WALLS WITH STRUCTURAL PLANS.
- MAINTAIN CONTINUOUS UTILITY SERVICE TO ALL SPACES IN THE BUILDING NOT AFFECTED BY THIS WORK.
- WITH OWNER ANY DISRUPTION IN SERVICES REQUIRED TO PERFORM WORK OR TO MODIFY EXISTING PIPING,

 J. DUCTWORK OR ANY ASSOCIATED EQUIPMENT.

CONSTRUCT A DUST-PROOF PARTITION TO SEPARATE AREAS OF CONSTRUCTION FROM ADJACENT OCCUPIED AREAS OUTSIDE SCOPE OF CONSTRUCTION. REFER TO DETAIL E2/A800.

KEYNOTE LEGEND - DEMOLITION PLAN NOTES DEMOLITION PLAN NOTE

100 REMOVE CEILING, FINISHES, HANDRAILS, ETC.

101 EXISTING BEARING WALL TO REMAIN. REMOVE FINISHES/PARTITIONS. 102 REMOVE PORTION OF BEARING WALL AS SHOWN. COORDINATE WITH STRUCTURAL

103 REMOVE TOPPING SLAB FOR NEW TOILET/SHOWER FLOOR SLOPE. COORDINATE WITH STRUCTURAL DRAWINGS. INFILL NEW SLOPED FLOOR AS REQ'D. 104 REMOVE SLAB ON GRADE FOR NEW TOILET/SHOWER FLOOR SLOPE. COORDINATE WITH STRUCTURAL DRAWINGS. INFILL NEW SLOPED FLOOR AS REQ'D.

105 REMOVE EXTERIOR WALL FOR NEW WINDOW. COORDINATE WITH STRUCTURAL


106 REMOVE EXTERIOR WINDOW FRAMING SYSTEM AND EXTERIOR WALL. COORDINATE WITH STRUCTURAL DRAWINGS.

107 REMOVE ALL PLUMBING FIXTURES, CASEWORK, FINISHES, EQUIP. ETC. FOR NEW RESIDENT ROOM DESIGN.

109 LIGHT COVE

KEY PLAN

CONSTRUCTION ch Architects 11 P Drawn By:

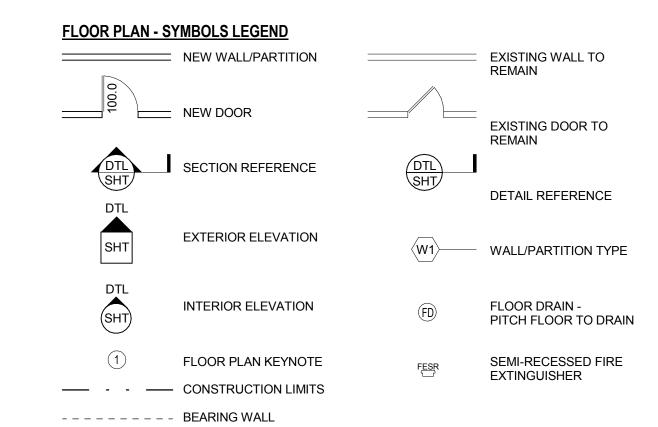

FLOOR PLAN - GENERAL NOTES

- A. DIMENSIONS ON FLOOR PLAN ARE BASED ON FACE OF FINISHED WALL TO FACE OF FINISHED WALL (NOMINAL).
- B. VERIFY ALL DIMENSIONS AND CONDITIONS AT JOB SITE. PORTIONS OF EXISTING CONSTRUCTION MAY HAVE BEEN REMOVED BY OWNER.
- C. MAINTAIN CONTINUOUS UTILITY SERVICE TO ALL SPACES IN THE BUILDING NOT AFFECTED BY THIS WORK. COORDINATE WITH OWNER ANY DISRUPTION IN SERVICES REQUIRED TO PERFORM WORK OR TO MODIFY EXISTING PIPING, DUCTWORK OR ANY ASSOCIATED EQUIPMENT.
- D. REFER TO SHEET --- FOR ROOM FINISH SCHEDULE AND NOTES.
- E. REFER TO SHEET --- FOR DOOR SCHEDULES, DOOR TYPES, AND NOTES.

| NOTE# | FLOOR PLAN NOTE |
|-------|---|
| 200 | NEW EXTERIOR WINDOW, PATCH MATCH EXISTING FINISH, SIZE, AND STYLE |
| 201 | NEW EXTERIOR WINDOW, FATCH MATCH EXISTING FINISH, SIZE, AND STILE |
| 202 | INFILL STRUCTURAL BEARING WALL. PROVIDE FURRING WALL AT EACH FACE TO MATCH EXISTING. COORDINATE WITH STRUCTURAL DRAWINGS. |
| 203 | PATCH TO MATCH FINISHES, FACES, ETC. |
| 204 | INFILL EXISTING DOOR OPENING. PROVIDE FURRING WALL AT EACH FACE TO MATCH EXISTING. COORDINATE WITH STRUCTURAL DRAWINGS. |
| 205 | EXISTING SPRINKLER BOX LOCATION |
| 206 | EXISTING ELECTRIC METER LOCATION |
| 207 | EXISTING TRANSFORMER |

| G2 | METAL COPING SYSTEM: METAL COPING ON TREATED 2x WOOD BLOCKING |
|----|--|
| | SINGLE PLY ROOFING SYSTEM: FULLY ADHERED EPDM MEMBRANE ON RIGID INSULATION (AVG=R-30) (ON VAPOR RETARDER) ON 5/8" EXTERIOR SHEATHIN ON (EDIT FOR ROOF FRAMING/DECKING/VAPOR RETARDER). |
| | ON (EDIT FOR ROOF FRAMING/DECKING/VAPOR RETARDER). |
| | |

KEYNOTE LEGEND - CONSTRUCTION TYPES

CONSTRUCTION DESCRIPTION

GYPSUM BOARD PARTITIONS - GENERAL NOTES

ALL GYPSUM BOARD PARTITIONS SHALL BE \langle A4 \rangle UNLESS OTHERWISE NOTED ON FLOOR

GYPSUM BOARD PARTITION DIMENSIONS ON FLOOR PLAN ARE BASED ON FACE OF FINISHED PARTITION TO FACE OF FINISHED PARTITION (NOMINAL).

REFER TO GYPSUM BOARD SPECIFICATION FOR LOCATION AND TYPE(S) OF GYPSUM BOARD MATERIAL REQUIRED.

PROVIDE FIRE RATED GYPSUM BOARD AT ALL FIRE RATED PARTITIONS. SEAL ALL WALL PENETRATIONS AT PERIMETER AND FIRESTOP ALL FIRE RATED PARTITIONS.

EXTEND ALL GYPSUM BOARD PARTITIONS FULL HEIGHT TO UNDERSIDE OF STRUCTURE ABOVE. AT METAL DECK CONSTRUCTION ABOVE PROVIDE SLIP JOINT BETWEEN TOP OF PARTITION AND UNDERSIDE OF METAL DECK / STRUCTURAL STEEL MEMBER ABOVE. REFER

MASONRY PARTITIONS - GENERAL NOTES

MASONRY PARTITIONS INDICATED WITH THE FOLLOWING HATCH PATTERN: ALL MASONRY PARTITIONS SHALL BE 8" CONCRETE BLOCK UNLESS OTHERWISE NOTED OR

DIMENSIONED. REFER TO FLOOR PLAN FOR PARTITION THICKNESS.


PROVIDE UL RATED CONCRETE BLOCK AT ALL FIRE RATED PARTITIONS.

SEAL ALL WALL PENETRATIONS AT PERIMETER AND FIRESTOP ALL RATED PARTITIONS. EXTEND CONCRETE BLOCK PARTITIONS FULL HEIGHT TO UNDERSIDE OF STEEL DECK ABOVE (OR PRECAST PLANK ABOVE IF APPLICABLE). REFER TO DETAIL - / --- PROVIDE HORIZONTAL MASONRY JOINT REINFORCEMENT AT 16" OC VERTICALLY. REFER TO STRUCTURAL DRAWINGS FOR VERTICAL REINFORCEMENT REQUIREMENTS.

| I" AIR M ON 8" RIZONTA FOR LASHING NTS. /BOTTOM |
|---|
| , I |

| KEYNOTE LEGEND - INTERIOR PARTITION TYPES |
|---|
| WALL. PROVIDE 2" RIGID FOUNDATION INSULATION, EXTEND 48" VERTICALLY ON WALL AND 24" HORIZONTALLY BELOW FLOOR SLAB. |
| OF CAVITY. REFER TO DETAIL XX/AXXX. EXTERIOR WALL (BELOW GRADE): REINFORCED CAST-IN-PLACE CONCRETE FOUNDATIO |
| CAVITY WEEPS/VENTS @ 24" OC AND MASONRY EXPANSION AND CONTROL JOINTS. COMPARTMENTALIZE THE CAVITY AND PROVIDE CAVITY WEEPS/VENTS AT TOP/BOTTON |
| MASONRY JOINT REINFORCING @ 16" OC (REFER TO STRUCTURAL DRAWINGS FOR REQUIRED VERTICAL REINFORCING). PROVIDE CAVITY DRAINAGE MATERIAL, FLASHING |

| | RETHOTE LEGEND - INTERIOR FARTITION TIFES |
|-----|--|
| TAG | INTERIOR PARTITION DESCRIPTION |
| | |
| 101 | EXISTING BEARING WALL TO REMAIN. REMOVE FINISHES/PARTITIONS. |
| A4 | INTERIOR STEEL STUD PARTITION: 3-5/8" STEEL STUDS @ 16" OC WITH 3" SOUND ATTENUATION INSULATION AND ONE LAYER 5/8" GYPSUM BOARD @ EACH FACE. PROVIDE 1 HR RATED UL #U465 DESIGN WHERE 1 HR CONSTRUCTION IS INDICATED ON PLANS. |
| F3 | INTERIOR FURRING (PARTITION): 2-1/2" STEEL STUDS @ 16" OC WITH ONE LAYER 5/8" GYPSUM BOARD. |
| F4 | INTERIOR FURRING (PARTITION): 3-5/8" STEEL STUDS @ 16" OC WITH ONE LAYER 5/8" |

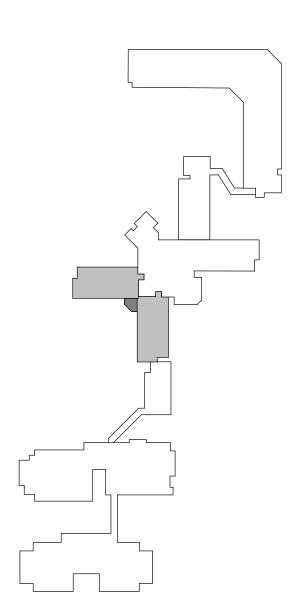

KEY PLAN

Sheet No.:


Revisions

Drawn By:

Remodel/Addition

1 FLOOR PLAN - WEST AND SOUTH UNIT SUBACUTE REMODEL
A201 1/8" = 1'-0"

2 SECOND FLOOR A201 1/8" = 1'-0"

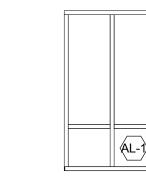

EXTERIOR FINISH PATTERNS

EXTERIOR ELEVATIONS - GENERAL NOTES

A. PAINT ALL EXPOSED STEEL LINTELS TO MATCH ADJACENT MASONRY COLOR B. TRIM ALL EXTERIOR LIGHTING FIXTURES, OUTLETS, HOSE BIBBS AND ALL OTHER SIDING PENETRATIONS WITH 1X4 FIBER CEMENT TRIM (TY

C. REFER TO SHEET FOR WINDOW FRAME ELEVATIONS D. SEALANT COLORS TO MATCH ADJACENT FINISHED SURFACES.

KEYNOTE LEGEND - EXTERIOR WALL TYPES EXTERIOR WALL DESCRIPTION W1 EXTERIOR WALL: MASONRY CAVITY WALL CONSISTING OF 4" FACE BRICK, 1-3/4" AIR SPACE, 3" RIGID INSULATION, SPRAY APPLIED AIR AND VAPOR BARRIER SYSTEM ON 8" CONCRETE MASONRY UNIT BACK-UP WALL WITH ADJUSTABLE (TWO-PIECE) HORIZONTAL MASONRY JOINT REINFORCING @ 16" OC (REFER TO STRUCTURAL DRAWINGS FOR REQUIRED VERTICAL REINFORCING). PROVIDE CAVITY DRAINAGE MATERIAL, FLASHING, CAVITY WEEPS/VENTS @ 24" OC AND MASONRY EXPANSION AND CONTROL JOINTS. COMPARTMENTALIZE THE CAVITY AND PROVIDE CAVITY WEEPS/VENTS AT TOP/BOTTOM OF CAVITY. REFER TO DETAIL XX/AXXX. WB3 EXTERIOR WALL (BELOW GRADE): REINFORCED CAST-IN-PLACE CONCRETE FOUNDATION WALL. PROVIDE 2" RIGID FOUNDATION INSULATION, EXTEND 48" VERTICALLY ON WALL AND 24" HORIZONTALLY BELOW FLOOR SLAB.


| KEYNOTE LEGEND - CONSTRUCTION TYPES | | |
|--|---|--|
| TAG | CONSTRUCTION DESCRIPTION | |
| C1 | LAY-IN CEILING PANELS IN EXPOSED GRID SYSTEM SUSPENDED FROM STRUCTURE ABOVE. | |
| C2 | 5/8" GYPSUM BOARD CEILING ON METAL SUSPENSION SYSTEM SUSPENDED FROM STRUCTURE ABOVE. | |
| E2 | ALUMINUM STOREFRONT SYSTEM WITH INSULATING GLASS. | |
| G2 | METAL COPING SYSTEM: METAL COPING ON TREATED 2x WOOD BLOCKING | |
| R2 | SINGLE PLY ROOFING SYSTEM: FULLY ADHERED EPDM MEMBRANE ON RIGID INSULATION (AVG=R-30) (ON VAPOR RETARDER) ON 5/8" EXTERIOR SHEATHING ON (EDIT FOR ROOF FRAMING/DECKING/VAPOR RETARDER). | |


| | KEYNOTE LEGEND - EXTERIOR ELEVATION NOTES |
|-------|---|
| NOTE# | EXTERIOR ELEVATION NOTE |
| | |
| 400 | EXISTING BUILDING |
| 401 | EXTERIOR 4" FACE BRCIK. MATCH BRICK TO EXISTING BLDG BASE COLOR |
| 402 | EXTERIOR 4" FACE BRICK. |
| | |



D4 DINING ADDITION PERSPECTIVE

SECOND FLOOR 110'-8" E2 DINING FIRST FLOOR PLAN-OLD
100'-0" D1 WALL SECTION - DINING WINDOW 1/2" = 1'-0"

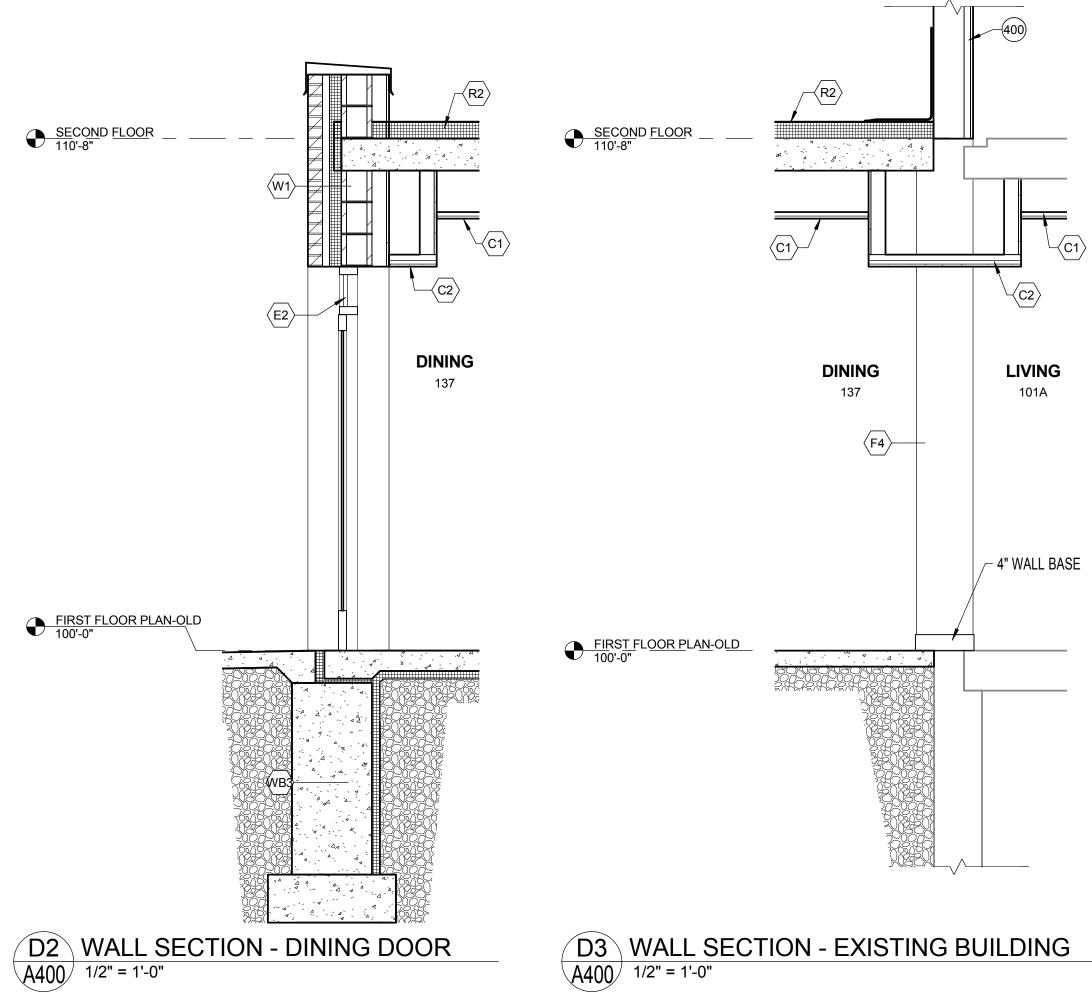

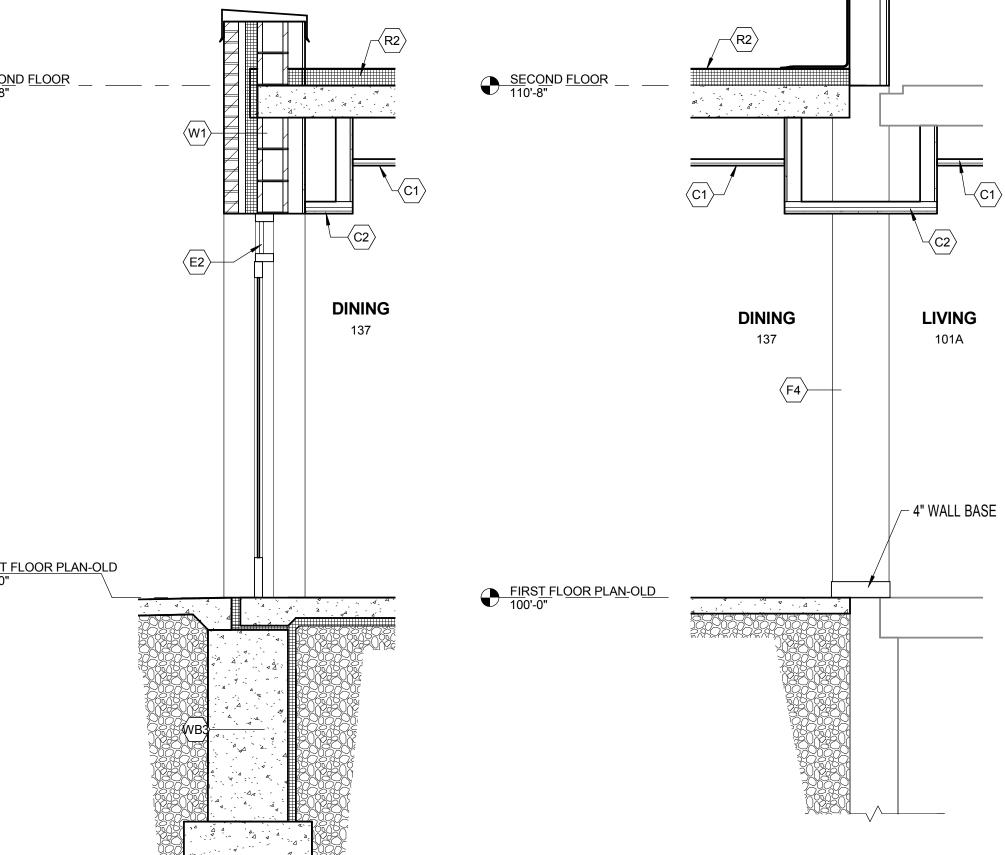

Subacute Remodel/Addition

WAUKESHA