

VINCENT JAMES MENTORING - BUILDING UPGRADES

307 E MAIN STREET | WAUKESHA, WI 53186

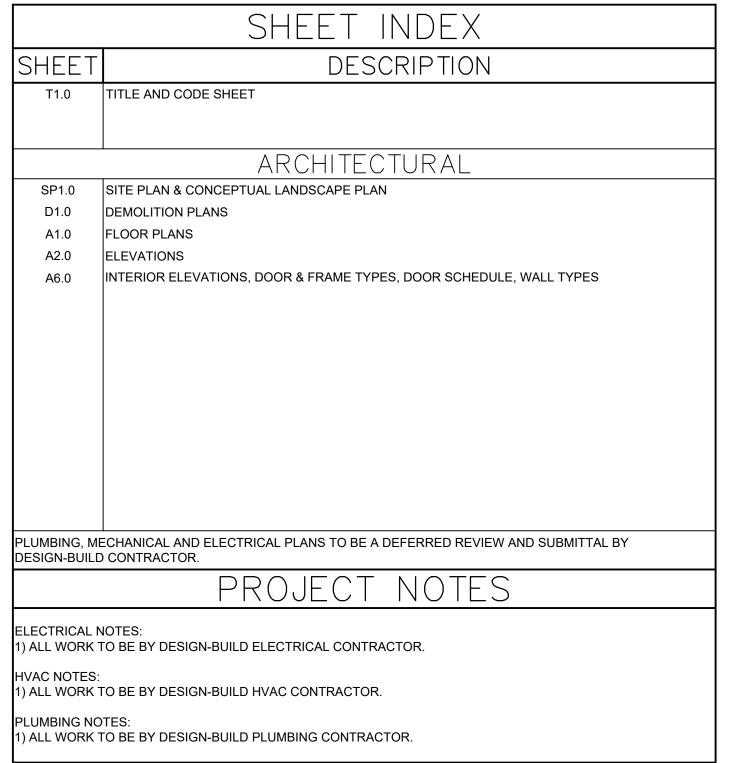

BASED ON THE:	WISCONSIN COMMERCIAL BUILDING CODE (2015 INTERNATIONAL BUILDING CODE w/WI AMENDMENTS) 2015 INTERNATIONAL EXISTING BUILDING CODE 2009 ANSI A117.1 ACCESSIBILITY CODE				
	2009 ANSI ATTI. I ACCESSIBILITY CODE				
	ALL OTHER CODES AND ORDINANCES AS REFERENCED BY THE ABOVE CODES.				
AREA OF ALTERATION:	TOTAL AREA OF ALTERATION: 270 S.F. TOTAL FIRST FLOOR FOOTPRINT: 2,620 S.F. TOTAL SECOND FLOOR FOOTPRINT: 1,494 S.F.				
FIRE ALARM:	NOT REQUIRED PER IBC 907.2.2				
OCCUPANCY:	B (BUSINESS)				
OCCUPANCY SEPARATION:	NONE				
	EXISTING, UNCHANGED				
CONSTRUCTION TYPE:					
	NOT REQUIRED				
SPRINKLER SYSTEM:					
SPRINKLER SYSTEM: NUMBER OF FLOOR LEVELS:	NOT REQUIRED				
CONSTRUCTION TYPE: SPRINKLER SYSTEM: NUMBER OF FLOOR LEVELS: ALTERATION LEVEL: FLAME SPREAD & SMOKE INDEX:	NOT REQUIRED 2 FLOORS & LOWER LEVEL				

PLUMBING FIXTURE REQUIREMENTS PER TABLE 2902.1	
BUSINESS OCCUPANT LOAD: 42 OCCUPANTS	
WATER CLOSETS REQUIRED:	WC PROVIDED:
1 PER 25 = 1.68	2
LAVATORIES REQUIRED:	LAVS PROVIDED:
1 PER 40 = 1.05	2
DRINKING FOUNTAINS = 1 PER 100 = 1 REQUIRED	SEE CODE EXCEPTIONS
OTHER: 1 SERVICE SINK REQUIRED PER BUILDING	

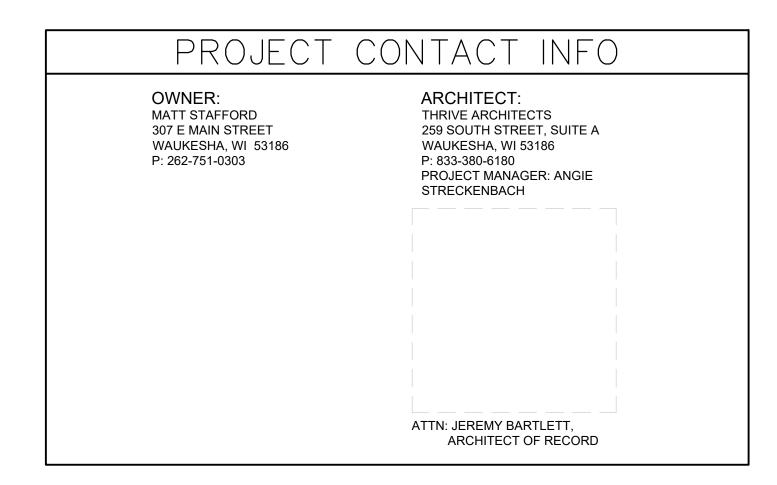

GENERAL NOTES APLIANCE WITH ALL GOVERNING CODES, ORDINANCES & STANDARDS. THE CONTRACTIONS APPROGRAMS IN CONNECTION WITH THE

- . CONSTRUCTION IS TO BE IN COMPLIANCE WITH ALL GOVERNING CODES, ORDINANCES & STANDARDS. THE CONTRACTOR(S) SHALL BE RESPONSIBLE FOR INITIATING, MAINTAINING, & SUPERVISING ALL SAFETY PRECAUTIONS & PROGRAMS IN CONNECTION WITH THE PERFORMANCE OF THIS PROJECT.


 . ARCHITECT/DESIGNER SHALL NOT BE RESPONSIBLE FOR ANY COST, SCHEDULE OR CONSTRUCTION ISSUES ARISING DUE GC/OWNERS FAILURE TO DISTRIBUTE ALL DOCS. SUBCONTRACTORS & SUPPLIERS SHOULD ENDEAVOR TO REVIEW A COMPLETE SET OF DOCS BEFORE BIDDING, FABRICATING
- 3. GC, SUBCONTRACTORS, MATERIAL SUPPLIERS, OWNER, ETC. MUST NOTIFY ARCHITECT OF ANY ERRORS, OMISSIONS, OR DEFECTS IN THE CONSTRUCTION DOCUMENTS PRIOR TO BIDDING, FABRICATING OR INSTALLING WORK.
- 4. SITE DIMENSIONS ARE TO BE FIELD VERIFIED AND ADJUSTED ACCORDINGLY. THE ARCHITECT/DESIGNER SHALL BE NOTIFIED OF ANY VARIANCES BEFORE CONTRACTOR BEGINS OR PROCEEDS WORK.
- 5. MECH, ELEC, PLUMB & FIRE PROTECTION ARE TO BE DESIGN BUILT, COMPLYING WITH ALL GOVERNING CODES, ORDINANCES & STANDARDS, WHICH WILL BE THE FULL RESPONSIBILITY OF THE CONTRACTOR; THE ARCHITECT ASSUMES NO LIABILITY.
- 6. ALL MECH, ELEC, PLUMB & FIRE PROTECTION SYSTEMS/EQUIP. SHALL BE MAINTAINED ACCORDING TO MANUFACTURER'S STANDARDS. BLDG. OWNER SHALL ASSUME FULL RESPONSIBILITY FOR MAINTANANCE/OPPERATION UPON OCCUPANCY.
- 7. THE INSTALLATION AND EXECUTION OF ALL MATERIALS SHALL BE IN ACCORDANCE WITH THE MANUFACTURER'S STANDARDS AND SPECIFICATIONS.

 ALL MEANS & METHODS OF CONSTRUCTION TO BE THE SOLE RESPONSIBILITY OF THE GC.
- 8. PORTABLE FIRE EXTINGUISHERS SHALL BE PROVIDED IN OCCUPANCIES AND LOCATIONS AS REQUIRED BY THE INTERNATIONAL FIRE CODE. INSTALLATION LOCATIONS SHALL HAVE A MAXIMUM TRAVEL DISTANCE OF 75' TO ANY EXTINGUISHER. EXTINGUISHERS SHALL BE LOCATED IN CONSPICUOUS LOCATIONS WERE THEY WILL BE READILY ACCESSIBLE AND IMMEDIATELY AVAILABLE FOR USE, TYPICALLY ALONG PATHS OF TRAVEL. EXTINGUISHERS SHALL NOT BE OBSTRUCTED FROM VIEW, IF VISUAL OBSTRUCTION CAN NOT BE AVOIDED ANOTHER MEANS SHALL BE PROVIDED TO INDICATE THE EXTINGUISHER LOCATIONS. EXTINGUISHERS NOT EXCEEDING 40" SHALL BE INSTALLED SO THAT ITS TOP IS NOT MORE THAN 3'-6" ABOVE THE FLOOR. THE CLEARANCE BETWEEN THE FLOOR AND BOTTOM OF HAND HELD UNITS SHALL NOT BE LESS THAN 4". VERIFY EXTINGUISHER LOCATIONS W/ LOCAL
- FIRE DEPT. & OWNER PRIOR TO INSTALLATION.

 9. ALL CONCRETE FLAT WORK MUST BE WET CURED PER ACI REQUIREMENTS AND/OR CURED USING A CURING COMPOUND. REFER TO STRUCTURAL NOTES FOR CURING COMPOUND SPECS. CONTRACTOR IS RESPONSIBLE FOR APPLYING CURING COMPOUNDS PER THE MANUFACTURER'S REQUIREMENTS.

TYPICAL ABBREVIATIONS							
ABV: Above ACOUS: Acoustical ADDL: Additional ADH: Adhesive ADJ: Adjustable AFF: Above Finish Floor AGG: Aggregate AUJ: Authority Having Authority Having AUT: Alternate ALUM: Aluminum ANC: Anchor, Anchorage AB: Anchor Bolt ANOD: Anodized APX: Approximate APT: Apartment ARCH: Architect architectural) ASPH: Asphalt AUTO: Automatic	B/O: By Others BO: Bottom Of BR: Bedroom CAB: Cabinet CALC: Calculation CD: Cabinet Door CG: Corner Guard CIP: Cast—In—Place (Concrete) CL: Centerline CO: Clean Out CONTR: Contract (or) COORD: Coordinate CRPT: Carpet CIP: cast—in—place CLK: Caulking CAS: Casement CB: Catch Basin CLG: Ceiling CT: Cergamic Tile	DW: Dishwasher DIV: Division DR: Door DH: Double Hung DS: Downspout DRWR: Drawer DT: Drain Tile DWG: Drawing D: Nail Size EW: Each Way E: East EL: Elevation ELEV: Elevation EQ: Equal EQP: Equipment EXCV: Excavate EXH: Exhaust EXIST: Exterior	FTG: Footing FND: Foundation FRM: Fram(d), (ing) FBO: Furnished by Others FUR: Furred GA: Gage, Gauge GAL: Gallon GL: Glass, Glazing GI: Galvanized Iron GLBK: Glass Block GLB: Glue Laminated Beam GT: Grout GRD: Grade, Grading GWB: Gypsum Wall Board HWD: Hardware HDR: Header HTG: Heating HVAC: Heating, Ventilation—Air Conditioning	LB: Pound LAM: Laminate(d) LAV: Lavatory LH: Left Hand L: Length LOA: Length Overall LT: Light LF: Lineal Feet LL: Live Load LVL: Laminated Veneer Lumber LVR: Louver MFR: Manufacturer MO: Masonry Opening MAX: Moximum MAS: Masonry MECH: Mechanic(al) MC: Medicine Cabinet MED: Medium MDF: Medium Density	NO, #: Number O: Non-Operable Window Section OBS: Obscure OC: On Center OP: Opaque OPG: Opening OSB: Orientated Strand Board OD: Outside Diameter PMT: Paint(ed) PBD: Particle Board PRT: partition PVMT: Pavement PERF: Perforate(d) PLAS: Plaster PLAM: Plastic Laminate PLT: Plate PLYWD: Plywood PCC: Precast Concrete	REFR: Ref REG: Register RE: Reinforced REQ'D: Required RA: Return Air REV: Revision R: Riser RD: Rod R&S: Rod and Shelf RFG: Roofing RM: Room RO: Rough Opening SCH: Schedule SCN: Screen SECT: Section SGD: Sliding Glass Door SHTH: Sheet SH: Shelf, Shelving SIM: Similar	TEMP: Tempered TK: Tight Knot T&G: Tongue and Groove T/O: Top of TOC: Top of Concrete TOW: Top of Wall TB: Towel Bar T: Tread TS: Tubular Steel TYP: Typical UL: Underwriters Laboratory UNF: Unfinished UNO: Unless Noted Otherwis VB: Vapor Barrier VAR: Varnish VIF: Verify In Field VRN: Veneer VERT: Vertical VG: Vertical VG: Vertical
AVE: Avenue	CI: Ceramic IIIe CIR: Circle	FOC: Face of Concrete	HT: Height	Fiberboard	PCC: Precast Concrete PCF: Pounds Per Cubic Foot	SKL: Skylight	VIN: Vinyl Sheet
AVR: Average AWN: Awning	CIR: Circle CLR: Clear COL: Column CONC: Concrete	FOF: Face of Finish FOM: Face of Masonry FOS: Face of Studs	HC: Hollow Core HOR: Horizontal HB: Hose Bib	MDO: Medium Density Overlay MBR: Member MMB: Membrane	PLF: Pounds Per Linear Foot PSF: Pounds Per Square Foot	S: South SLB: Slab SLD: Slider(ing)	WL: Wall WC: Water Closet
BSMT: Basement BM: Beam BVL: Beveled BITUM: Bituminous BLK: Block	CMU: Concrete Masonry Unit CONST: CONSTruction CONT: Continuous CJT: Control Joint	FOW: Face of Wall FBD: Fiberboard FCB: Fiber Cement Board FGL: Fiberglass FIN: Finish	IN: Inch INCL: Include ID: Inside Diameter INS: Insulate	MTL: Metal MWK: Millwork MIN: Minimum MIR: Mirror MISC: Miscellaneous	PSI: Pounds Per Square Inch PBF: Prefabricated PRF: Preformed PT: Pressure Treated PL: Property Line	SPEC: Specification SQ: Square STD: Standard STV: Stove STL: Steel	WH: Water Heater WP: Water Proofing WR: Weather Resistant WRB: Weather Resistive Barrier
BLKG: Blocking BLW: Below BLDV: Boulevard BTW: Between	CORR: Corrugated CUFT: Cubic Foot CUYD: Cubic Yard	FFE: Finished Floor Elevation FA: Fire Alarm FE: Fire Extinguisher FPL: Fireplace	INT: Interior INV: Invert JNT: Joint	MOD: Module MLD: Moulding MLB: Micro Laminate Beam	PH: Toilet Paper Hanger QTY: Quantity QT: Quarry Tile	STR: Structural SA: Supply Air SC: Solid Core SW: Shear Wall	WWF: Welded Wire Fabric WWM: Welded Wire Mesh W: West WIN: Window
3D: Board 3OT: Bottom 3LDG: Building 3UR: Built Up Roofina	DP: Dampproofing DTL: Detail DIA: Diameter DIM: Dimension	FLSH: Flashing FLR: Floor FLOR: Fluorescent FT: Foot, Feet	JST: Joist KD: Kiln Dried KIT: Kitchen	NOM: Nominal N: North NIC: Not in Contract NTS: Not To Scale	RAD: Radius REF: Reference RFL: Reflect(ed),(ive),(or)	SS: Stainless Steel SYS: System TEL: Telephone	W/O: Without W/: With WD: Wood

& INSTALL.

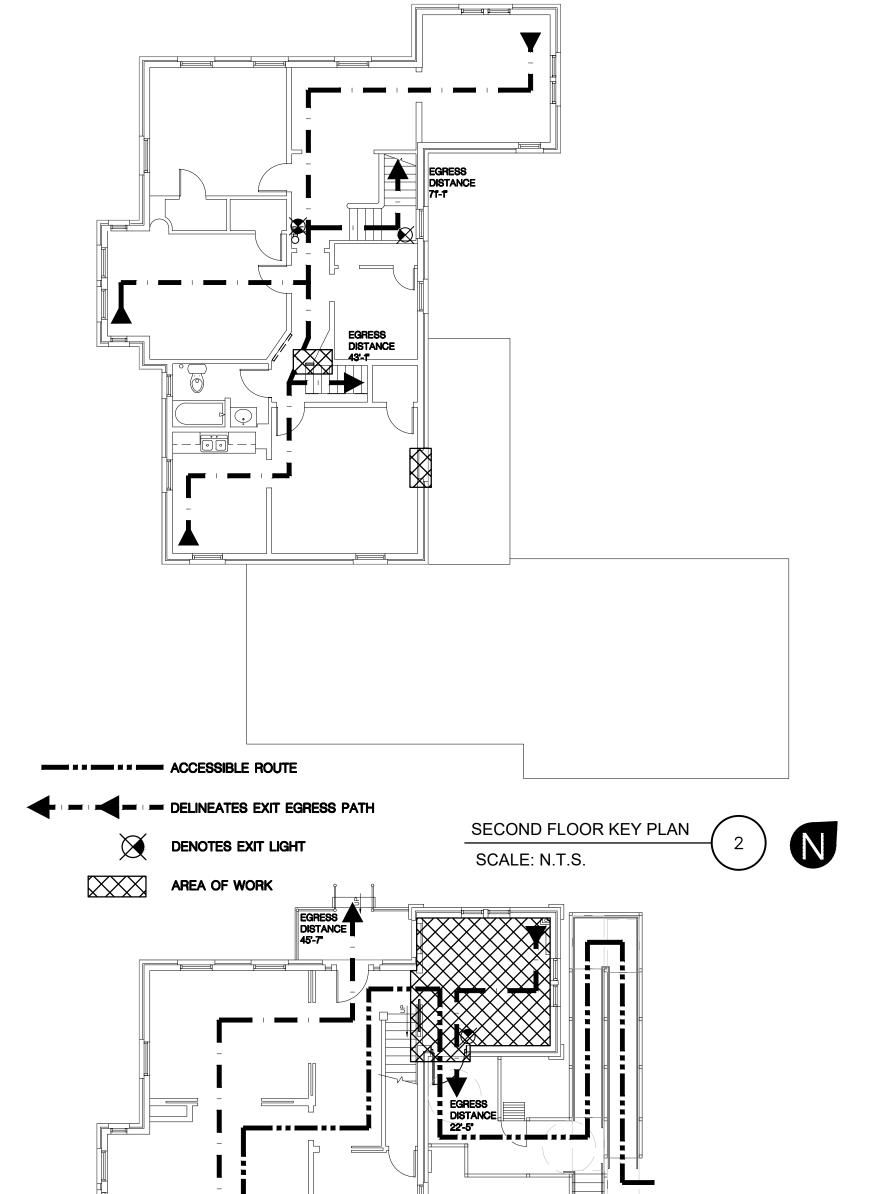

EGRESS DISTANCE 45'-11

FIRST FLOOR KEY PLAN

SCALE: N.T.S.

DISTANCE 19'-2"



Architect

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Project Info. — 23060 - VINCENT JAMES MENTORING

BUILDING UPGRADES

307 E Main Street Waukesha, WI 53186

TITLE AND CODE SHEET

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KJV	ALS		

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-Sheet No. _____


SITE PLAN KEYNOTES

- PRIVACY SHRUBS AROUND BACKYARD PERIMETER, COORDINATE QUANTITY AND LOCATION WITH OWNER, GOLD CONE JUNIPER OR SIMILAR, TYP.
- NEW SHRUBS: GOLD CONE JUNIPER, ABRORVITAE OR SIMILAR, TYP.

 CONIFEROUS; MIX IN DECIDUOUS SHRUB HYDRANGEA, WIGELA OR
- (3) WOOD CHIP MULCH, TYP.
- 4 PERENNIALS, DAYLILY, GRASSES, OR SIMILAR, TYP.
- (5) HOSTAS, TYP.
- 6 EXISTING STOOP TO REMAIN, PROVIDE NEW CONCRETE STEPS AND METAL HANDRAIL @ 36"
- 7 REGRADE YARD AS REQUIRED TO MEET NEW SIDEWALKS, PROVIDE DRAINAGE
- $\langle 8 \rangle$ NEW SIDEWALK TO BE LEVEL WITH EXISTING CITY SIDEWALK
- 9 PROVIDE NEW LADDER TO CELLAR BELOW; PROVIDE GATE AT OPENING FROM RAISED DECK
- (10) NOT USED
- WOOD FRAMED RAMP WITH WOOD DECKING, VERIFY EXACT HEIGHTS IN FIELD, NOT TO EXCEED 1:12 SLOPE; PROVIDE WOOD RAILING @ 42" AND WOOD HANDRAIL @ 36"; SEE DETAIL 2/SP1.0
- (12) FREESTANDING WOOD FENCE WITH 36" WIDE GATE
- (13) STONE PATH
- (14) FEATURE SHRUB, UNFORGETTABLE FIRE BURNING BUSH OR SIMILAR
- (15) EXISTING STOOP & RAILING TO REMAIN
- NEW CONCRETE WALK, RUNNING SLOPE TO BE NOT GREATER THAN 1:20, CROSS SLOPE NOT GREATER THAN 1:48
- (17) ADA PARKING SIGN, SEE DETAIL 3/SP1.0


GENERAL NOTES

1. LANDSCAPE DESIGNER TO PROVIDE SPECIFIC SPECIES AND LAYOUT — THIS PLAN IS FOR REFERENCE ONLY

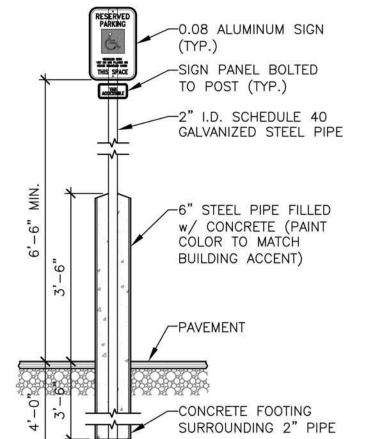


ADA PARKING SIGN DETAIL

SCALE: 1/2"=1'-0" (22x34); 1/4"=1'-0" (11x17)

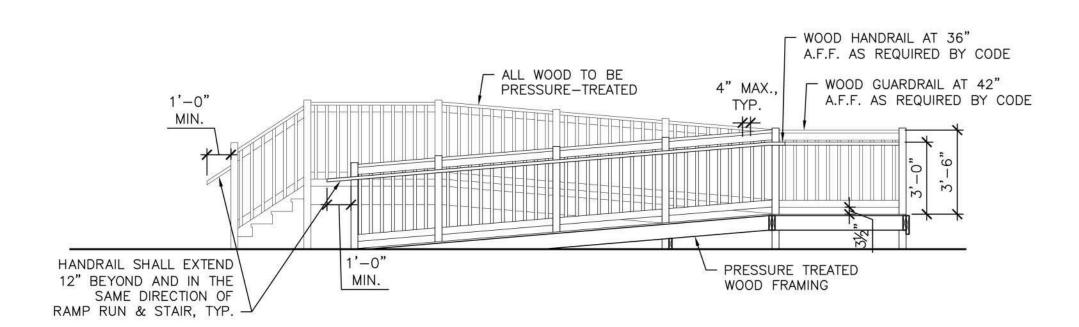

RAMP DETAIL

SCALE: 1/4"=1'-0" (22x34); 1/8"=1'-0" (11x17)

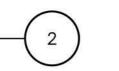





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Project Info. — 23060 – VINCENT JAMES

BUILDING UPGRADES

307 E Main Street Waukesha, WI 53186

MENTORING

—Sheet Title ——

SITE PLAN &
CONCEPTUAL
LANDSCAPE PLAN


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BUILDING UPGRADES

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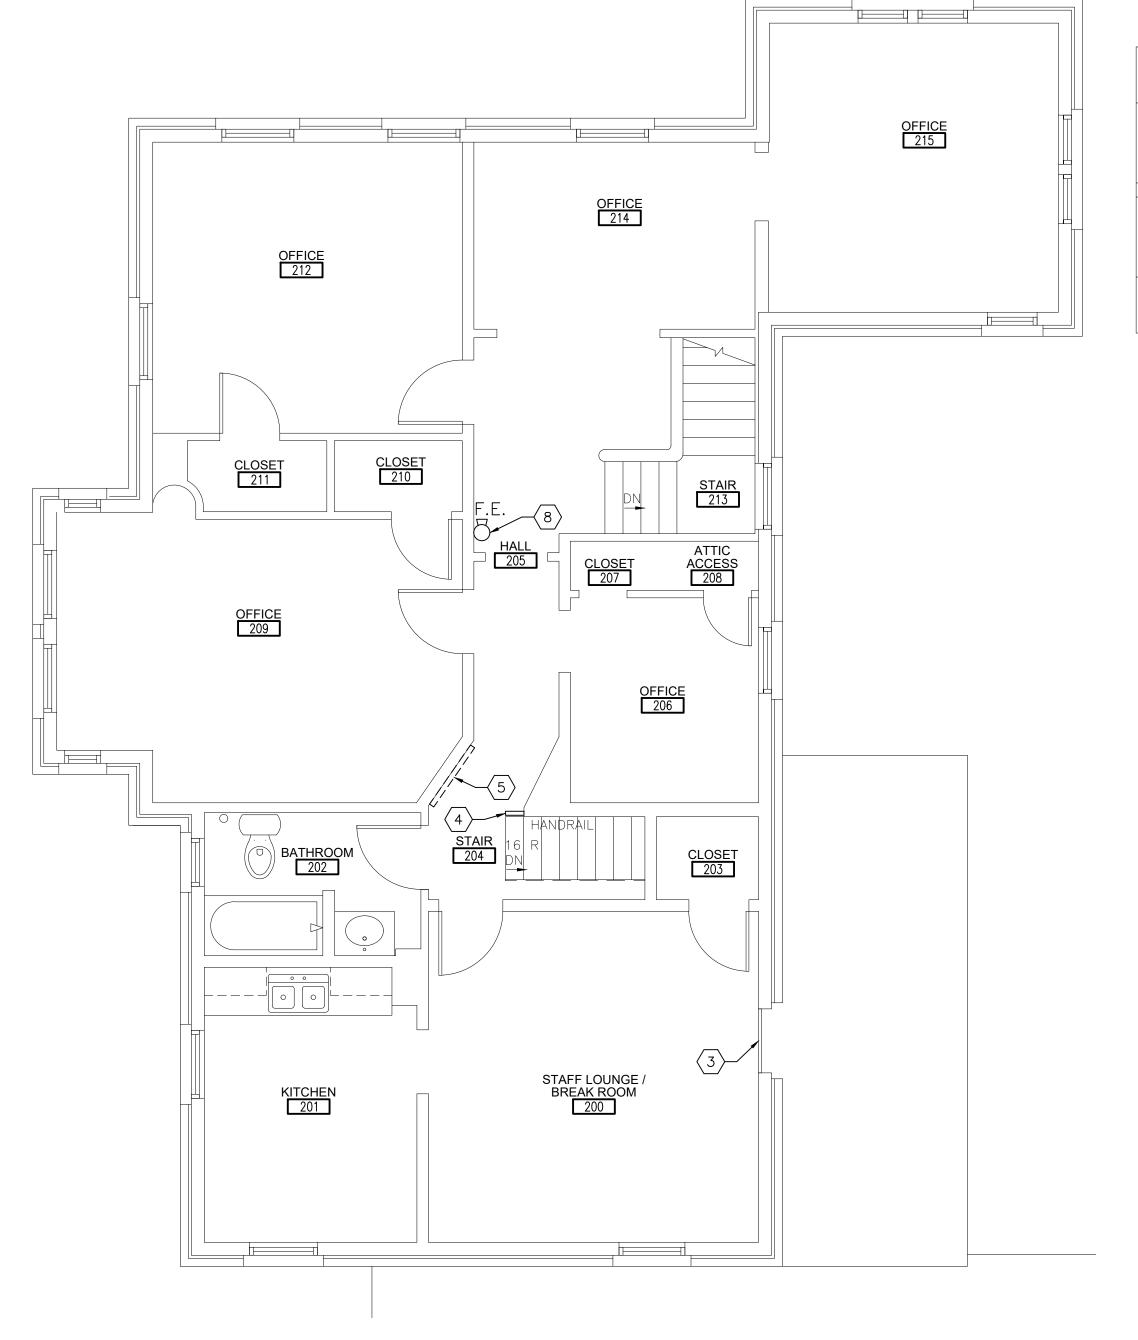
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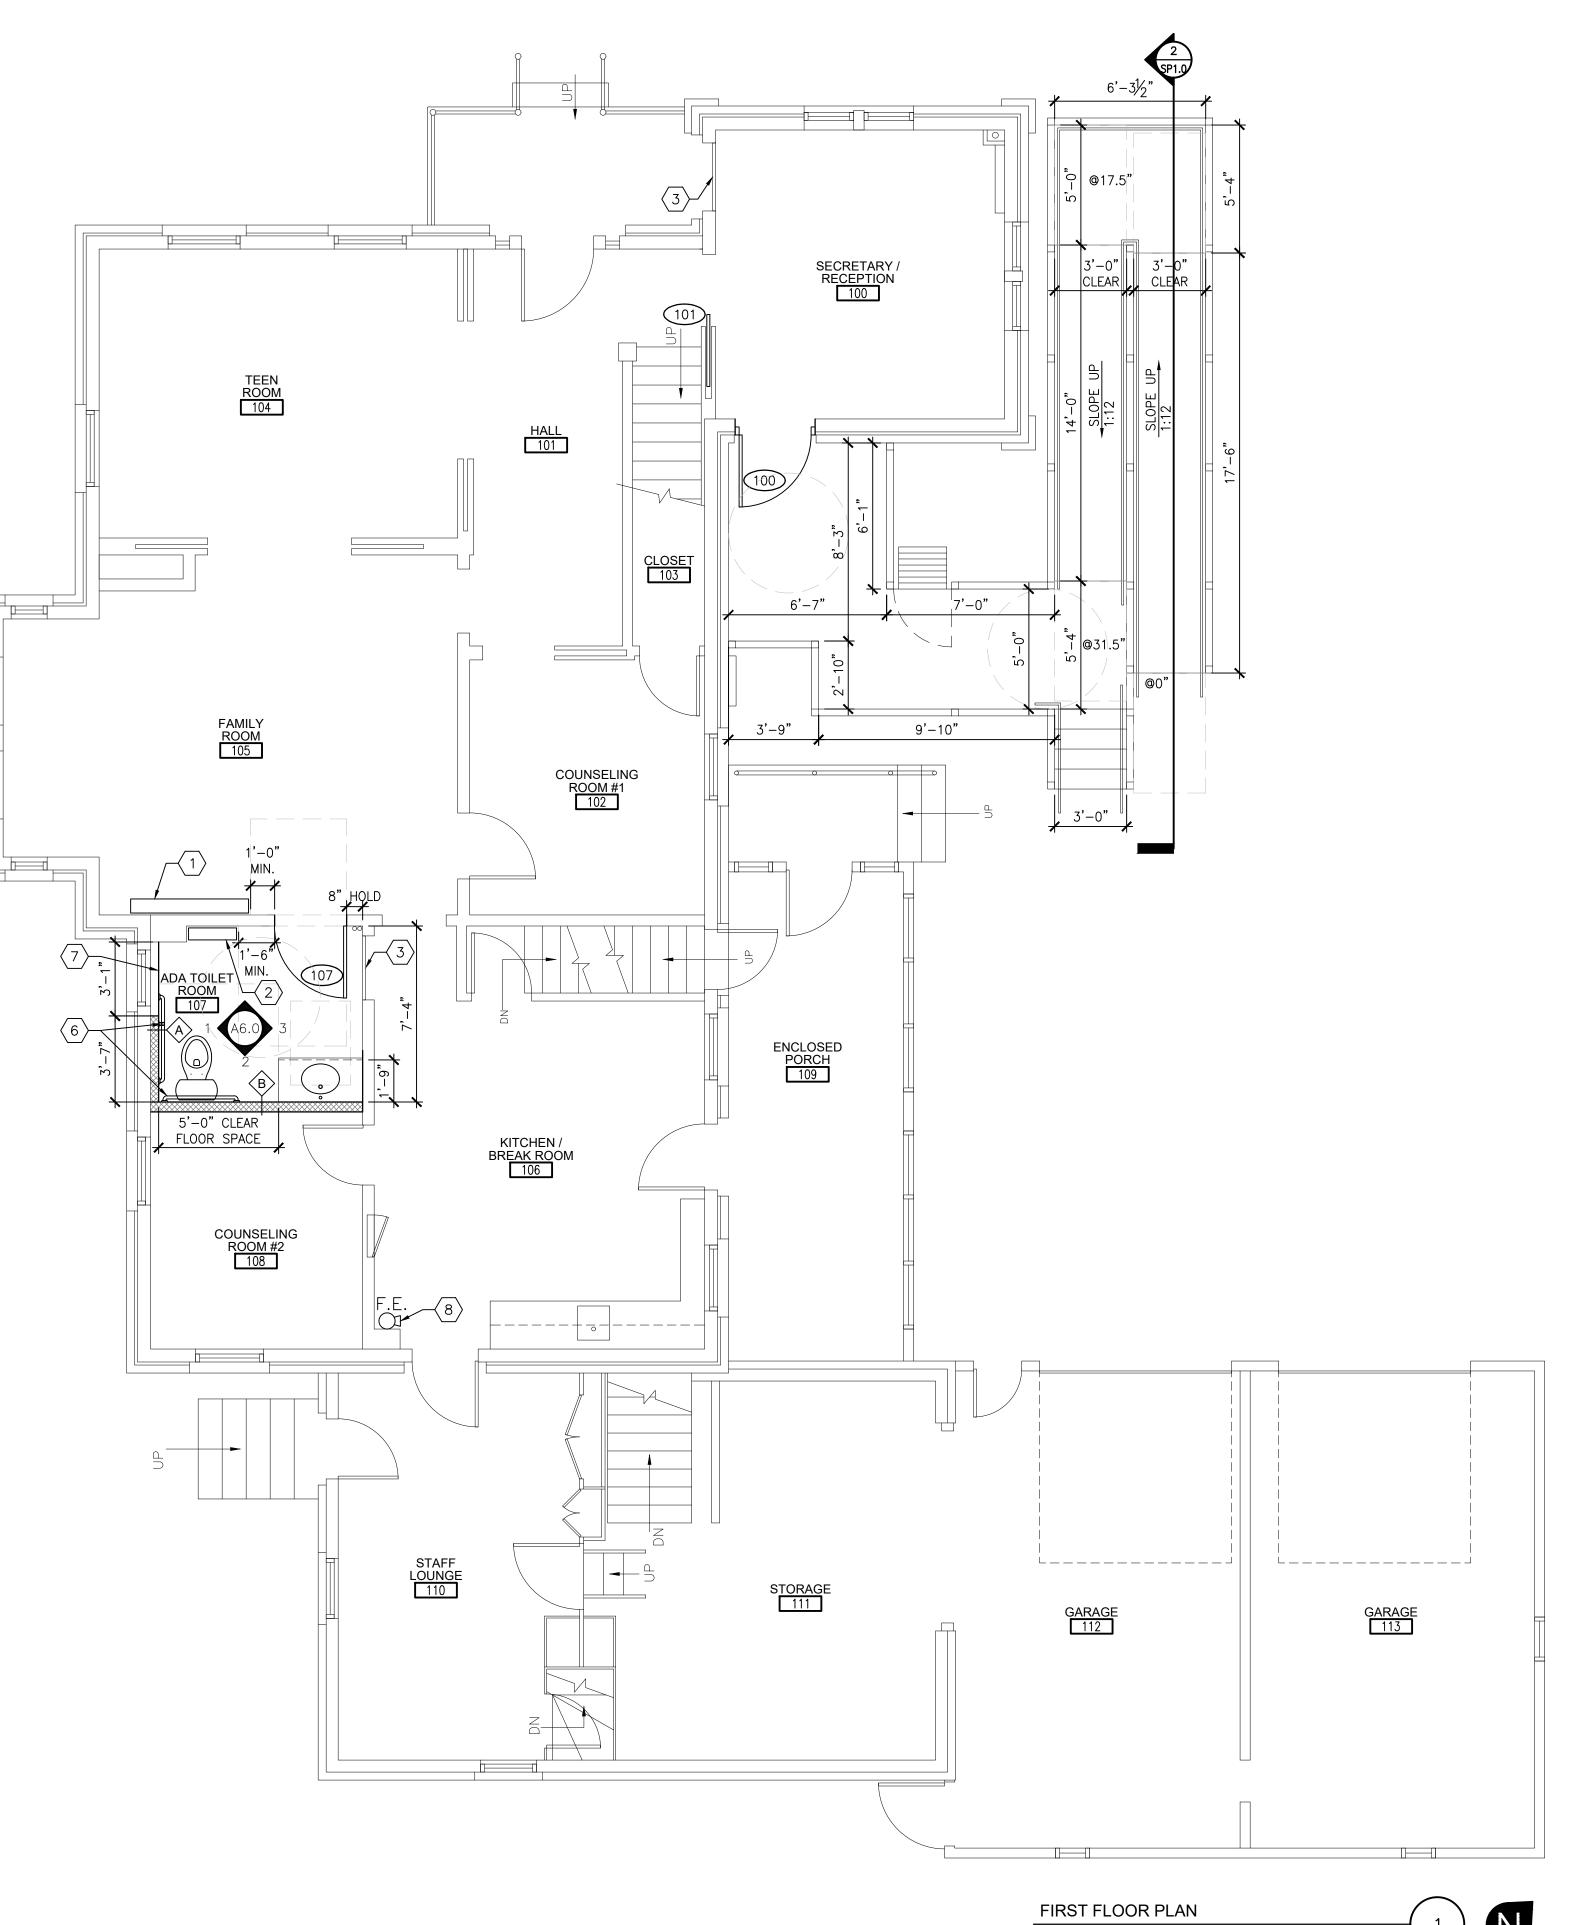
GENERAL NOTES

- 1. SEE SHEET A6.0 FOR WALL TYPES.
- 2. "FE" IDENTIFIES THE LOCATION OF FIRE EXTINGUISHERS CABINETS; SEE DETAIL 4 SHEET A6.0.
 3. G.C. TO COORDINATE WITH OWNER ALL ELECTRICAL OUTLET NEEDS/LOCATIONS.
 4. G.C. TO COORDINATE WITH OWNER ALL FINISHES.

FLOOR PLAN KEYNOTES

- 1 INSTALL NEW RADIATOR, COORDINATE WITH OWNER
- $\left\langle 2\right\rangle$ install radiator from salvage, coordinate with owner
- 3 SEAL DOOR IN PLACE
- 4 RESTORE RAILING, MATCH EXISTING HANDRAIL
- $\langle 5 \rangle$ install coat hooks, coordinate with owner
- 6 INSTALL ADA GRAB BARS, SEE DETAILS 1&2/A6.0
- $\left\langle 7\right\rangle$ 38" HIGH KNEE WALL, SEE DETAILS 1&2/A6.0
- $\langle 8 \rangle$ INSTALL NEW FIRE EXTINGUISHER, SEE DETAIL 4/A6.0

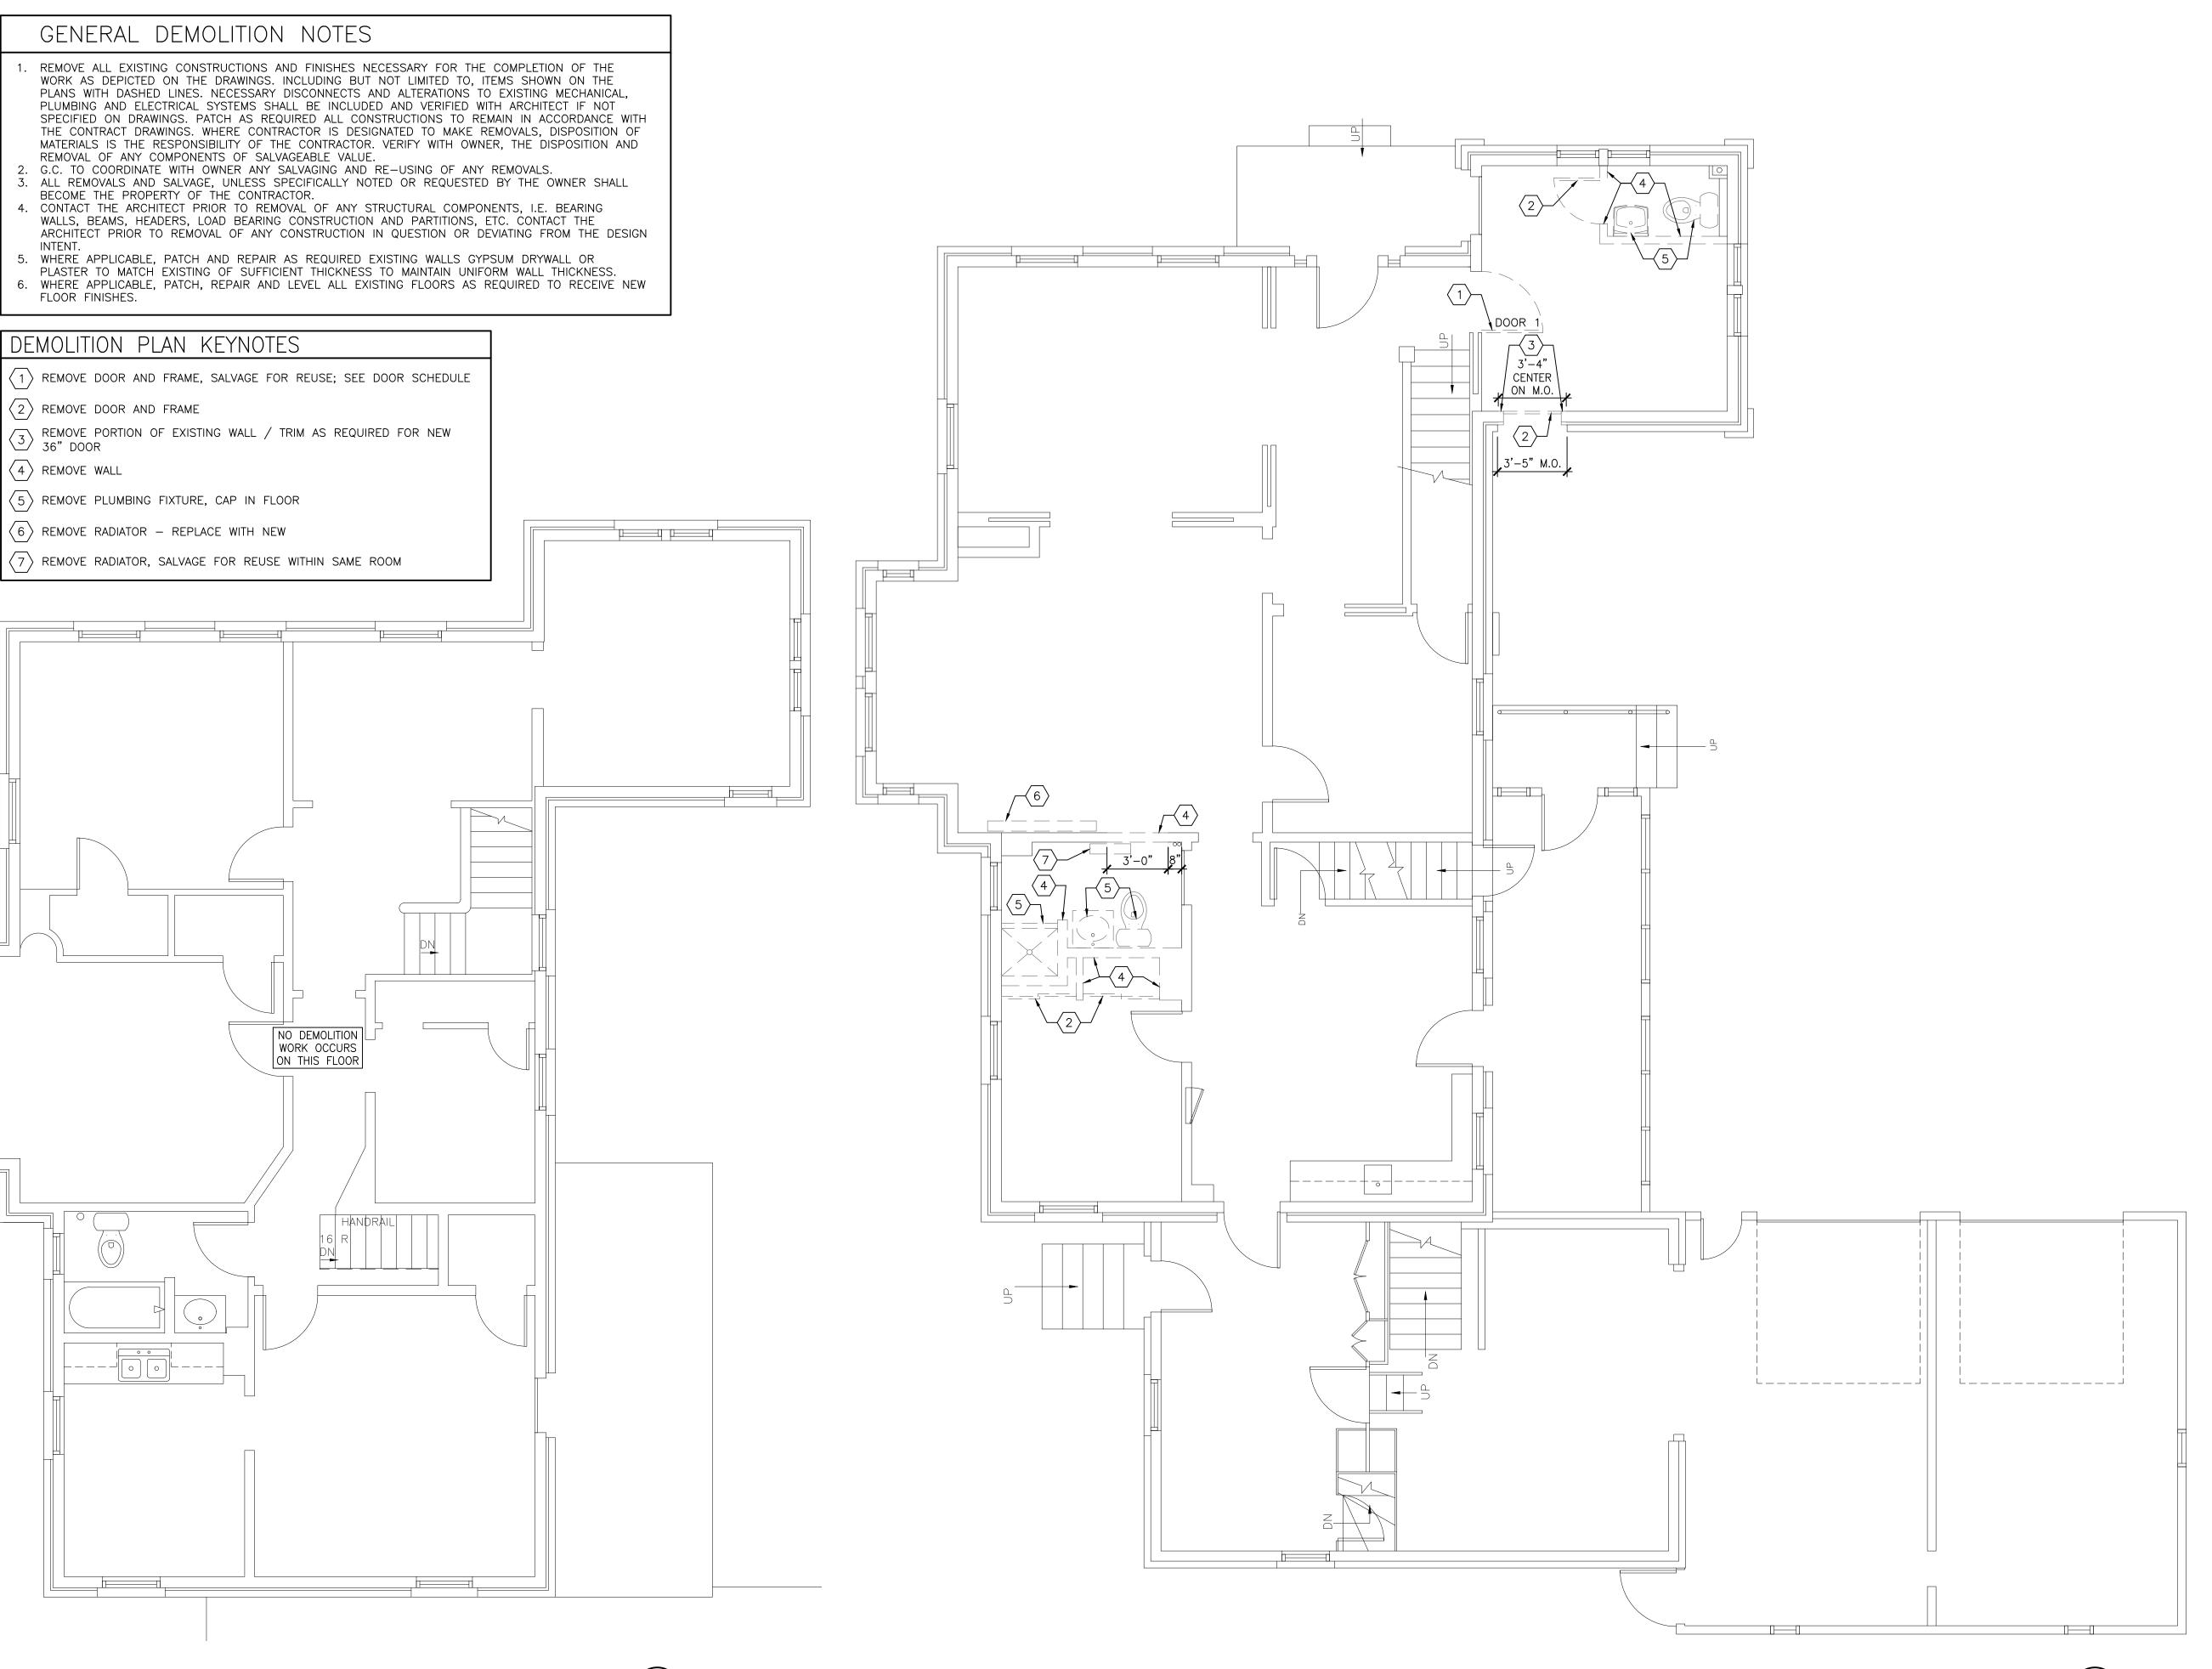





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SCALE: 1/4"=1'-0" (22x34); 1/8"=1'-0" (11x17)

SECOND FLOOR PLAN SCALE: 1/4"=1'-0" (22x34); 1/8"=1'-0" (11x17)



EXISITING CONDITION



SIDE ELEVATION

SCALE: 1/4"=1'-0" (22x34); 1/8"=1'-0" (11x17)

SCALE: 1/4"=1'-0" (22x34); 1/8"=1'-0" (11x17)

ELEVATIONS

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307 E Main Street Waukesha, WI 53186

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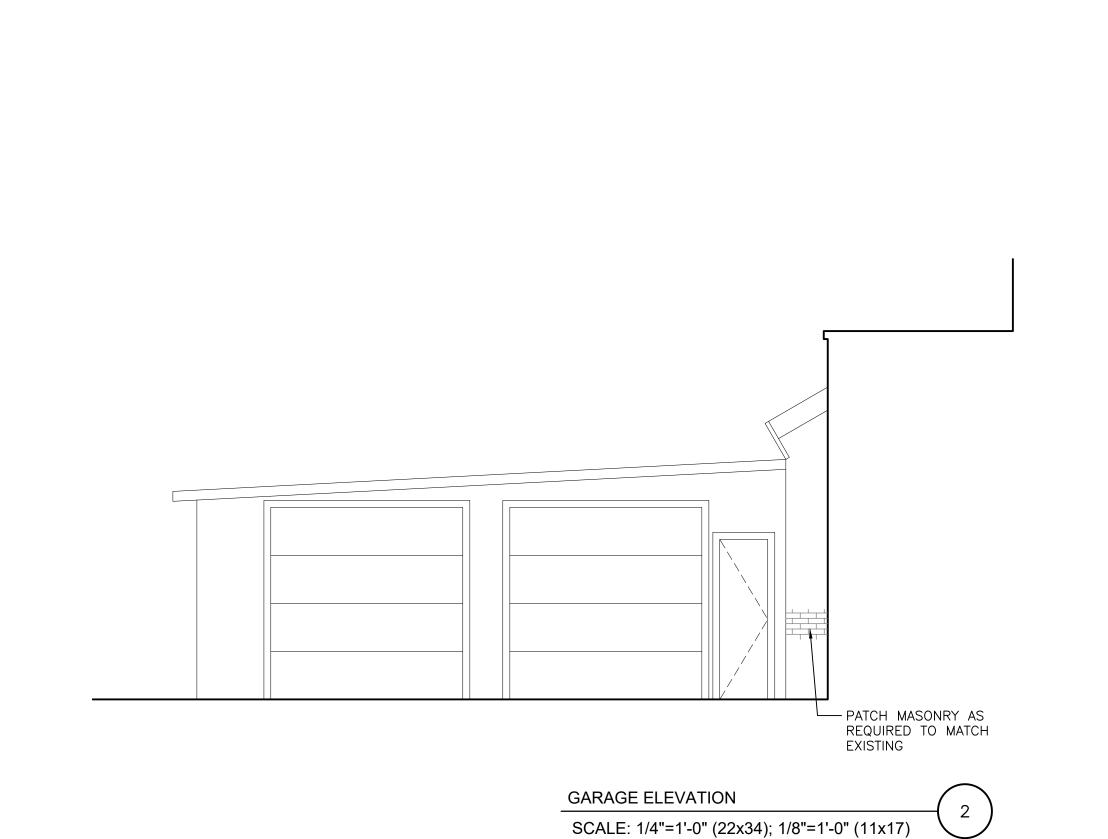
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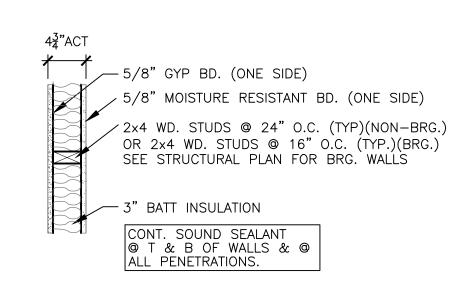
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FACE OF EXISTING WALL

5/8" MOISTURE RESISTANT BD. (ONE SIDE)

2x4 WD. STUDS @ 24" O.C. (TYP)(NON-BRG.)
OR 2x4 WD. STUDS @ 16" O.C. (TYP.)(BRG.)
SEE STRUCTURAL PLAN FOR BRG. WALLS

WALL TYPE EXTENDS TO DECK

WALL TYPE B

SCALE: N.T.S.

WALL TYPE EXTENDS TO DECK

WALL TYPE A


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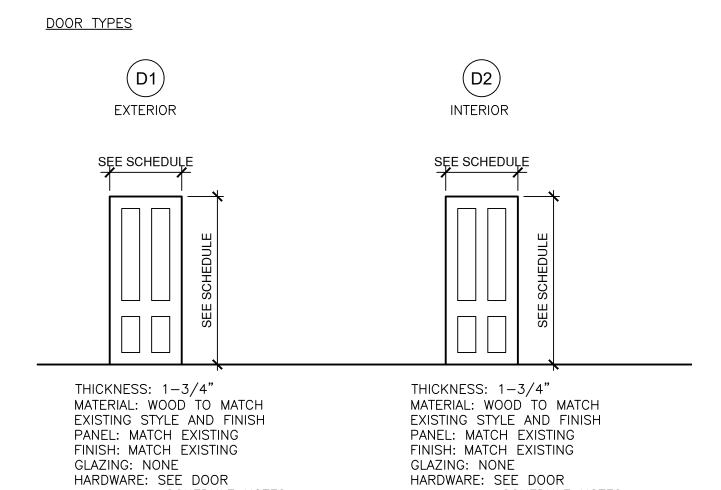
	DOOR SCHEDULE							
DOOR NUMBER	ROOM NAME	NO. OF PANELS	WIDTH	HEIGHT	DOOR TYPE	FRAME TYPE	FIRE RATING	REMARKS
100	SECRETARY / RECEPTION	1	3'-0"	MATCH EXIST.	D1	F1		
101	HALL	1	EXIST	EXIST	ı	ı		POCKET DOOR, REUSE EXISTING DOOR 1 FROM DEMO PLAN
107	ADA TOILET ROOM	1	3'-0"	7'-0"	D2	F2		

NOTES:


- 1. DOOR HARDWARE IS NOT SPECIFIED; HARDWARE COORDINATION MEETING WITH OWNER, DOOR SUPPLIER AND G.C. IS REQUIRED.
- . G.C. TO SUPPLY ALL DOOR HARDWARE REQUIRED BY CODE.

 DOOR HARDWARE SHALL COMPLY WITH ICC/ANSL A117.1 SEC.
- 3. DOOR HARDWARE SHALL COMPLY WITH ICC/ANSI A117.1 SEC 404.2.6 HANDLES, PULLS, LATCHES, LOCKS, AND OTHER OPERABLE PARTS ON ACCESSIBLE DOORS SHALL HAVE A SHAPE THAT IS EASY TO GRASP WITH ONE HAND AND DOES NOT REQUIRE TIGHT GRASPING, PINCHING OR TWISTING OF THE WRIST. THE HARDWARE SHALL BE PLACED AT LEAST 34 INCHES, BUT NOT MORE THAN 48 INCHES ABOVE THE FLOOR SURFACE.




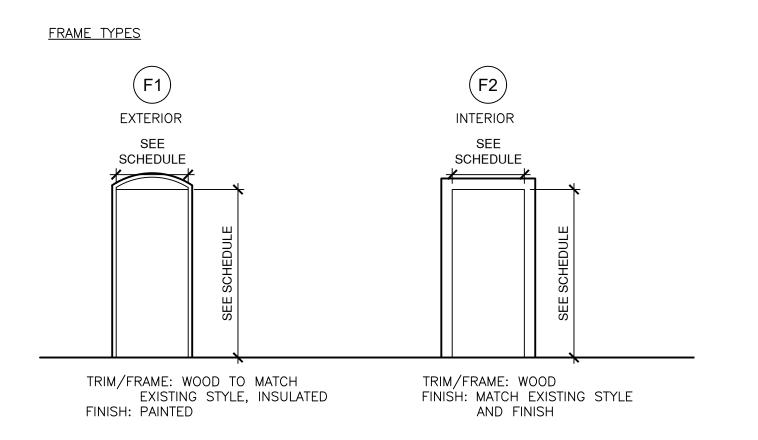


SCHEDULE NOTES

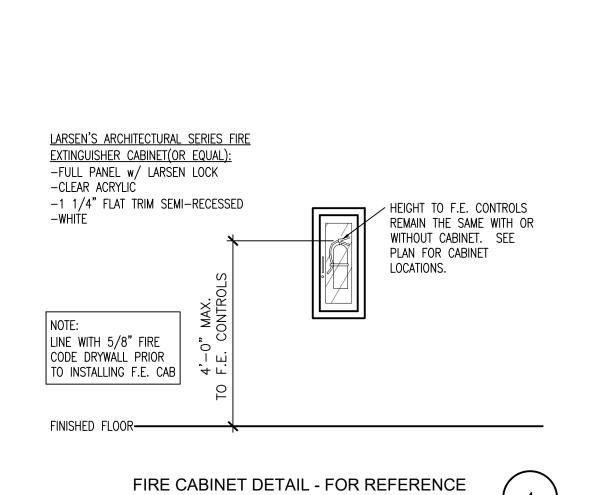


SCALE: 1/2"=1'-0" (22x34); 1/4"=1'-0" (11x17)

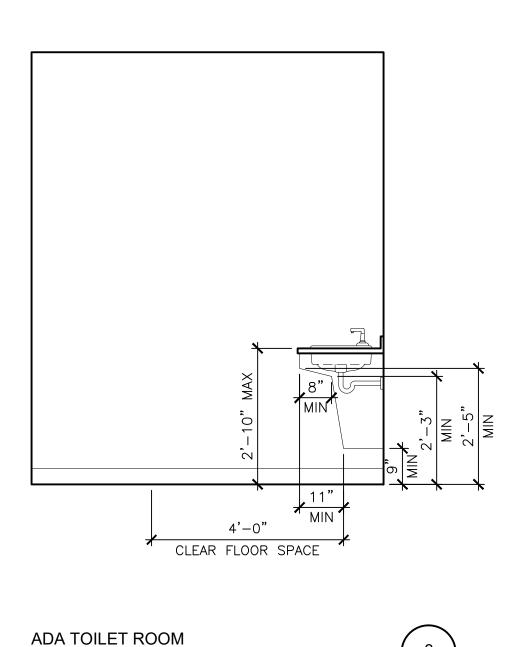

SCALE: 1/2"=1'-0" (22x34); 1/4"=1'-0" (11x17)

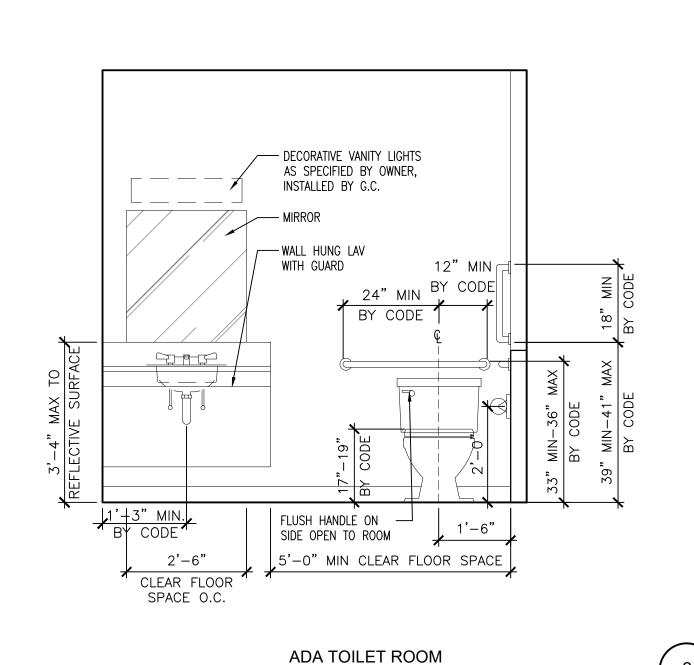

SCALE: 1/2"=1'-0" (22x34); 1/4"=1'-0" (11x17)

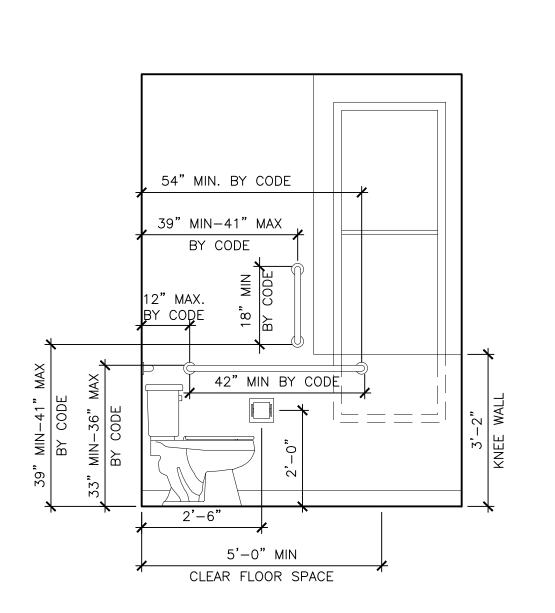

ADA TOILET ROOM

SCALE: 1/2"=1'-0" (22x34); 1/4"=1'-0" (11x17)

SCHEDULE NOTES

NOLON Sheet No.

A6.0

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