Oconomowoc | WI 53066 Gregg Prossen, Principal

TELEPHONE 414.406.7625 www.consortiumae.com

An ADDITION FOR:

MEDICO MART 2022 ADDITION

2323 CORPORATE DRIVE
WAUKESHA WI 53189
the CONSORTIUM ae PROJECT #:0022-29



PROPOSED 7,200 S.F. OFFICE & WAREHOUSE ADDITION DIGITAL RENDERING



ABBREVIATION KEY

ACOUSTICAL CEILING TILE GAUGE GALVANIZED GRAB BAR ADJUSTABLE ABOVE FINISH FLOOR ALTERNATE ALUMINUM GENERAL CONTRACTOR GLASS MASONRY UNIT GYPSUM WALL BOARD GYPSUM BLOCK BLOCKING BLANKET HOLLOW METAL HORIZONTAL HOUR HEIGHT BOTTOM OF BEAM BOTTOM OF DECK HEATING, VENTILATING & BOTTOM OF FOOTING BOTTOM OF JOIST AIR CONDITIONING BOTTOM BEARING BRICK INCHES INCLUDE INSULATION INTERIOR BASEMENT

CABINET

CORNER GUARD

CONTROL/ CONSTRUCTION JOINT

CENTER LINE

CELLING

CLEARENCE

CARPET

CONCRETE MASONRY UNIT

COLUMN

CONCRETE

CONCRETE

CONSTRUCTION

CUBIC
CONTRACTOR FURNISHED, OWNER INSTALLED
MFGR
MANUFACTURER
MIN
MIN
MINIMUM

DOUBLE
MISC
MISCE LLAREOUS
DEPARTMENT
M.O.
MASONRY OPENING
DIAGRAM/DIAGONAL
DIMENSION
DIVISION
NIC
NOT IN CONTRACT
DOWN
NO
NUMBER
DOWN SPOUT
DOWN
NO
NOM
NOM
NOMINAL
DRAWING
EACH
O.C.
ON CENTER

OWNER FURNISHED. CONTRACTOR INSTALLED EXTERIOR INSULATION FINISH SYSTEM OWNER FURNISHED, OWNER INSTALLED OPENING OPPOSITE OUNCE ELECTRICAL ENCLOSURE ENGINEER EPOXY RESIN P.LAM PLYWD PPT EQUAL EQUIPMENT ESTIMATE EXISTING TO REMAIN PLASTIC LAMINATE PLYW00D PRESSURE TREATED WOOD PREFABPREFABRICATED EXISTING EXPOSED CONSTRUCTION PREFIN PREFINISHED PRELIM PRELIMINARY EXPANSION JOINT EXTERIOR POUNDS PER SQUARE FOOT POLE AND SHELF

FLOOR DRAIN
FOUNDATION
GIVEN THE EXTINGUISHER CABINET
FIRE EXTINGUISHER CABINET
FIRE EXTINGUISHER CABINET
FIRE HOSE CABINET
FRAME
FIRE FRECO
FILOOR
FRAME
FRAME
FRAME
FRECO
FR

SYMBOLS

SQUARE FOOT SHEET SIMILAR

SPECIFICATIONS SQUARE

SUSPENDED SHEET VINYL

SYMMETRICAL

TEMPERATURE

TYPICAL
TYPICAL
TOP OF BEAM
TOP OF DECK
TOP OF FOOTING
TOP OF JOIST
TOP OF SLAB
TOP OF WALL

UNEXCAVATED

UNDERWRITERS LABORATORIES

UNLESS NOTED OTHERWISE

VINYL COMPOSTION TILE

VERTICAL VINYL FLOORING ADAPTER

VERIFY IN FIELD
VINYL SHEET FLOORING

VINYL STAIR NOSING


VENT THROUGH ROOF

VINYL WALL COVERING

WIND LOAD

STAINLESS STEEL STREET SOUND TRANSMISSION CLASS

STANDARD STEEL STRUCTURAL/STRUCTURE

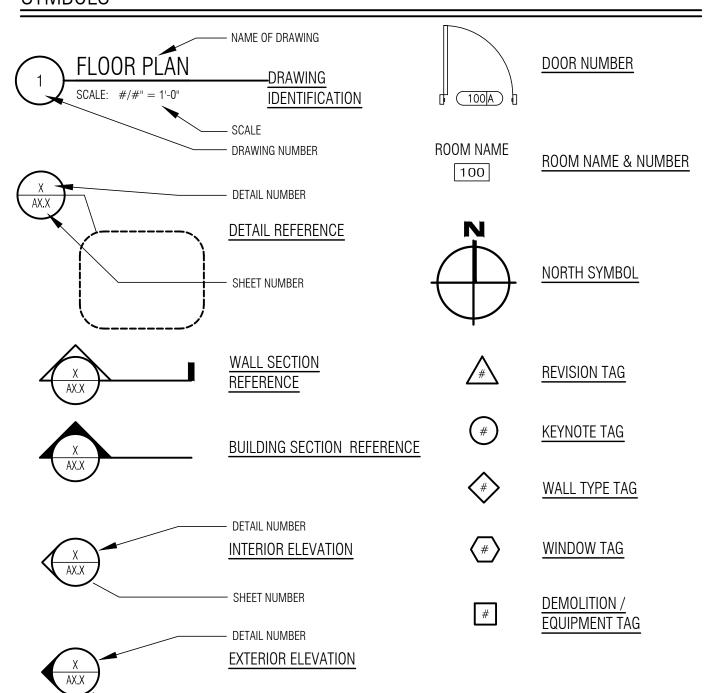

SHEET NUMBER

COLUMN GRID LINE REFERENCE

GENERAL NOTES

1. CONTRACTOR TO VERIFY ALL DIMENSIONS PRIOR TO COMMENCING CONSTRUCTION. 2. FINISHED FLOOR HEIGHT IS 100'-0". REFER TO CIVIL PLAN FOR ACTUAL DATUM ELEVATION.

2. FINISHED FLOOR HEIGHT IS 100'-0". REFER TO CIVIL PLAN FOR ACTUAL DATUM ELEVATION.

3. ALL WORK OF THE CONTRACTOR SHALL BE IN ACCORDANCE WITH APPLICABLE BUILDING CODES AND COMPLY WITH ALL GOVERNING LAWS, CODES, ORDINANCES, RULES AND REGULATIONS OF THE CITY, COUNTY STATE AND FEDERAL JURISDICTION INCLUDING REQUIREMENTS OF THE STATE OF WISCONSIN DEPARTMENT OF NATURAL RESOURCES.

4. THE CONTRACTOR SHALL REPORT IMMEDIATELY, ANY DISCREPANCIES BETWEEN EXISTING CONDITIONS AND THOSE SHOWN ON

THE CONSTRUCTION DOCUMENTS, TO THE ARCHITECT.

5. PRIOR TO COMMENCEMENT OF WORK, THE CONTRACTOR SHALL CAREFULLY EXAMINE THE SITE OF THE WORK AND VERIFY GRADE ELEVATIONS, UTILITIES, AND OTHER EXISTING CONDITIONS WHETHER OR NOT SHOWN ON THE DRAWINGS. LOCATE ALL GENERAL SITE REFERENCE DATA FOR PROPERTY LINES AND GRADE ELEVATIONS AND DO THAT WORK WHICH IS NECESSARY TO PREVENT THEIR DISLOCATION OR DESTRUCTION.

6. CONTRACTOR SHALL CLEAR THE CONTRACT WORK AREA ONLY. PROTECT EXISTING UTILITIES, TREES AND/OR NATURAL VEGETATION WHICH IS REQUIRED TO REMAIN.

7. THE CLEARING/FILLING/EXCAVATING OF THIS AREA SHALL BE ACCOMPLISHED IN A MANNER AS TO MINIMIZE THE RUNOFF OF SILT AND SEDIMENT INTO THE STORM DRAINAGE SYSTEM AND ONTO ADJACENT OR DOWNSTREAM PROPERTIES. EROSION CONTROL MEASURES SHALL BE INSTITUTED AS NECESSARY BY THE CONTRACTOR TO ACCOMPLISH THIS EROSION CONTROL. ANY AND ALL EROSION PLANS REQUIRED FOR THIS WORK SHALL BE THE RESPONSIBILITY OF THE CONTRACTOR.

8. NO DEBRIS, EARTH MATERIAL, CLEARED VEGETATION OR WASTE MATERIALS SHALL BE DEPOSITED ON ANY OTHER PROPERTY WITHOUT FIRST OBTAINING THE REQUIRED PERMITS AND/OR APPROVALS. THIS INCLUDES THE INTRUSION OF SUCH MATERIAL INTO THE CITY STREET AND DRAINAGE SYSTEMS. CLEAN ANY DEBRIS LEFT IN THE STREET AT RESULT OF OPERATIONS IMMEDIATELY.

9. BARRICADE AND POST WARNING SIGNS AND LIGHTS ADJACENT TO OPEN DEPRESSIONS AND HOLES OCCURRING AS PART OF THE WORK.

10. MAINTAIN ACCESS TO ADJACENT PROPERTIES AT ALL TIMES.
11. USE MEANS NECESSARY TO PREVENT DUST FROM BECOMING A NUISANCE TO THE PUBLIC, NEIGHBORS, AND OTHER WORK BEING PERFORMED ON OR NEAR THE SITE.

BEING PERFORMED ON OR NEAR THE SITE.

12. GRADE AREAS ADJACENT TO BUILDINGS TO ACHIEVE DRAINAGE AWAY FROM BUILDINGS. SLOPE 5% OR GREATER, AS MAY BE SHOWN, FOR THE FIRST 10'-0" TOWARDS APPROVED DRAINAGE FACILITIES.

13. FINISH FLOOR TO BE A MINIMUM 4" ABOVE ADJACENT FINISH GRADE.

14. DO NOT SCALE DRAWINGS.
15. VERIFY ALL ROUGH-IN DIMENSIONS FOR ALL BUILT-IN EQUIPMENT PRIOR TO PERFORMING WORK. NO CHANGE ORDERS WILL BE APPROVED FOR CONTRACTOR FAILURE TO DO SO.
16. THE CONTRACTOR SHALL BE RESPONSIBLE FOR ALL CUTTING, FITTING OR PATCHING THAT MAY BE REQUIRED TO COMPLETE

17. REPETITIVE FEATURES IN THE CONSTRUCTION DOCUMENTS ARE OFTEN DRAWN ONLY ONCE AND SHALL BE COMPLETELY PROVIDED AS IF DRAWN IN FULL.

Sheet Set Index Sheet # Sheet Title A0.00 COVER SHEET A0.01 INDEX PROJECT NOTES CODE INFO & MAPS SP1.00 SITE PLAN - PROPOSED C1.10 PROJECT LOCATION & GENERAL NOTES C1.11 CIVIL SITE PLAN C1.20 GRADING & EROSION CONTROL PLAN A1.00 FLOOR PLAN - PROPOSED ADDITION A3.00 ROOF PLAN & ROOF DETAILS A4.00 ELEVATIONS A6.00 WALL SECTIONS

PROJECT INFORMATION

SITE SIZE: 128,340 S.F. (2.95 ACRES)

BUILDING ADDITION SIZE: 7,200 s.f. EXISTING BLDG SIZE: 20,887 s.f. TOTAL BLDG AREA: 28,087 s.f. BUILDING CODE: IBC-2015, IEBC-2015, ICC/ANSI 117.1 - 2009

OCCUPANCY CLASSIFICATION: Group S1, B & F1

CONSTRUCTION TYPE: IIB

SPRINKLERED: YES NFPA 13

PLAN REVIEWER - CODE INFORMATION

ALLOWABLE AREA FOR NON-SEPARATED USES (F1 MOST RESTRICTIVE) TABLE 506.2 TABULAR AREA = 62,000 S.F. 62,000 S.F. ALLOWABLE > 28,087 S.F. ACTUAL AREA

MINIMUM FIRE SEPARATION DISTANCE IS > 30' EXTERIOR WALL RATING = 0

EXTERIOR WALLS $> 30^{\circ}$ FIRE SEPARATION DISTANCE (705.2), UNLIMITED UNPROTECTED OPENINGS (705.8) EGRESS DISTANCE $= 250^{\circ}$ MEDICO MART OCCUPANT LOAD = 47 (S1 500 SF/OCC + B 100 SF/OCC)

EXITS REQUIRED (2) EXITS PROVIDED (3)
SANITARY FIXTURE CALCULATIONS FOR MEDICO MART TENANT AREA (IBC TABLE 2902.1)

B PRIMARY OCCUPANCY 50% MALE 50% FEMALE 24 OCCUPANTS EA SEX

REQUIRED 1 TOILET + 1 LAVS PER SEX 1 DRINKING FOUNTAIN, 1 UTILITY SINK

NO WORK IN EXISTING TENANT

DRAWING ORGANIZATION

FIN. FLR.

					ALL ARCHITECTURAL DRAWINGS ARE ORGANIZED IN CONJUNCTION WITH THE ADJACENT GRID LAYOUT. DRAWINGS ARE NUMBERED IN
1	2	3	4	5	SEQUENTIAL ORDER LEFT TO RIGHT, TOP TO BOTTOM BEGINNING WITH THE UPPER LEFT
					DRAWING.
	7			10	
6	1	8	9	10	
11	12	13	14	15	
16	17	18	19	20	


MATERIALS

	EARTH		BATT INSULATION
	SAND, PLASTER, GROUT		STEEL
	GRAVEL		GYPSUM WALLBOARD
	CONCRETE		WOOD, FINISHED
	PRECAST CONCRETE		WOOD, BLOCKING
	BRICK		WOOD SHIM
	CONCRETE BLOCK		PLYW00D
FAUAFACATAVAV FAUAVATAVAVATA SAVAVAFEAVATA FAFATAVAUATOS	TERRAZZO		ACOUSTICAL TILE
	METAL STUD PARTITIONS		WOOD STUD PARTITIONS
	RIGID INSULATION	·/y/y/y/y/y/	CEMENTITIOUS SHEATHING

SITE AERIAL



GOOGLE EARTH VICINITY MAP

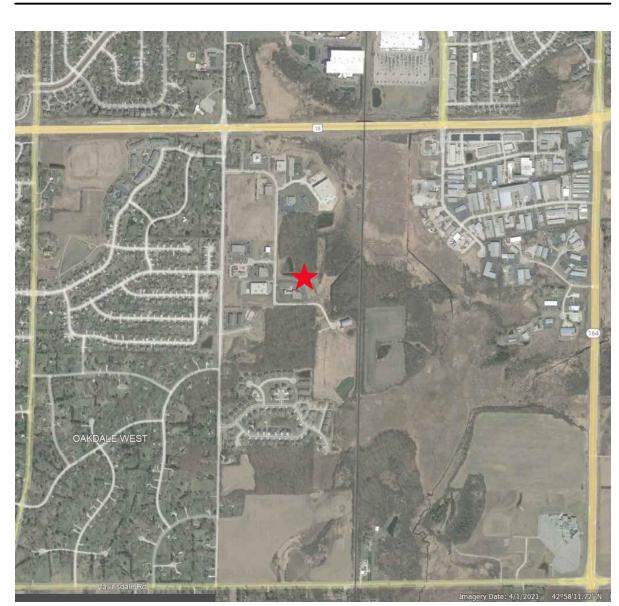

STRUCTURAL CONSULTANT

HARWOOD ENGINEERING CONSULTANTS LTD 255 NORTH 21ST STREET MILWAUKEE, WI 53233 (414)918-1240 Mary.Piontkowski@hecl.com

CIVIL CONSULTANT

HARWOOD ENGINEERING CONSULTANTS LTD 255 NORTH 21ST STREET MILWAUKEE, WI 53233 (414)918-1240 Nathan.Schmit@hecl.com

CONTRACTOR

DESIGN 2 CONSTRUCT DEVELOPMENT CORPORATION N173 W21010 NORTHWEST PASSAGE JACKSON, WISCONSIN 53037 (262) 677-9933 mkrenz@design2construct.com

OWNER

WCC 2005 LLC 2323 CORPORATE DRIVE WAUKESHA WI 53189 (262) 446-2323 www.medicomart.com

Medico-Mart, Inc.

2323 CORPORATE DRIVE

MEDICO MART

2022 ADDITION

Location: WAUKESHA WI 53189



Sheet:
INDEX PROJECT NOTES CODE
INFO & MAPS

Date:	Issue Set:	

Date: 2022-11-11 PC SUBMISSION

Project No.: 0022-29

Sheet No.:

A0.01



Medico-Mart, Inc.

Project:

MEDICO MART 2022 ADDITION

2323 CORPORATE DRIVE

Location:

Location: WAUKESHA WI 53189



Sheet: SITE PLAN - PROPOSED

Date: Issue Set:

Date: 2022-11-11 PC SUBMISSION

Project No.: 0022-29

Sheet No.:

SP1.00



LEGEND:

LLOLIND.					
UTILITY		GRADING		SITE	
EXISTING:		EXISTING:		EXISTING:	
— W — W — — E — E — — — — — — — — — — —	WATERMAIN BURIED ELECTRIC OVERHEAD WIDE		MAJOR CONTOUR MINOR CONTOUR	$\langle \mathbf{x} \rangle$	EXISTING PARKING COUNT
——————————————————————————————————————	OVERHEAD WIREGAS LINESANITARY SEWER	EXIST + 100.00	EXISTING SPOT ELEVATION		EXISTING SIGN
ST ST ST	STORM SEWER			C.	EXISTING ADA PARKING SPACE
<u></u>	UTILITY POLE	PROPOSED:		PROPOSED:	
-\\\\\-\\\\\\\\\\\\\\\\\\\\\\\\\\\\\\\	LIGHT POLE	160	MAJOR CONTOUR		
S	SANITARY MANHOLE	160	MINOR CONTOUR	\(\sqrt{\sq}}\sqrt{\sq}}}}}}}}\sqrt{\sqrt{\sqrt{\sqrt{\sqrt{\sqrt{\sqrt{\sqrt{\sqrt{\sqrt{\sqrt{\sqrt{\sqrt{\sqrt{\sqrt{\sq}}}}}}}}}\eqiintites}\sqrt{\sqrt{\sqrt{\sqrt{\sqrt{\sqrt{\sq}}}}}}}}}}}}}}}}}}}}}}}}}}}}}}}}}}}}	PARKING COUNT
	FIRE HYDRANT	+ 100.00	SPOT ELEVATION (FINISHED GRADE, TOP OF PAVEMENT, FLANGE OF CURB)		ADA PARKING SPACE
	WATER VALVE STORM SEWER STRUCTURE	+ DOOR + 100.00	DOOR ELEVATION		SIGN
PROPOSED:		+ GR + 100.00	GROUND GRADE AT BUILDING	00000000	TRUNCATED DOMES
	WATERMAIN	100.50T/C + 100.00E/P	SPOT ELEVATION (T/C - TOP OF CURB, E/P - EDGE OF PAVEMENT)	> A	
E E GAS	- ELECTRICAL LINE - GAS LINE	+ 100.50T/W + 100.00B/W	RETAINING WALL SPOT ELEVATION (T/W - GROUND GRADE AT TOP OF WALL, B/W - GROUND GRADE AT BOTTOM)		PAVEMENT MARKING DIRECTIONAL ARROWS
SAN SAN SAN SAN ST	_	+ 12" FES + 100.00B/W	FLARED END SECTION (PIPE SIZE, INVERT ELEVATION)		

DRAINAGE FLOW DIRECTION

EMERGENCY OVERFLOW ROUTE

GENERAL NOTES AND SPECIFICATIONS:

1. THE EXISTING SITE INFORMATION ON THIS PLAN WAS TAKEN FROM A SITE SURVEY PROVIDED BY CAPITOL SURVEY ENTERPRISES. THE ENGINEER MAKES NO WARRANTY OR REPRESENTATION WITH REFERENCE TO THE ACCURACY AND COMPLETENESS OF THE EXISTING CONDITIONS INDICATED OR NOT INDICATED ON THE ENGINEERING PLANS PROVIDED. THE CONTRACTOR SHALL VERIFY THE LOCATION OF ALL EXISTING SITE CONDITIONS INCLUDING UNDERGROUND UTILITIES, UNDERGROUND UTILITY ELEVATIONS, BUILDING SETBACKS AND EXISTING BUILDING LOCATIONS. THE CONTRACTOR SHALL INFORM THE OWNER AND ENGINEER OF ANY DISCREPANCIES PRIOR TO COMMENCING WITH WORK. QUESTIONS REGARDING THE EXISTING SURVEY SHALL BE DIRECTED TO THE PARTIES LISTED ABOVE.

- BEFORE PROCEEDING WITH ANY UTILITY CONSTRUCTION, CONTRACTOR SHALL EXCAVATE EACH EXISTING LATERAL TO BE CONNECTED TO (VERIFYING ELEVATION, LOCATION AND SIZE). SHOULD THE EXISTING UTILITY NOT BE AS INDICATED ON THE PLAN, THE ENGINEER SHALL BE NOTIFIED IMMEDIATELY FOR EVALUATION.
- 3. ALL UTILITY CONSTRUCTION SHALL ADHERE TO THE STANDARD SPECIFICATIONS FOR SEWER AND WATER CONSTRUCTION IN WISCONSIN (2003), AS WELL AS, THE MUNICIPAL CONSTRUCTION STANDARDS AND THE DEPT. OF SAFETY AND PROFESSIONAL SERVICES SEC. 382-387.
- 4. ALL PERMITS MUST BE RECEIVED FROM THE MUNICIPALITY AND WDNR (IF REQUIRED) PRIOR TO THE START OF CONSTRUCTION. IT IS THE CONTRACTORS RESPONSIBILITY TO ENSURE ALL APPLICABLE PERMITS ARE RECEIVED PRIOR TO STARTING CONSTRUCTION.
- 5. NOTIFY THE PUBLIC WORKS INSPECTION DEPT. AT LEAST 48 HOURS BEFORE STARTING CONSTRUCTION.
- 6. BACKFILL REQUIREMENTS AND ROADWAY/SIDEWALK RESTORATION SHALL ADHERE TO LOCAL STANDARDS (GRANULAR BACKFILL UNDER OR WITHIN 5' OF CURBS, SIDEWALK, OR PAVEMENT. SPOIL MAY BÈ USED ELSEWHERE. SLURRY BACKFILL WILL BE REQUIRED IN PUBLIC ROADWAYS.)
- 7. ALL BUILDING UTILITIES SHALL BE VERIFIED WITH THE ARCHITECTURAL PLANS PRIOR TO
- 8. PROPOSED SANITARY SEWER PIPE SHALL BE PVC, ASTM D-3034, SDR 35 WITH RUBBER GASKETED JOINTS CONFORMING TO ASTM D-3212 (UNLESS OTHERWISE NOTED).
- 9. PROPOSED STORM SEWER SHALL BE PVC, ASTM D-3034, SDR 35 WITH RUBBER ELASTOMERIC JOINTS CONFORMING TO ASTM D-3212 (UNLESS OTHERWISE NOTED).
- 10. A MEANS TO LOCATE BURIED UNDERGROUND EXTERIOR NONMETALLIC UTILITIES MUST BE PROVIDED. PROVIDE TRACER WIRE OR OTHER METHODS IN ORDER TO BE LOCATED IN ACCORD

SPECIFICATIONS FOR SEWER AND WATER CONSTRUCTION IN WISCONSIN.

WITH THE PROVISIONS SECTIONS 182.0715(2R) OF THE STATE STATUTES. 11. UTILITY TRENCHES SHALL BE MECHANICALLY COMPACTED IN ACCORDANCE WITH THE STANDARD

- 12. ALL MANHOLES, CATCH BASINS, INLETS, VALVES BOXES, ETC WITHIN THE PROJECT AREA SHALL BE RESET AND ADJUSTED TO MATCH FINISH GRADE.
- 13. ALL EXCAVATED OR STRIPPED MATERIALS NOT BEING REPLACED IN UTILITY TRENCHES OR BEING USED FOR FILL SHALL BE REMOVED FROM THE SITE, UNLESS OTHERWISE DIRECTED BY THE
- 14. SEE ARCHITECTURAL PLANS FOR EXACT BUILDING & FOUNDATION DETAILS AND ORIENTATION.

15. ALL CONCRETE FOR CURB AND GUTTER, ROADWAY AND SIDEWALKS MUST CONFORM TO THE STANDARD SPECIFICATIONS FOR READY MIXED CONCRETE. MINIMUM 28 DAY COMPRESSIVE

16. CONTRACTOR IS RESPONSIBLE FOR PROTECTING ALL PROPERTY CORNERS.

STRENGTH TEST MUST EQUAL 4000 PSI.

- 17. CONTRACTOR IS RESPONSIBLE FOR REPAIRING ANY DAMAGE TO EXISTING UTILITIES OR SITE IMPROVEMENTS. CONTRACTOR SHALL DOCUMENT ALL EXISTING DAMAGE PRIOR TO START OF CONSTRUCTION AND NOTIFY CONSTRUCTION MANAGER OF ANY FINDINGS.
- 18. PROJECT SAFETY ON-SITE SHALL BE THE SOLE RESPONSIBILITY OF THE CONTRACTOR.
- 19. CONTRACTOR IS RESPONSIBLE FOR VERIFYING EXISTING SOIL CONDITIONS, CONSTRUCTION MANAGER MAY HAVE SOILS REPORT FOR MORE INFO.
- 20. CONTRACTOR IS RESPONSIBLE FOR PROVIDING THE OWNER WITH A SET OF MARKED UP PLANS (AS-BUILTS) SHOWING ANY CHANGES DURING CONSTRUCTION.

CIVIL SHEET INDEX:

C1.10 PROJECT LOCATION & GENERAL NOTES

C1.11 SITE PLAN

C1.20 GRADING & EROSION CONTROL PLAN

 \supset

IN ACCORDANCE WITH WISCONSIN STATUTE 182.0175, DAMAGE O TRANSMISSION FACILITIES, EXCAVATOR SHALL BE SOLELY RESPONSIBLE TO PROVIDE ADVANCE NOTICE TO THE DESIGNATED "ONE CALL SYSTEM" NOT LESS THAN THREE WORKING DAYS PRIOR TO COMMENCEMENT OF ANY EXCAVATION REQUIRED TO PERFORM WORK CONTAINED ON THESE DRAWINGS, AND FURTHER, EXCAVATOR SHALL COMPLY WITH ALL OTHER REQUIREMENTS OF

THIS STATUTE RELATIVE TO EXCAVATOR'S WORK.

WATER VALVE

STORM SEWER STRUCTURE

FLARED END SECTION

PROJECT LOCATION & GENERAL NOTES SCALE: 1" = 20'

Date: Issue Set:

Harwood Engineering Consultants

MEDICO MART

2022 ADDITION

2323 CORPORATE DRIVE

WAUKESHA WI 53189

2022-11-11 PC SUBMITTAL

Project No.: 0022-29

Sheet No.:





MEDICO MART 2022 ADDITION

2323 CORPORATE DRIVE

WAUKESHA WI 53189

Site Plan

SCALE: 1" = 20'


Date: Issue Set:

2022-11-11 PC SUBMITTAL

Project No.: 0022-29

Sheet No.:



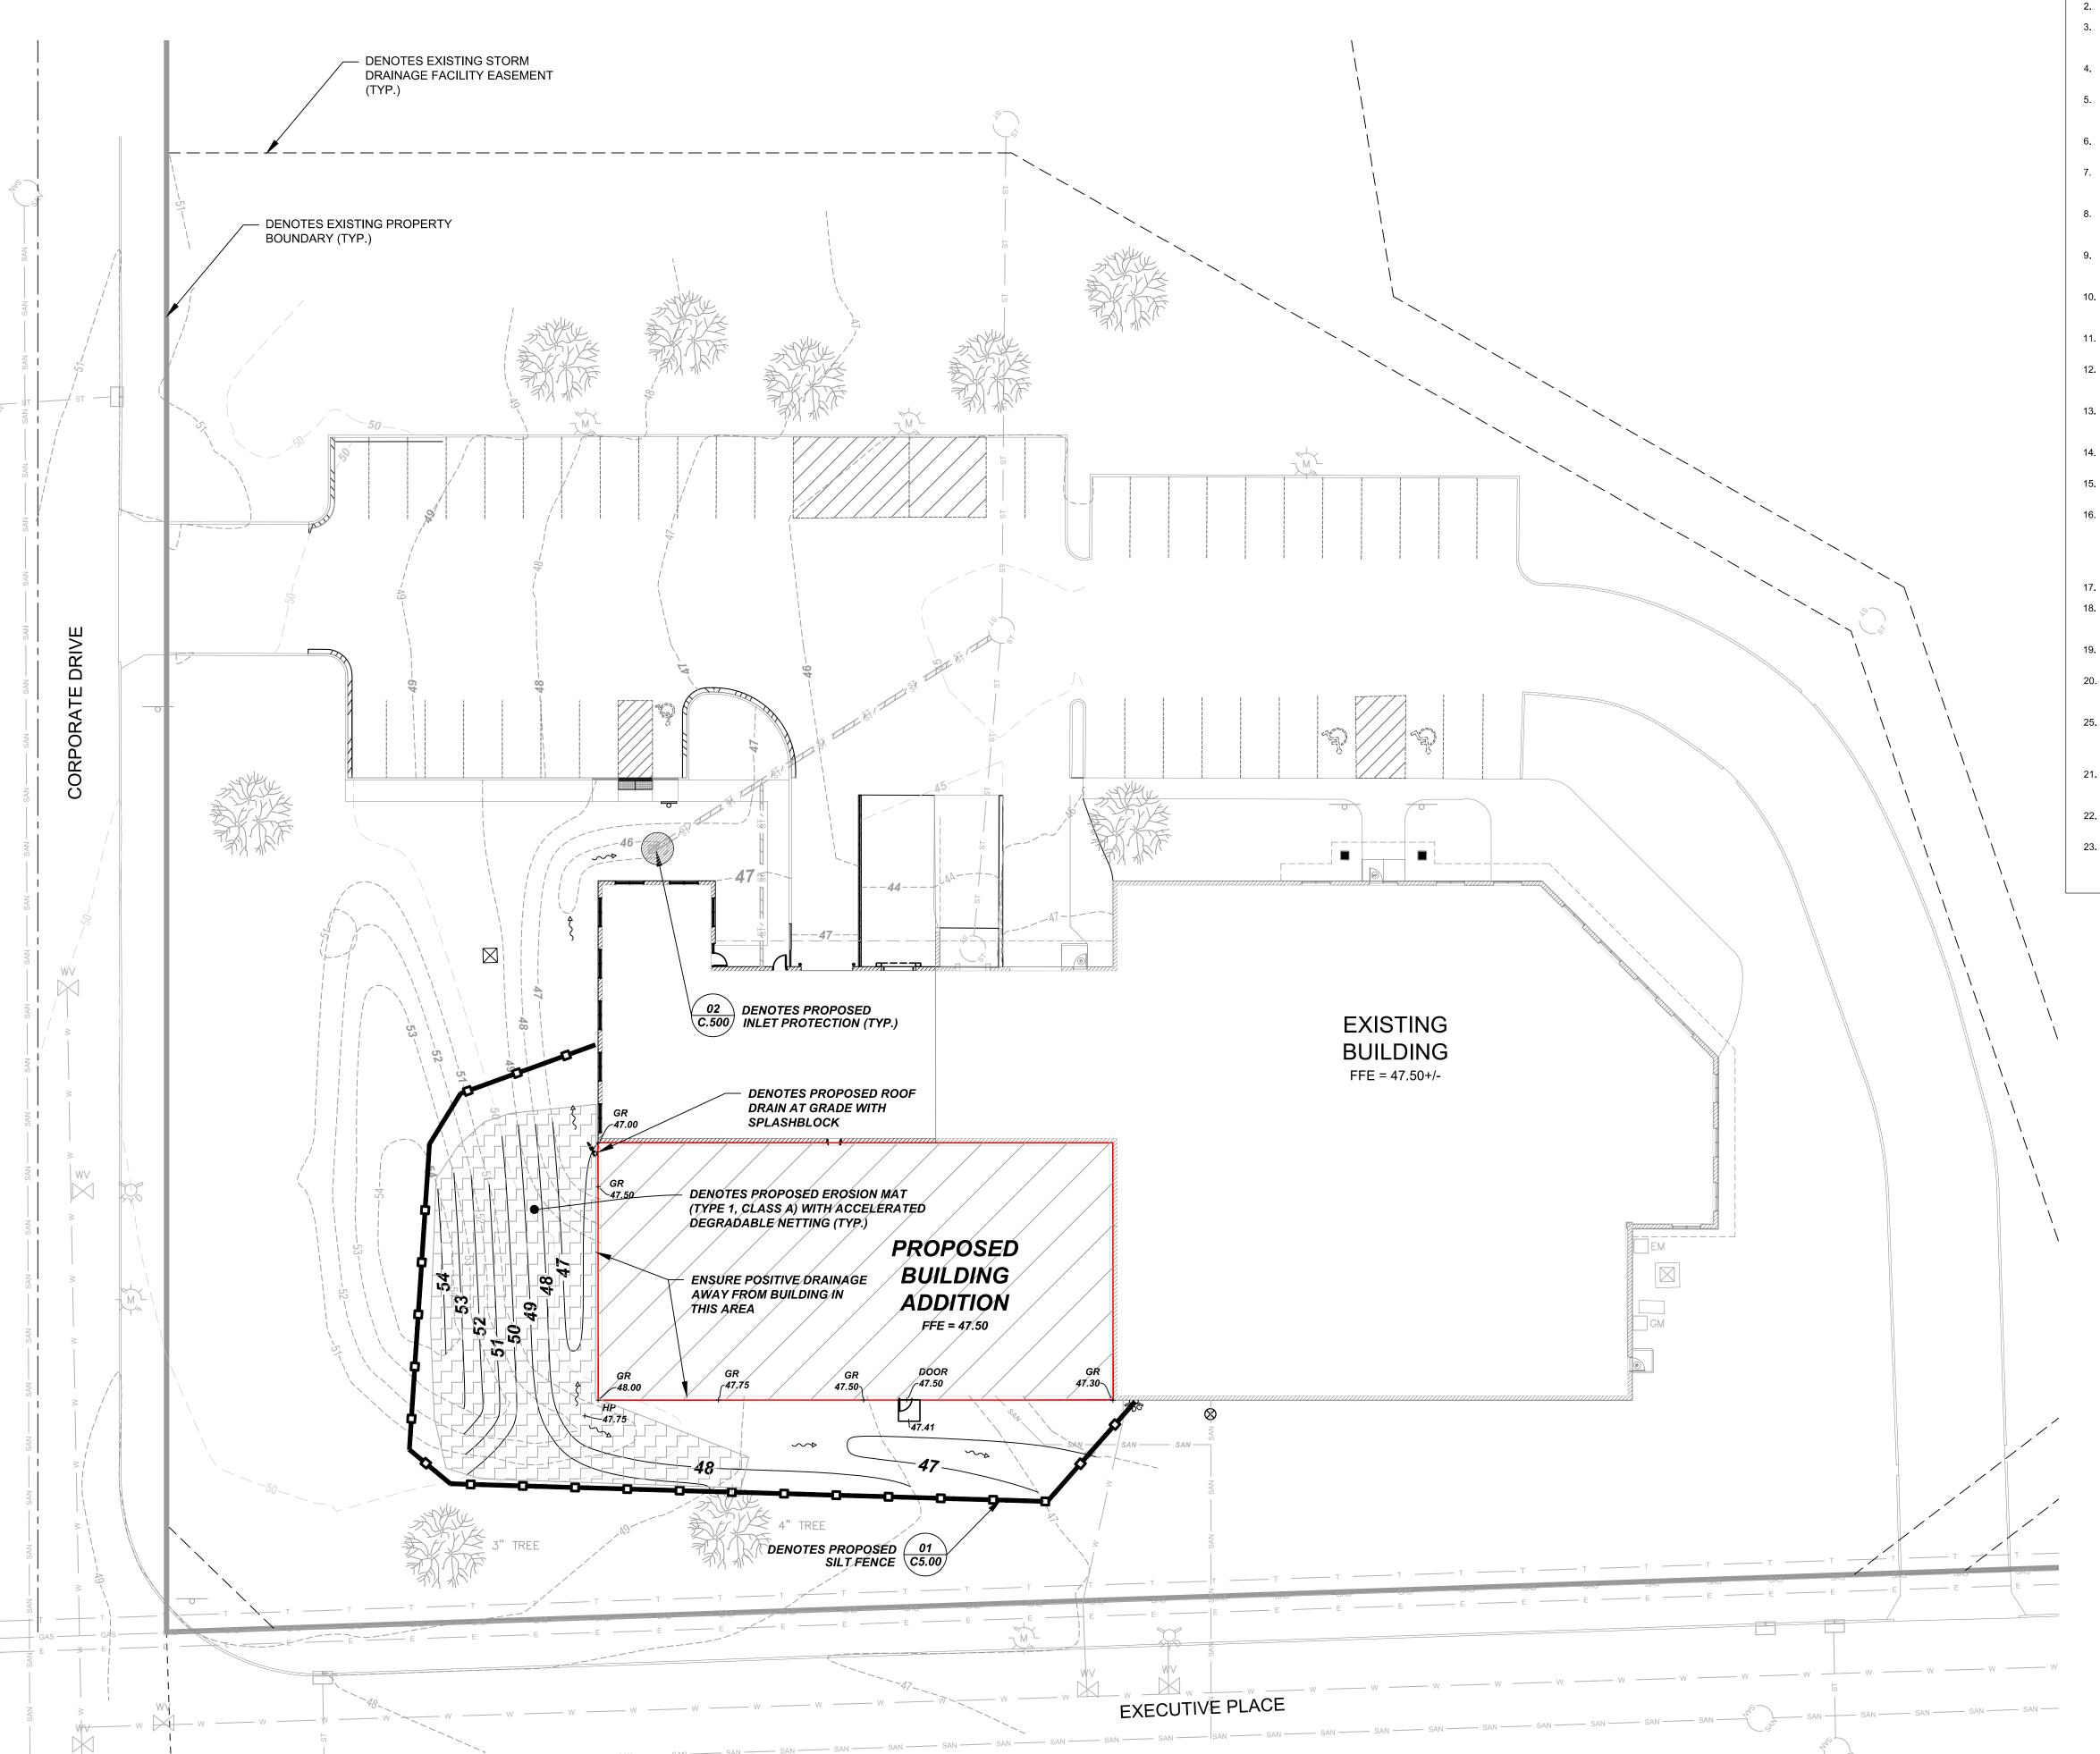

EROSION CONTROL NOTES AND PHASING

- 1. KEEP A COPY OF THE CURRENT EROSION CONTROL PLAN ON SITE THROUGHOUT THE DURATION OF THE PROJECT.
- 2. SUBMIT PLAN REVISIONS OR AMENDMENTS TO THE ENGINEER AT LEAST 5 DAYS PRIOR TO FIELD IMPLEMENTATION. 3. CONTRACTOR IS RESPONSIBLE FOR ROUTINE SITE INSPECTIONS AT LEAST ONCE EVERY 7 DAYS AND WITHIN 24 HOURS
- AFTER A RAINFALL EVENT OF 0.5 INCHES OR GREATER. KEEP INSPECTION REPORTS ON-SITE AND MAKE THEM AVAILABLE
- 4. INSPECT AND MAINTAIN ALL INSTALLED EROSION CONTROL PRACTICES UNTIL THE CONTRIBUTING DRAINAGE AREA HAS
- 5. WHEN POSSIBLE: PRESERVE EXISTING VEGETATION (ESPECIALLY ADJACENT TO SURFACE WATERS), MINIMIZE LAND-DISTURBING CONSTRUCTION ACTIVITY ON SLOPES OF 20% OR MORE, MINIMIZE SOIL COMPACTION, AND PRESERVE
- 6. REFER TO THE WDNR STORMWATER CONSTRUCTION TECHNICAL STANDARDS AT http://dnr.wi.gov/topic/stormwater/standards/const_standards.html.
- INSTALL PERIMETER EROSION CONTROLS AND TRACKOUT CONTROL PRACTICES PRIOR TO ANY LAND-DISTURBING ACTIVITIES, INCLUDING CLEARING AND GRUBBING. USE WDNR TECHNICAL STANDARD 1057 FOR TRACKOUT CONTROL AT
- 8. INSTALL INLET PROTECTION PRIOR TO LAND-DISTURBING ACTIVITIES IN THE CONTRIBUTING DRAINAGE AREA AND/OR IMMEDIATELY UPON INLET INSTALLATION. COMPLY WITH WDNR TECHNICAL STANDARD STORM DRAIN INLET PROTECTION
- 9. STAGE CONSTRUCTION GRADING ACTIVITIES TO MINIMIZE THE CUMULATIVE EXPOSED AREA. CONDUCT TEMPORARY GRADING FOR EROSION CONTROL PER WDNR TECHNICAL STANDARD TEMPORARY GRADING PRACTICES FOR EROSION
- 10. PERMITTING OF GROUNDWATER DEWATERING IS THE RESPONSIBILITY OF THE CONTRACTOR. GROUNDWATER DEWATERING IS SUBJECT TO A DNR WASTEWATER DISCHARGE PERMIT AND A DNR HIGH CAPACITY WELL APPROVAL IF CUMULATIVE PUMP CAPACITY IS 70 GPM OR MORE.
- 11. PROVIDE ANTI-SCOUR PROTECTION AND MAINTAIN NON-EROSIVE FLOW DURING DEWATERING. PERFORM DEWATERING OF ACCUMULATED SURFACE RUNOFF IN ACCORDANCE WITH WDNR TECHNICAL STANDARD DE-WATERING #1061.
- 12. INSTALL AND MAINTAIN SILT FENCING PER WDNR TECHNICAL STANDARD SILT FENCE #1056. REMOVE SEDIMENT FROM BEHIND SILT FENCES AND SEDIMENT BARRIERS BEFORE SEDIMENT REACHES A DEPTH THAT IS EQUAL TO ONE-HALF OF
- 13. REPAIR BREAKS AND GAPS IN SILT FENCES AND BARRIERS IMMEDIATELY. REPLACE DECOMPOSING STRAW BALES (TYPICAL BALE LIFE IS 3 MONTHS). LOCATE, INSTALL, AND MAINTAIN STRAW BALES PER WDNR TECHNICAL STANDARD
- 14. INSTALL AND MAINTAIN FILTER SOCKS IN ACCORDANCE WITH WDNR TECHNICAL STANDARD INTERIM MANUFACTURED PERIMETER CONTROL AND SLOPE INTERRUPTION PRODUCTS # 1071.
- 15. IMMEDIATELY STABILIZE STOCKPILES AND SURROUND STOCKPILES AS NEEDED WITH SILT FENCE OR OTHER PERIMETER CONTROL IF STOCKPILES WILL REMAIN INACTIVE FOR 7 DAYS OR LONGER.
- 16. IMMEDIATELY STABILIZE ALL DISTURBED AREAS THAT WILL REMAIN INACTIVE FOR 14 DAYS OR LONGER. BETWEEN SEPTEMBER 15 AND OCTOBER 15:
- STABILZE WITH MULCH, TACKIFIER, AND A PERENNIAL SEED MIXED WITH WINTER WHEAT, ANNUAL OATS, OR ANNUAL RYE. AS APPROPRIATE FOR REGION AND SOIL TYPE - OCTOBER 15 THROUGH COLD WEATHER: STABILIZE WITH A POLYMER AND DORMANT SEED MIX, AS APPROPRIATE FOR REGION AND SOIL TYPE.
- 17. STABILIZE AREAS OF FINAL GRADING WITHIN 7 DAYS OF REACHING FINAL GRADE.
- 18. SWEEP/CLEAN UP ALL SEDIMENT/TRASH THAT MOVES OFF-SITE DUE TO CONSTRUCTION ACTIVITY OR STORM EVENTS BEFORE THE END OF THE SAME WORKDAY OR AS DIRECTED BY THE WDNR/MUNCIPALITY. SEPARATE SWEPT MATERIALS (SOILS AND TRASH) AND DISPOSE OF APPROPRIATELY.
- 19. CONTRACTOR IS RESPONSIBLE FOR CONTROLLING DUST PER WDNR TECHNICAL STANDARD DUST CONTROL ON CONSTRUCTION SITES # 1068.
- 20. PROPERLY DISPOSE OF ALL WASTE AND UNUSED BUILDING MATERIALS (INCLUDING GARBAGE, DEBRIS, CLEANING WASTES, OR OTHER CONSTRUCTION MATERIALS) AND DO NOT ALLOW THESE MATERIALS TO BE CARRIED BY RUNOFF INTO THE RECEIVING CHANNEL.
- 25. FOR NON-CHANNELIZED FLOW ON DISTURBED OR CONSTRUCTED SLOPES 4:1 OR GREATER (OR AS SHOWN ON THE PLAN), PROVIDE CLASS I TYPE TYPE A (WITH ACCELERATED DEGRADABLE NETTING) EROSION CONTROL MATTING. SELECT EROSION MATTING FROM WDOT'S PRODUCT ACCEPTABILITY LIST (PAL); INSTALL AND MAINTAIN PER WDNR TECHNICAL STANDARD NON-CHANNEL EROSION MAT #1052.
- 21. FOR CHANNELIZED FLOW ON DISTURBED OR CONSTRUCTED AREAS (OR AS SHOWN ON THE PLANS), PROVIDE NORTH AMERICAN GREEN SC150 (OR APPROVED EQUAL) EROSION CONTROL MATTING. INSTALL AND MAINTAIN PER WDNR TECHNICAL STANDARD CHANNEL EROSION MAT #1053.
- 22. MAKE PROVISIONS FOR WATERING DURING THE FIRST 8 WEEKS FOLLOWING SEEDING OR PLANTING OF DISTURBED AREAS WHENEVER MORE THAN 7 CONSECUTIVE DAYS OF DRY WEATHER OCCUR.
- 23. INSTALL ADDITIONAL EROSION AND SEDIMENT CONTROL MEASURES (SUCH AS TEMPORARY SEDIMENT BASINS, DITCH CHECKS, EROSION CONTROL MATTING, SILT FENCING, FILTER SOCKS, WATTLES, SWALES, ETC.), OR AS DIRECTED BY

255 North 21st Street Milwaukee, WI 53233

2323 CORPORATE DRIVE

WAUKESHA WI 53189

Grading & Erosion Control Plan

SCALE: 1" = 20'

Date: Issue Set:

2022-11-11 PC SUBMITTAL

Project No.: 0022-29

Sheet No.:

C1.01

EROSION CONTROL LEGEND


SILT FILTER FENCE

CONSTRUCTION ENTRANCE **EROSION MAT**



N ACCORDANCE WITH WISCONSIN STATUTE 182.0175, DAMAGE TO TRANSMISSION FACILITIES, EXCAVATOR SHALL BE SOLELY RESPONSIBLE TO PROVIDE ADVANCE NOTICE TO THE DESIGNATED "ONE CALL SYSTEM" NOT LESS THAN THREE WORKING DAYS PRIOR TO COMMENCEMENT OF ANY EXCAVATION REQUIRED TO PERFORM WORK CONTAINED ON THESE DRAWINGS, AND FURTHER, EXCAVATOR SHALL COMPLY WITH ALL OTHER REQUIREMENTS OF THIS STATUTE RELATIVE TO EXCAVATOR'S WORK.

INLET SEDIMENT GUARD

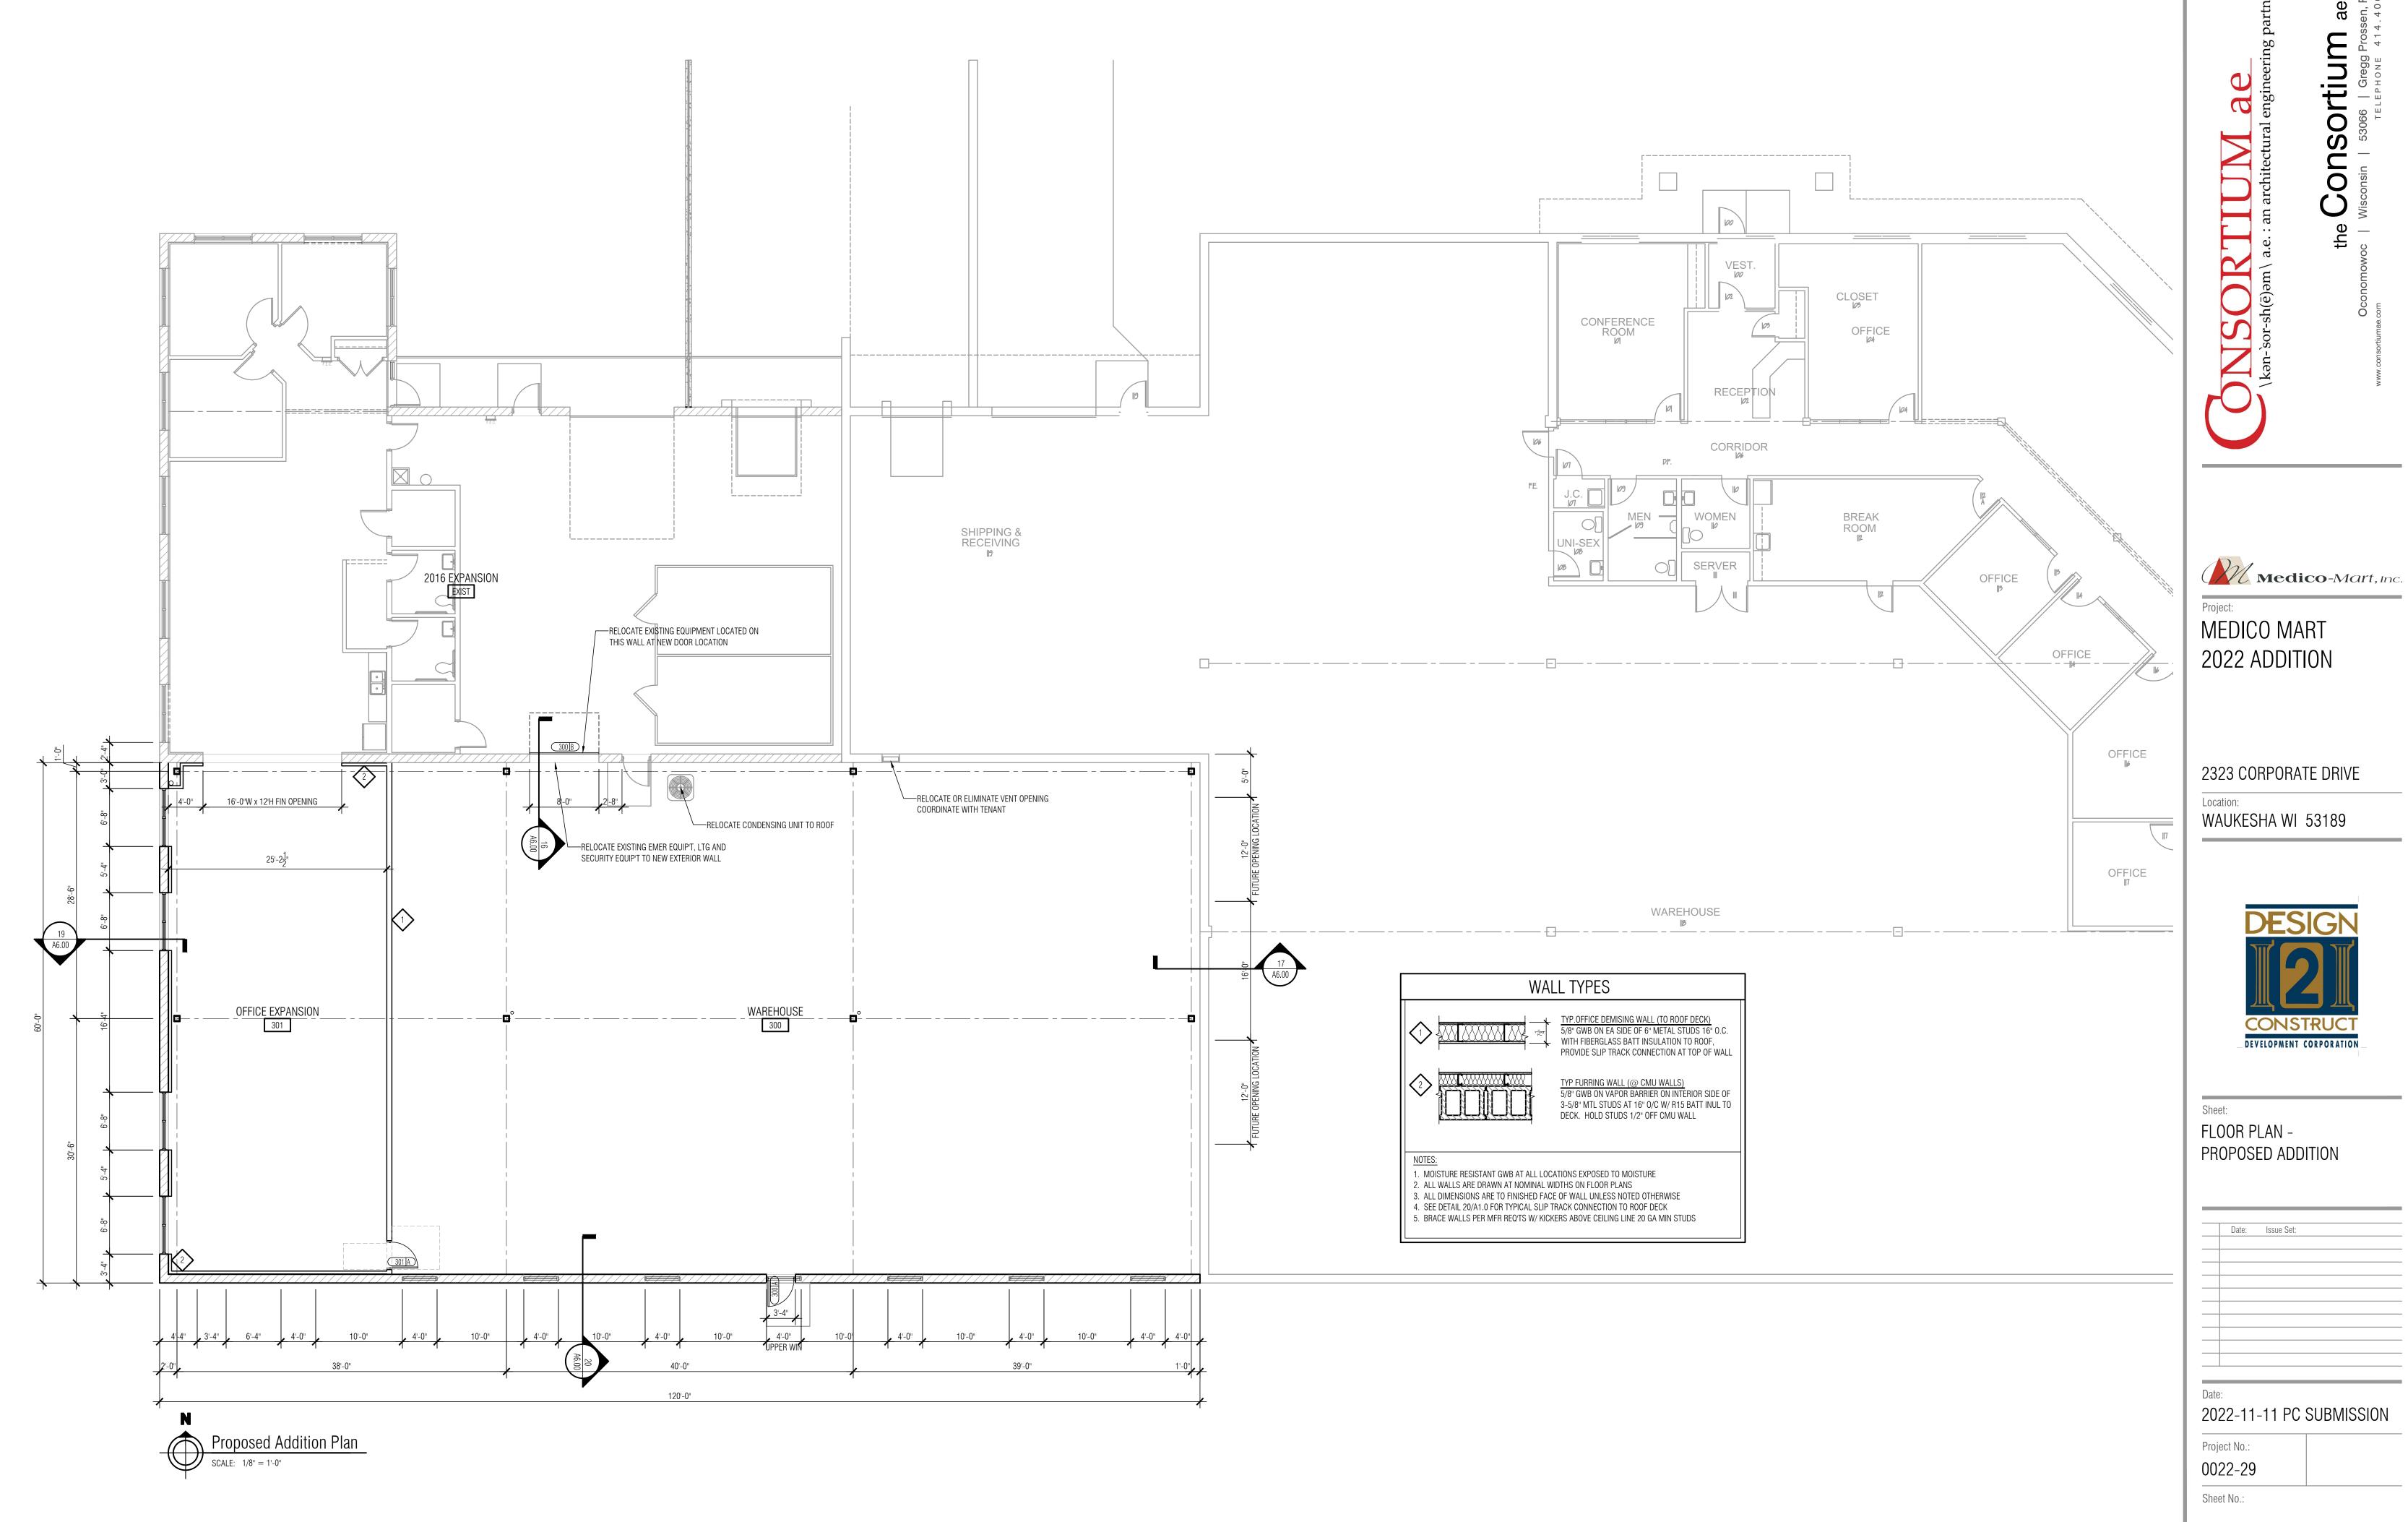

A1.00



\kan-\sor-sh(\overline{\text{e}}) | \kan-\text{sor-sh}(\overline{\text{e}}) | \kappa a architectural engineering partnership

Medico-Mart, Inc.

Project:
MEDICO MART
2022 ADDITION

2323 CORPORATE DRIVE

Location: WAUKESHA WI 53189



Sheet:
ROOF PLAN & ROOF DETAILS


Date:	Issue Set:	

Date: 2022-11-11 PC SUBMISSION

Project No.: **0022–29**

Sheet No.:

A3.00

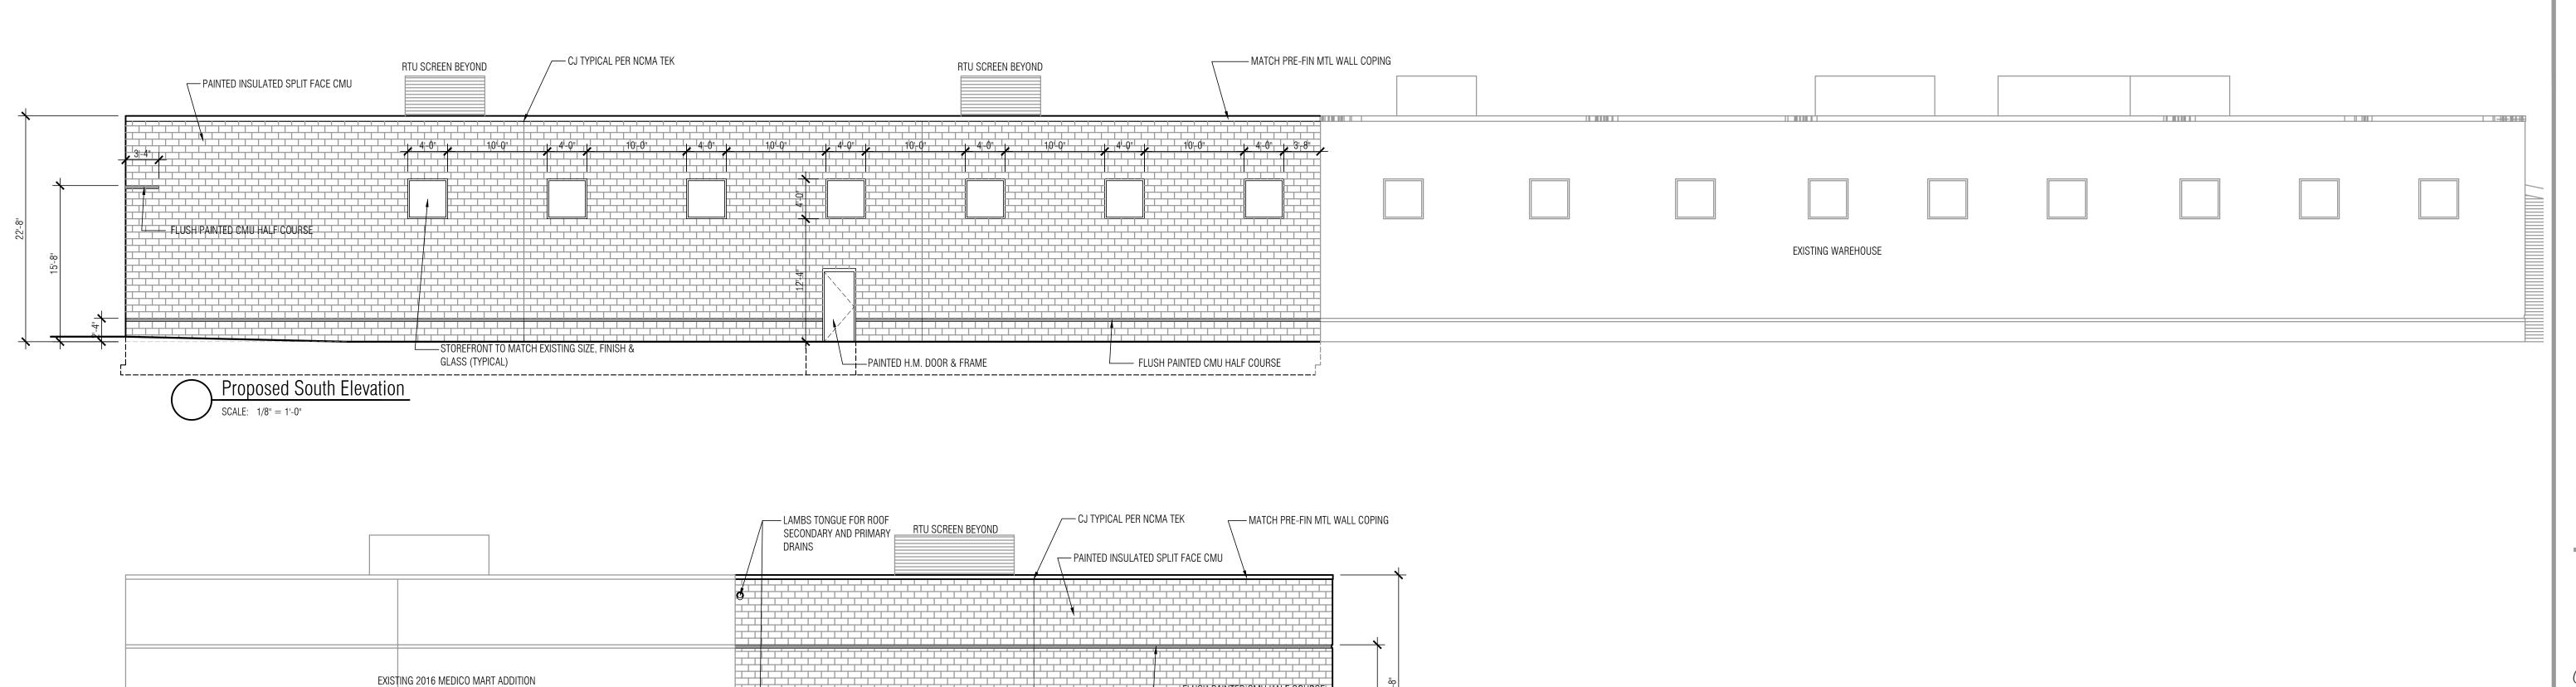

Proposed West Elevation

STOREFRONT TO MATCH EXISTING L-FLUSH PAINTED CMU HALF COURSE L-PAINTED VERTICAL SCORE CMU ACCENT

Medico-Mart, Inc.

MEDICO MART 2022 ADDITION

2323 CORPORATE DRIVE WAUKESHA WI 53189



Sheet: **ELEVATIONS**

			_
Date:	Issue Set:		

2022-11-11 PC SUBMISSION

Project No.: 0022-29

Sheet No.:

A4.00

SECTION KEYNOTES

MAIN ROOF SYSTEM
BALLASTED SINGLE-PLY EPDM ROOF MEMBRANE ON (MIN R28) RIGID INSULATION SYSTEM ON 1-1/2" METAL ROOF DECK ON STEEL JOISTS (SEE STRUCT). INSUL SYSTEM 5-1/2" THICK TO MATCH HGT OF EXISTING SYSTEM. CONTRACTOR OPTION TO PROVIDE MIXED MATERIALS TO ACHIEVE MIN R VALUE AND THERMAL BARRIER WITHIN 5-1/2" THICKNESS.

COPING SYSTEM #1
PRE-FINISHED 2 PIECE METAL WALL COPING ON CONTINUOUS P.T. 2"x WD BLOCKING ANCHORED TO TOP OF WALL SYSTEM W/COUNTER SUNK EXP ANCHORS AT 3' O/C.

GUARD 1 1-1/2" DIA. (ACTUAL) PAINTED STEEL RAIL SYSTEM TO BE MOUNTED 42" ABOVE GRADE OR ADJ HORIZ SURF WITH ONE INTERMEDIATE AT MID POINT.

G1 GLAZING SYSTEM #1
ANODIZED ALUMINUM STOREFRONT SYSTEM W/ 1" INSULATED TINTED LOWe GLAZING UNITS TO MATCH EXISTING BUILDING. MIN WINTER U=.29, SHGC=.28. PROVIDE SILL AND HEAD FLASHING AS RECOMMENDED BY MFR FOR OPENING AND SPAN CONDITIONS. SAFETY GLAZING AS REQ'D. BY CODE.

C1 ACOUSTICAL CEILING TILE SYSTEM SUSPENDED ACOUSTIC CEILING TILE (SEE FINISH SCHEDULE FOR HEIGHTS).

CONCRETE FLOOR SYSTEM
7" CONC. SLAB ON VAPOR BARRIER ON COMPACTED GRANULAR FILL ON COMPACTED SUBGRADE. PROVIDE ISOLATION JOINT MATERIAL AT COLUMNS, AND PERIMETER (SEE STRUCT.) FLOOR FINISH GROUND, STAINED & SEALED TO MATCH EXISTING.

FD1 FOUNDATION SYSTEM
CAST IN PLACE REIN CONC FTG W/ CMU TRENCH WALL. (SEE STRUCT)

CONCRETE PAD FOOTING
REINFORCED CONCRETE PAD FOOTING (SEE STRUCTURAL DRAWINGS)

EXTERIOR WALL SYSTEM
FOAMED IN PLACE, PAINTED, REINFORCED 12" ARCHITECTURAL CMU. SEE ELEVATIONS FOR CMU EXTERIOR FINISH TYPE. PROVIDE HORIZONTAL JOINT REINFORCEMENT EVERY OTHER COURSE. PROVIDE CONTROL JOINTS AS RECOMMENDED BY THE NATIONAL CONCRETE MASONRY ASSOCIATION (NCMA). SEE STRUCT DWGS FOR VERT REINF REQUIREMENTS.

CAN CANOPY MATCH EXISTING (FIELD VERIFY HGT, DIMENSIONS). PREFIN METAL ON METAL DECK ON PAINTED STEEL CHANNELS ON STEEL BEAM WITH PAINTED COLUMN. SEE STRUCT

1 STEEL BEAM BEYOND (SEE STRUCT DWGS)

2 SLOPING STEEL ANGLE (NOT CAMBERED TY, SEE STRUCT DWGS)

(3) STEEL JOIST

4 REINFORCED CMU PIER BEYOND (SEE STRUCT DWGS)

5 EMBED FOR STRUCT (SEE STRUCT DWGS)

6 TALL JOIST SEATS (SOUTH WALL) SEE STRUCT DWGS

7 GROUTED CMU COURSE

8 TAPERED ROOF INSULATION CRICKET (SEE ROOF PLAN)

9 DOCK SHELTER (FROMMELT ELIMINATOR II), MECHANICAL DOCK LEVELOR (WITH PIT & ANGLES) & BUMPERS DOCK. PROJECTION PER MFR RECOMMENDATION

10 REINFORCED CAST IN PLACE CONCRETE DOCK RETAINING WALL (SEE STRUCT DWGS)

(11) INSULATED, SECTIONAL HIGH LIFT O.H. DOOR W/ SINGLE VISION LIGHT.

CONCRETE SLAB ON COMPACTED GRANULAR FILL, PROVIDE JOINT ISOLATION MATERIAL AT BUILDING EXTERIOR (SEE CIVIL DWG'S)

13 1/2" JOINT ISOLATION MATERIAL

14 STEEL COLUMN (SEE STRUCTURAL DRAWINGS)

TWO COURSES SMOOTH FACED CMU PAINTED ACCENT BAND $+\ 2'-8"$ SQUARE SMOOTH PACED PAINTED MEDALLIONS TO MATCH EXIST'G (SEE ELEVATIONS)

REINFORCED GROUTED CMU BOND BEAM (SEE STRUCT)

17 STEEL LINTEL W/ THRU WALL FLASHING & WEEPS (SEE STRUCT)

PROVIDE CUT BLOCK, SLOPED ALUM SILL COVER (MATCH ALUM STOREFRONT SYSTEM) W/ SILL FLASHING

2" THICK EXTRUDED POLY STYRENE RIGID INSULATION AT BUILDING PERIMETER (4' TYPICAL PER CODE)



Medico-Mart, Inc.

MEDICO MART

2022 ADDITION

2323 CORPORATE DRIVE

WAUKESHA WI 53189

Sheet: WALL SECTIONS

Date: Issue Set:

2022-11-11 PC SUBMISSION

Project No.: 0022-29

Sheet No.:

A6.00

Wall Section @ Existing Bldg West Wall

| SCALE: 1/2" = 1'-0"

Wall Section West Wall

SCALE: 1/2" = 1'-0"

Wall Section South Wall

SCALE: 1/2" = 1'-0"

Wall Section between Existing Bldg & Add'n

SCALE: 1/2" = 1'-0"