



REVISIONS DESCRIPTION No. DATE 1 09.13.2024 Revision 1

WAUKESHA PLAN APPROVAL SITE PLAN JOB NUMBER: ISSUED DATE:

LANDINGS TO BE PROVIDED AT ALL EGRESS DOORS.

LANDING CLEARANCES TO MATCH "ADA DOOR CLEARANCES"


UNLESS EGRESS DOOR IS "EXIT ONLY", THEN A CLEAR FLOOR SPACE OF 36"x60" IS REQUIRED AT THE LANDING. THRESHOLDS AT DOORWAYS SHALL BE 1/2" MAX. IN HEIGHT

LANDINGS SHALL HAVE A SLOPE & CROSS SLOPE NOT

STEEPER THAN 1:48.

22056 08 26 2024

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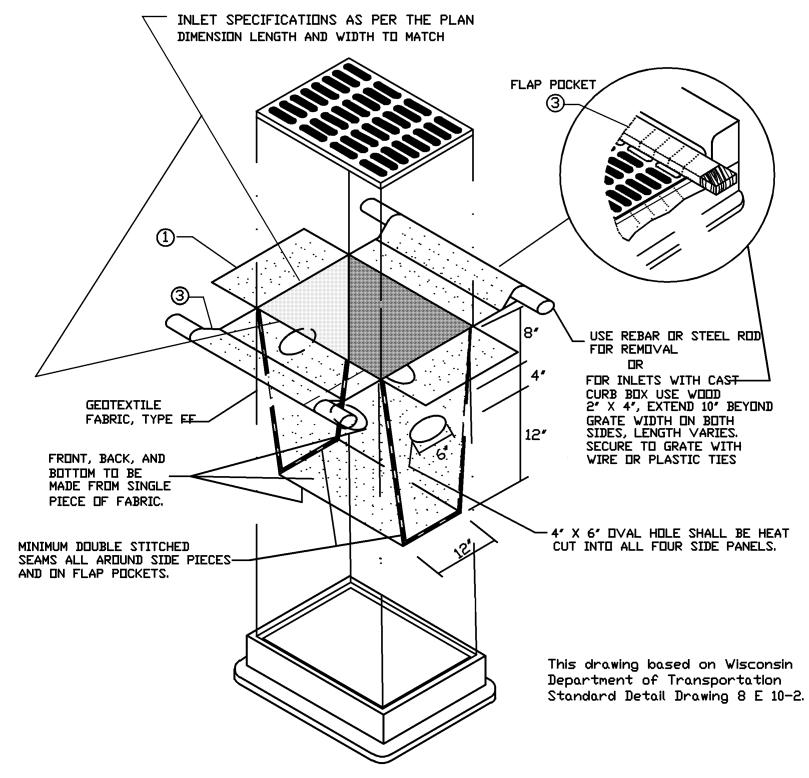


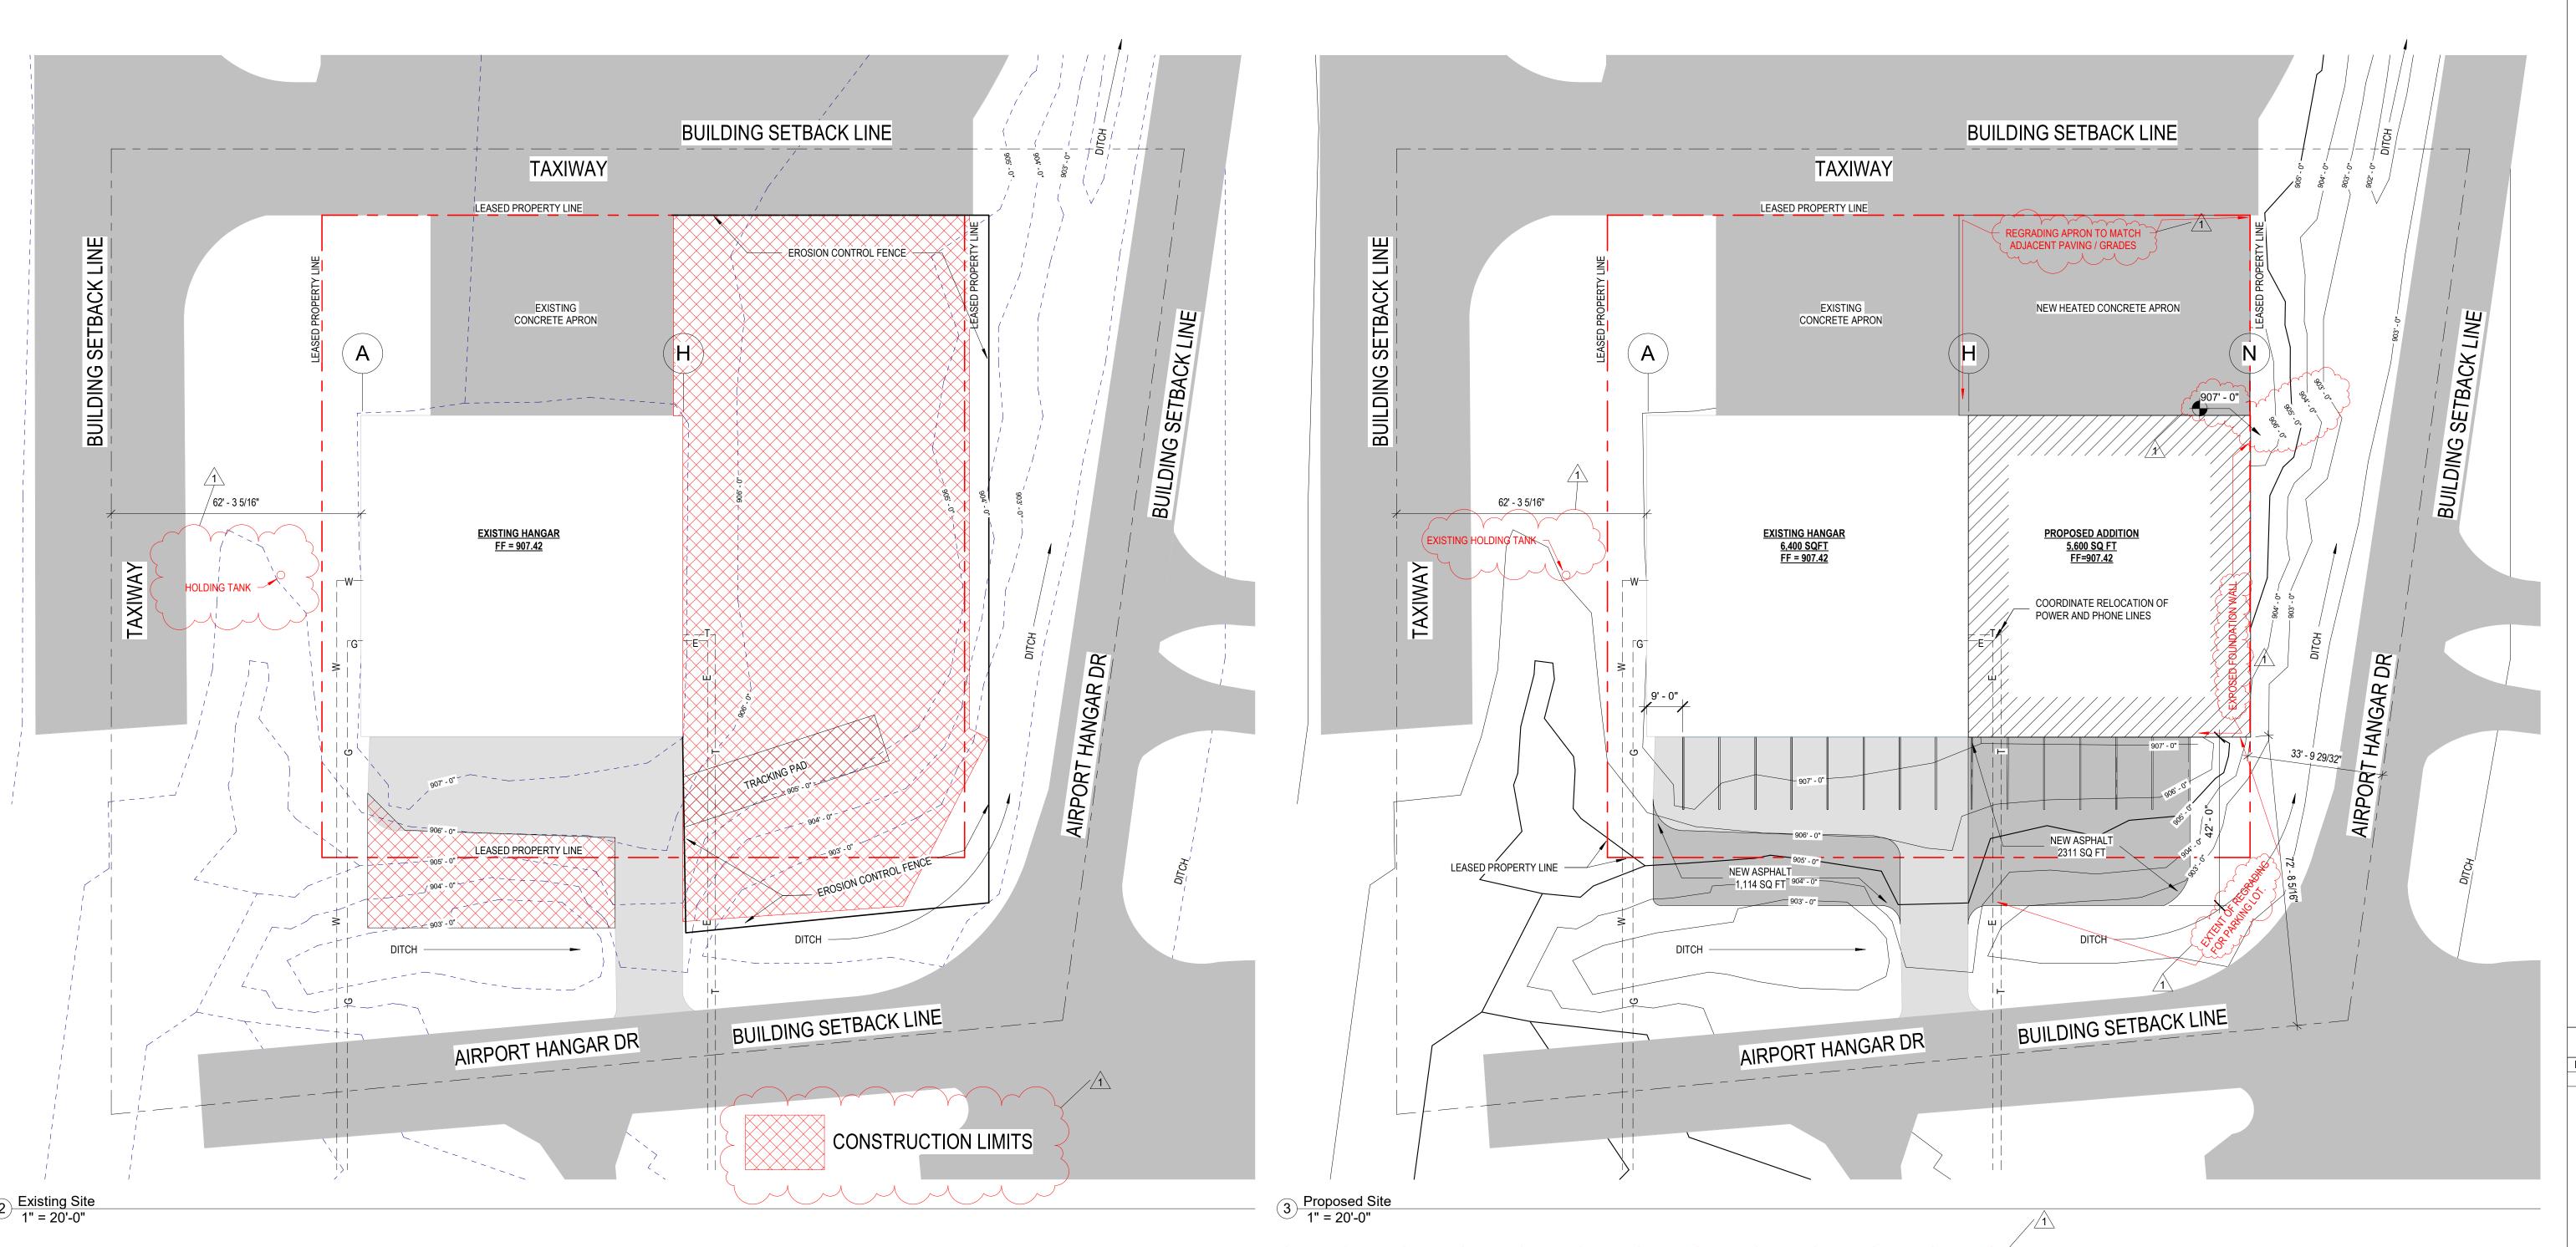"All site improvements and construction shown on the plans shall

conform to the City of Waukesha Development Handbook & Infrastructure Specifications.

Where the plans do not comply, it shall be the sole responsibility and expense of the Developer to make revisions to the plans and/or constructed infrastructure to comply."

Erosion Control Sendiment Log DTL 1/4" = 1'-0"



INLET PROTECTION, TYPE D

(CAN BE INSTALLED IN ANY INLET TYPE WITH OR WITHOUT A CURB BOX AS PER NOTE®)

GENERAL NOTES

MANUFACTURED ALTERNATIVES APPROVED AND LISTED ON THE DEPARTMENT'S EROSION CONTROL PRODUCT ACCEPTABILITY LIST MAY BE SUBSTITUTED.

WHEN REMOVING OR MAINTAINING INLET PROTECTION, CARE SHALL BE TAKEN

SO THAT THE SEDIMENT TRAPPED ON THE GEOTEXTILE FABRIC DOES NOT FALL INTO THE INLET. ANY MATERIAL FALLING INTO THE INLET SHALL BE REMOVED IMMEDIATELY.

① FINISHED SIZE, INCLUDING FLAP POCKETS WHERE REQUIRED, SHALL EXTEND A MINIMUM OF 10' AROUND THE PERIMETER TO FACILITATE MAINTENANCE OR REMOVAL.

② FOR INLET PROTECTION, TYPE C (WITH CURB BOX), AN ADDITIONAL 18' OF FABRIC IS WRAPPED AROUND THE WOOD AND SECURED WITH STAPLES. THE WOOD SHALL NOT BLOCK THE ENTIRE HEIGHT OF THE CURB BOX OPENING.

③ FLAP PUCKETS SHALL BE LARGE ENDUGH TO ACCEPT WOOD 2X4.

INSTALLATION NOTES

TYPE D

DO NOT INSTALL INLET PROTECTION TYPE D IN INLETS SHALLOWER THAN 30', MEASURED

FROM THE BOTTOM OF THE INLET TO THE TOP OF THE GRATE.

TRIM EXCESS FABRIC IN THE FLOW LINE TO WITHIN 3" OF THE GRATE.

THE INSTALLED BAG SHALL HAVE A MINIMUM SIDE CLEARANCE, BETWEEN THE INLET WALLS AND THE BAG, MEASURED AT THE BOTTOM OF THE OVERFLOW HOLES, OF 3". WHERE NECESSARY THE CONTRACTOR SHALL CINCH THE BAG, USING PLASTIC ZIP TIES, TO ACHIEVE THE 3" CLEARANCE. THE TIES SHALL BE PLACED AT

A MAXIMUM OF 4' FROM THE BOTTOM OF THE BAG.

3 Inlet Protection DTL


1/4" = 1'-0"

NOTE: THE LOCATION AND SIZE OF THE UNDERGROUND STRUCTURES AND UTILITIES SHOWN HEREON HAVE BEEN LOCATE4D TO A REASONABLE DEGREE OF ACCURACY, BUT THE ENGINEER AND/OR SURVEYOR DOES NOT GUARANTEE THEIR EXACT LOCATION OR THE LOCATION OF OTHERS NOT SHOWN.

CONTACT DIGGERS HOTLINE, INC., ETC.



WI STATUTE 182.0175(1974)
REQUIRES MIN. 3 WORK DAYS
NOTICE BEFORE YOU EXCAVATE
MILWAUKEE AREA 259-1181

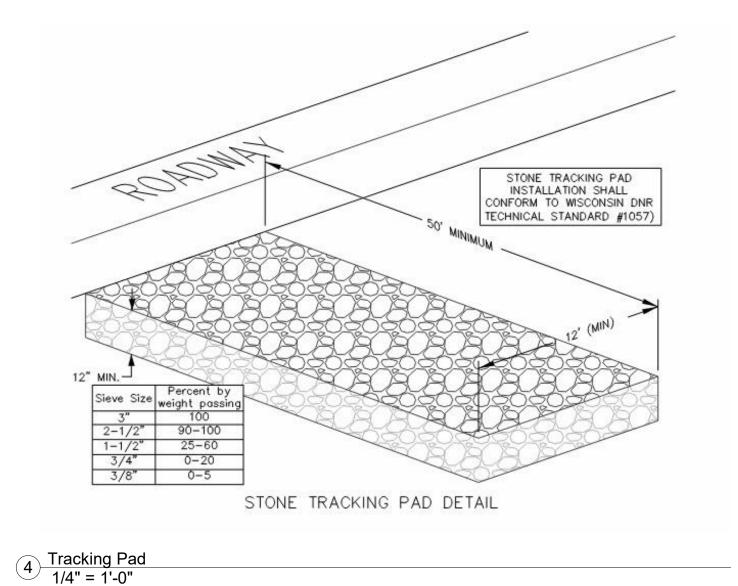

JOINING TWO LENGTHS OF SILT FENCE

TIEBACK BETWEEN FENCE TRENCH SHALL BE A MINIMUM OF 4" WIDE & 6" DEEP TO BURY AND ANCHOR THE GEOTEXTILE FABRIC. FOLD MATERIAL TO FIT TRENCH AND BACKFILL & POST AND ANCHOR COMPACT TRENCH WITH EXCAVATED SOIL. 2. WOOD POST SHALL BE A MINIMUM SIZE OF 1 1/8" X 1 1/8" OF OAK OR CONSTRUCT SILT FENCE FROM A CONTINUOS ROLL IF POSSIBLE BY CUTTING LENGTHS TO AVOID JOINTS. IF A JOINT IS NECESSARY, USE ONE OF THE THE FOLLOWING TWO METHODS: FENCE A) TWIST METHOD - - OVERLAP THE END POST AND TWIST, OR ROTATE, AT LEAST 180 DEGREES, OR FLOW DIRECTION B) HOOK METHOD - - HOOK THE END OF EACH SILT FENCE LENGTH. **GEOTEXTILE** GEOTEXTILE WOOD POST **3"** MAX. ¯ SUPPORT LENGTH 3'-4". CORD — 20" DEPTH IN GROUND GEOTEXTILE SILT FENCE TIE BACK NOTE: ADDITIONAL POST DEPTH OR TIE BACKS MAY TWIST METHOD (WHEN ADDITIONAL SUPPORT REQUIRED) FLOW-BE REQUIRED IN UNSTABLE SOILS FLOW DIRECTION GEOTEXTILE__ FABRIC ONLY GEOTEXTILE **GEOTEXTILE** BACKFILL & COMPACT_ TRENCH WITH EXCAVATED SOIL NOTE: 8'-0" POST SPACING ALLOWED IF A WOVEN GEOTEXTILE FABRIC IS USED. HOOK METHOD SILT FENCE SILT FENCE TO BE INSTALLED IN ACCORDANCE WITH WISCONSIN DEPARTMENT

TRENCH DETAIL

2 Erosion Control Fence DTL 1/4" = 1'-0"

OF NATURAL RESOURCES CONSERVATION PRACTICE STANDARD 1056

(THIS DRAWING BASED ON WISCONSIN DEPARTMENT OF TRANSPORTATION DETAIL

DRAWING 8 E 9-6)





HANGAR ADDITION 556 & 558 NORTHVIEW RD WAUKESHA, WI

REVISIONS

No. DATE DESCRIPTION

WAUKESHA PLAN APPROVAL

SHEET TITLE:

CIVIL DETAILS

JOB NUMBER:

22056

ISSUED DATE:

08 26 2024

DRAWN BY:

NUMBER:

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