### SITE INFORMATION

SITE LANDSCAPE PERCENTAGE

TOTAL PARKING STALLS

USDA PLANT HARDINESS ZONE 5a (-20 to -15 Degrees F) LOT ZONING M-1 Light Manufacturing LOT AREA 365,267 SQ. FT. (8.39 Acres) SITE BUILDING AREA 5,820 SQ. FT. TOTAL IMPERVIOUS TOTAL GREENSPACE

### **EXISTING CONDITIONS GENERAL NOTES**

- 1. INFORMATION PERTAINING TO EXISTING CONDITIONS GIVEN ON THESE LANDSCAPE DRAWINGS REPRESENTS TO THE BEST OF OUR KNOWLEDGE THE ACTUAL EXISTING FIELD CONDITIONS. INSITE LANDSCAPE DESIGN, INC. MAKES NO WARRANTY AS TO THEIR ACCURACY. CONTRACTOR TO FIELD VERIFY EXISTING CONDITIONS IMPERATIVE TO THEIR NEW WORK. REPORT ANY DISCREPANCIES BETWEEN THE DRAWINGS AND FIELD CONDITIONS TO THE LANDSCAPE ARCHITECT FOR REVIEW. ANY WORK PERFORMED PRIOR TO RESOLUTION OF DISCREPANCIES BY THE LANDSCAPE ARCHITECT IS SUBJECT TO REMOVAL AND REPLACEMENT AT NO ADDITIONAL COST TO THE CONTRACT.
- 2. THE LOCATIONS OF EXISTING UTILITY INSTALLATIONS AS SHOWN ON THIS PLAN ARE APPROXIMATE. THERE MAY BE UNDERGROUND UTILITY INSTALLATIONS WITHIN THE PROJECT AREA OF DISTURBANCE THAT ARE NOT SHOWN. THE CONTRACTOR SHALL BE RESPONSIBLE FOR VERIFYING THE EXISTENCE AND LOCATION OF ALL UNDERGROUND UTILITIES.
- 3. VERIFY ALL EXISTING CONDITIONS, DIMENSIONS, AND ALIGNMENT OF WALLS. BRING ANY DISCREPANCIES TO THE LANDSCAPE ARCHITECTS ATTENTION PRIOR TO FABRICATION / CONSTRUCTION BEGINS.
- 4. VERIFY LOCATION OF ACCESS PANELS w/ MECHANICAL AND ELECTRICAL EQUIPMENT FOR ACCESSIBILITY OF MECHANICAL & ELECTRICAL ITEMS. VERIFY LOCATIONS OF ALL BURIED UTILITIES AND STRUCTURES AND LOCATIONS OF ALL OVERHEAD WIRES.
- VERIFY LOCATION OF ALL EXISTING EASEMENTS.
- INSITE LANDSCAPE DESIGN, INC, ASSUMES NO RESPONSIBILITY FOR DAMAGES, LIABILITY OR COSTS RESULTING FROM CHANGES OR ALTERATIONS MADE TO THIS PLAN WITHOUT THE EXPRESSED WRITTEN CONSENT OF INSITE LANDSCAPE DESIGN, INC.

#### DESIGN COMPLIANCE: THIS LANDSCAPE PLAN IS ACCURATE AND IN COMPLAINACE WITH THE CITY OF WAUKESHA LANDSCAPE REQUIREMENTS SET FOR IN SECTION 22.18 LANDSCAPING 22.18.4 REQUIRED LANDSCAPE PLANTING.

(Am. #38-02) The number of plant materials required in order to achieve an appropriate and complete landscape plan for a site shall be provided so that plant materials shall consist of a mixture of trees, shrubs, and ground cover as approved by the Plan Commission. Business, industrial, institutional, and park development shall plant appropriate trees, shrubs, and ground cover--as approved by the Plan Commission--based on the size of the project. 22.18.6 MINIMUM SIZE OF PLANTINGS. All plantings under this subsection shall be in accordance with the following:

Deciduous trees shall be a minimum size of two and one half (2 1/2) inches in diameter at four and one half (4 1/2) feet above grade.

77 STALLS

Coniferous trees shall be a minimum of six (6) feet in height. Shrubs shall be a minimum of eighteen (18) inches in height or spread.

Ornamental trees shall be a minimum size of one and one half (1 1/2) inches in diameter at four and one half (4 1/2) feet above grade.

CONTRACTOR NOTE: THE LANDSCAPE CONTRACTOR/GENERAL CONTRACTOR ARE RESPONSIBLE TO INSTALL THE LANDSCAPE AS PER THE APPROVED PLAN. IF ANY CHANGES OR DEVIATIONS ARE MADE FROM THE THIS APPROVED PLAN, THE LANDSCAPE CONTRACTOR / GENERAL CONTRACTOR ARE RESPONSIBLE FOR UPDATING THE PLANS ACCORDINGLY AND SUBMITTING THOSE REVISED PLANS FOR APPROVAL AND "SIGN OFF" WITH THE CITY OF WAUKESHA. THE LANDSCAPE CONTRACTOR / GENERAL CONTRACTOR ARE ALSO RESPONSIBLE FOR VERIFYING THAT ANY PLANT MATERIAL SUBSTITUTIONS OR MODIFICATIONS THAT ARE MADE TO THE APPROVED LANDSCAPE DESIGN DOCUMENTS WILL NOT CHANGE OR ALTER ANY OF THE REQUIRED SUPPORTING LANDSCAPE REQUIREMENT CALCULATIONS. UPON COMPLETION OF THE CONSTRUCTION PROJECT AND FILE THAT AFFIDAVIT WITH THE CITY OF WAUKESHA

### LANDSCAPE PLAN GENERAL NOTES

#### PLANT MATERIAL SHOWN ON LANDSCAPE PLAN IS DEPICTED AT MATURE GROWTH.

- 1. AT LEAST SEVENTY-TWO HOURS PRIOR TO ANY EXCAVATION, CONTRACTOR SHALL VERIFY UTILITY LOCATIONS AS GIVEN BY THE ELECTRIC, GAS, TELEPHONE, WATER, SEWER, AND CABLE TELEVISION COMPANIES, UTILITIES OR ENTITIES. REVIEW WITH OWNER'S REPRESENTATIVE SITE MECHANICAL, SITE ELECTRICAL AND LIGHTING, SITE GRADING AND DRAINAGE, SITE IRRIGATION AND ALL OTHER DRAWINGS PERTAINING TO UNDERGROUND UTILITY LOCATIONS. RECORD SET OF INFORMATION THE SAME AS IN POSSESSION OF OWNER'S REPRESENTATIVE. ALSO REVIEW OWNER'S "MARK SETS" OF ALL OF THESE DRAWINGS IN POSSESSION OF THE CONTRACTOR OR OWNER. MARK ALL SUCH UTILITIES ON THE SITE PRIOR TO COMMENCING. COORDINATE WITH OWNER BEFORE AND DURING CONSTRUCTION. REPAIR ANY DAMAGE TO ANY SYSTEM THAT IS CAUSED BY LANDSCAPE CONTRACTOR AT NO COST TO OWNER.
- 2. ALL PLANTINGS SPECIFIED FOR THE ENTERPRISE MOBILITY PARKING LOT PROJECT PLANTING TABLES SHALL COMPLY WITH STANDARDS AS DESCRIBED IN AMERICAN STANDARD OF NURSERY STOCK ANSI Z60.1 2014 AND ANSI STANDARDS FOR PLANTING 2012.
- 3. ALL DEVIATIONS FROM THE APPROVED ENTERPRISE MOBILITY PARKING LOT PROJECT PLANS SHALL BE NOTED ON THE RECORD DRAWINGS BY THE CONTRACTOR AND MAY BE EXECUTED ONLY WITH PRIOR APPROVAL FROM THE LANDSCAPE ARCHITECT AND OWNER'S REPRESENTATIVE. VERBAL AGREEMENTS OR REVISIONS WITHOUT A CHANGE ORDER WILL NOT BE RECOGNIZED BY LANDSCAPE ARCHITECT AND OWNER.
- 4. ALL PLANTS MUST BE BID AND SELECTED PER THE SPECIES SPECIFIED ON THE PLANS. ANY SPECIES SUBSTITUTIONS MUST BE APPROVED IN WRITING BY LANDSCAPE ARCHITECT. THE SIZES OF PLANT MATERIAL LISTED HEREIN IS A MINIMUM ACCEPTABLE SIZE. ADDITIONALLY, IF EXCESSIVE PRUNING REDUCES THE CROWN THE PLANT SHALL BE REPLACED.
- 5. PROTECT PUBLIC FROM CONSTRUCTION WITH BARRIERS AND BARRICADES.
- 6. ALL AREAS THAT WERE DISTURBED DURING CONSTRUCTION AND AREAS NOT COVERED WITH PAVEMENT, BUILDING, PLANTING BEDS, OR TREE PITS ARE TO BE TOPSOILED 3" DEEP (MIN.) AND SHALL BE SODDED/SEEDED WITH SPECIFIED LAWN GRASS. LANDSCAPE CONTRACTOR SHALL INCLUDE COST PER SQUARE YARD FOR ADDITIONAL SEED OPERATIONS AS MAY BE POSSIBLY REQUIRED TO REESTABLISH ADJACENT TURF GRASS AREAS WHICH MAY BECOME DAMAGED DURING THE CONSTRUCTION PROCESS OR TO REPAIR DAMAGE DONE BY OTHERS.
- 7. CONTRACTOR IS RESPONSIBLE FOR FURNISHING ALL MATERIALS, TOOLS, EQUIPMENT, LABOR, AND PLANTS NECESSARY FOR PROPER PLANTING AND INSTALLATION OF ALL LANDSCAPE MATERIAL
- 8. QUANTITIES ON PLANT MATERIALS LIST ARE FOR CONVENIENCE OF BIDDING ONLY. CONTRACTOR IS RESPONSIBLE FOR ALL PLANTS SHOWN ON LANDSCAPE PLANS AND COVERAGE OF ALL AREAS DELINEATED. THE PLANS ARE TO SUPERSEDE THE PLANT LIST IN ALL CASES.
- 9. CONTRACTOR IS RESPONSIBLE FOR ALL ESTIMATING AND BIDDING, ALL AREAS, QUANTITIES MATERIALS SHOULD BE FIELD VERIFIED WITH SITE CONDITION.
- 10. WHERE DISCREPANCIES OCCUR BETWEEN THE LANDSCAPE PLANS AND/OR ARCHITECTURAL AND/OR THE CIVIL DRAWINGS (AND ANY OTHER SITE DRAWINGS) THE DISCREPANCIES MUST BE BROUGHT TO THE LANDSCAPE ARCHITECTS ATTENTION FOR
- 11. ALL DISEASED, NOXIOUS OR INAPPROPRIATE MATERIALS SHALL BE REMOVED FROM THE PROPOSED SITE PRIOR TO THE START OF CONSTRUCTION AND DURING THE MAINTENANCE PERIOD.
- 12. GENERAL CONTRACTOR SHALL LEAVE THE SITE FREE OF CONSTRUCTION DEBRIS.
- 13. ALL LAWN AND PLANTING AREAS SHALL SLOPE TO DRAIN A MINIMUM OF 2% UNLESS NOTED OTHERWISE AND REVIEWED WITH OWNER'S REPRESENTATIVE FOR FINAL APPROVAL.
- 14. FINISH GRADES FOR SHRUB AND GROUND COVER AREAS SHALL BE HELD 1" BELOW TOP OF ADJACENT PAVEMENTS AND CURBS, UNLESS NOTED OTHERWISE ON THE PLANS. REFER TO LSP1.2 FOR FURTHER INFORMATION.
- 15. ALL PERENNIAL, ANNUAL AND GROUND COVER AREAS TO RECEIVE A BLEND OF ORGANIC SOIL AMENDMENTS PRIOR TO PLANTING. TILL THE FOLLOWING MATERIALS INTO EXISTING TOPSOIL TO A DEPTH OF APPROXIMATELY 8". A DEPTH OF 12" IN TREE PITS. PROPORTIONS AND QUANTITIES MAY REQUIRE ADJUSTMENT DEPENDING ON THE CONDITION OF EXISTING SOIL. REFER TO LSP1.2 FOR FURTHER INFORMATION. PER EVERY 100 SQUARE FEET ADD: ONE - 2 CUBIC FOOT BALE OF PEAT MOSS, 2 POUNDS OF 5 -10 -5 GARDEN FERTILIZER, 1/4 CUBIC YARD OF COMPOSTED MANURE OR OTHER COMPOSTED, ORGANIC MATERIAL.
- 16. ALL SHRUBS TO BE POCKET PLANTED WITH A 50/50 MIX OF COMPOSTED, ORGANIC MATERIAL AND EXISTING SOIL. INSTALL TOPSOIL INTO ALL BEDS AS NEEDED TO ACHIEVE PROPER GRADE. REMOVE ALL EXCESSIVE GRAVEL, CLAY AND STONES. REFER TO LSP1.2
- 17. PLANT ALL TREES SLIGHTLY HIGHER THAN FINISHED GRADE AT ROOT FLARE. BACK FILL HOLE WITH 2/3 EXISTING TOPSOIL AND ORGANIC SOIL AMENDMENTS SPECIFIED IN NOTE 15. AVOID ANY AIR POCKETS. DISCARD ANY GRAVEL CLAY OR STONES. REFER TO
- 18. ALL TREES TO BE INSTALLED, STAKED AND GUYED ACCORDING TO DETAILS. REFER TO ANSI STANDARDS FOR PLANTING 2012 AND DETAILS ON LSP1.2 FOR FURTHER INFORMATION. 19. PROVIDE A 4'-0" - 5'-0" DIAMETER MULCH RING AT THE ROOT BALL FLARE OF ALL LAWN TREES.
- 20. ALL PLANTINGS TO BE WATERED AT THE TIME OF PLANTING, THROUGHOUT CONSTRUCTION AND UPON COMPLETION OF PROJECT AS REQUIRED.
- 21. WHERE SPECIFIED, ALL PLANT BEDS, PITS AND TREE RINGS ARE TO RECEIVE A MINIMUM OF 2" 3" DRESSING OF SHREDDED HARDWOODM OAK BARK MULCH SHAVINGS FREE OF GROWTH, WEEDS, FOREIGN MATTER DETRIMENTAL TO PLANT LIFE OR GERMINATION INHIBITING INGREDIENTS. LANDSCAPE CONTRACTOR TO PROVIDE A SAMPLE TO OWNER FOR APPROVAL. CONTRACTOR TO TAKE CARE WITH INSTALLATION NOT TO DAMAGE OR COVER PLANTS. REFER TO LSP1.2 FOR FURTHER INFORMATION.
- 22. LAWN INSTALLATION: CONTRACTOR TO FURNISH AND PREPARE TOPSOIL (3" MIN) AND SEED BED (REMOVE ALL STONES 1" OR LARGER), APPLY STARTER FERTILIZER AND SEED UNIFORMLY. PROVIDE A MULCH COVERING SUITABLE TO GERMINATE AND ESTABLISH TURF. EROSION CONTROL MESH SHOULD BE USED IN SWALES AND STEEP GRADES WHERE APPLICABLE. METHODS OF INSTALLATION MAY VARY AT THE DISCRETION OF CONTRACTOR. IT IS HIS/HER RESPONSIBILITY TO ESTABLISH AND GUARANTEE A SMOOTH, UNIFORM, QUALITY TURF. IF STRAW MULCH IS USED AS A COVERING, A TACKIFIER MAY BE NECESSARY TO AVOID WIND DAMAGE.
- 23. DELUXE 50 GRASS SEED MIX REINDER'S (800) 785-3301
- 20% KENTUCKY BLUE GRASS 15% NEWPORT KENTUCKY BLUE GRASS
- 15% SR 2100 Kentucky Bluegrass
- 25% Creeping Red Fescue 15% Replicator Perennial Ryegrass
- 10% Fiesta 4 Perennial Ryegrass
- APPLY AT A RATE OF 200 POUNDS PER ACRE. REFER TO SUPPLIERS SPECIFICATIONS & INSTALLATION CUT SHEETS FOR FURTHER FORMATION
- 24. DURING THE INITIAL "30 DAY MAINTENANCE PERIOD" THE LANDSCAPE CONTRACTOR IS REQUIRED TO PROVIDE AND ON-GOING PLEASANT VISUAL ENVIRONMENT WHEREAS ANY PLANT WHICH IS NOT RESPONDING TO TRANSPLANTING OR THRIVING SHALL IMMEDIATELY BE REPLACED. NEW LAWNS SHALL BE WATERED AND REPAIRED AND WEEDS MUST CONSTANTLY BE REMOVED, NO EXCEPTIONS WILL BE GRANTED.
- MAINTENANCE IS THE RESPONSIBILITY OF THE PROPERTY OWNER TO MAINTAIN REQUIRED LANDSCAPING IN ACCORDANCE WITH THE MUNICIPALITY'S PROPERTY MAINTENANCE CODE AND AN APPROVED MAINTENANCE PLAN. THE MAINTENANCE MUST INCLUDE,
- AT A MINIMUM, METHODS FOR PROVIDING THE FOLLOWING:
- NECESSARY IRRIGATION (if REQUIRED) INTEGRATED PEST MANAGEMENT,
- PROPER FERTILIZATION
- TREE CARE AND PRUNING, SHRUB TIP CLIPPING AND SHAPING AS REQUIRED
- REPLACEMENT OF LOST VEGETATION, AND ALL DISEASED, DAMAGED, OR DEAD MATERIAL WILL BE REPLACED BY THE END OF THE FOLLOWING PLANTING SEASON IN PERPETUITY.
- WEED MANAGEMENT AND BED CARE.
- 25. ALL NEWLY PLANTED TREES AND SHRUBS ARE TO RECIEVE AN APPLICATION OF AN ANTI-TRANSPIRANT SPRAY THAT WILL EFFECTIVELY REDUCE THE WATER LOSS OF TRANSPIRATION OF PLANT MATERIAL AND REDUCE THE STRESS OF TRANSPLANTATION. IT IS RECOMENDED AS PART OF THE ONGOING MAINTENANCE THAT ANY BROADLEAF EVERGREEN AND CONIFEROUS TREE AND SHRUBS (EXCLUDING ARBORVITAE) RECIEVE AN APPLIATION OF AN ANTI-DESICANT SPRAY TO REDUCE THE LOSS OF MOISTURE DUE TO WINTER DESICCATION.
- 26. MAINTENANCE. THE OWNER SHALL TEND AND MAINTAIN ALL PLANT MATERIALS IN A HEALTHY GROWING CONDITION AS PER THE APPROVED PLAN. PLANTINGS SHALL BE REPLACED WHEN NECESSARY AND KEPT FREE FROM REFUSE & DEBRIS. ALL PLANTING MATERIAL WHICH IS DYING OR DAMAGED BEYOND RECOVERY SHALL BE REPLACED WITHIN SIX (6) MONTHS OR BY THE NEXT PLANTING SEASON, WHICHEVER COMES FIRST.
- 27. LANDSCAPE / SITE DEMOLITION CONTRACTOR TO VERIFY LOCATIONS OF EXISTING TREES AND SHRUBS TO BE SALVAGED AND CLEARLY TAG THEM WITH MARKING TAPE AND CONSTRUCTION FENCE.



UNDERGROUND SEWER AND UTILITY INFORMATION TO OBTAIN LOCATION OF AS SHOWN IS OBTAINED FROM THE RECORDS OF MUNICIPALITY AND LOCAL UTILITY COMPANIES. UNDERGROUND FACILITIES THE ACCURACY OF WHICH CAN NOT BE BEFORE YOU DIG IN WISCONIN GUARANTEED OR CERTIFIED TO. THE LOCATIONS CALL THE MILWAUKEE UTILITY of existing utility installations as shown on

OTHER UNDERGROUND UTILITY INSTALLATIONS

ALERT NETWORK THIS SURVEY ARE APPROXIMATE. THERE MAY BE <u>www.Diggershotline.com</u> (800)-242-8511 WITHIN THE PROJECT AREA THAT ARE NOT SHOWN.





Landscape Consulting & Master Planning Design Sevices

11525 W. North Avenue, Suite 1B Wauwatosa, WI 53226 Tel (414) 476-1204 www.insitedesigninc.com mdavis@insitedesigninc.com

Project:

# **ENTERPRISE MOBILITY**

1060 Lincoln Avenue Waukesa, WI 53186

Issuance and Revisions

Date Number Description	ate	Number	Description
-------------------------	-----	--------	-------------

07/29/24

Plan Commission Submittal


COPYRIGHT InSite Landscape Design Inc. 2020 ALL RIGHTS RESERVED THIS DRAWING IS NOT TO BE REPRODUCED, CHANGED, COPIED OR ASSIGNED TO ANY THIRD PARTY IN ANY FORM OR MANNER WITHOUT FIRST OBTAINING THE EXPRESSED WRITTEN PERMISSION OF InSite Landscape Design, Inc. THE CLIENT AGREES
TO INDEMNIFY AND HOLD THE InSite Landscape Design Inc. HARMLESS FROM ANY DAMAGES, LIABILITY, OR COST, INCLUDING ATTORNEY'S FEES AND COSTS OF DEFENSE ARISING FROM ANY CHANGES OR ALTERATIONS MADE BY ANYONE OTHER THAN THE InSite Landscape Design Inc., OR FROM ANY REUSE OF THE DRAWINGS OR DATA WITHOUT THE PRIOR WRITTEN CONSENT OF THE

InSite Landscape Design Inc.

PROPOSED LANDSCAPE PLAN, GENERAL NOTES, AND PLANT MATERIAL TABLE

Date of Drawing:	07/29/24
Scale:	1" = 20'-0"
Drawn By:	MCD
Job Number:	L24 <b>-</b> 054

Sheet Number:

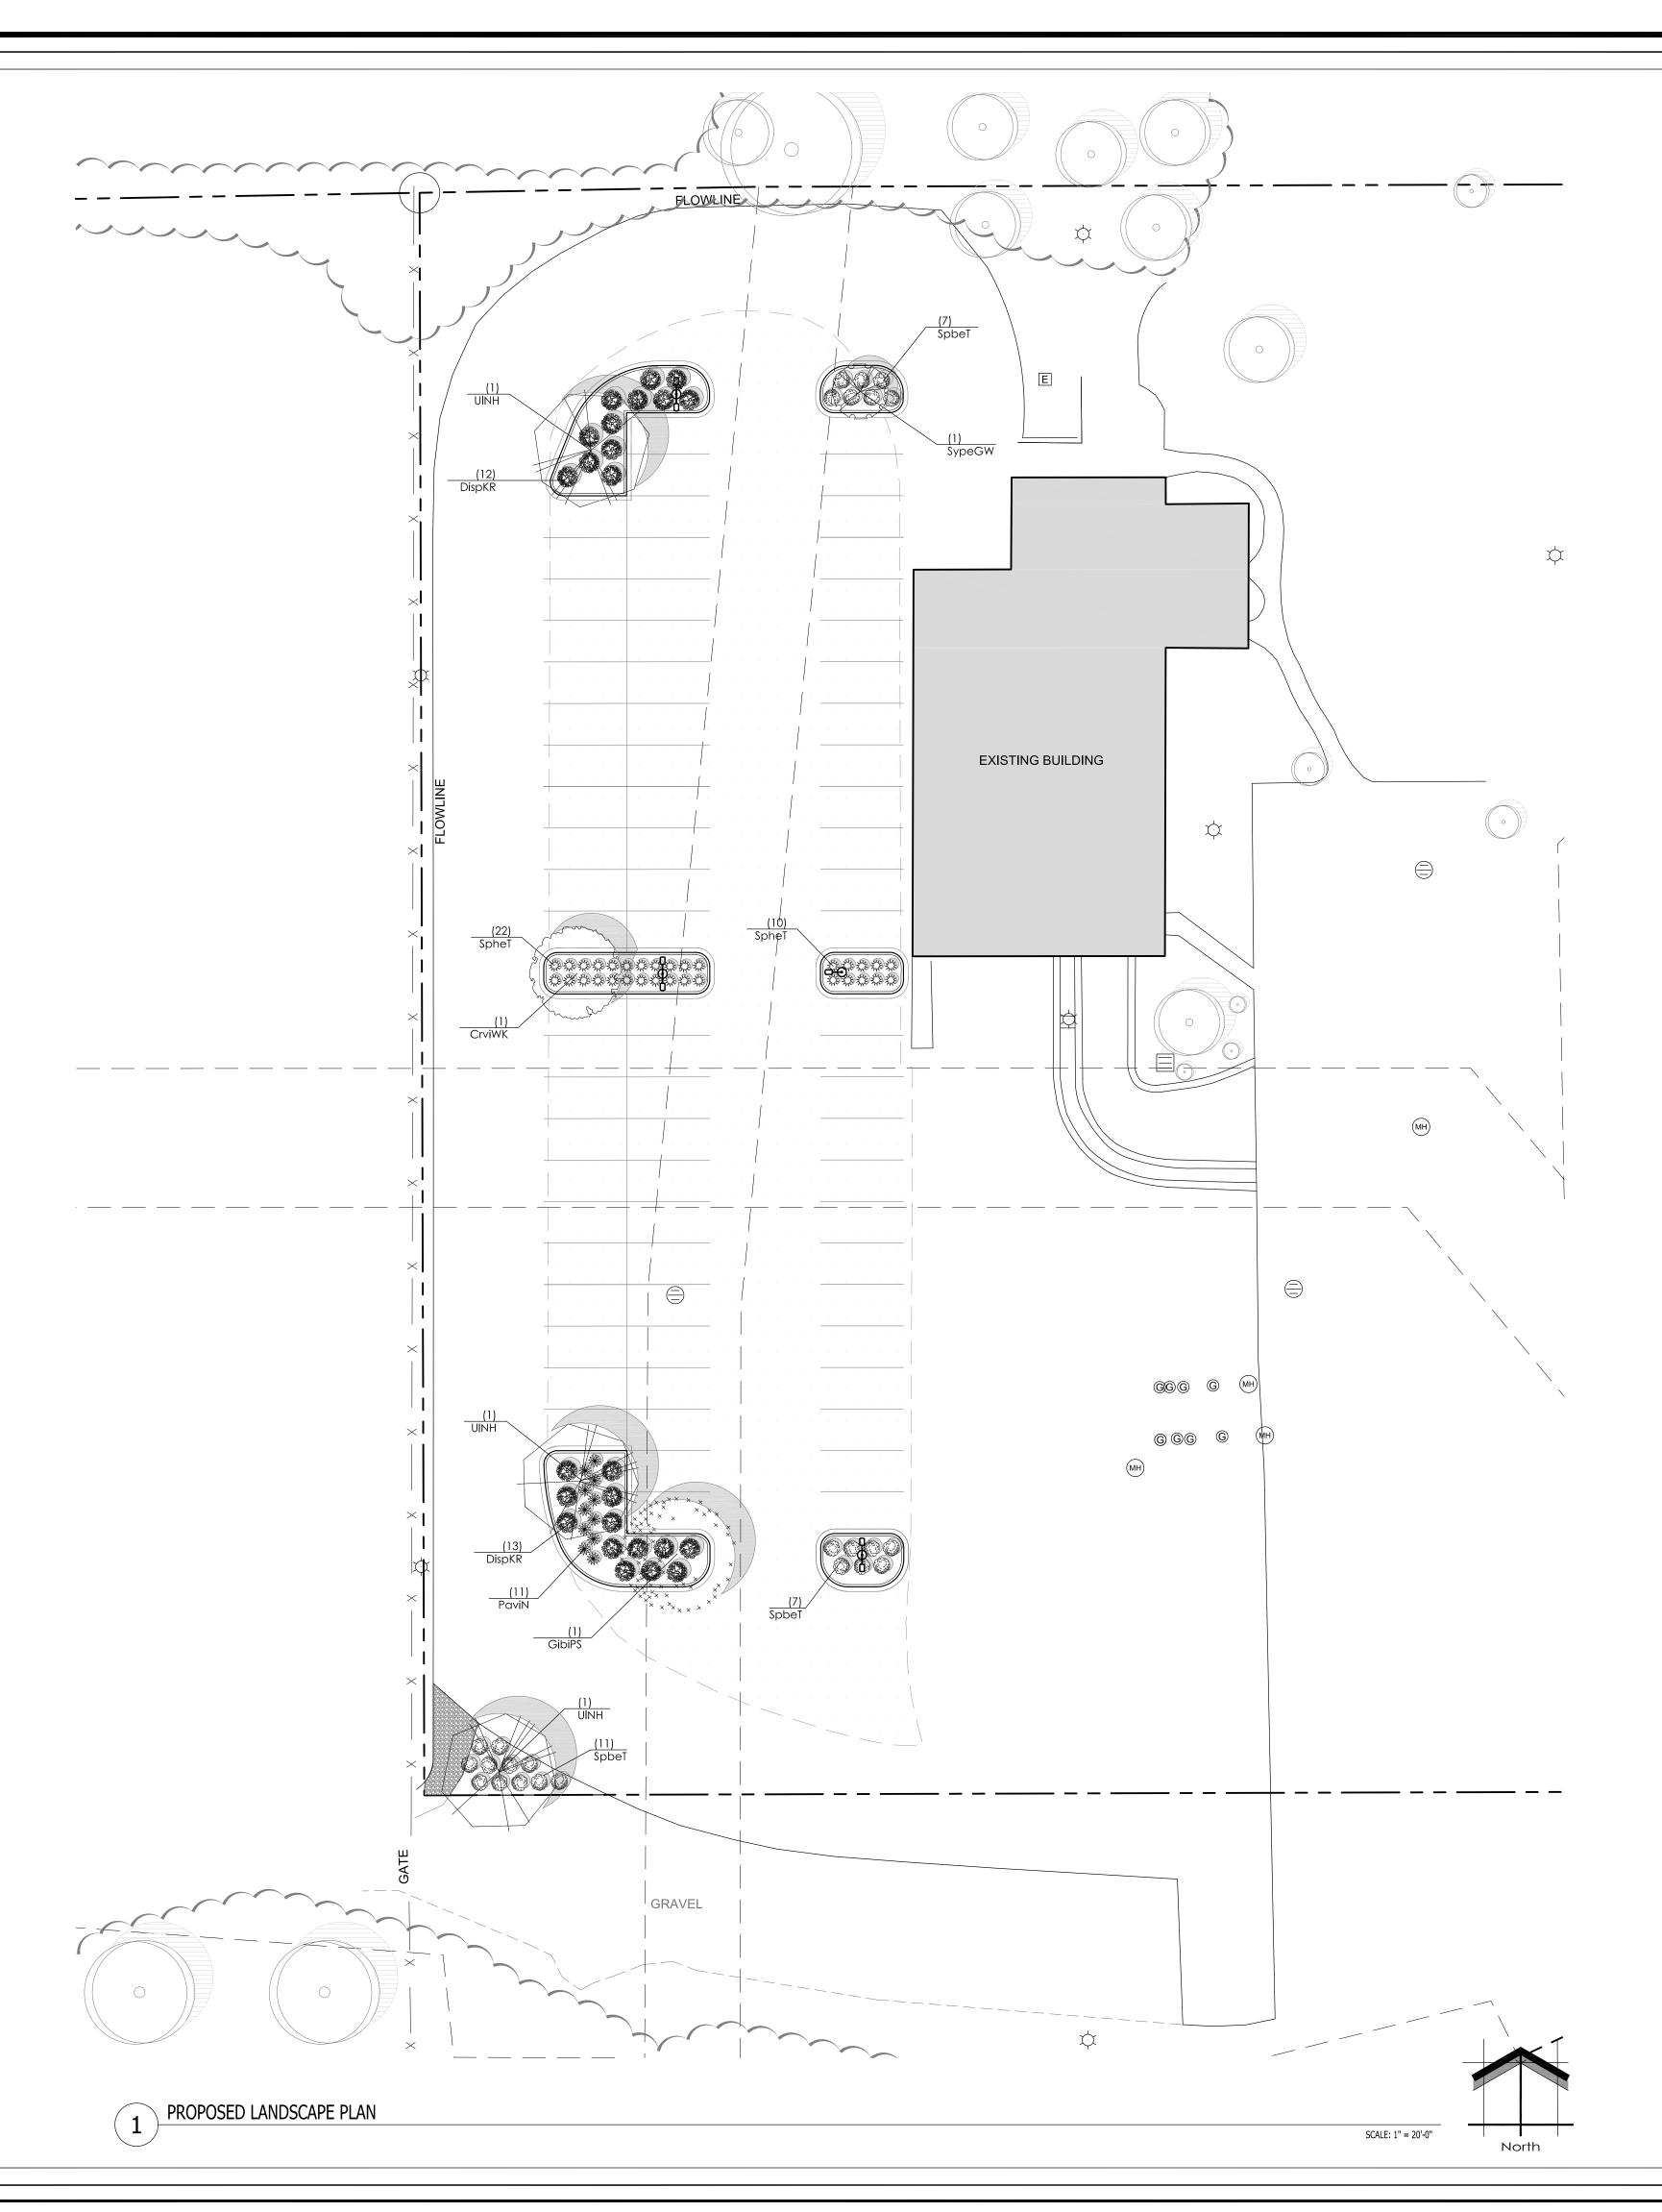

#### Proposed Plant Material Table

Broadleaf De	eciduous Tree					
Quantity	Code Name	Symbol	Scientific Name	Common Name	Planting Size	Comments
1	CrviWK	0	Crataegus viridis 'Winter King'	Winter King Green Hawthorn	2 1/2"-Cal - B&B	1
1	GibiPS	<b>a</b>	Ginko biloba 'Princeton Sentry'	Princeton Sentry Maidenhair Tree	2 1/2"-Cal - B&B	1, 5
1	SypeGW	<b>A</b>	Syringa pekinensis 'Great Wall'	Great Wall Tree Lilac	2 1/2"-Cal - B&B	1
2	UINH	*	Ulmus 'New Horizon'	New Horizon Elm	2 1/2"-Cal - B&B	1
6	Extg	0	Existing to Remain	Existing to Remain	Existing	2

Broadleaf Deciduous Shrub

Quantity	Code Name	Symbol	Scientific Name	Common Name	Planting Size	Comments
25	DispKR	0	Diervilla splendens 'G2X885411'	Kodiak Red Diervilla	18" - Cont	3
20	SpbeT	٨	Spiraea betulifolia 'Tor'	Tor Birchleaf Spirea	18" - Cont	3
Perennial Grass						
			0 1 117 11			

Quantity	Code Name	Symbol	Scientific Name	Common Name	Planting Size	Comments
11	PaviN	*	Panicum virgatum 'Northwind'	Northwind Switch Grass	1-Gal - Cont	4
32	SpheT	ZW.	Sporobolus heterolepis 'Tara'	Tara Prairie Dropseed	1-Gal - Cont	4

### Comments

Straight central leader, full & even crown. Prune only after planting.

- 2. Prune existing tree, remove any dead, diseased or hazardous limbs. Thin out as required and raise canopy for safety and viability for both pedestrians and motorists.

  3. Full, well rooted plant, evenly shaped.
- 4. Full, well rooted plant.
- 5. Male only

LANDSCAPE DESIGN

Landscape Consulting & Master Planning Design Sevices

11525 W. North Avenue, Suite 1B Wauwatosa, WI 53226 Tel (414) 476-1204 www.insitedesigninc.com mdavis@insitedesigninc.com

<u>Project:</u>

# **ENTERPRISE MOBILITY**

1060 Lincoln Avenue Waukesa, WI 53186

Issuance and Revisions:

[	Date	Number	Description
---	------	--------	-------------

07/29/24

Plan Commission Submittal

COPYRIGHT InSite Landscape Design Inc. 2020
ALL RIGHTS RESERVED


THIS DRAWING IS NOT TO BE REPRODUCED,
CHANGED, COPIED OR ASSIGNED TO ANY THIRD
PARTY IN ANY FORM OR MANNER WITHOUT FIRST
OBTAINING THE EXPRESSED WRITTEN PERMISSION
OF InSite Landscape Design, Inc. THE CLIENT AGREES
TO INDEMNIFY AND HOLD THE InSite Landscape
Design Inc. HARMI FSS FROM ANY DAMAGES Design Inc. HARMLESS FROM ANY DAMAGES,
LIABILITY, OR COST, INCLUDING ATTORNEY'S FEES
AND COSTS OF DEFENSE ARISING FROM ANY
CHANGES OR ALTERATIONS MADE BY ANYONE
OTHER THAN THE INSITE Landscape Design Inc., OR
FROM ANY REUSE OF THE DRAWINGS OR DATA
WITHOUT THE PRIOR WAITTEN CONSENT OF THE WITHOUT THE PRIOR WRITTEN CONSENT OF THE InSite Landscape Design Inc.

<u>Sheet Title</u>:

PROPOSED LANDSCAPE PLAN, GENERAL NOTES, AND PLANT MATERIAL TABLE

Date of Drawing:	07/29/2
Scale:	1" = 20'-
Drawn By:	МС
Job Number:	L24 <b>-</b> 05

Sheet Number:

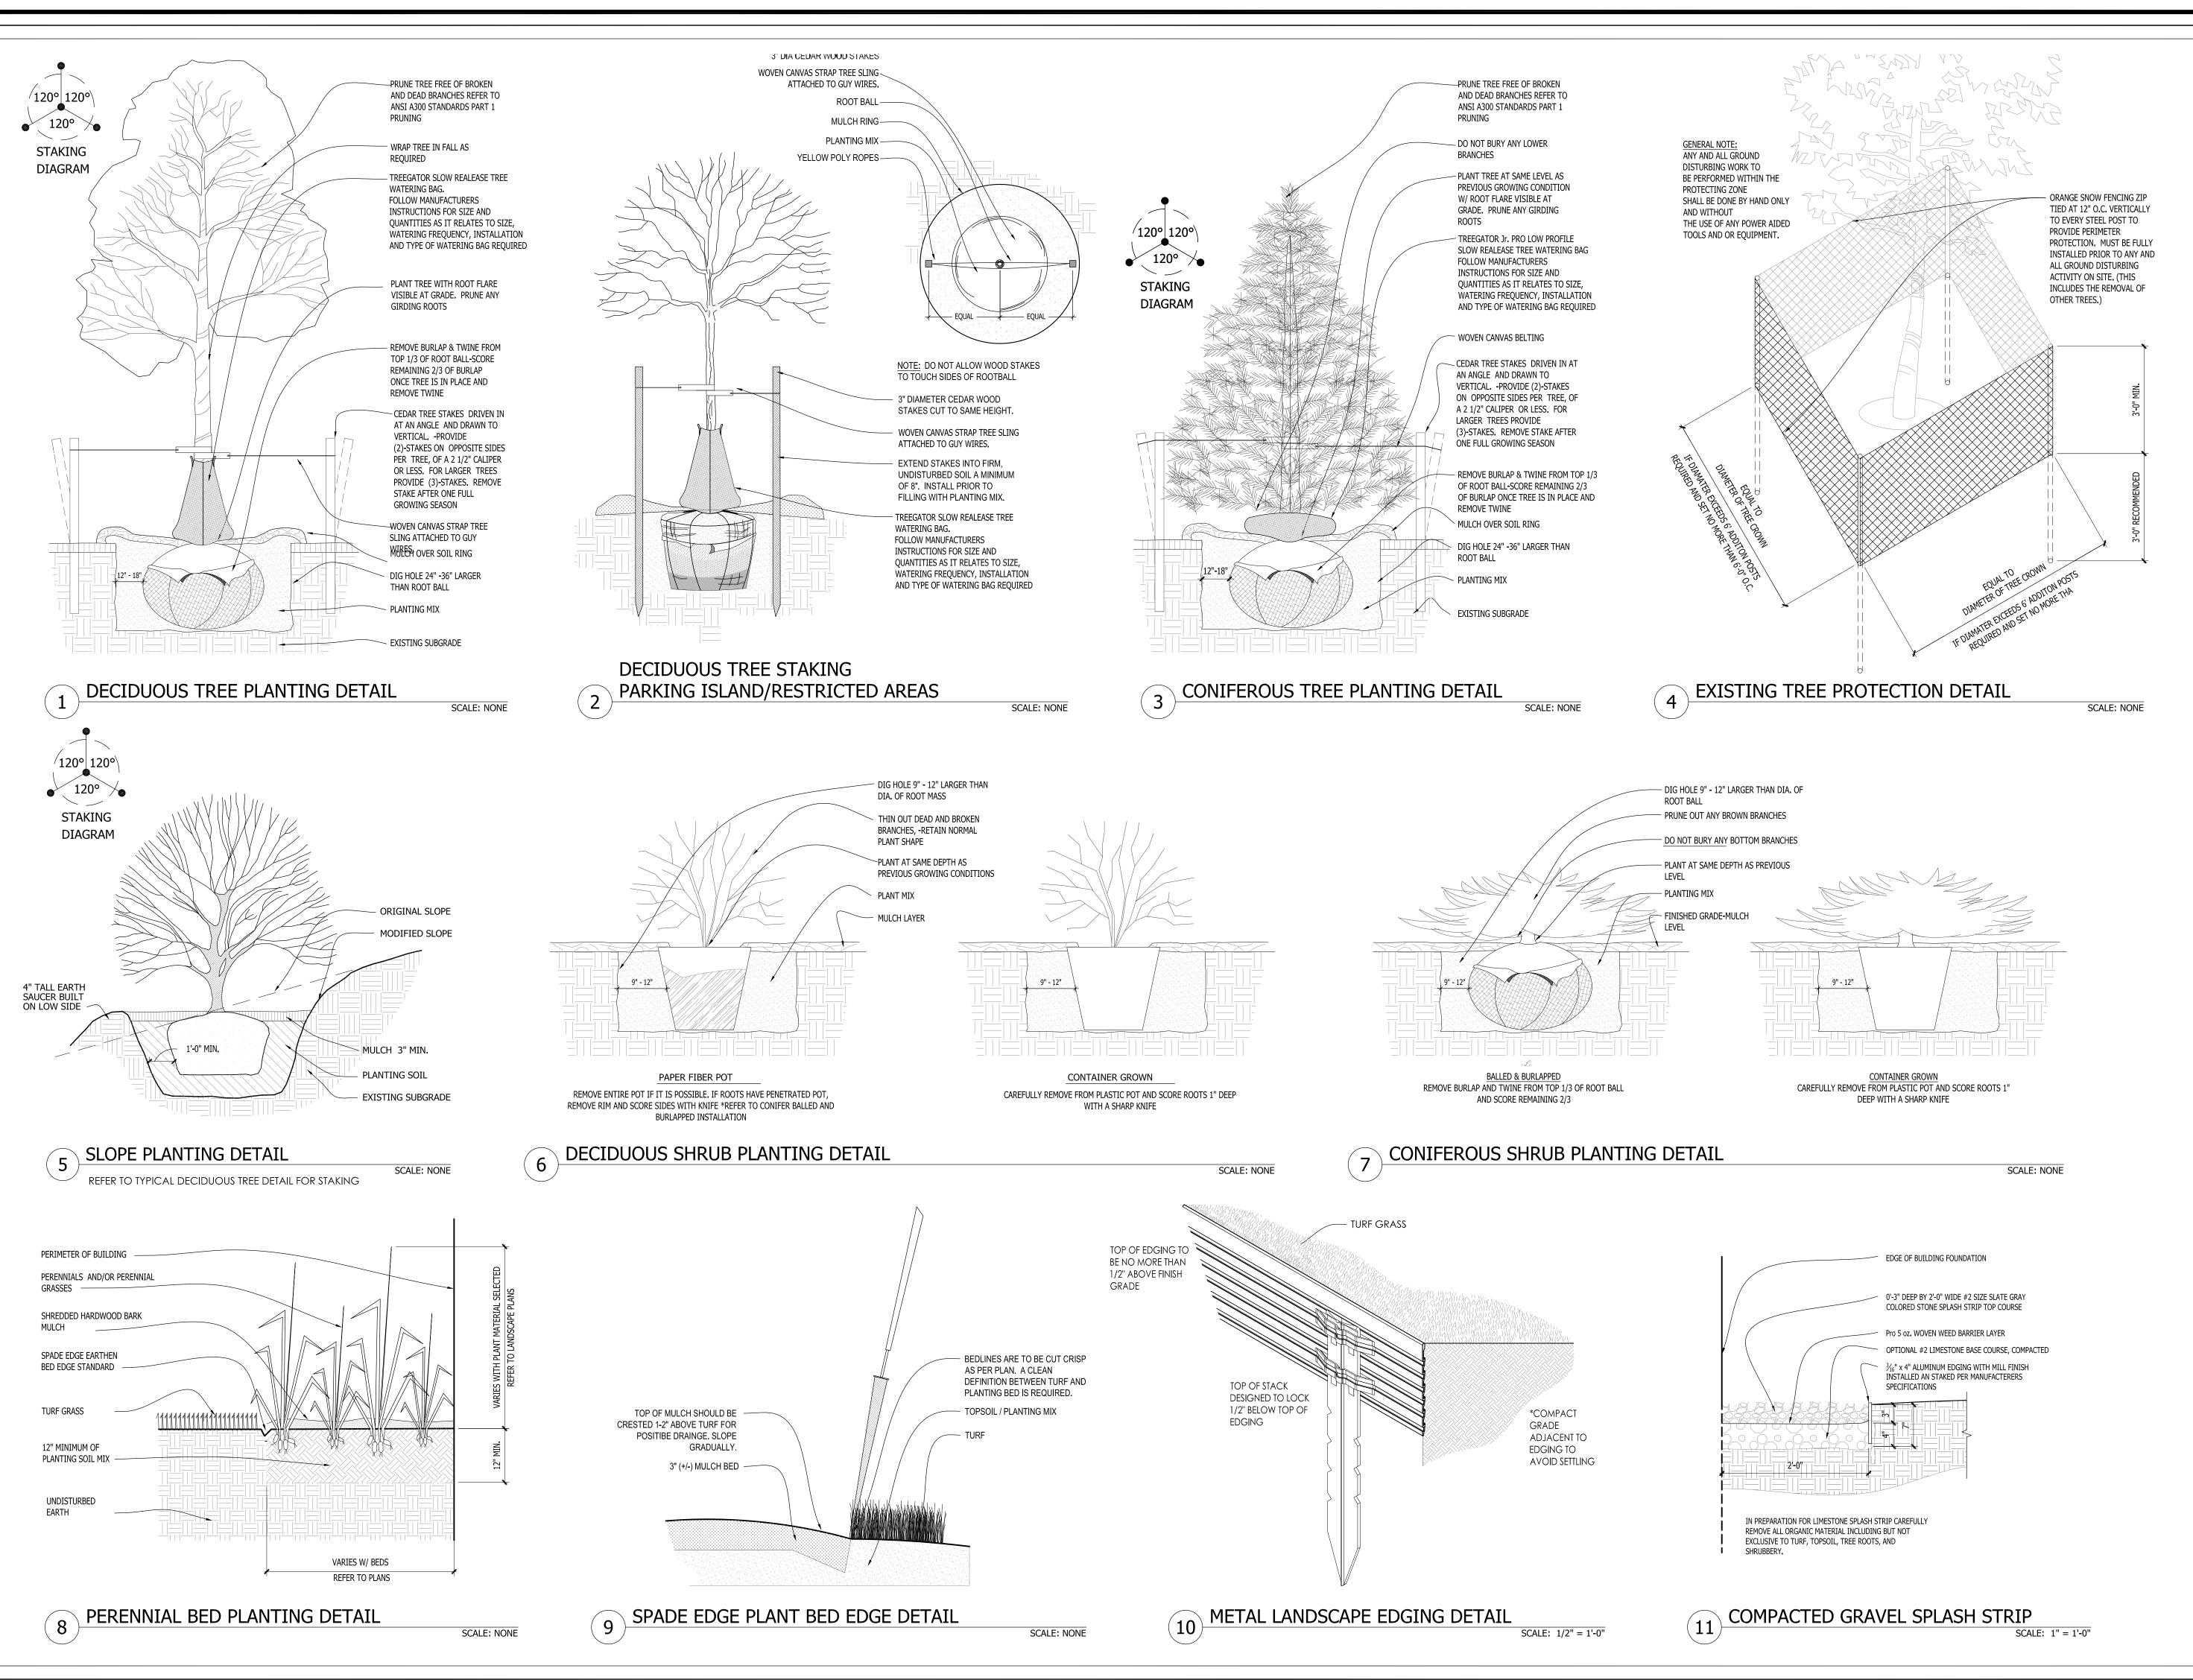

LANDSCAPE

**Landscape Consulting** & Master Planning Design Sevices

11525 W. North Avenue, Suite 1B Wauwatosa, WI 53226 Tel (414) 476-1204 www.insitedesigninc.com mdavis@insitedesigninc.com

<u>Project:</u>

# **ENTERPRISE MOBILITY**

1060 Lincoln Avenue Waukesa, WI 53186

Issuance and Revisions:

| Number | Description

07/29/24

Plan Commission Submittal

COPYRIGHT InSite Landscape Design Inc. 2020 ALL RIGHTS RESERVED Design Inc. HARMLESS FROM ANY DAMAGES,
LIABILITY, OR COST, INCLUDING ATTORNEYS FEES
AND COSTS OF DEFENSE ARISING FROM ANY
CHANGES OR ALTERATIONS MADE BY ANYONE
OTHER THAN THE InSite Landscape Design Inc., OR
FROM ANY REUSE OF THE DRAWINGS OR DATA
WITHOUT THE PRIOR WRITTEN CONSENT OF THE Design Inc. HARMLESS FROM ANY DAMAGES, WITHOUT THE PRIOR WRITTEN CONSENT OF THE InSite Landscape Design Inc

PROPOSED LANDSCAPE PLAN, PLANTING DETAILS

Date of Drawing:	07/29/24
Scale:	As Noted
Drawn By:	MCD
Job Number:	L24-054

Sheet Number:

0.0 0.0 0.0 0.0 0.1 0.4 0.4

₺.0 ₺.0 ₺.1

⁺0.0 ⁺0.1 ⁺0.1

⁺0.0 ⁺0.1 ⁺0.1

0.0 0.0 0.1 0.3 0.6 0.8 1.1

\*\dots 0.0 \dots 0.0 \dots 0.1 \dots 0.3 \dots 0.6 \dots 0.8 \dots

0.0 0.0 0.1 0.3 0.2 0.5 0.6 0.8

†0.0 †0.0 †0.1 †0.1 †0.1 \(\dagge 0.2\dagge 3\)

\*\documents.0 \documents.0 \documents.0 \documents.0 \documents.1 \documents.1 \documents.1

<sup>†</sup>0.0 **†0.0** <sup>†</sup>0.1 <sup>†</sup>0.1 <sup>†</sup>0.1

<sup>†</sup>0.1 <sup>†</sup>0.**0** <sup>†</sup>0.1 <sup>†</sup>0.1 <sup>†</sup>0.1

<sup>†</sup>0.1 <sup>†</sup>0.**0** <sup>†</sup>0.1 <sup>†</sup>0.1 <sup>†</sup>0.1

<sup>†</sup>0.0 <sup>†</sup>0.0 <sup>†</sup>0.1 <sup>†</sup>0.1 <sup>†</sup>0.1

0.0 0.0 0.1 0.3 0.4 0.4 0.5 0.5

⁺0.0

⁺0.0

⁺0.0 **†0.0** †0.1 †0.1

₺.0 ₺.0 ₺.0 ₺.1

0.0 0.0 €

0.0 0.0 €

0.0 0.0 €

₺.0 ₺.0 ₺.1

₹0.0 €0.0 €0.1

<sup>†</sup>0.0 <sup>†</sup>0.1

tol.2 \ \tau.7 \ \tau.8

<sup>†</sup>1.\$ <sup>†</sup>4.0

<sup>†</sup>1.3∖ <sup>†</sup>3.9

<sup>1</sup>1.4 \ 2.5 ×2,β

 $0.7 \setminus 1.2 \quad 1.4 \quad 1.7 / 0.7 \quad 0.9$ 

PROPOSED PHOTOMETRIC LIGHT LEVELS CALCULATIONS PLAI

<sup>†</sup>0.0 <sup>†</sup>0.0 <sup>†</sup>0.1 <sup>†</sup>0.2

0.0 **0.0** 0.1 0.2 0.2

0.0 0.0

\*\dot{0.0} \dot{0.1} \dot{0.1} \dot{0.3} \sqrt{2\*2.5}

0.0 0.0 0.0 0.0 0.1 0.4 0.5 0.7

±0.0 ±0.0 ±0.1 0.25 ±0.5 ±0.6 ±0.49

0.0 0.1 0.1 0.4 2.1 3.8

⁺3.3

<sup>†</sup>1/5 <sup>†</sup>4.8

<sup>†</sup>1.6 \ <sup>†</sup>2.4

<sup>†</sup>1,3 / <sup>†</sup>2.4 <sup>†</sup>3.8

/ <sup>+</sup>1.6/ <sup>+</sup>2.6 <sup>+</sup>4.4 /

<sup>†</sup>2.6 <sup>†</sup>2.5

#4.8 7.7 7.2 6/7 \ 4.3 4.1 \ 2.3 \ 2.4 \ 4.5

4.8 5.3 4.8 5.3 2.6 1.4 1.8 5.6

√<sup>4</sup>.8 <sup>†</sup>2.6

<sup>+</sup>5.5 <del>8.2 <sup>+</sup>7.6</del> <sup>+</sup>7.1

 1 | 5 |
 2.6
 4.7
 6.4
 10.3
 10.1
 9.5
 6.8
 6.0
 3.7
 3.2
 2.7
 1.6
 1.4
 1.4

2.3 †1.3 †1.4 <u>72.0</u> †2.1 †2.3 †2.7 †2.9 †3.4 †3.3 †3.1 †2.4

2.6 2.8 2.8 3.0 2.9 2.9 3.6 4.0 5.4 5.0 4.7 3.2 2.6 2 1.5 1.0

5.1 3.4 6.2 <del>9.7 **1** 8.3</del> 8.3

0.5 0.5 0.7 0.9 1.3 (2.1 3.8 4.4

1.0 1.5 - 1.6 \_ 1.7

EXISTING BUILDING

ზ.8 ზ.7 ზ.6

₩G GG0.6G

5.1 5.4 4.1 4.8 3.6 2.1

⁺0.9

SCALE: 1" = 20'-0"

North

1<sup>2</sup>5.0 <sup>+</sup>3.8

<sup>†</sup>2.9 \ <sup>†</sup>7.7 <sup>†</sup>11.0 <sup>†</sup>11.7 <sup>†</sup>9.4

9.2 🗖 7.9

3.8 4.6 5.0 5.3 4.7 4.0 3.5 2.6 2.1 1.3

 $B^{\dagger}12.0$  9.7 5.5 3.3 2.4 (1.9) 1.6 1.3 1.1 0.8

 9.1
 8.2
 7.0
 4.7
 3.4
 2.6
 2.1

 $\sqrt{0.25}$  \ \frac{7.1}{10.0} \ \frac{12.0}{12.0} \ \frac{9.6}{5.4} \ \frac{15.4}{3.1} \ \frac{12.1}{1.8} \ \frac{1}{1.6} \ \frac{1}{1.4} \ \frac{1}{1.2} \ \frac{1}{10.9}

71.0 3.6 612 9.8 9.2 6.6 3.8 2.6 2.6 1.7 1.4 1.2

40 = 5.4 6.0 6.4 4.9 4.0 3.4 2.6

⁺1.5

<sup>t</sup>1.0

<sup>†</sup>7.2 <sup>†</sup>6.2

<sup>†</sup>12.1 <sup>†</sup>9.1

<sup>†</sup>12.1 <sup>†</sup>9.5

√5.7 <sup>†</sup>6.4 <u>†</u>8.3

े√1.3 `

0.3 0.3 0.3 0.4 0.4 0.4 0.3 0.5 0.5 0.5 0.6 0.7


⁺3.7

\*\dot 0.3 \quad \tau 0.2 \quad \tau 0.3 \quad \tau 0.3 \quad \tau 0.2 \quad \tau 0.3 \quad \tau 0.4 \quad \tau 0.4 \quad \tau 0.5 \quad \tau 0.8 \quad \quad \tau 1.3 \quad \tau 1.9 \quad \quad \tau 2.6 \quad \quad \tau 2.9 \quad \quad \tau 3.6 \quad \quad \tau 2.9 \quad \quad \quad \tau 3.6 \quad \quad \quad \tau 2.9 \quad \quad \quad \tau 3.6 \quad \qquad \quad \

1\6 3.8 3<sub>1</sub>6 \frac{14}{2} 3.0 4.5 \ 5.8 7.0 \ 5.9 5\3 3.7 2\7.7 2 1.6 1.0

<sup>1</sup>2.5 <sup>1</sup>4.0 √5.0 <sup>1</sup>7.0 <sup>1</sup>6.3 √6.0 √4.2 <sup>1</sup>3.4

<sup>†</sup>6.7 <sup>\*</sup>10.9 | <sup>†</sup>10.6**□** <sup>†</sup>9.4 <sup>†</sup>6.0 •

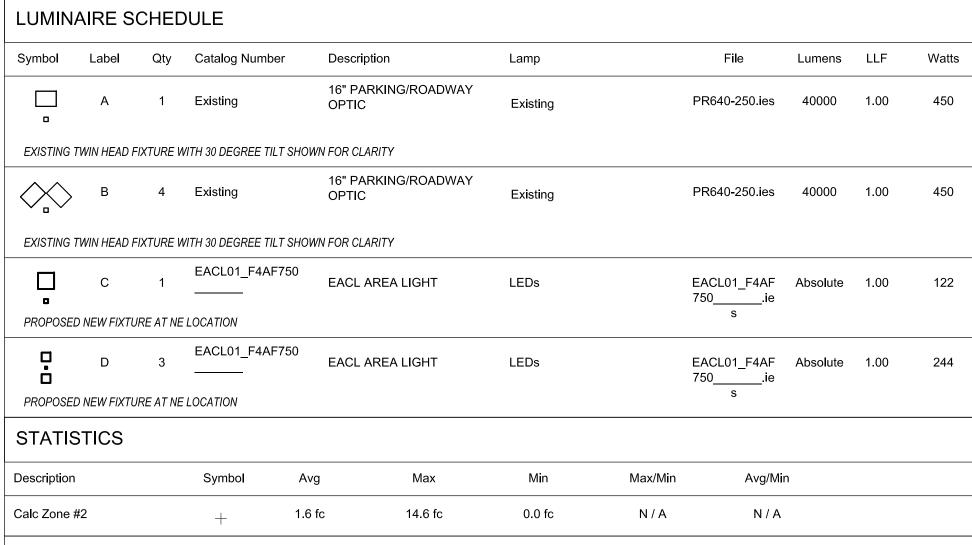

## LUMINAIRE NOTES

- FIXTURE "A" (1) IS AN EXISTING SINGLE HEAD POLE AND CONCRETE FOUNDATION TO REMAIN AND IS SHOWN FOR CLARITY
- FIXTURE "B" (3) IS AN EXISTING TWIN HEAD POLE (TILTED HEAD AT APPROX 35 DEGREES FACING INWARD) AND CONCRETE FOUNDATION TO REMAIN AND IS SHOWN FOR CLARITY.
- FIXTURE "C" (1) IS A NEW LOCATION W/ NEW POLE MOUNTED FIXTURE (SINGLE HEAD AND TENON ). FIXTURES ARE TO BE INSTALLED ON A NEW 2'-6" TALL REINFORCED POURED CONCRETE FOUNDATION (FIELD VERIFY FOUNDATION HEIGHT TO MATCH EXISTING) AND NEW 20'-0" SQUARE DARK BRONZE POLE (FIELD VERIFY POLE HIEGHT AND COLOR TO MATCH EXISTING) FIXTURE "D" (1) IS A NEW LOCATION W/ NEW POLE MOUNTED FIXTURES (TWIN HEAD AND TENONS AT 180 DEGREES). FIXTURES ARE TO BE INSTALLED ON A NEW 2'-6" TALL REINFORCED POURED CONCRETE FOUNDATION
- ALL PROPOSED FIXTURE HEADS ARE TO BE DARK-SKY COMPLIANT AND HAVE HARDWARE WITH IESNA FULL CUTOFF HOUSE SIDE SHIELDING WHERE REQUIRED. NEW PROPOSED POLE MOUNTED FIXTURES (HEADS AND
- TENONS) FINISH IS TO MATCH EXISTING W/ OPTIONAL PHOTOCELL CONTROL ALL NEW CONCRETE LIGHT POLE BASES ARE TO HAVE ALL EXPOSED FORM MARKS REMOVED, GROUND FLUSH AND THE SURFACE IS TO BE PROPERLY PREPARED TO RECEIVE A HAND TROWELED, MASONRY SKIM COAT O
- APPROPRIATE THICKNESS TO ACHIEVE A DURABLE SURFACE AND LONG LASTING AESTHETIC.
- ALL NEW PROPOSED AREA LIGHT POLES SHALL BE LOCATED 3-0" FROM BACK OF CURB TO THE EDGE OR FACE OF THE REINFORCED LIGHT POLE BASE, UNLESS NOTED OTHERWISE.
- INSTALLATION CONTRACTOR TO REFER TO ELECTRICAL PLANS FOR CONDUIT ROUTING OF LIGHT POLES AND SIGNAGE LIGHTING CONTROL AND WIRING. CONTRACTOR TO REFER TO REINFORCED LIGHT POLE BASE SECTION AND DETAIL FOR FURTHER INFORMATION.
- PROPOSED POLE MOUNTED FIXTURES (HEADS AND TENONS) ARE TO HAVE A DARK BRONZE POLE (FIELD VERIFY POLE HIEGHT AND COLOR TO MATCH EXISTING) W/ OPTIONAL PHOTOCELL CONTROL. ALL NEW EXTERIOR FIXTURES, BOTH BUILDING MOUNTED AND POLE FIXTURES SHALL BE DESIGNED AND INSTALLED SUCH THE THE LIGHT EMITTED FROM THE LUMINARE AT AN ANGLE OF 90 DEGREES FROM VERTICAL (OR
- MORE) AND NO LIGHT SHALL TRESSPASS ACROSS PARCEL BOUNDARIES INTO ADJACENT LOST, BUILDINGS OR STREETS IN EXCESS OF 1.0 FOOT CANDLE OR GREATER.
- ALL NEW BUILDING MOUNTED LIGHT FIXTURES ARE TO BE COORDINATED WITH THE ARCHITECTURAL ELEVATIONS FOR EXACT MOUNTING HEIGHTS AND LOCATIONS
- FOR PURPOSES OF CALCULATING THE SITE POLE LIGHTING AND PHOTOMETRIC OUTPUT LUMINAIRE WERE PLACED AT 22'-0" ABOVE FINISHED FLOOR ELEVATION


CONTROLLED CONDITIONS IN ACCORDANCE WITH THE ILLUMINATING ENGINEERING SOCIETY (IES) APPROVED METHODS. ACTUAL PERFORMANCE OF ANY MANUFACTURER'S LUMINAIRES MAY VARY DUE TO CHANGES IN ELECTRICAL VOLTAGE, TOLERANCE IN LAMPS/LED'S AND OTHER MAY VARY DUE TO CHANGES IN ELECTRICAL VOLTAGE, TOLERANCE IN LAMPS/LED'S AND OTHER VARIABLE FIELD CONDITIONS, CALCULATIONS DO NOT INCLUDE OBSTRUCTIONS SUCH AS BUILDINGS CURBS, LANDSCAPING, OR ANY OTHER ARCHITECTURAL ELEMENTS UNLESS NOTED

## PHOTOMETRIC PLAN GENERAL NOTES

- 1. BASED ON THE INFORMATION PROVIDED, ALL DIMENSIONS AND LUMINAIRE LOCATIONS SHOWN REPRESENT RECOMMENDED POLE PLACEMENTS AND LUMINAIRE ORIENTATION. THE ENGINEER AND/OR
- 2. THE DEPICTED ILLUMINATION RESULTS ARE BASED UPON ILLUMINATION MEASUREMENTS AS CALCULATED BY AN INDEPENDENT LABORATORY. LUMINAIRE CHARACTERISTICAL DATA WAS MEASURED UNDER CONTROLLED CONDITIONS IN ACCORDANCE WITH APPROVED ILLUMINATION ENGINEERING SOCIETY METHODS. ACTUAL ON-SITE PERFORMANCE OF ANY MANUFACTURER'S LUMINAIRES MAY VARY FROM
- LABORATORY TEST RESULTS DUE TO VARIATIONS IN: ELECTRICAL VOLTAGE, TOLERANCE IN LAMPS, AND OTHER VARIABLE FIELD CONDITIONS. 3. IF EXISTING LUMINAIRES ARE INCLUDED IN THIS REPORT, THEIR ILLUMINATION CHARACTERISTICS ARE BASED UPON A COMBINATION OF CUSTOMER'S PROVIDED SPECIFICATIONS & OUR BEST ESTIMATION.
- 4. ALL EXISTING AND NEW CONCRETE LIGHT POLE BASES ARE TO HAVE ALL FORM MARKS REMOVED, GROUND FLUSH AND THE SURFACE IS TO BE PROPERLY PREPARED TO RECEIVE A HAND TROWELED,
- MASONRY SKIM COAT OF APPROPRIATE THICKNESS TO ACHIEVE A DURABLE SURFACE AND LONG LASTING AESTHETIC.

## EXISTING CONDITIONS GENERAL NOTES

- 1. INFORMATION PERTAINING TO EXISTING CONDITIONS GIVEN ON THESE ARCHITECTURAL DRAWINGS REPRESENTS TO THE BEST OF OUR KNOWLEDGE THE ACTUAL EXISTING FIELD CONDITIONS, INSITE LANDSCAPE DESIGN, INC. MAKES NO WARRANTY AS TO THEIR ACCURACY. CONTRACTOR TO FIELD VERIFY EXISTING CONDITIONS IMPERATIVE TO THEIR NEW WORK. REPORT ANY DISCREPANCIES BETWEEN THE DRAWINGS AND FIELD CONDITIONS TO THE LANDSCAPE ARCHITECT FOR REVIEW. ANY WORK PERFORMED PRIOR TO RESOLUTION OF DISCREPANCIES BY THE LANDSCAPE ARCHITECT IS SUBJECT TO REMOVAL AND REPLACEMENT AT NO ADDITIONAL COST TO THE CONTRACT.
- 2. VERIFY LOCATION OF ALL EXISTING UNDERGROUND UTILITIES I.E. WATER, SEWER, ELECTRICAL, TELECOMUNICATION AND ACCESS PANELS FOR ALL UTLITIES AND ALL ASSOCIATED EQUIPMENT FOR ACCESSIBILITY OF THOSE ITEMS.
- 3. VERIFY ALL EXISTING CONDITIONS, DIMENSIONS, AND ALIGNMENT OF WALLS. BRING ANY DISCREPANCIES TO THE LANDSCAPE ARCHITECTS ATTENTION PRIOR TO FABRICATION / CONSTRUCTION BEGINS.

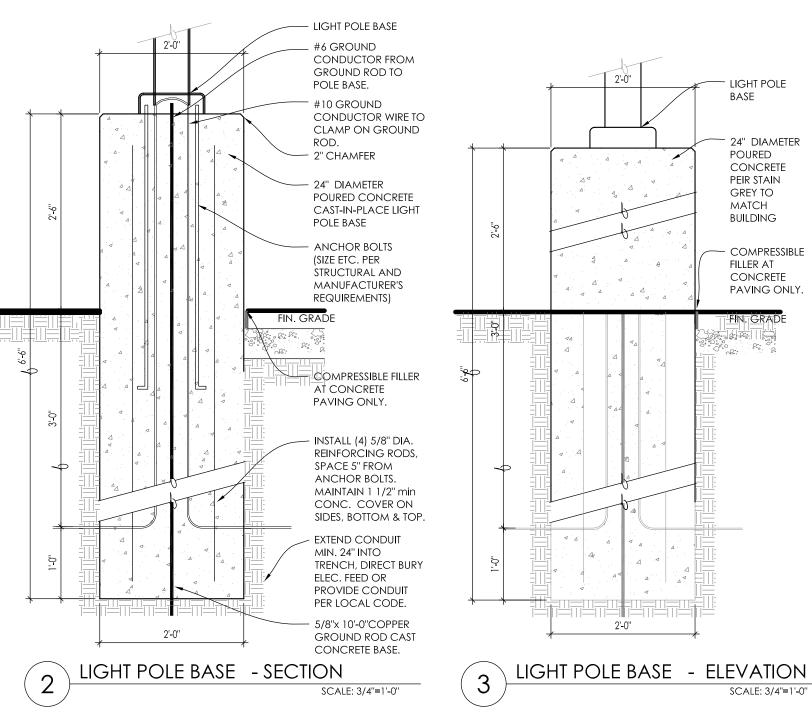



Landscape Consulting & Master Planning Design Sevices

11525 W. North Avenue, Suite 1B Wauwatosa, WI 53226 Tel (414) 476-1204 www.insitedesigninc.com mdavis@insitedesigninc.com

<u>Project:</u>

## **ENTERPRISE MOBILITY**

1060 Lincoln Avenue Waukesa, WI 53186

Issuance and Revisions:

|Number | Description

07/29/24

Plan Commission Submittal

COPYRIGHT InSite Landscape Design Inc. 2020 ALL RIGHTS RESERVED THIS DRAWING IS NOT TO BE REPRODUCED, CHANGED, COPIED OR ASSIGNED TO ANY THIRD PARTY IN ANY FORM OR MANNER WITHOUT FIRST OBTAINING THE EXPRESSED WRITTEN PERMISSION OBTAINING THE EXPRESSED WALLTEN AGREES
OF InSite Landscape Design, Inc. THE CLIENT AGREES
TO INDEMNIFY AND HOLD THE InSite Landscape Design Inc. HARMLESS FROM ANY DAMAGES, LIABILITY, OR COST, INCLUDING ATTORNEYS FEES AND COSTS OF DEFENSE ARISING FROM ANY CHANGES OR ALTERATIONS MADE BY ANYONE OTHER THAN THE InSite Landscape Design Inc., OR FROM ANY REUSE OF THE DRAWINGS OR DATA

Sheet Title:

PROPOSED PHOTOMETRIC LIGHT LEVEL CALCULATIONS PLAN, GENERAL NOTES, AND LIGHT FIXTURE TABLE

InSite Landscape Design Inc.

Date of Drawing:	07/29/24
Scale:	1" = 20'-0"
Drawn By:	MCD
Job Number:	L24-054

Sheet Number:

WITHOUT THE PRIOR WRITTEN CONSENT OF THE

10kV/5kA\*

GE EVOLVE EACL SERIES AREA LUMINARIES

Warranty

5 Year (Standard)


\*Per ANSI C136.2-2015


6kV/3kA\*

EVOLVE

Current @

Current @

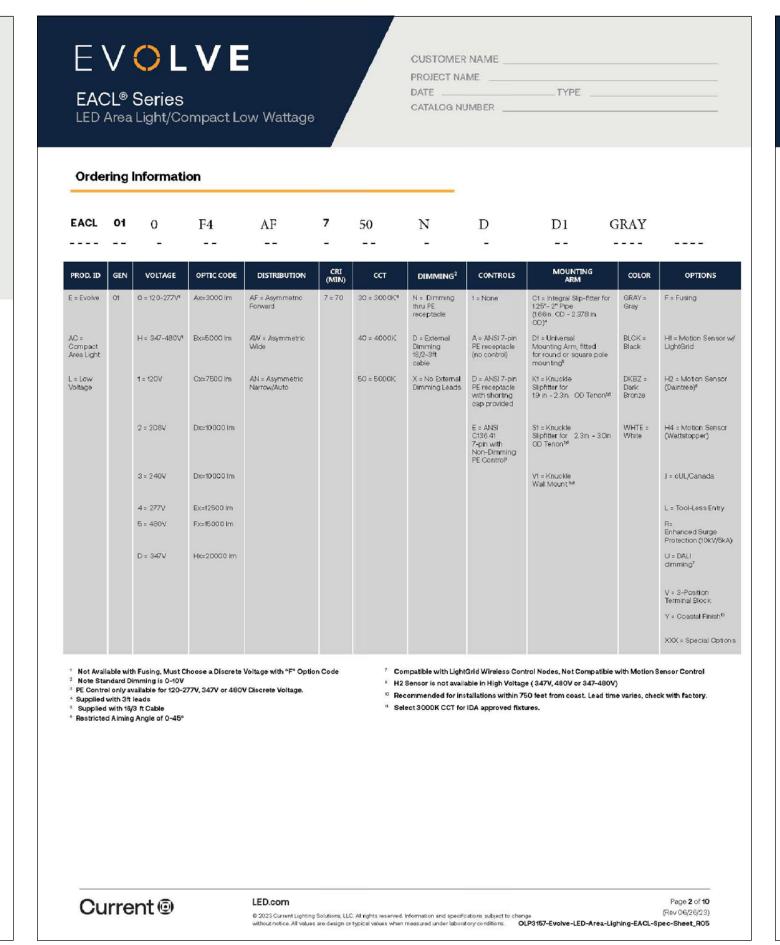

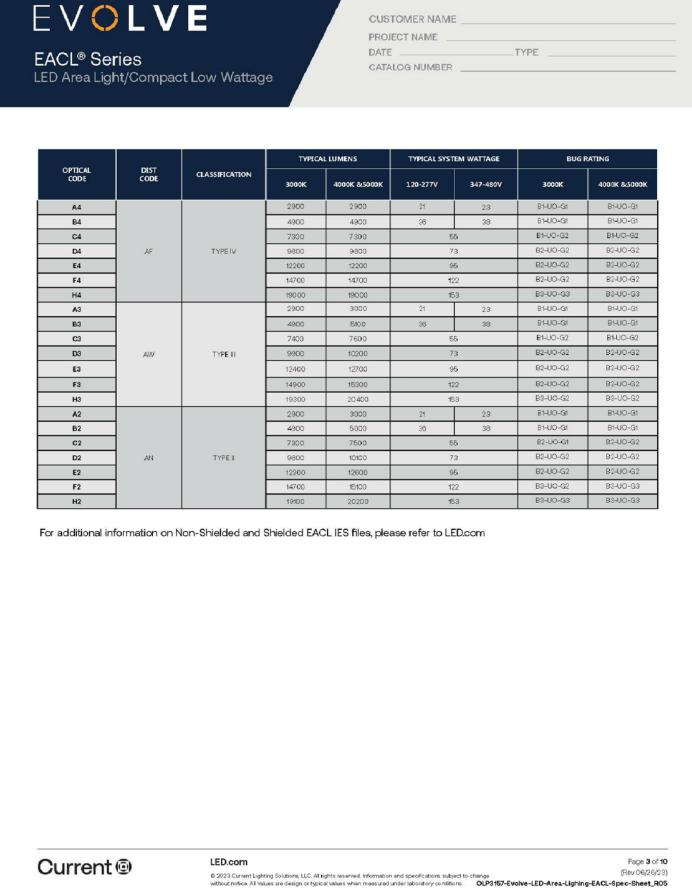



© 2023 Current Lighting Solutions, LtC. All rights reserved. Information and specifications subject to change without notice. All values are design or typical values when measured under laboratory conditions.

OLP3157-Evolve-LED-Area-Lighing-EACL-Spec-Sheet\_R05

Project Name

5.5 4" square 0.125" 9" 8"-10" 5.66"-7.07" 9" 3/4"x30"x

 20
 6.1
 5" square
 .188"
 11"
 10.25"-13.25"
 7.25"-9.37"
 11.50"
 1"x36"x4"
 4.5
 26

 25
 7.6
 5" square
 .188"
 11"
 10.25"-13.25"
 7.25"-9.37"
 11.50"
 1"x36"x4"
 4.5
 32

30 9.1 5" square .1.88" 11" 10.25"-13.25" 7.25"-9.37" 11.50" 1"x36"x4" 4.5 387

25 7.6 5"square 2.5" 11" 10.25"-13.25" 7.25"-9.37" 11.50" 1"x36"x4" 4.5 427

20 6.1 6" square .1.88" 12" 11.00"-13.25" 7.81"-9.37" 12.25" 1"x36"x4" 5.0 329

VIBRATION DAMPER 2ND

ry installed, internal damper ned to alter pole resonance to e movement and material fatigu d by 2nd mode vibration.

OPTION ORIENTATION

Bolt C

VIBRATION DAMPER

30 9.1 5"square .25" 11" 10.25"-13.25" 7.25"-9.37" 11.50" 1"x36"x4" 4.5 50

GE EVOLVE EACL SERIES LUMINARIES SHEILDING

Current @

EVOLVE





**MOBILITY** 

1060 Lincoln Avenue Waukesa, WI 53186

Issuance and Revisions:

|Number | Description

Plan Commission Submittal

**NOT SCALE** nould not be used for

COPYRIGHT InSite Landscape Design Inc. 2020 ALL RIGHTS RESERVED THIS DRAWING IS NOT TO BE REPRODUCED, CHANGED, COPIED OR ASSIGNED TO ANY THIRD PARTY IN ANY FORM OR MANNER WITHOUT FIRST OBTAINING THE EXPRESSED WRITTEN PERMISSION OF InSite Landscape Design, Inc. THE CLIENT AGREES TO INDEMNIFY AND HOLD THE InSite Landscape

OTHER THAN THE InSite Landscape Design Inc., OR FROM ANY REUSE OF THE DRAWINGS OR DATA WITHOUT THE PRIOR WRITTEN CONSENT OF THE InSite Landscape Design Inc.

Design Inc. HARMLESS FROM ANY DAMAGES, LIABILITY, OR COST, INCLUDING ATTORNEY'S FEES

AND COSTS OF DEFENSE ARISING FROM ANY


CHANGES OR ALTERATIONS MADE BY ANYONE

Sheet Title:

PROPOSED LIGHT FIXTURES

Date of Drawing:	07/29/24
Scale:	NONE
Drawn By:	MCD
Job Number:	L24-054


Sheet Number:

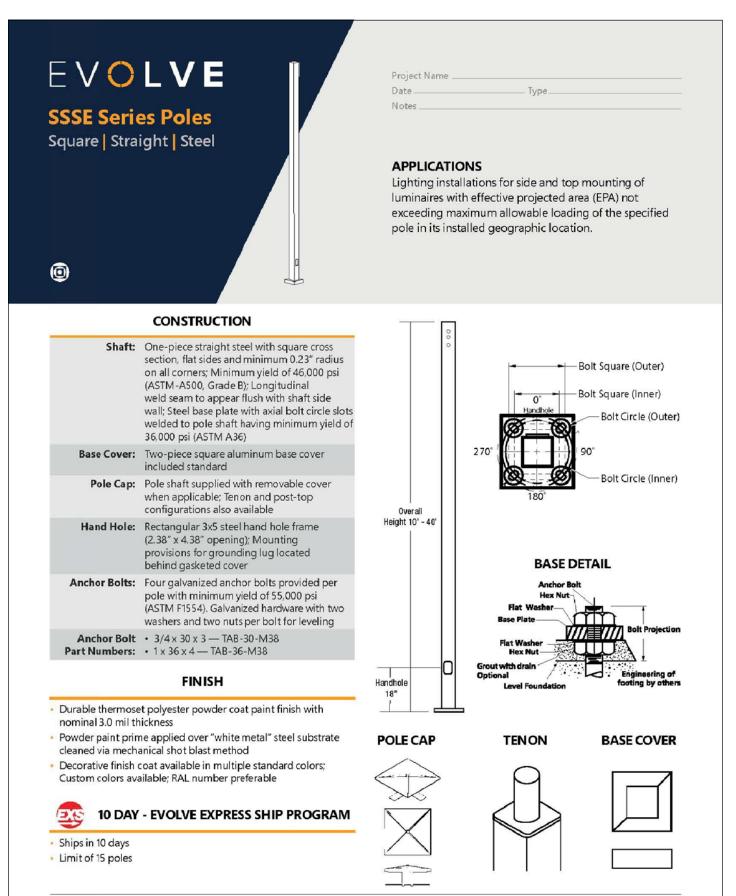



gecurrent.com/evolve


GE EVOLVE SSSE SERIES POLES

notice. All values are design or typical values when measured under laboratory conditions.

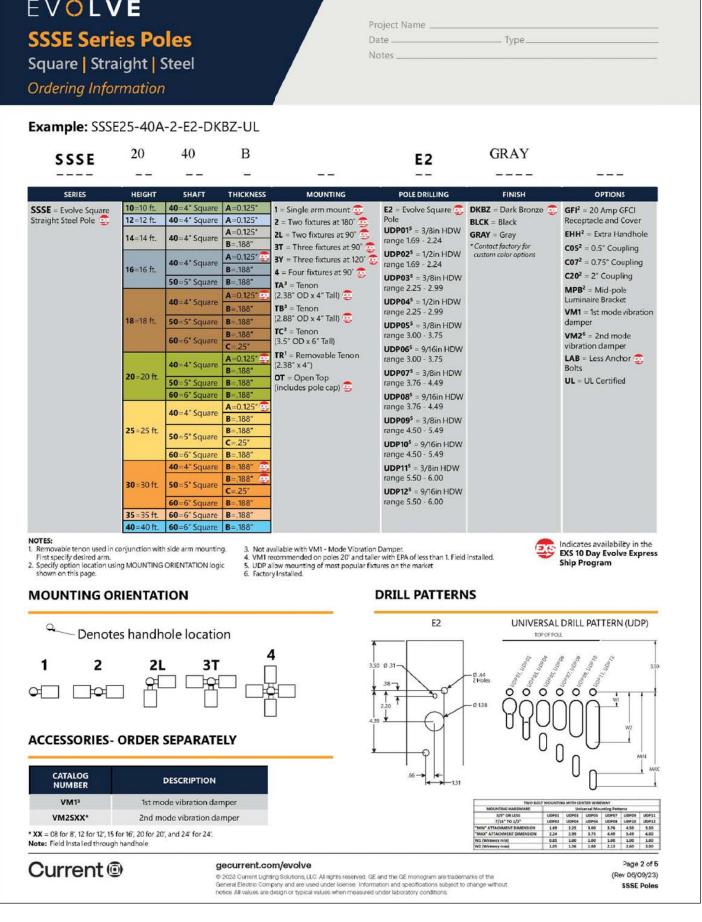

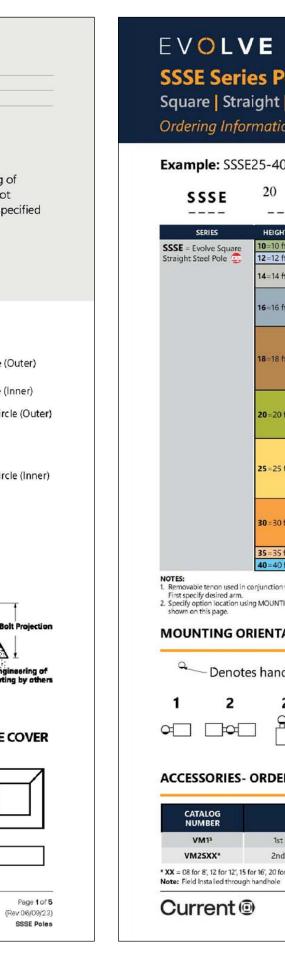

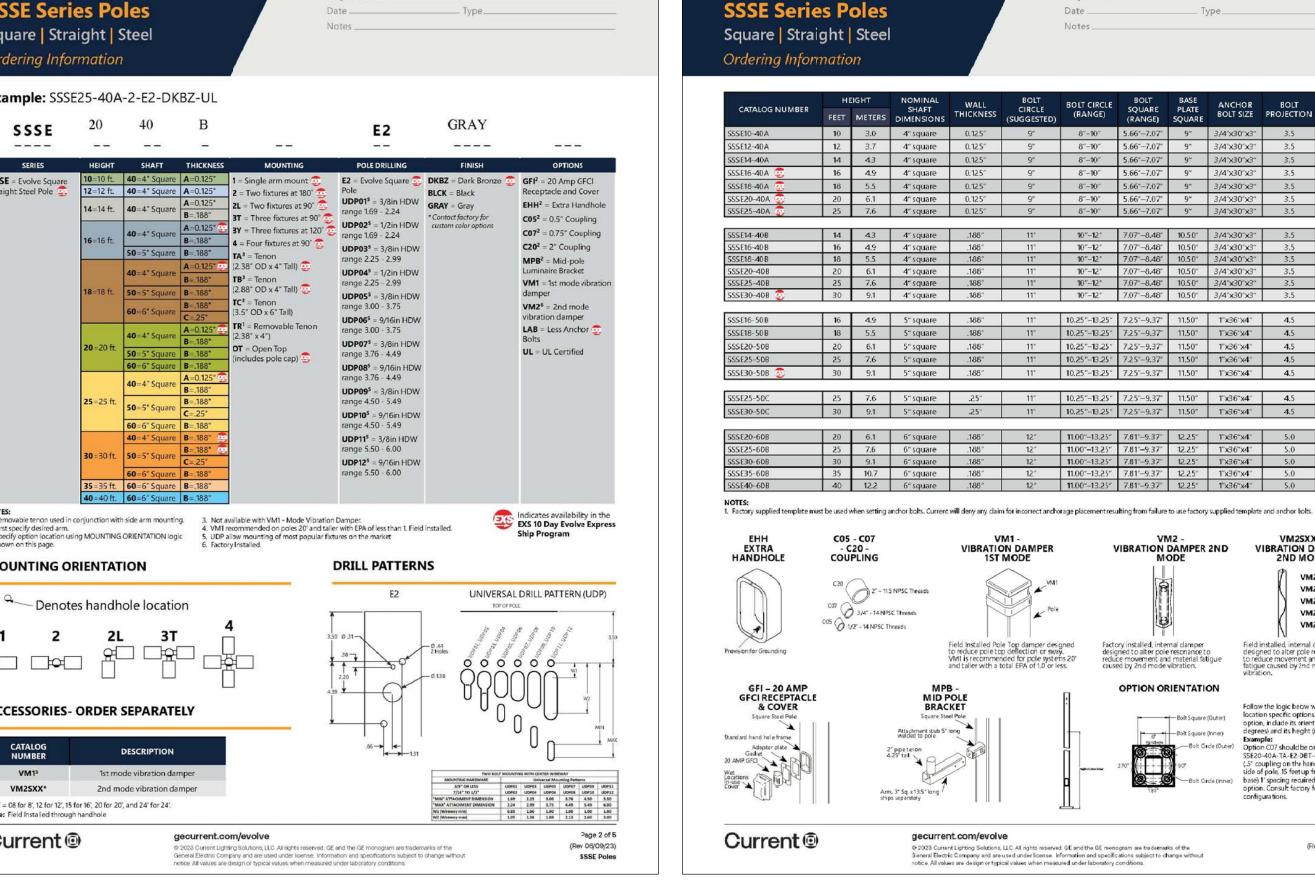

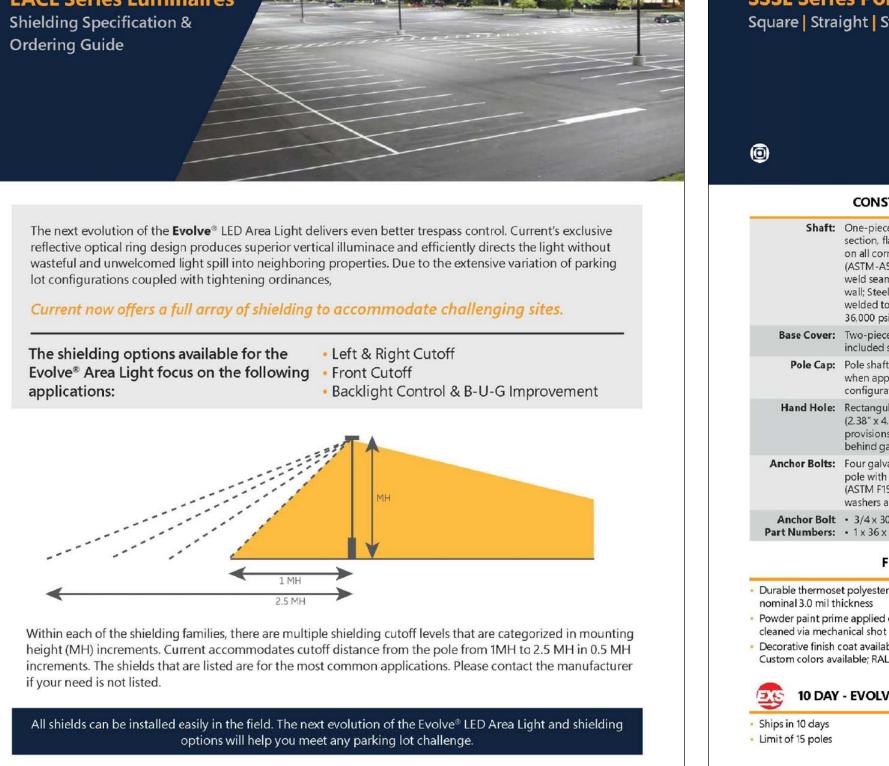

Page 1 of 2

(Rev 04/26/23)

OLP3207-Evolve-EACL-Series-Area-Light-Shielding\_R01

Current @

Not all product variations listed on this page are DLC qualified

© 2023 Current Lighting Solutions, LLC. All rights reserved. Information and specifications subject to change without notice. All values are dealan or typical values when measured under laboratory conditions.

OLP3157-Evolve-LED-Area-Lighing-EACL-Spec-Sheet\_R05





UNDERGROUND SEWER AND UTILITY INFORMATION TO OBTAIN LOCATION OF AS SHOWN IS OBTAINED FROM THE RECORDS OF MUNICIPALITY AND LOCAL UTILITY COMPANIES. THE ACCURACY OF WHICH CAN NOT BE GUARANTEED OR CERTIFIED TO. THE LOCATIONS CALL THE MILWAUKEE UTILITY OF EXISTING UTILITY INSTALLATIONS AS SHOWN ON

WITHIN THE PROJECT AREA THAT ARE NOT SHOWN.

3/4" - 14 NPSC Threads

MPB -MID POLE BRACKET

gecurrent.com/evolve

Attachment stub 5" long welded to pole

COS 1/2" - 14 NPSC Threads

PARTICIPANT'S UNDERGROUND FACILITIES BEFORE YOU DIG IN WISCONIN ALERT NETWORK THIS SURVEY ARE APPROXIMATE. THERE MAY BE www.Diggershotline.com OTHER UNDERGROUND UTILITY INSTALLATIONS <u>(800)-242-8511</u>

ent Lighting Solutions, LLC. All rights reserved. GE and the GE monogram are trademarks of the

notice. All values are design or typical values when measured under laboratory conditions.

Know what's below. Call 811 before you dig.

Page 3 of 5

(Rev 06/09/23)

VIBRATION DAMPER 2ND MODE

Follow the logic below when ordering location specific options. For each option, include its orientation (in degrees) and its height (in feet).

Example:
Option CO7 should be ordered as:

Option CD7 should be ordered as: SSEQ-40A-TA-E2-DBT-CO7-0-15 (.5' coupling on the handhole/arm side of pole, 15 feetup from the pole base) 1' spacing required between option. Consult factory for other configurations.

VM2S08 - 8

VM2S16 - 16

VM2520 - 201 VM2524 - 24