
SITE IMPROVEMENT PLANS FOR

ROLLING MEADOWS TOWN HOMES

CITY OF WAUKESHA, WISCONSIN

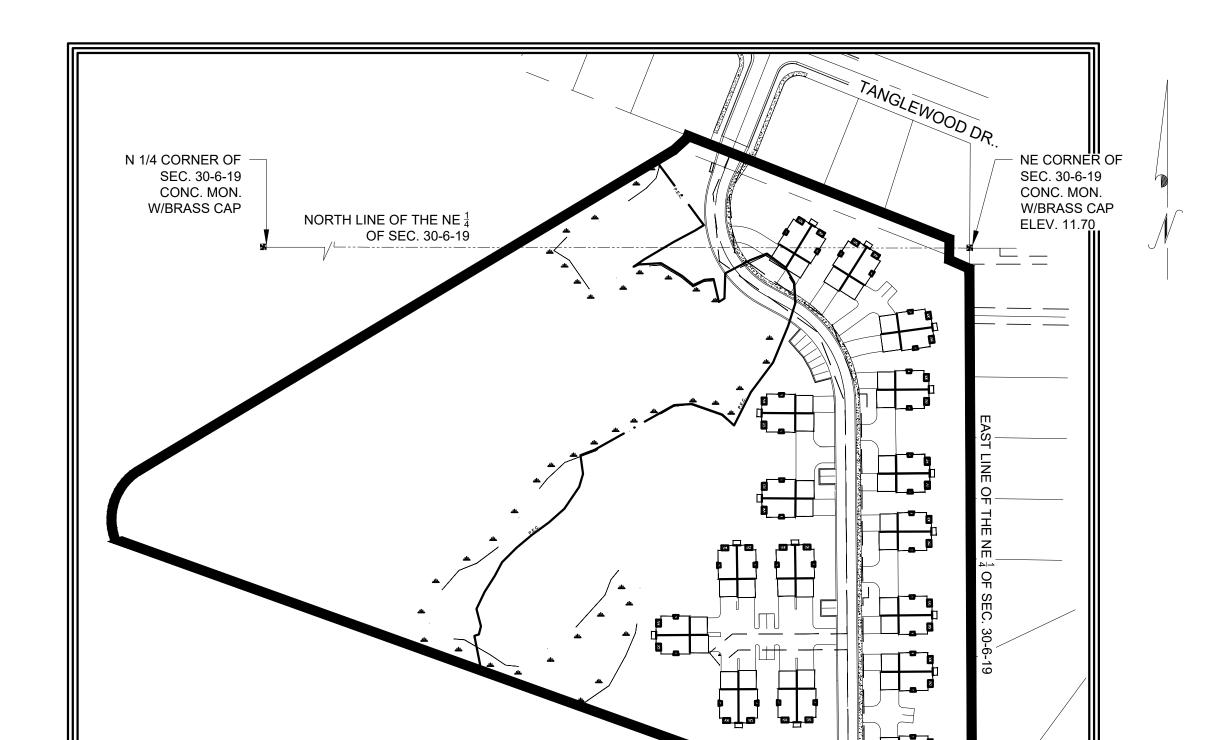

SITE MAP



VICINITY MAP

PART OF THE SE $\frac{1}{4}$ OF SEC. 19 AND THE NE $\frac{1}{4}$ OF SEC. 30, TOWN 6 NORTH, RANGE 19 EAST

BENCHMARKS:
BASED ON GRID NORTH OF THE WSCONSIN COUNTY CORRDINATE SYSTEM,
(NAD83 WISCORS 2018) AND REFERENCED TO THE EAST LINE OF THE SE \$\frac{1}{4}\$ OF SEC. 30-6-10 MEASURED AS \$\$S00°16'58"E.

VERTICAL DATUM IS CITY OF WAUKESHA REFERENCED TO THE NE CORNER OF SEC. 30-6-10 MEASURED AS 792.26' (NAVD88 GEOID 12A WISCORS 2019) CITY COVERSION FACTOR -780.56.

PRELIMINARY

ALL IMPROVEMENTS AND CONSTRUCTION SHOWN ONTHE PLANS SHALL CONFORM TO THE CITY OF WAUKESHA DEVELOPMENT HANDBOOK & INFRASTRUCTURE SPECIFICATIONS: WHERE THE PLANS DO NOT COMPLY, IT SHALL BE THE SOLE RESPONSIBILITY AND EXPENSE OF THE DEVELOPER TO MAKE REVISIONS TO THE PLANS AND/OR CONSTRUCTED INFRASTRUCTION TO COMPLY.

OWNER/DEVELOPER: JOHN MAREK INC. W284 N5039 ROOSEVELTS QUAY PEWAUKEE, WI 53072

AGENT/ENGINEER: JRM CONSULTING, LLC 3904 OAKMONT TRAIL WAUKESHA, WI 53188



SITE IMPROVEMENT PLANS FOR ROLLING MEADOWS TOWN HOMES

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- 2 CONSTRUCTION DETAIL
- 3 CONSTRUCTION DETAILS4 CONSTRUCTION DETAILS
- SITE PLAN
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- 9 GRADING PLAN
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- 11 LANDSCAPE PLAN



TO OBTAIN LOCATION OF
PARTICIPANTS UNDERGROUND
FACILITIES BEFORE YOU
DIG IN WISCONSIN
CALL DIGGERS HOTLINE
TOLL FREE
800-242-8511
414-259-1181 MILWAUKEE METRO)
(TDD: 800-542-2289)
www.diggershotline.com

WIS. STATUTE 182.0175 (1974)
REQUIRES MIN. OF 3 WORK DAYS
NOTICE BEFORE YOU EXCAVATE.

CAUTION NOTICE TO CONTRACTOR

THE CONTRACTOR IS SPECIFICALLY CAUTIONED THAT THE LOCATION AND/OR ELEVATION OF EXISTING UTILITIES AS SHOWN ON THESE PLANS IS BASED ON RECORDS OF VARIOUS UTILITY COMPANIES AND WHERE POSSIBLE, MEASUREMENTS TAKEN IN THE FIELD. THE INFORMATION IS NOT TO BE RELIED ON AS BEING EXACT OR COMPLETE. THE CONTRACTOR MUST CALL THE APPROPRIATE UTILITY COMPANY AT LEAST 48 HOURS BEFORE ANY EXCAVATION TO REQUEST EXACT FIELD LOCATION OF UTILITIES. IT SHALL BE THE RESPONSIBILITY OF THE CONTRACTOR TO RELOCATE ALL EXISTING UTILITIES WHICH CONFLICT WITH THE PROPOSED IMPROVEMENTS SHOWN ON THE PLANS.

	DDAWN IDD 10/16/22					
	DRAWN JBR 10/16/23 CHECKED JRM 10/16/23	PROJECT NO. 22-044				
O.	REVISION	S	В	3Y	DATE	
1	New PEC and new wetland lines			m	08-11-23	
	TITLE SHEET. INC	EX	SHI	SHEET NO.		

TITLE SHEET, INDEX
VICINITY MAP
SITE MAP

INITIALS DATE

DESIGNED JRM 10/16/23

OF]

NTS

EROSION CONTROL NOTES:


- 1. DETAILS OF CONSTRUCTION NOT SHOWN ON THIS DRAWING SHALL CONFORM TO THE PERTINENT REQUIREMENTS OF THE WISCONSIN DEPARTMENT OF NATURAL RESOURCES TECHNICAL STANDARDS.
- 2. CONSTRUCT SILT FENCE IN ACCORDANCE WITH WDNR TECHNICAL STANDARD 1056
- 3. CONTRACTOR SHALL CHECK ALL EROSION CONTROL MEASURES EVERY SEVEN DAYS OR AFTER EACH 0.5 INCH RAINFALL WHICHEVER IS SOONER AND PROVIDE ANY MAINTENANCE REQUIRED FOR CONFORMANCE WITH THIS PLAN.
- 4. A MINIMUM OF 4 INCHES OF TOPSOIL SHALL BE PLACED ON AREAS TO BE VEGETATED, INCLUDING RESTORATION OF AREAS DISTURBED DURING UTILITY INSTALLATION.
- 5. SEEDING SHALL BEGIN WITHIN 7 DAYS AFTER FINAL GRADING IS COMPLETED.
- 6. SEEDING SHALL CONFORM TO THE REQUIREMENTS OF SECTION 630 OF THE WISDOT STANDARD SPECIFICATIONS. A NO. 40 MIXTURE SHALL BE APPLIED AT A RATE OF 2 POUNDS PER 1000 S.F.
- PLACE EROSION MATTING ON ALL SLOPES OF 4:1 OR GREATER IN ACCORDANCE WITH WISDOT STANDARD SPECIFICATIONS. EROSION MAT PRODUCTS MUST BE SELECTED FROM THE WISDOT PRODUCT ACCEPTABILITY LIST.
- 8. INSTALL EROSION WATTLES AT THE BASE OF THE SLOPE BEHIND THE BACK OF CURB AT THE ENTRANCE TO THE SITE.
- 9. TOPSOIL PILES ARE TO BE SEEDED WITHIN 14 DAYS OF LAYUP.
- 10. ANY DISTURBED AREAS LEFT OPEN FOR MORE THAN 30 DAYS WILL REQUIRE TEMPORARY STABILIZATION. REFER TO WDNR STANDARD 1059, SECTION 3 "CONDITIONS WHERE PRACTICE APPLIES".
- 11. TEMPORARY SEEDING: ANNUAL RYEGRASS AT 25 lbs/ACRE; LATE SEASON TEMPORARY SEEDING (SEPT. 15 TO OCT. 15): WINTER WHEAT AT 2 BUSHELS/ACRE; DORMANT SEEDING (AFTER NOV. 1): NO. 10 MIXTURE AT 4 lbs/1000 S.F. CHANNELS ARE TO BE STABILIZED WITH CLASS 3, TYPE A EROSION MAT.
- 12. BIWEEKLY PROGRESS SITE MEETINGS TO BE HELD ON THE SITE. ATTENDEES WILL BE OWNER, CONTRACTOR, ENGINEER AND A REPRESENTATIVE FROM CITY OF WAUKESHA ENGINEERING DEPARTMENT.


CONSTRUCTION SEQUENCE:

- 1. CONSTRUCT STONE TRACKING PAD AT THE PROPOSED ENTRANCE.
- 2. CLEAR AND GRUB SITE.
- 3. INSTALL SILT FENCE AT THE LOCATIONS NOTED ON THE PLANS. THIS MUST BE DONE BEFORE ANY GRADING ACTIVITIES TAKE PLACE.
- CONSTRUCT SEDIMENT TRAP AND SEDIMENT BASIN. THIS WORK IS TO BE DONE PRIOR TO ANY OTHER GRADING ACTIVITIES. SIDE SLOPES ARE TO BE STABILIZED IMMEDIATELY AFTER CONSTRUCTION.
- GRADE THE SWALE BEHIND UNITS 10 11 AND 14 -15 TO DIRECT RUNOFF INTO DETENTION POND. STABILIZE THE SWALE IN ACCORDANCE WITH THE EROSION CONTROL PLAN IMMEDIATELY AFTER CONSTRUCTION.
- 6. IF DEWATERING IS NECESSARY DURING POND CONSTRUCTION A TEMPORARY SETTLING BASIN IS TO BE CONSTRUCTED IN ACCORDANCE WITH THE DETAIL ON SHEET 3. THE BASIN MUST BE PLACED WITHIN THE PERIMETER SILT FENCE ON LEVEL GROUND.
- 7. TOPSOIL ON THE REMAINDER OF THE SITE IS TO BE STRIPPED AND STOCKPILED. THE STOCKPILE IS TO BE PROTECTED WITH SILT FENCE WITHIN 7 DAYS AND SEEDED WITHIN 14 DAYS OF LAYUP.
- 8. ROUGH GRADING MAY TAKE PLACE AFTER TOPSOIL STRIPPING.
- GRADE ROADWAY AND BUILDING PADS. INSTALL STORM SEWER AND UTILITIES. ALL INLETS ARE TO BE PROTECTED IMMEDIATELY AFTER INSTALLATION IN ACCORDANCE WITH THESE DETAILS.
- 10. AFTER BASIN HAS BEEN GRADED, THE STORM SEWER OUTFALL IS TO BE CONNECTED TO THE BASIN STANDPIPE WITH A 12" DIAMETER PIPE. THIS CONNECTION IS TO REMAIN IN PLACE UNTIL VEGETATION HAS BEEN ESTABLISHED IN THE BASIN.
- 11. FINISH GRADE CONSTRUCTED WETLAND AND SEED WITH NATIVE WISCONSIN SEED MIXTURE. CONTRACTOR TO CONSULT WITH A CERTIFIED LANDSCAPE ARCHITECT.
- 12. PERMANENT SEEDING TO BE COMPLETED BY OCTOBER 15TH OF THE YEAR GRADING WORK IS COMPLETED OR BY JUNE 1ST OF THE FOLLOWING YEAR.
- 13. REMOVE ALL TEMPORARY BMP'S SUCH AS SILT FENCES AND SEDIMENT TRAPS AS SOON AS ALL DISTURBED AREAS HAVE BEEN STABILIZED. DO NOT REMOVE BMP'S UNTIL DISTURBED AREAS HAVE BEEN STABILIZED. CONTRACTOR IS TO ENSURE THAT SEDIMENT IS REMOVED FROM PERMANENT BASINS USED AS SEDIMENT TRAPS DURING CONSTRUCTION


This drawing based on Wisconsir Department of Transportation Standard Detail Drawing 8 E 9-6.

SILT FENCE / 1

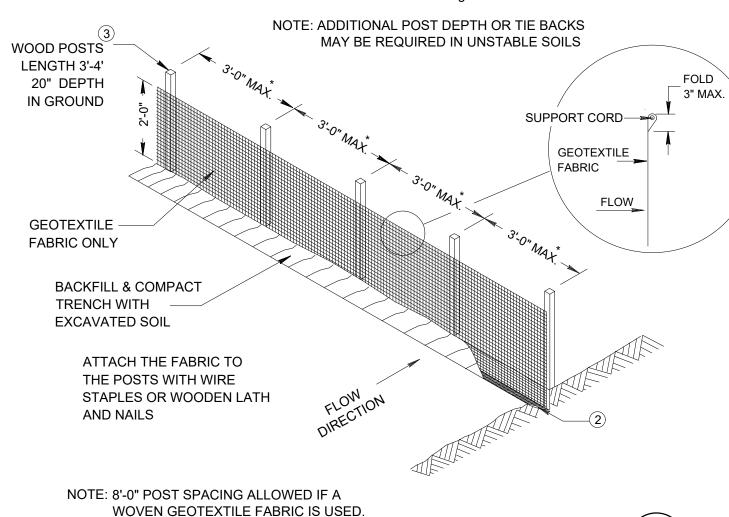

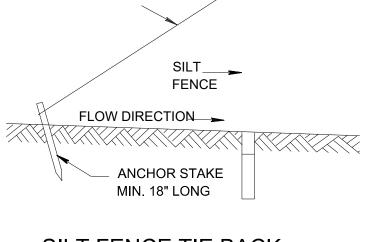


SILT FENCE TIE BACK (WHEN ADDITIONAL SUPPORT REQUIRED)

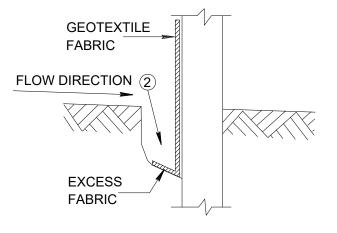


TRENCH DETAIL


GENERAL NOTES:

- 1. HORIZONTAL BRACE REQUIRED WITH 2" x 4" WOODEN FRAME OR EQUIVALENT AT TOP OF POSTS.
- 2. TRENCH SHALL BE A MINIMUM OF 4" WIDE AND 6" DEEP TO BURY AND ANCHOR THE GEOTEXTILE FABRIC. FOLD MATERIAL TO FIT TRENCH AND BACKFILL AND COMPACT TRENCH WITH EXCAVATED SOIL.
- 3. WOOD POSTS SHALL BE A MINIMUM SIZE OF 1-1/8" x 1-1/8" OF OAK OR HICKORY
- 4. SILT FENCE TO EXTEND ACROSS THE TOP OF THE PIPE.
- 5. CONSTRUCT SILT FENCE FROM A CONTINUOUS ROLL IF POSSIBLE BY CUTTING LENGTHS TO AVOID JOINTS. IF A JOINT IS NECESSARY USE ONE OF THE FOLLOWING TWO METHODS; A) OVERLAP THE END POSTS AND TWIST, OR ROTATE, AT LEAST 180^ B) HOOK THE END OF EACH SILT FENCE LENGTH.
- 6. SILT FENCE SHALL BE INSTALLED USING CURRENT WISDOT STANDARDS AT THE TIME OF CONSTRUCTION.

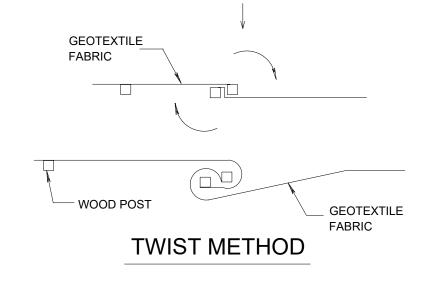


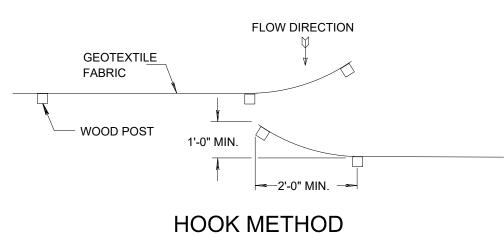


JOINING TWO LENGTHS OF SILT FENCE

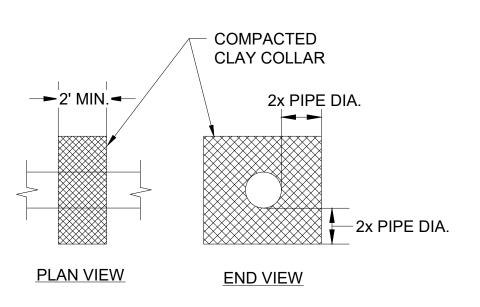


COMPACTED CLAY COLLAR (2)

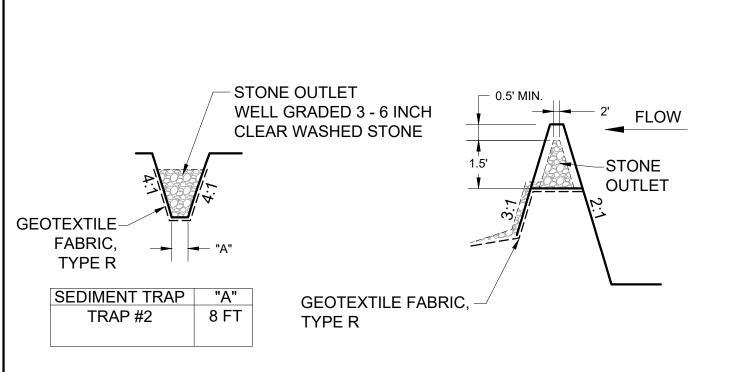

SEDIMENT TRAP #2 OUTLET 3

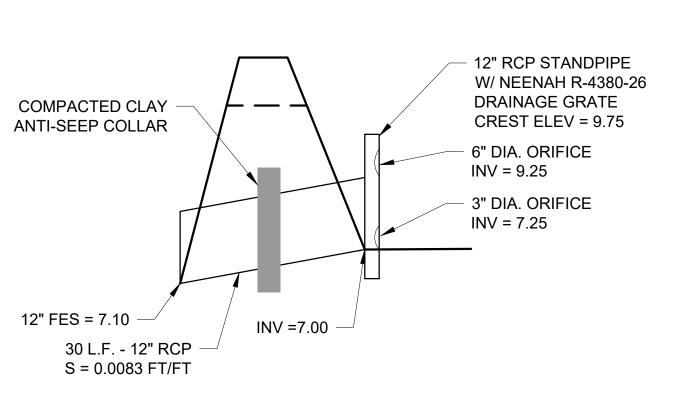



BASIN #1 OUTLET DETAIL

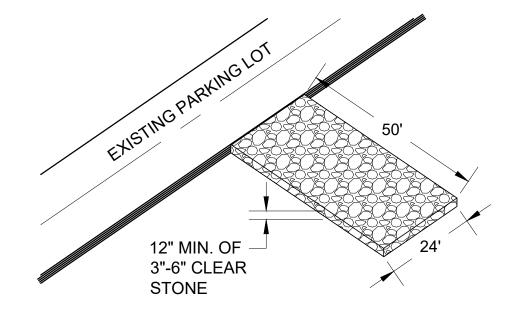


PLACE WISDOT TYPE R GEOTEXTILE FABRIC UNDER STONE IF SATURATED CONDITIONS ARE EXPECTED.

STONE TRACKING PAD (5)

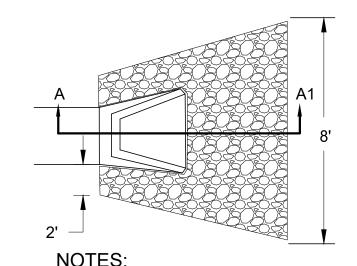

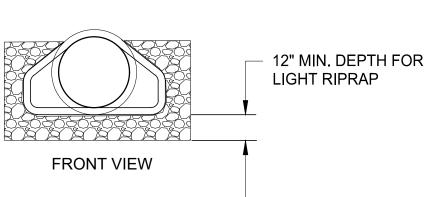

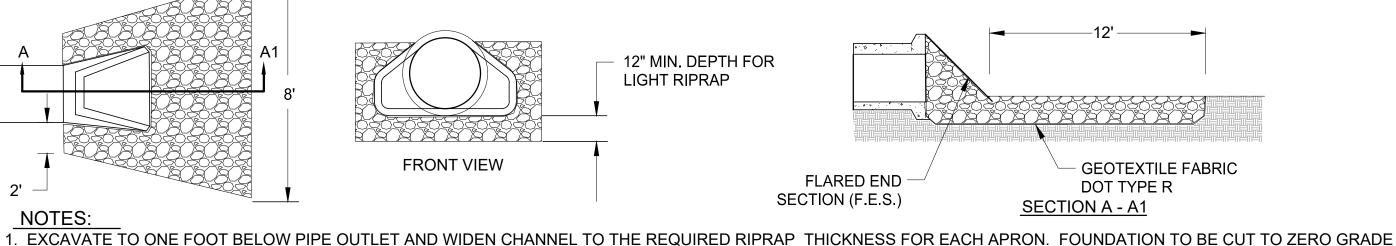

AND SMOOTHED.

- 2. PLACE FILTER CLOTH ON BOTTOM AND SIDES OF PREPARED FOUNDATION. ALL JOINTS TO OVERLAP A MINIMUM OF ONE FOOT
- 3. EXERCISE CARE IN RIPRAP PLACEMENT TO AVOID DAMAGE TO FILTER FABRIC.
- 4. PLACE RIPRAP ON ZERO GRADE, TOP OF RIPRAP TO BE LEVEL WITH PROPOSED OUTLET NO OVERFALL AT ENDS.
- 5. RIPRAP SHALL BE MEDIUM RIPRAP IN ACCORDANCE WITH SECTION 606 OF THE STANDARD SPECIFICATIONS FOR ROAD AND BRIDGE CONSTRUCTION.
- 6. IMMEDIATELY AFTER CONSTRUCTION, STABILIZE ALL DISTURBED AREAS WITH VEGETATION.
- 7. LINE CHANNEL TO TOP OF BANKS FOR A DISTANCE OF 12' DOWNSTREAM. NO RESTRICTION OF CHANNEL CROSS SECTION SHOULD EXIST.

FLARED END SECTION (F.E.S.) AND RIPRAP DETAIL



PRELIMINARY

3904 OAKMONT TRAIL


WAUKESHA, WI 53188


262-206-8047

INITIALS DATE DESIGNED JRM 10/16/23 JAB 10/16/23 CHECKED JRM 10/16/23 NTS

> PROJECT NO. 22-044


SHEET NO.

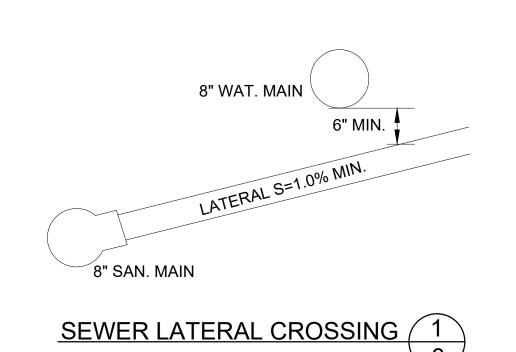

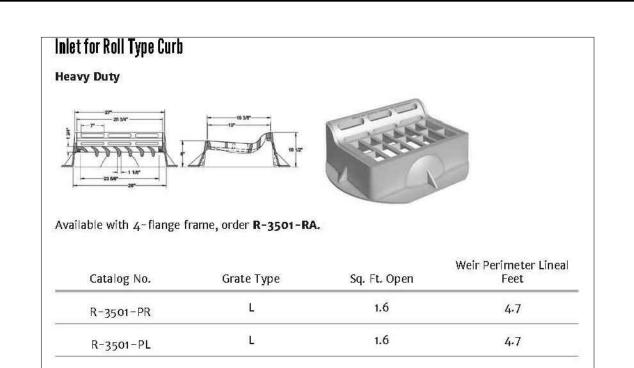

PRE-CAST INLET DETAIL NEENAH R-3501-PR 3

* CONTRACTOR SHALL SET INLET AT ASPHALT BINDER GRADE AND ADJUST WHEN SURFACE COURSE IS PLACED.

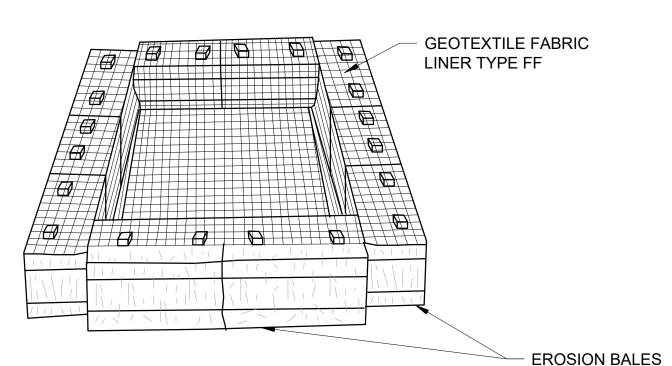

IF DEWATERING IS NECESSARY, A PUMP WILL BE PLACED WHERE NEEDED. AT THE POINT OF DISCHARGE THE WATER BEING PUMPED OUT WILL FLOW INTO A TEMPORARY SETTLING BASIN AS SHOWN ON THE PLANS. SIZING OF THE TEMPORARY SETTLING BASIN SHALL BE DETERMINED IN THE FIELD BY THE CONTRACTOR.

SIZE TO BE DETERMINED IN FIELD AS INDICATED BELOW:

STORAGE VOLUME (C.F.) = 16 x GPM (PUMP RATE)

EXAMPLE:
CONTRACTOR INDICATES PUMP CAPABLE OF 50 GPM
HEIGHT OF BALES = 1.5 FT


SV(C.F.) = 16 x 50 GPM = 800 C.F.


SOLUTION:


 $\frac{800 \text{ C.F.}}{1.5 \text{ FT.}} = 533 \text{ S.F.}$

USE A 20' x 27' BASIN

DEWATERING PLAN

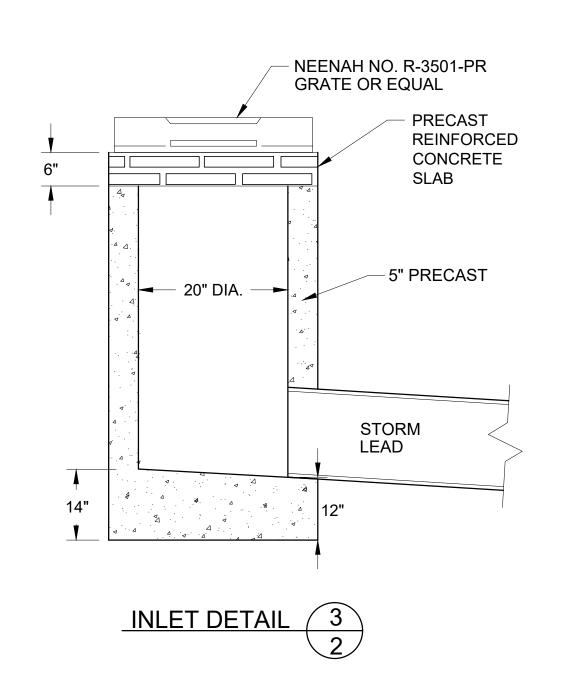

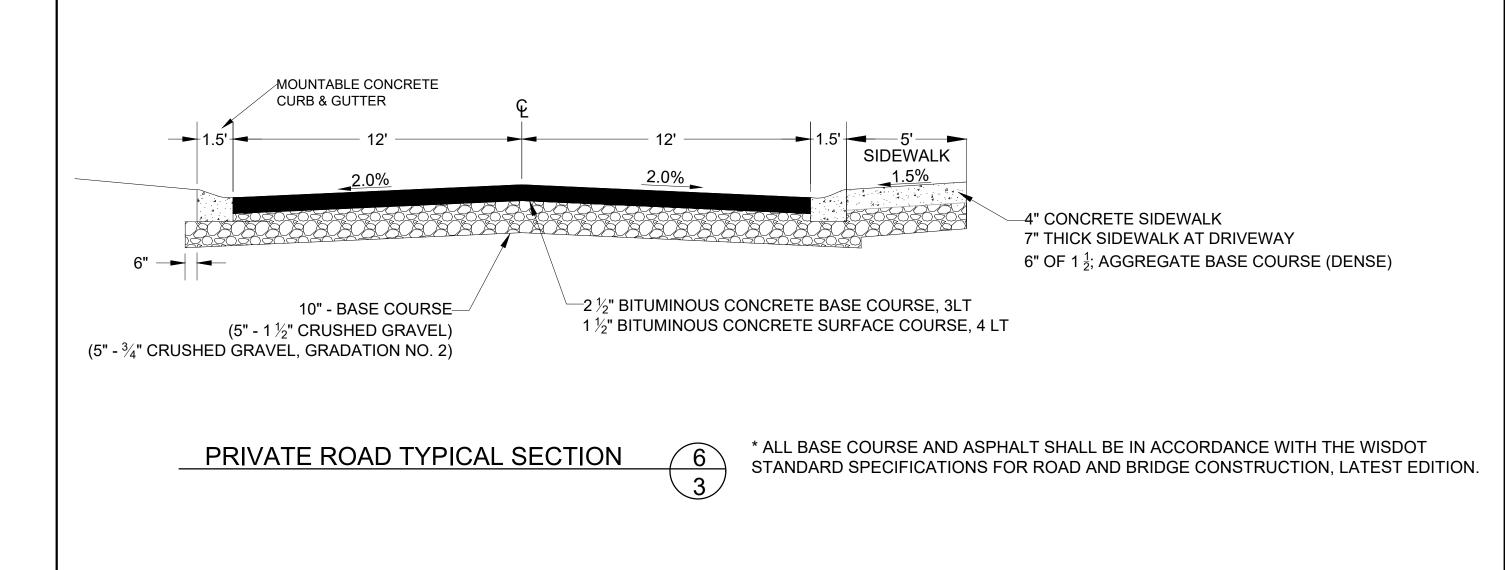

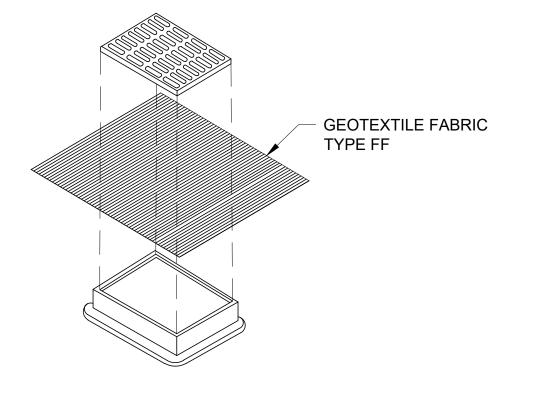



INSTALLATION NOTES:
FINISHED SIZE, INCLUDING FLAP POCKETS WHERE REQUIRED,
SHALL EXTEND A MINIMUM OF 10" AROUND THE PERIMETER TO
FACILITATE MAINTENANCE OR REMOVAL.
THE CONTRACTOR SHALL DEMONSTRATE A METHOD OF
MAINTENANCE, USING A SEWN FLAP, HAND HOLDS OR OTHER METHOD
TO PREVENT ACCUMULATED SEDIMENT FROM ENTERING THE INLET.
INLET PROTECTION SHALL BE INSPECTED AT A MINIMUM WEEKLY AND
WITHIN 24 HOURS AFTER EVERY PRECIPITATION EVENT THAT
PRODUCES 0.5 INCHES DURING A 24 HOUR PERIOD. SEDIMENT
DEPOSITS SHALL BE REMOVED WHEN ACCUMULATION TOTALS
BETWEEN 1/3 AND 1/2 THE DESIGN DEPTH OF THE DEVICE OR WHEN THE
DEVICE IS NOT FUNCTIONING AS DESIGNED.
DURING REMOVAL OF INLET PROTECTION ENSURE SEDIMENT DOES

INLET PROTECTION, TYPE B 4


INLET SHALL BE REMOVED.

NOT FALL INTO THE INLET. ANY MATERIAL WHICH FALLS INTO THE

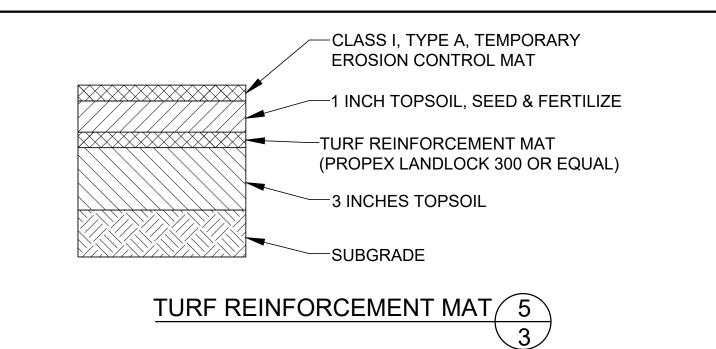

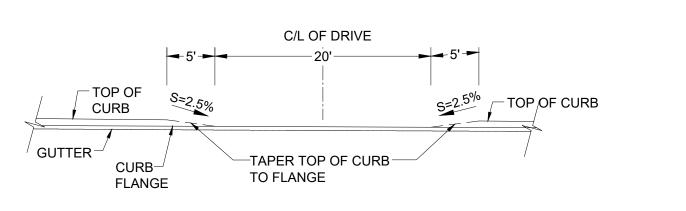

MOUNTABLE CURB CROSS SECTION

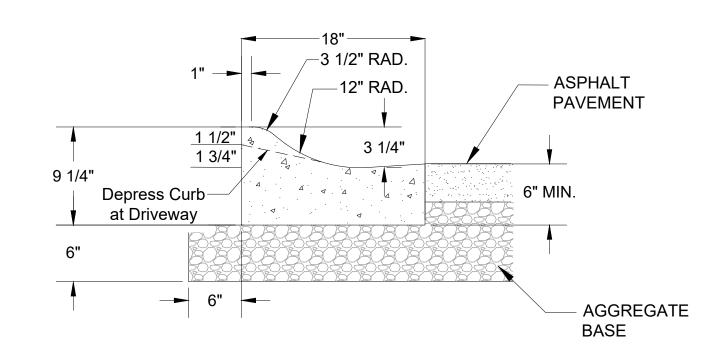



PRELIMINARY

SNOISINAS

ROLLING MEADOWS TOWN HO

INITIALS DATE

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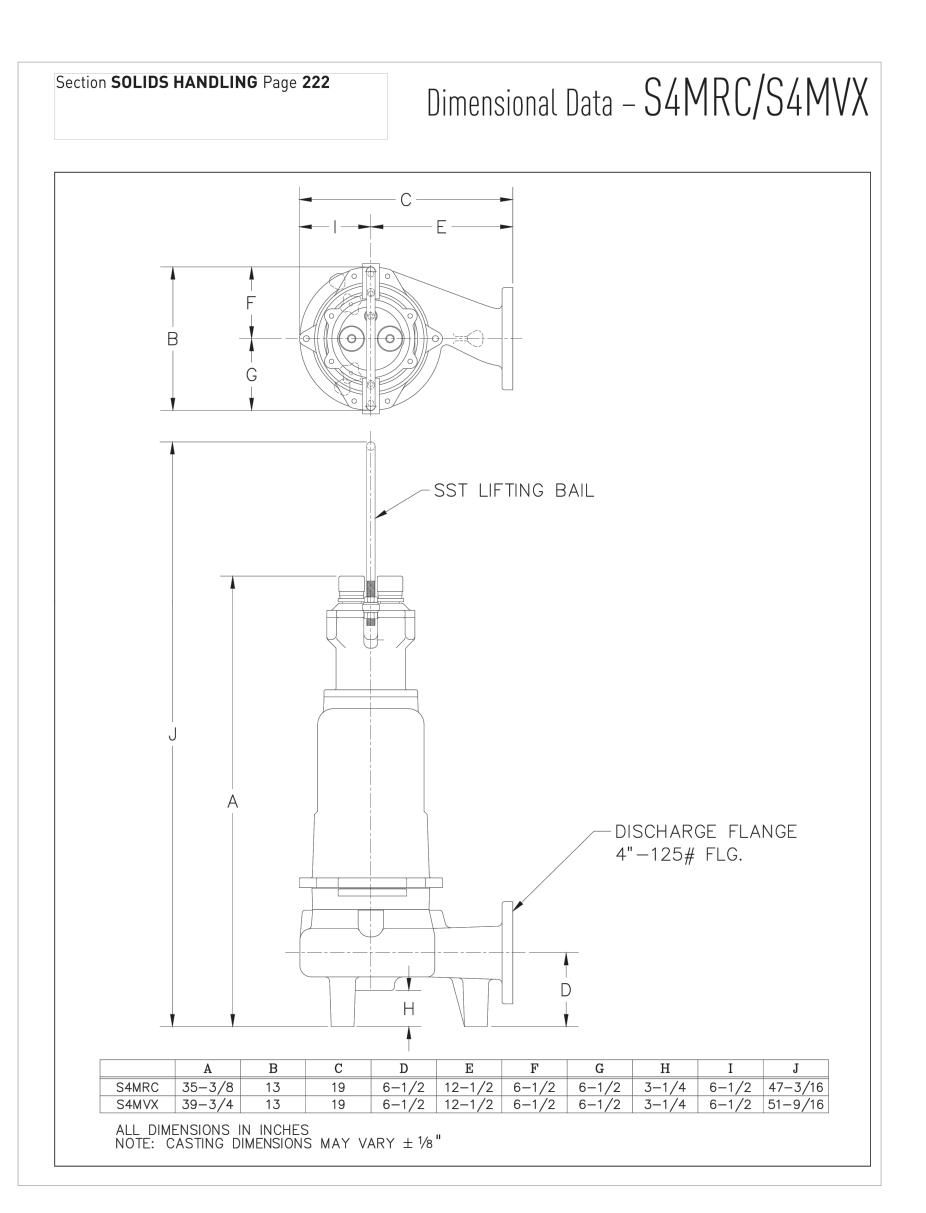
DRAWN JAB 10/16/23

CHECKED JRM 10/16/23


NTS


SCALE
PROJECT NO.
22-044

SHEET NO.




SANITARY SEWER LIFT STATION (1

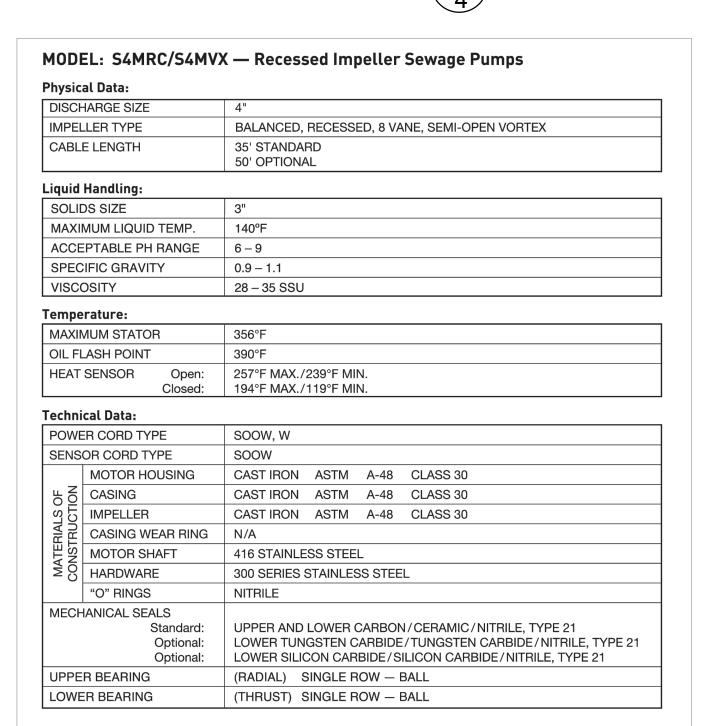

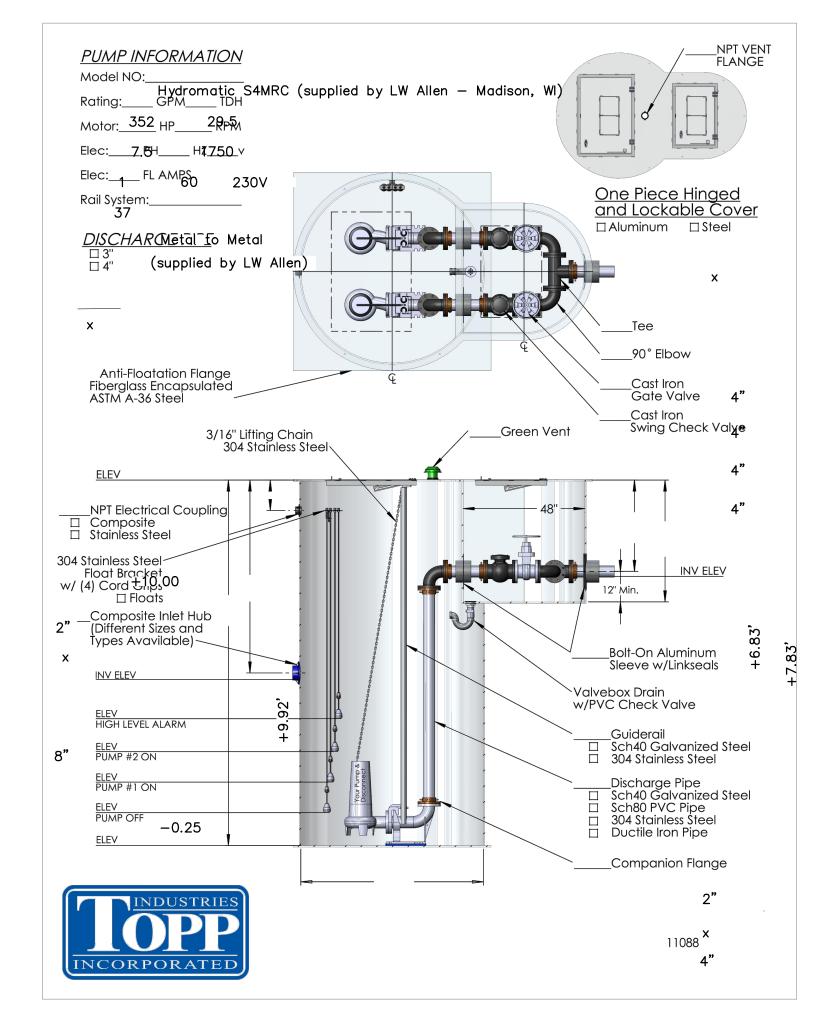




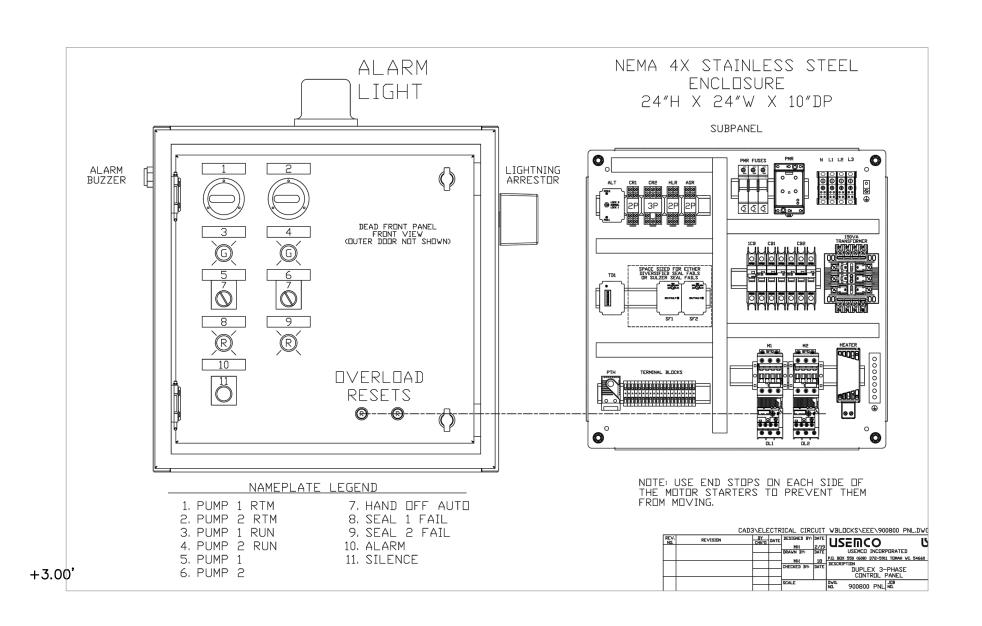

LIFT STATION CONTROL PANEL



PRELIMINARY

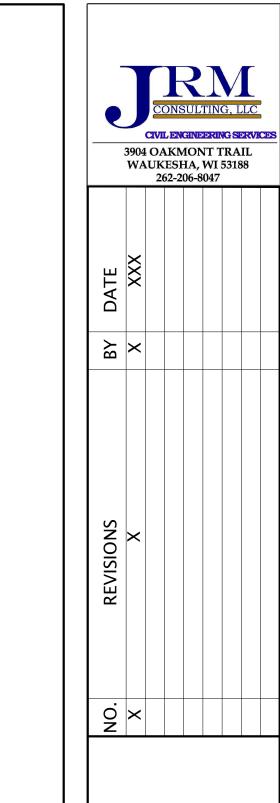

OLLING MEADOWS TOWN HOMES
DETAIL SHEET

INITIALS DATE

DESIGNED JRM 10/16/23


DRAWN JAB 10/16/23

CHECKED JRM 10/16/23

NTS

PROJECT NO. 22-044

SHEET NO.

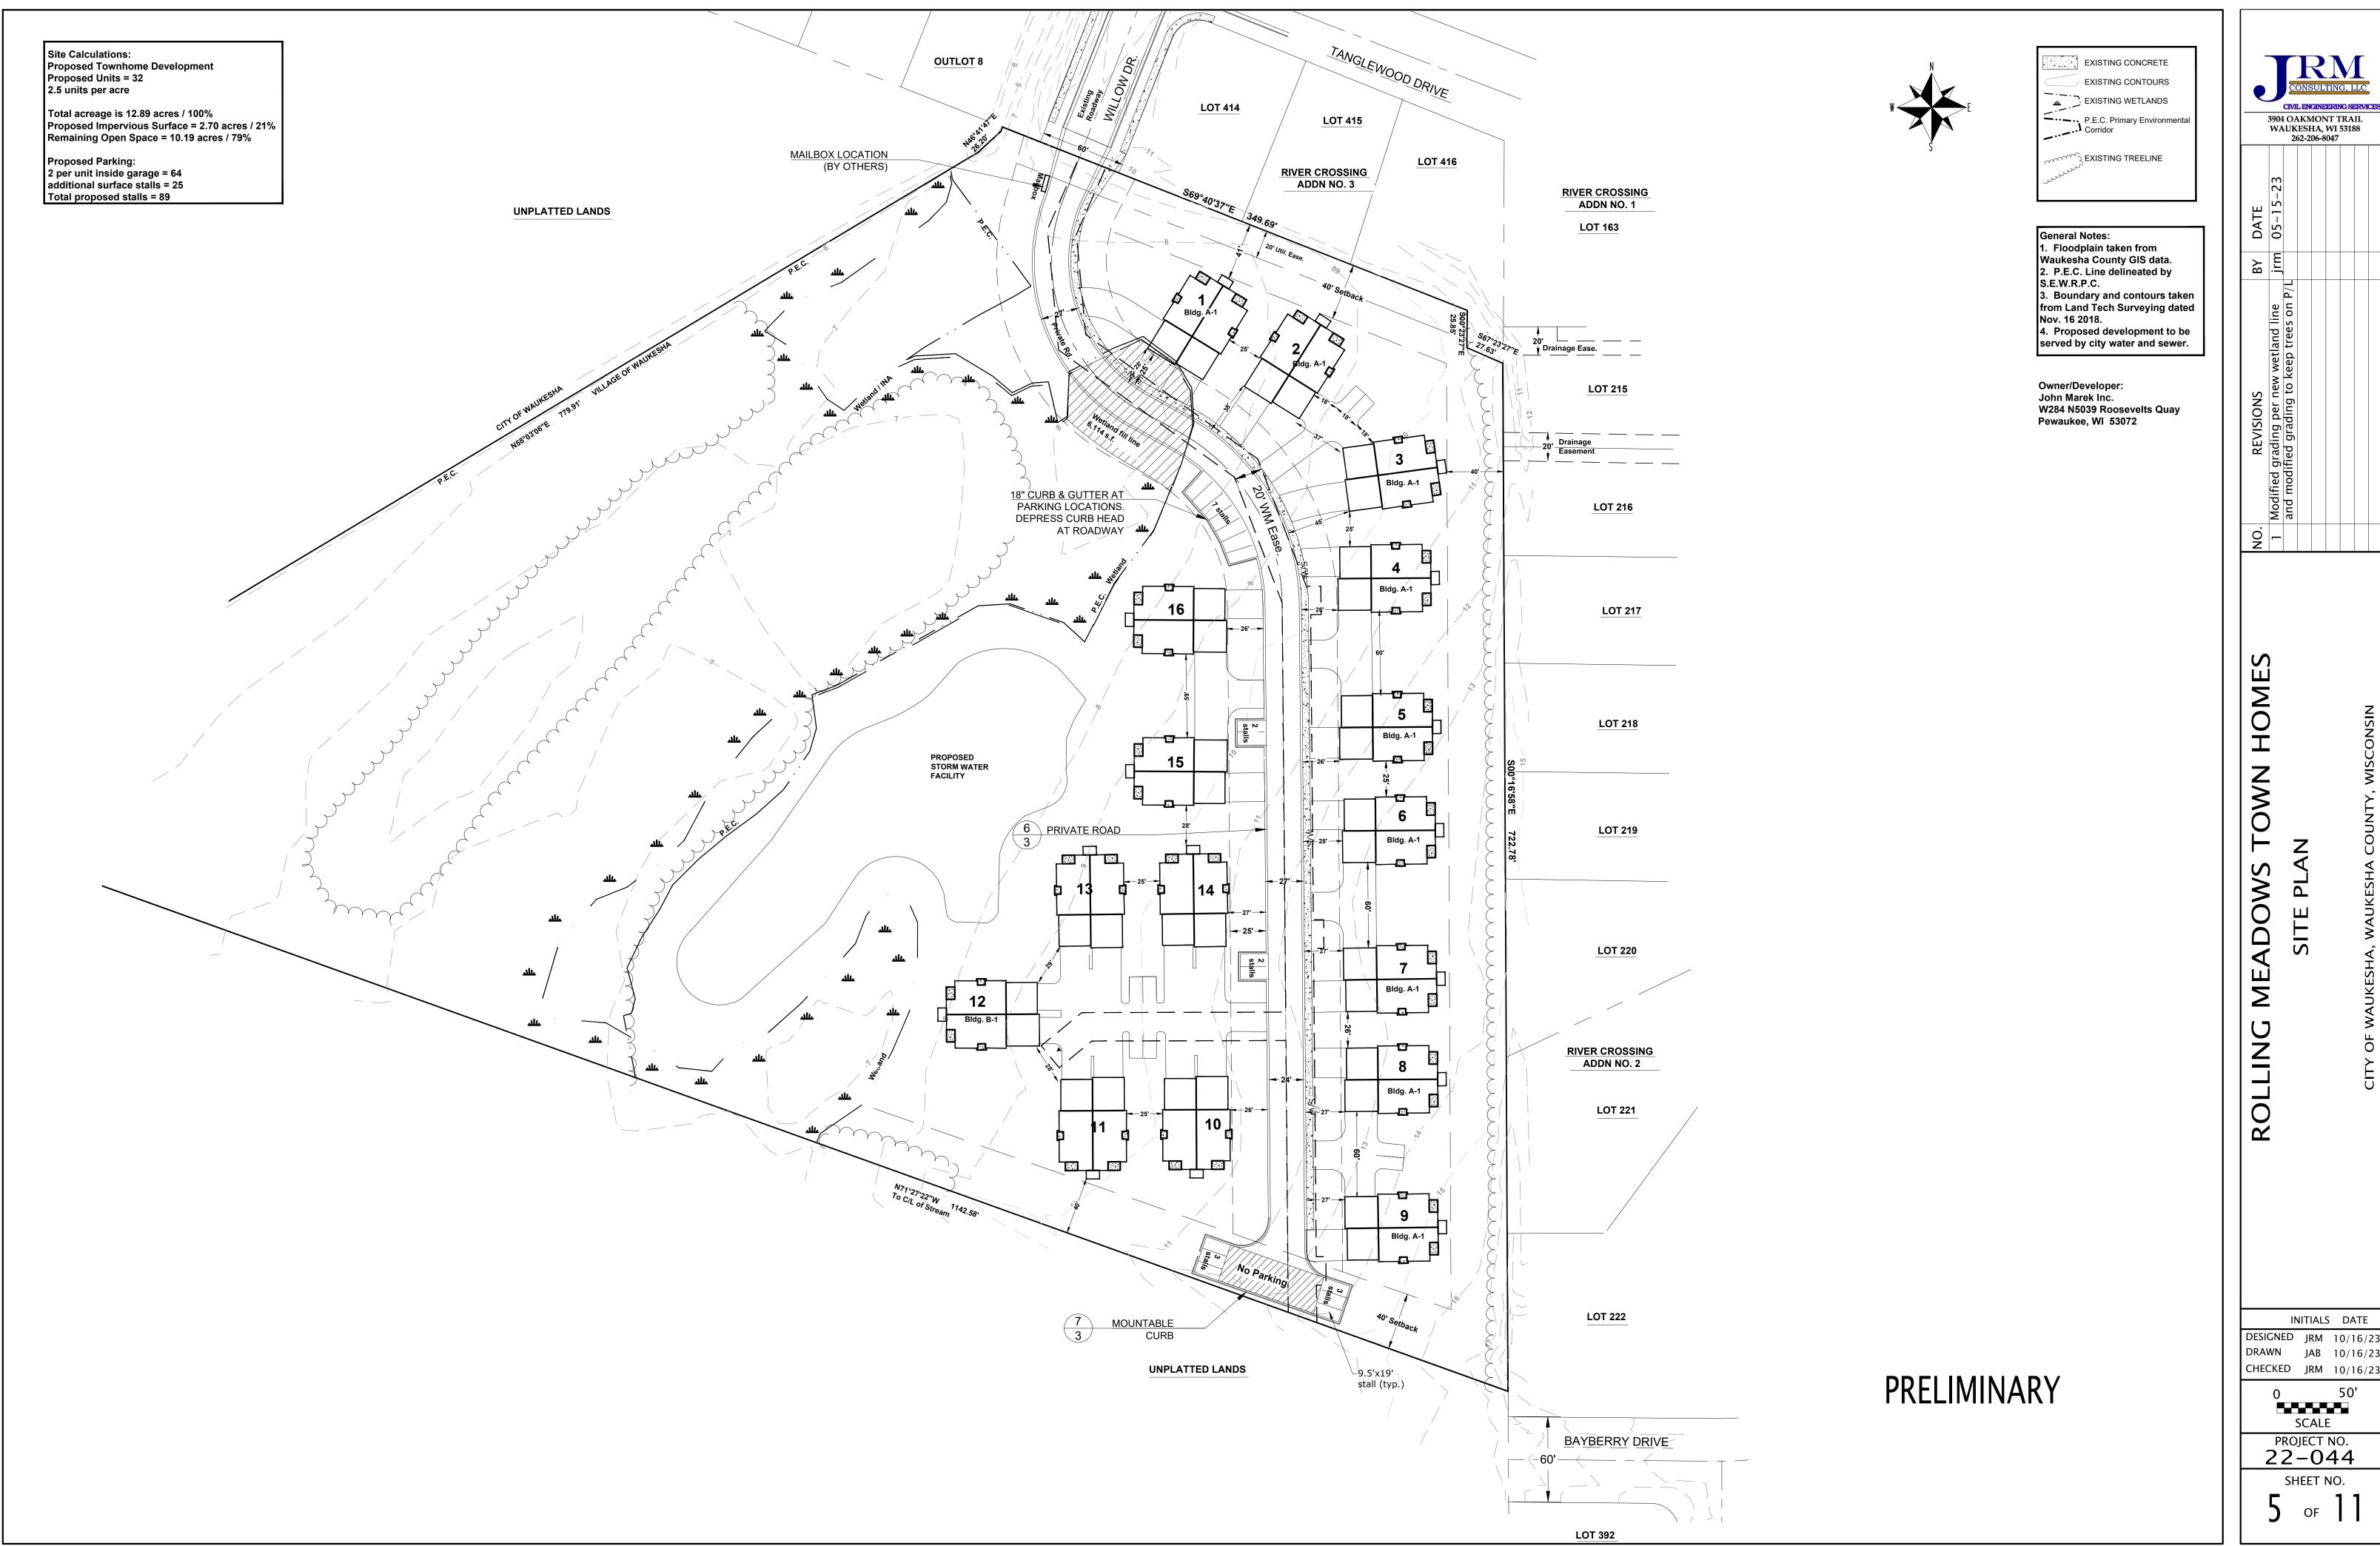

3904 OAKMONT TRAIL

INITIALS DATE DESIGNED JRM 10/16/23 JAB 10/16/23

SCALE

PROJECT NO. 22-044



CIVIL ENGINEERING SERVE
3904 OAKMONT TRAIL

BY DATE Salar and line jrm 05–15–23 to keep trees on P/L to keep trees o

NO. REVISIONS

1 Modified grading per new wetland line jrm and modified grading to keep trees on P/L

G MEADOWS LOWN HOM ARY SEWER AND WATER PLAN

INITIALS DATE

DESIGNED JRM 10/16/22

DRAWN JAB 10/16/2


DRAWN JAB 10/16/23
CHECKED JRM 10/16/23


0 40'


0 40
SCALE

PROJECT NO. 22-044


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EXISTING WETLANDS

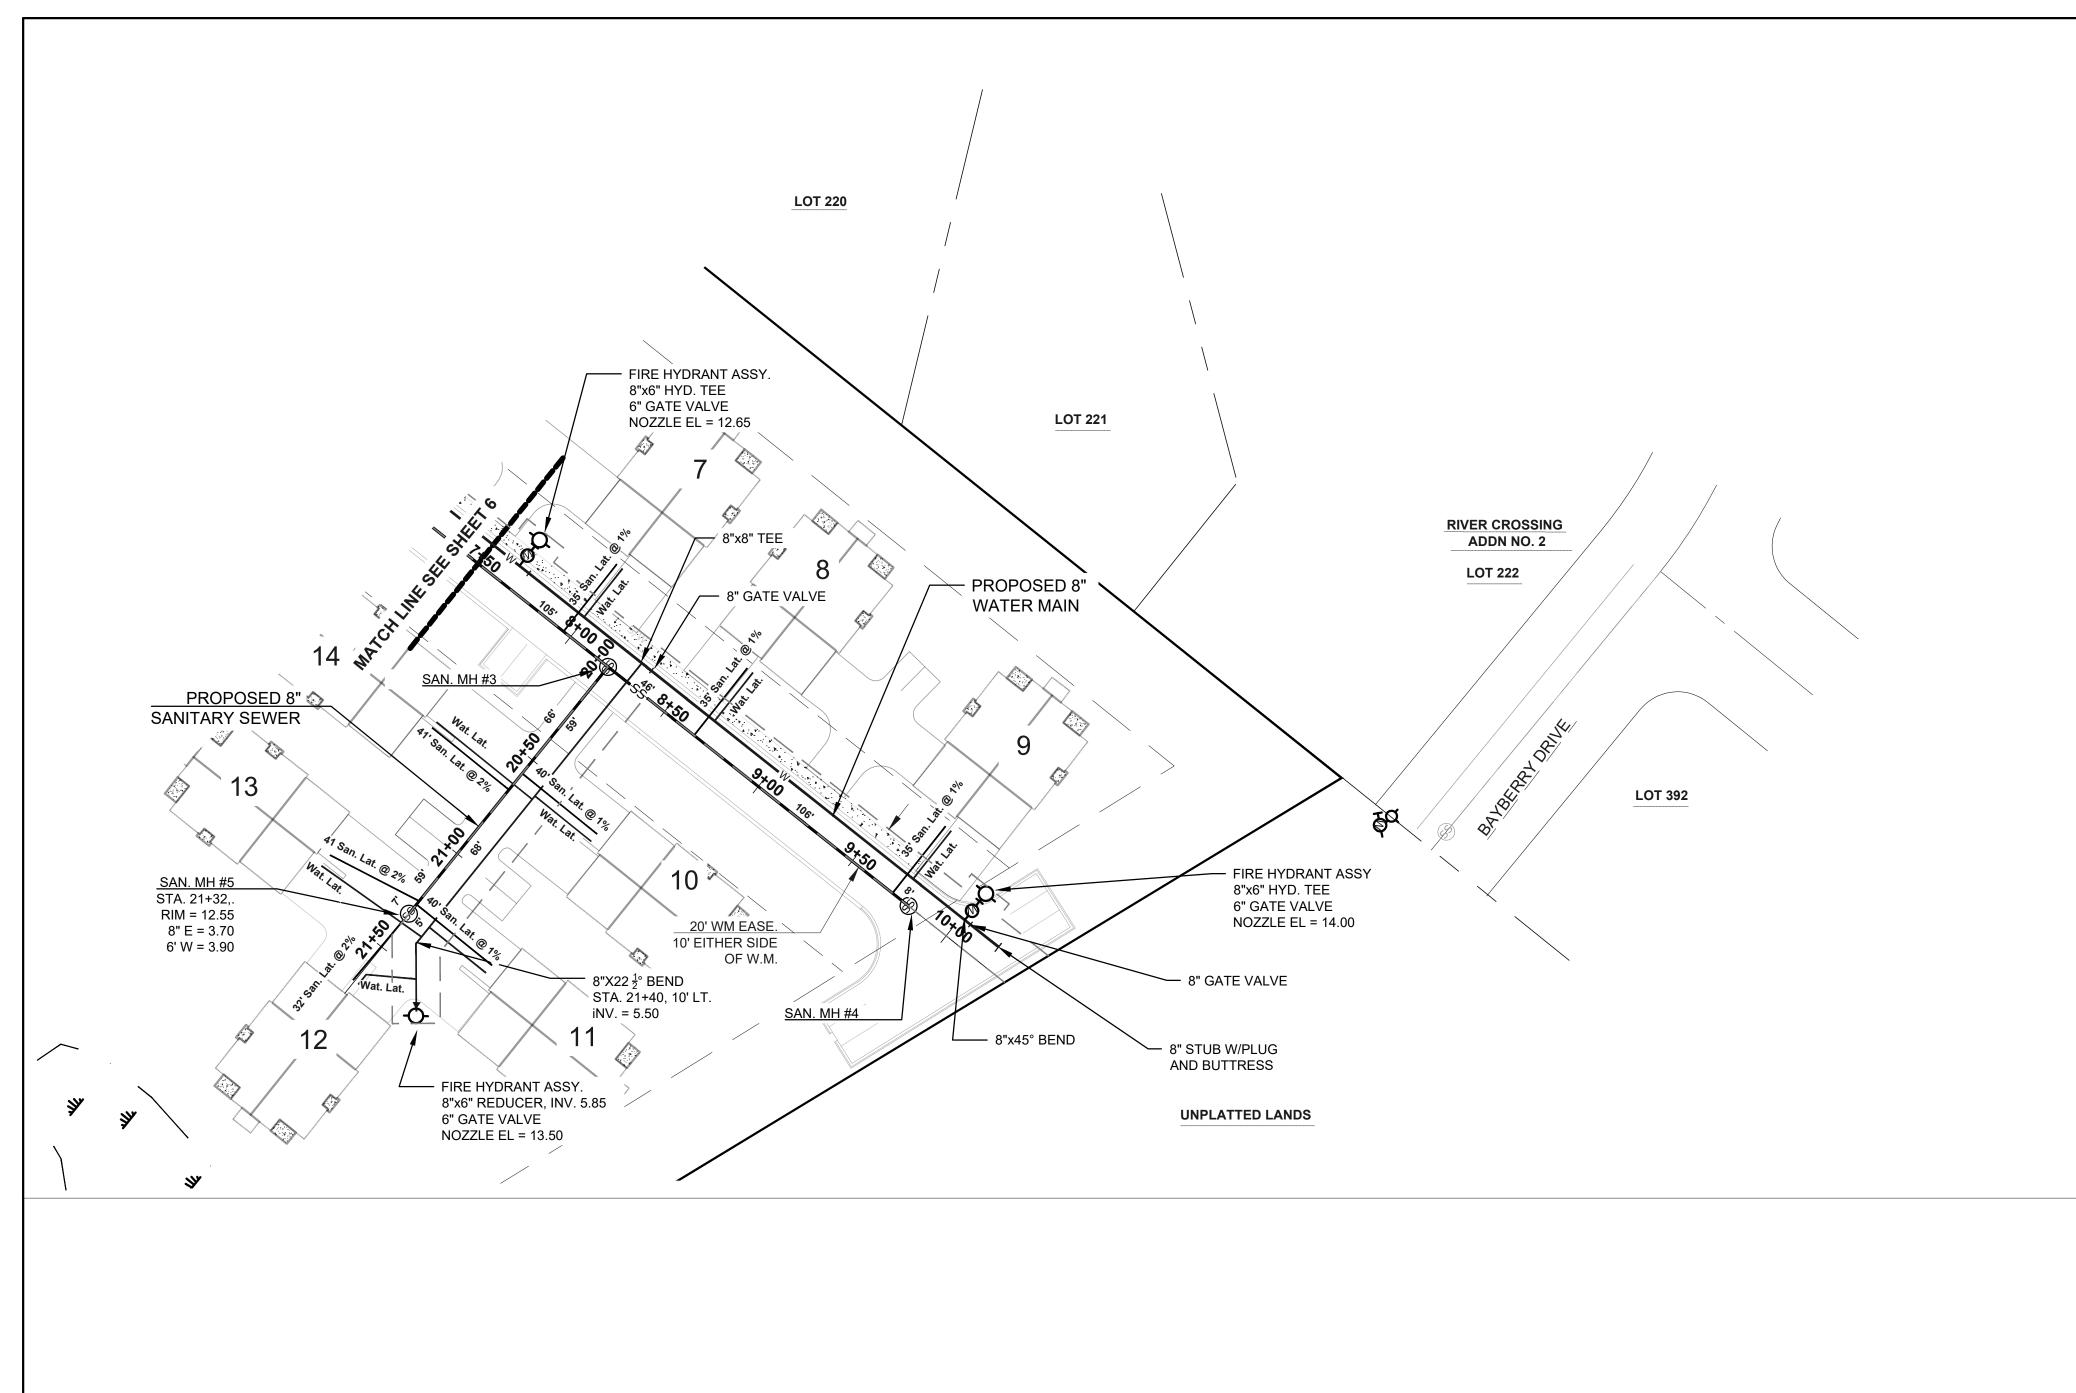

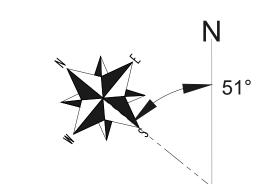
SANITARY SEWER MANHOLE

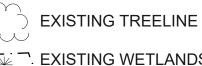
FIRE HYDRANT

NOTES:

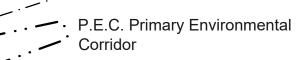LEGEND

- 1. SEWER AND WATER CONSTRUCTION SHALL BE IN ACCORDANCE WITH THE CITY OF WAUKESHA STANDARD SPECIFICATIONS AND STATE OF WISCONSIN STANDARDS FOR SEWER AND WATER CONSTRUCTION.
- 2. TRACER WIRE REQUIRED FOR ALL STORM SEWER, SANITARY SEWER AND WATER SERVICE PER DSPS REQUIREMENTS. 18 GAUGE MINIMUM AND LOCATED WITHIN 6" OF PIPE. STORM SEWER WIRE SHALL BE BROWN, WATER SHALL BE BLUE AND SANITARY SHALL BE GREEN IN COLOR.
- 3. SANITARY LATERALS ARE 6" MIN. WITH A SLOPE OF 1% TYPICAL.
- 4. WATER LATERALS ARE 4" MIN. AND INCLUDES SHUTOFF VALVES.
- 5. HYDRANT VALVES NOT ALLOWED IN SIDEWALK.
- 6. ALL APPLICATIONS AND FEES FOR SANITARY SEWER MUST BE COMPLETED AND PAID PRIOR TO BE CONNECTION TO SEWER SYSTEMS.
- 7. ANY UTILITY WORK IN THE RIGHT-OF-WAY AND ALL SANITARY SEWER CONNECTIONS TO BE INSPECTED BY CITY. NOTIFY CITY 72 HOURS IN ADVANCE OF CONNECTING TO SEWER.

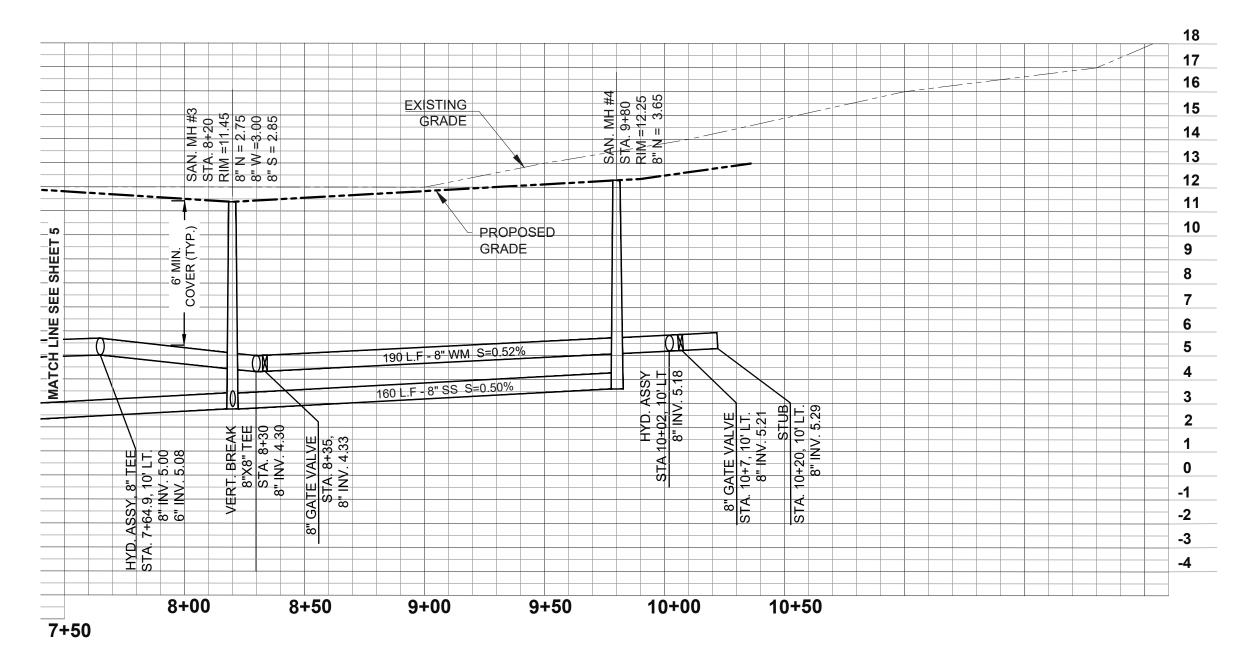

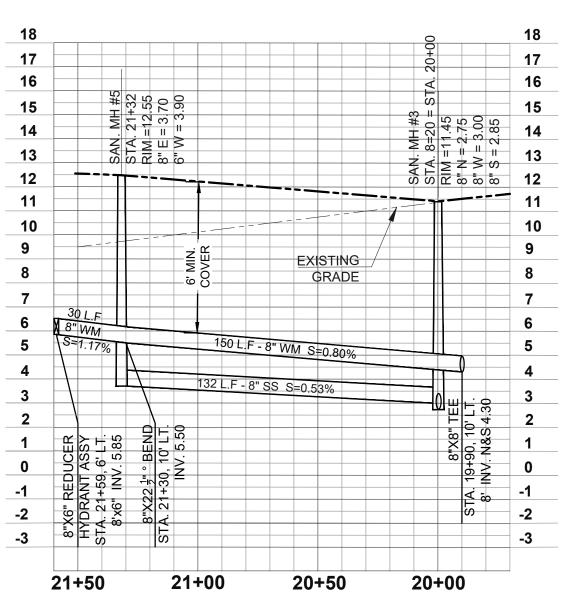

Horiz. 1" = 40' Vert. 1" = 4'

PRELIMINARY


3904 OAKMONT TRAIL WAUKESHA, WI 53188 262-206-8047

> ADOW OLLIN

INITIALS DATE DESIGNED JRM 10/16/23 JAB 10/16/23 CHECKED JRM 10/16/23

> **SCALE**

PROJECT NO. **22-044** SHEET NO.

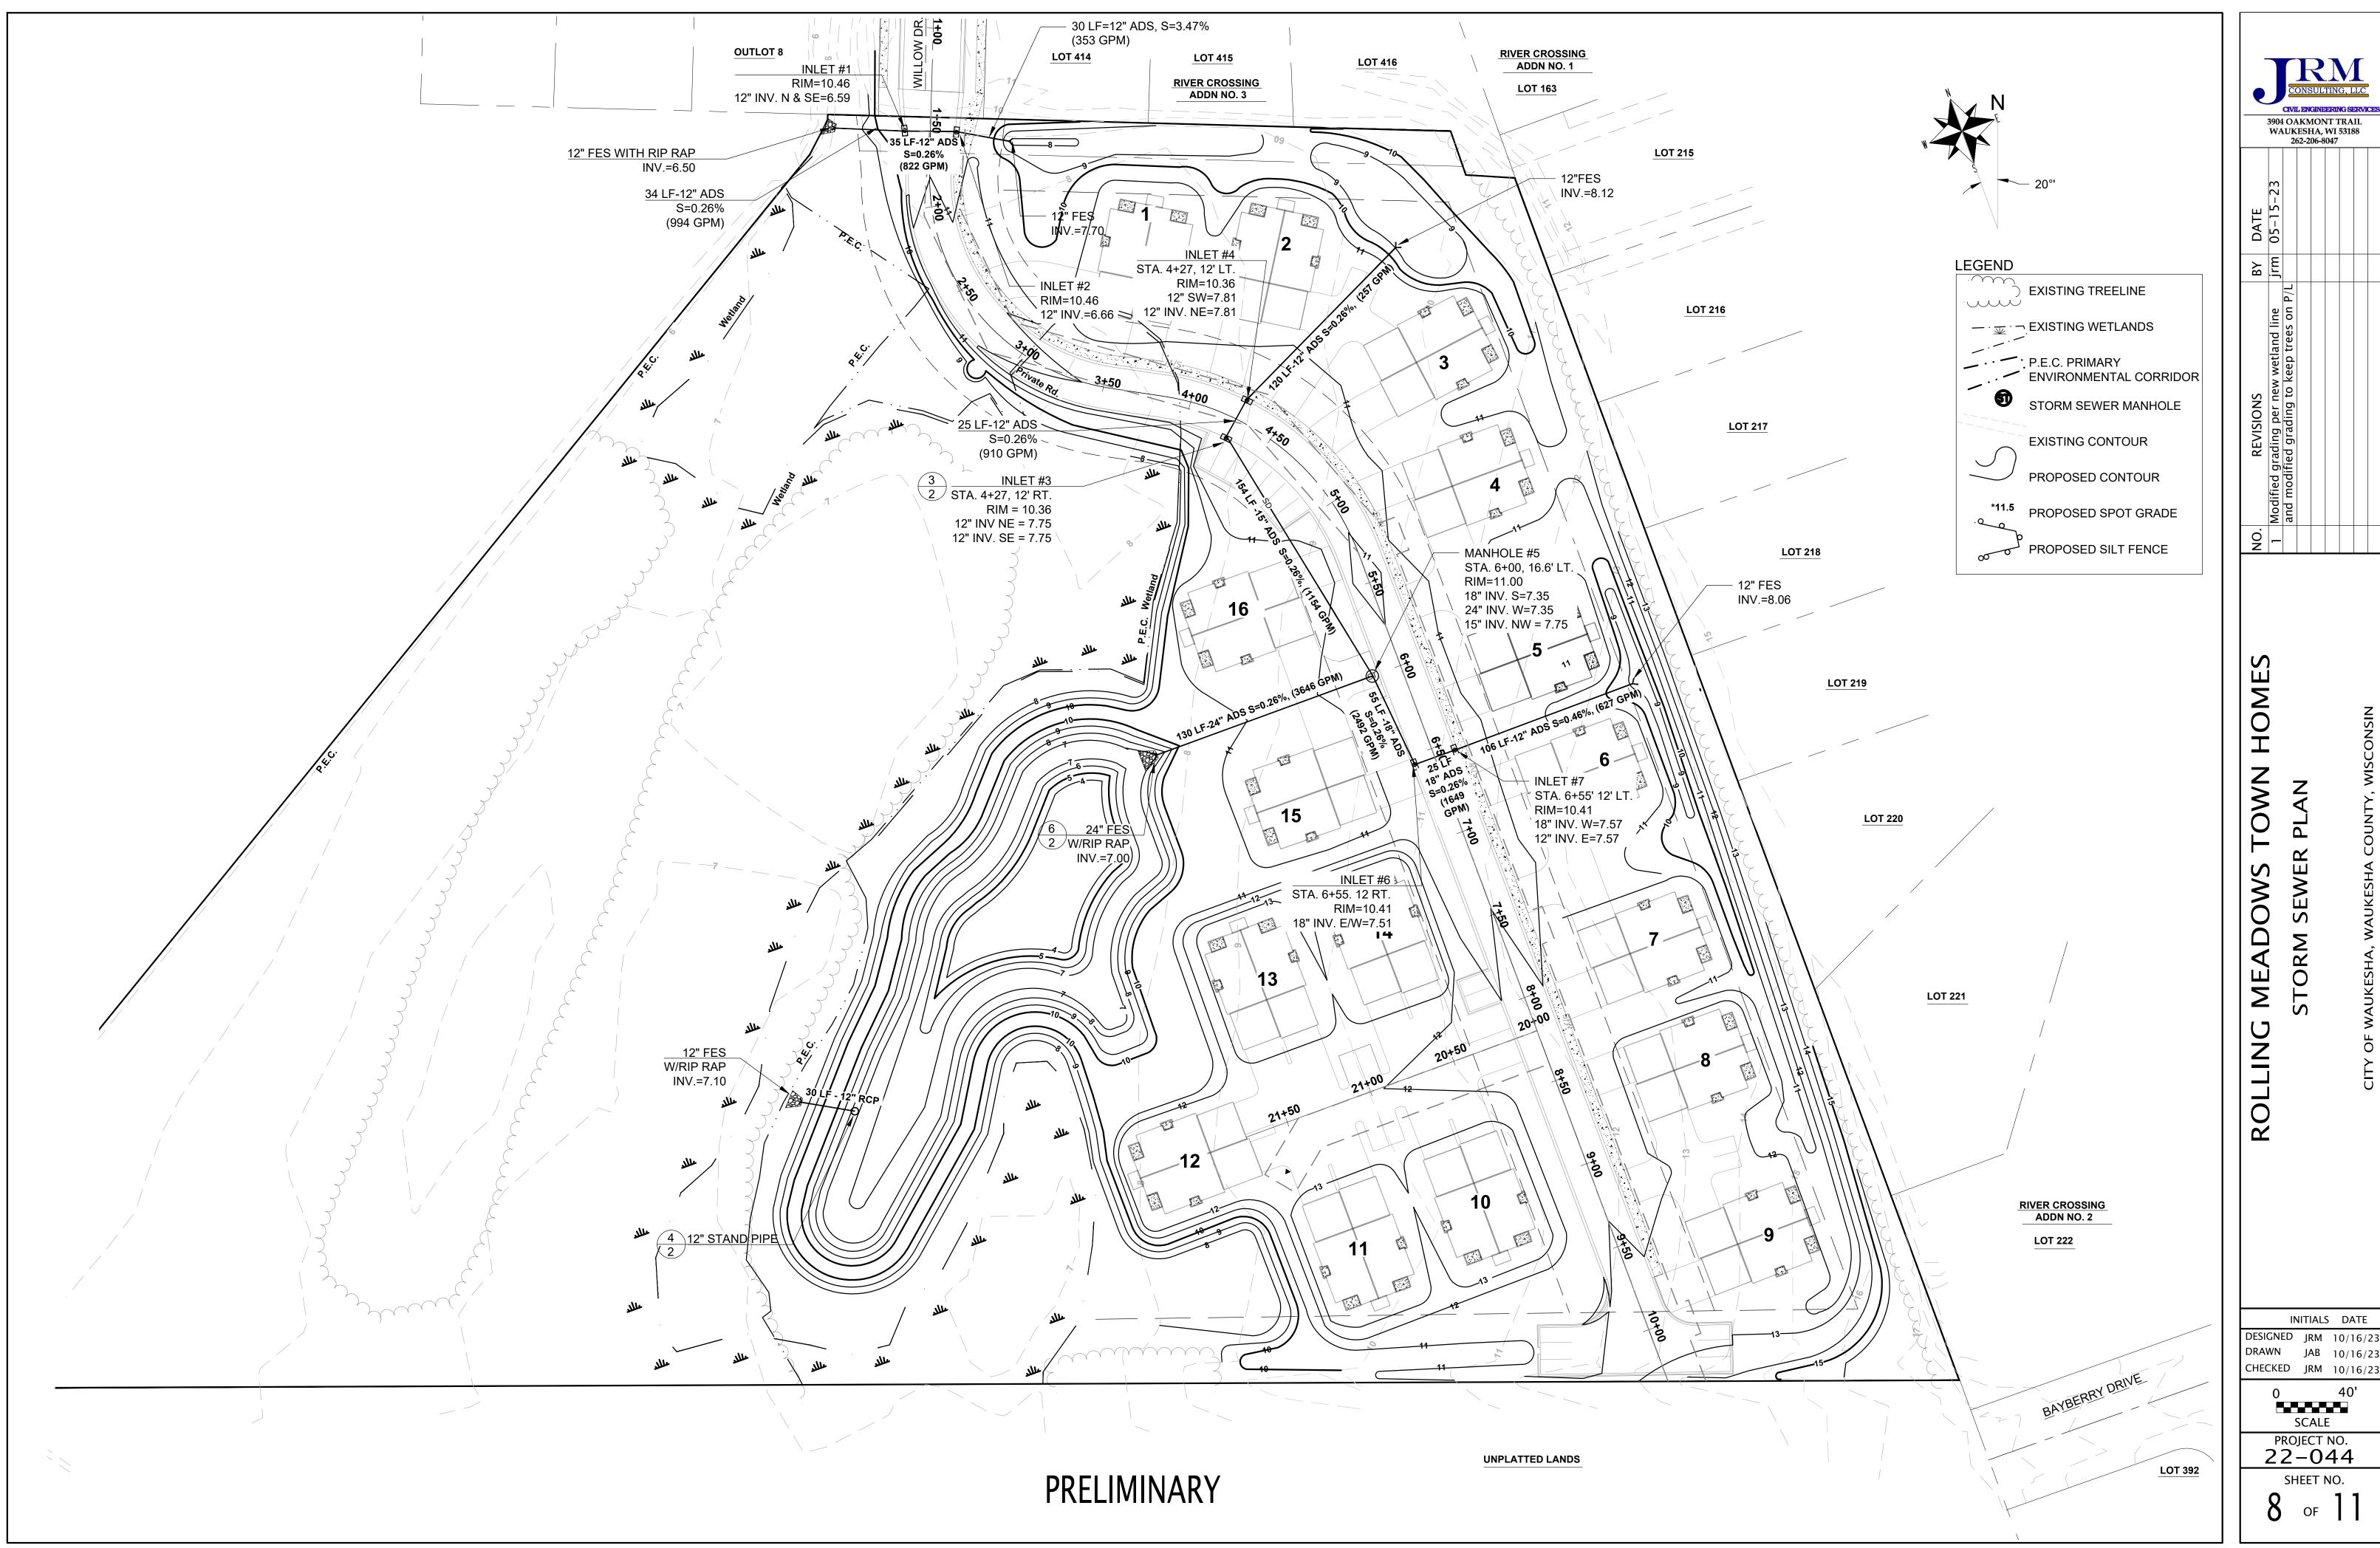





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SCALE

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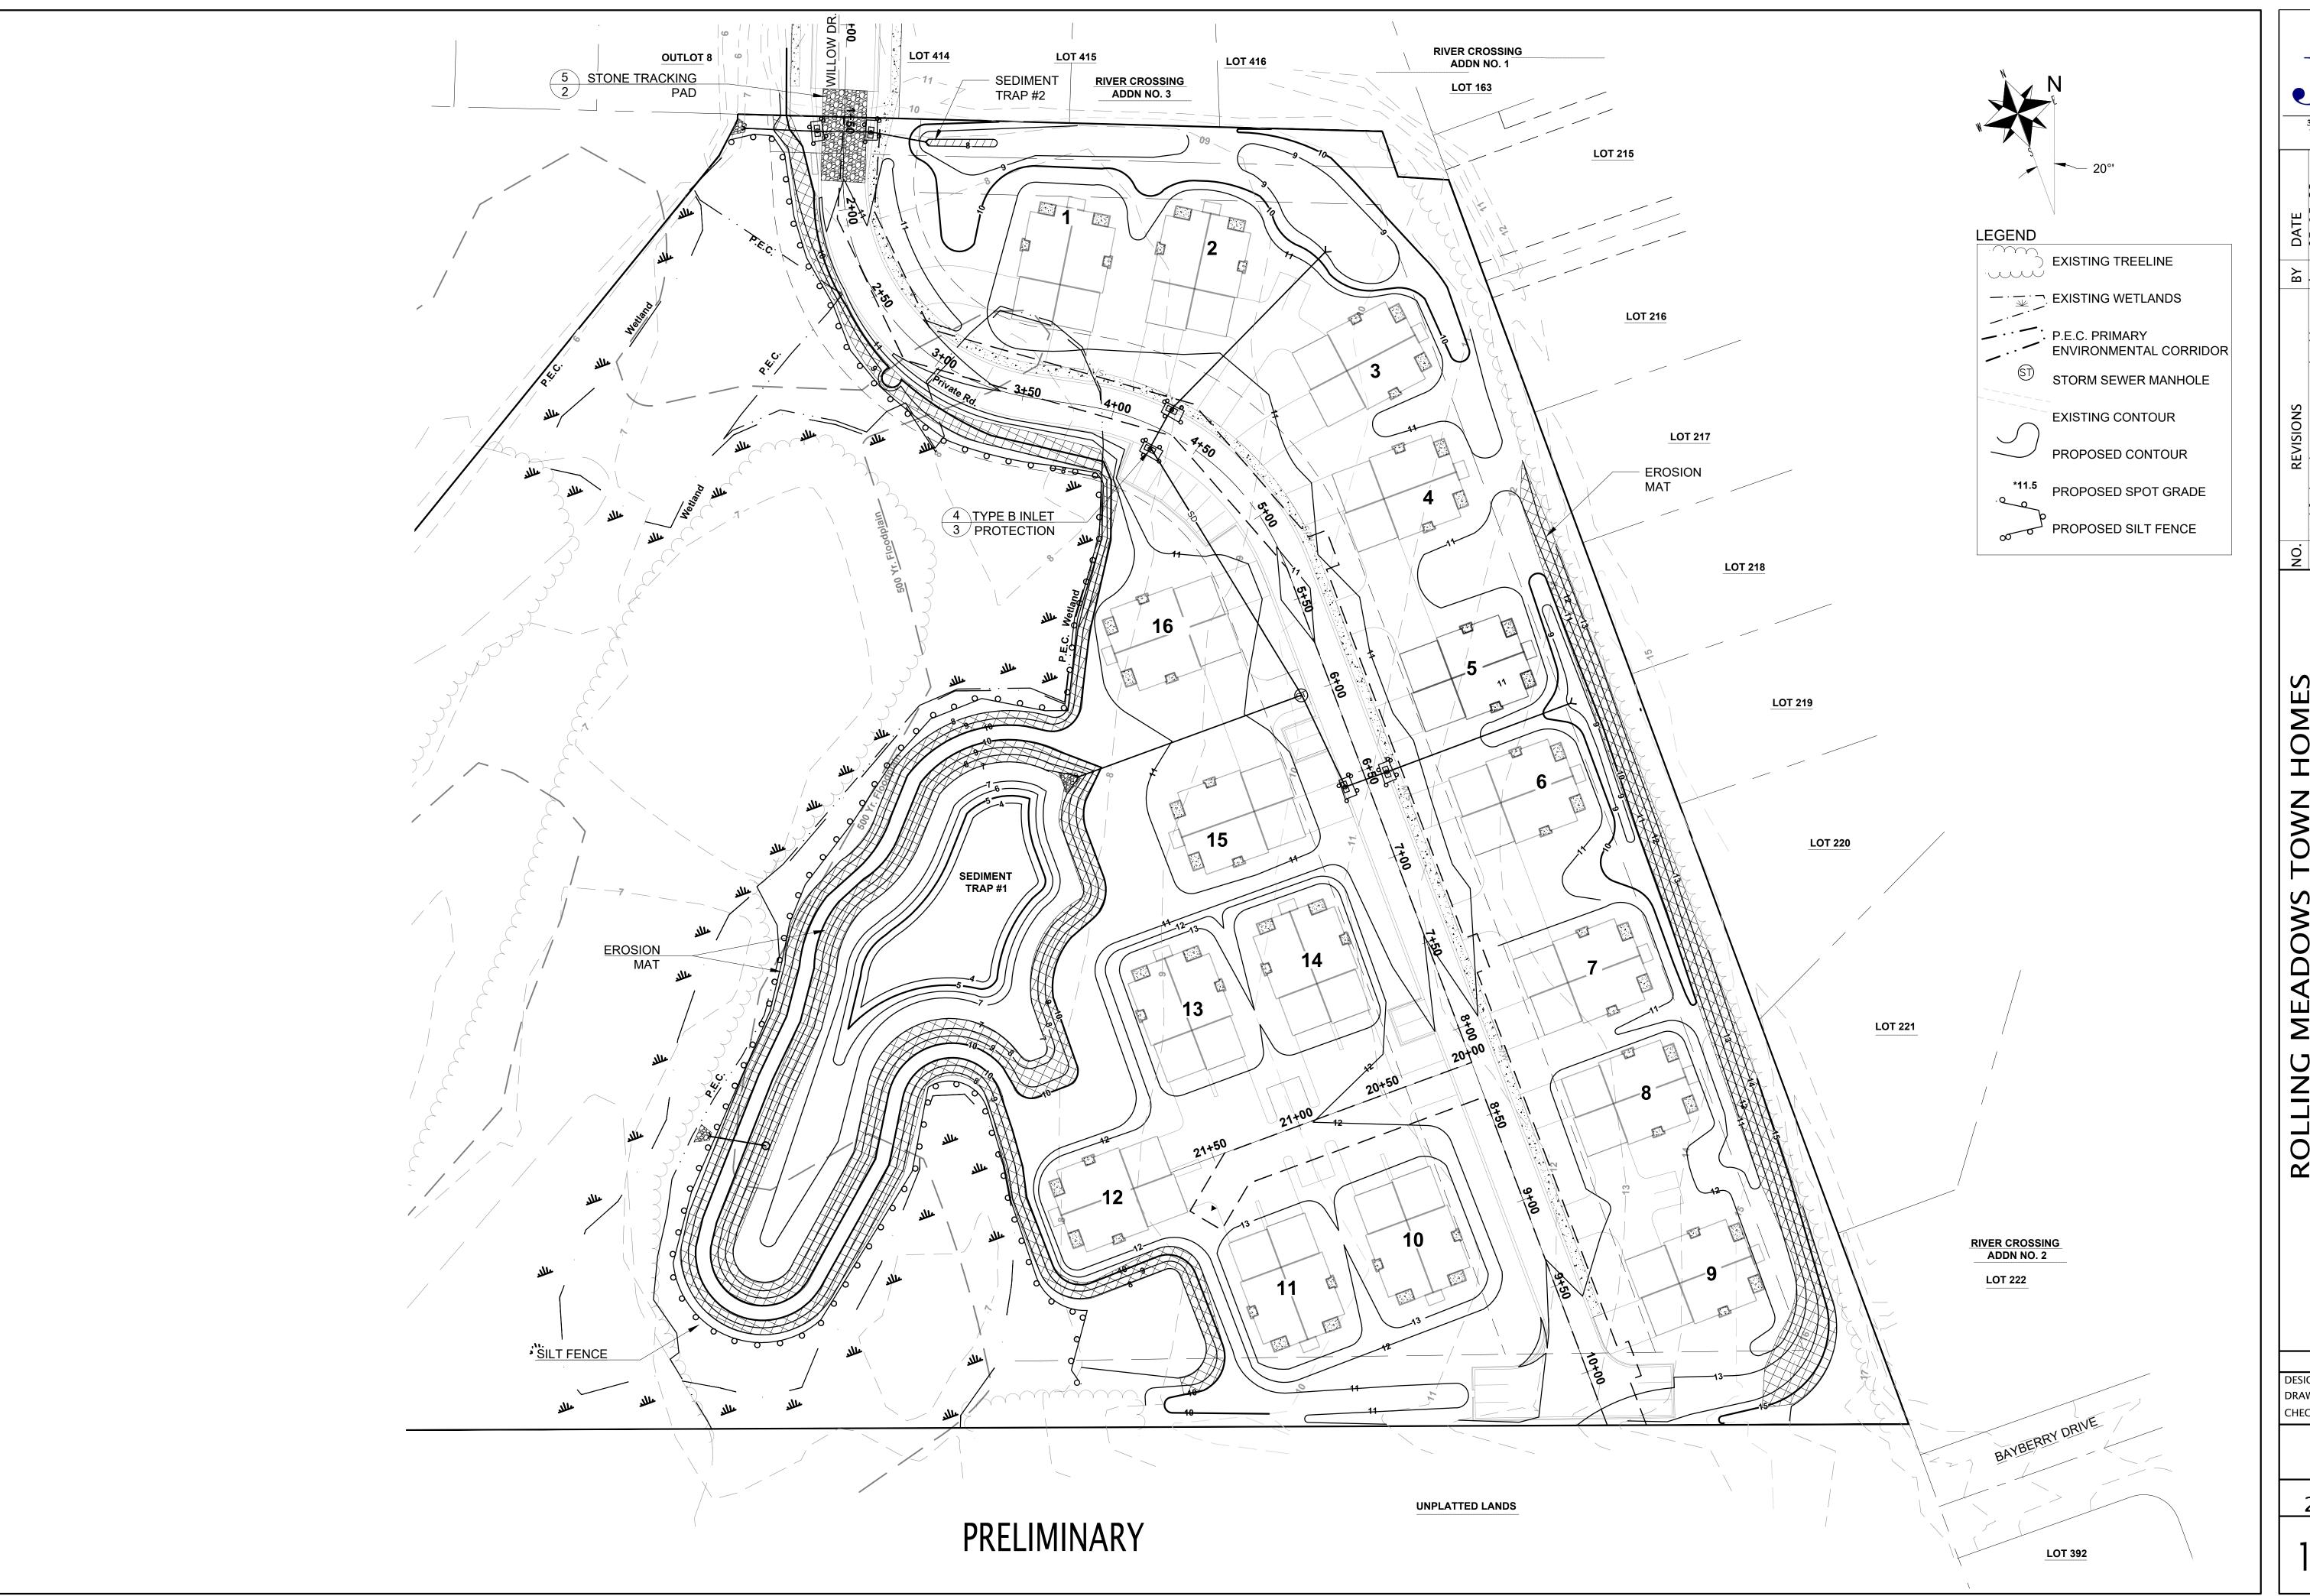
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INITIALS DATE DESIGNED JRM 10/16/23 JAB 10/16/23 CHECKED JRM 10/16/23

PROJECT NO. **22-044**



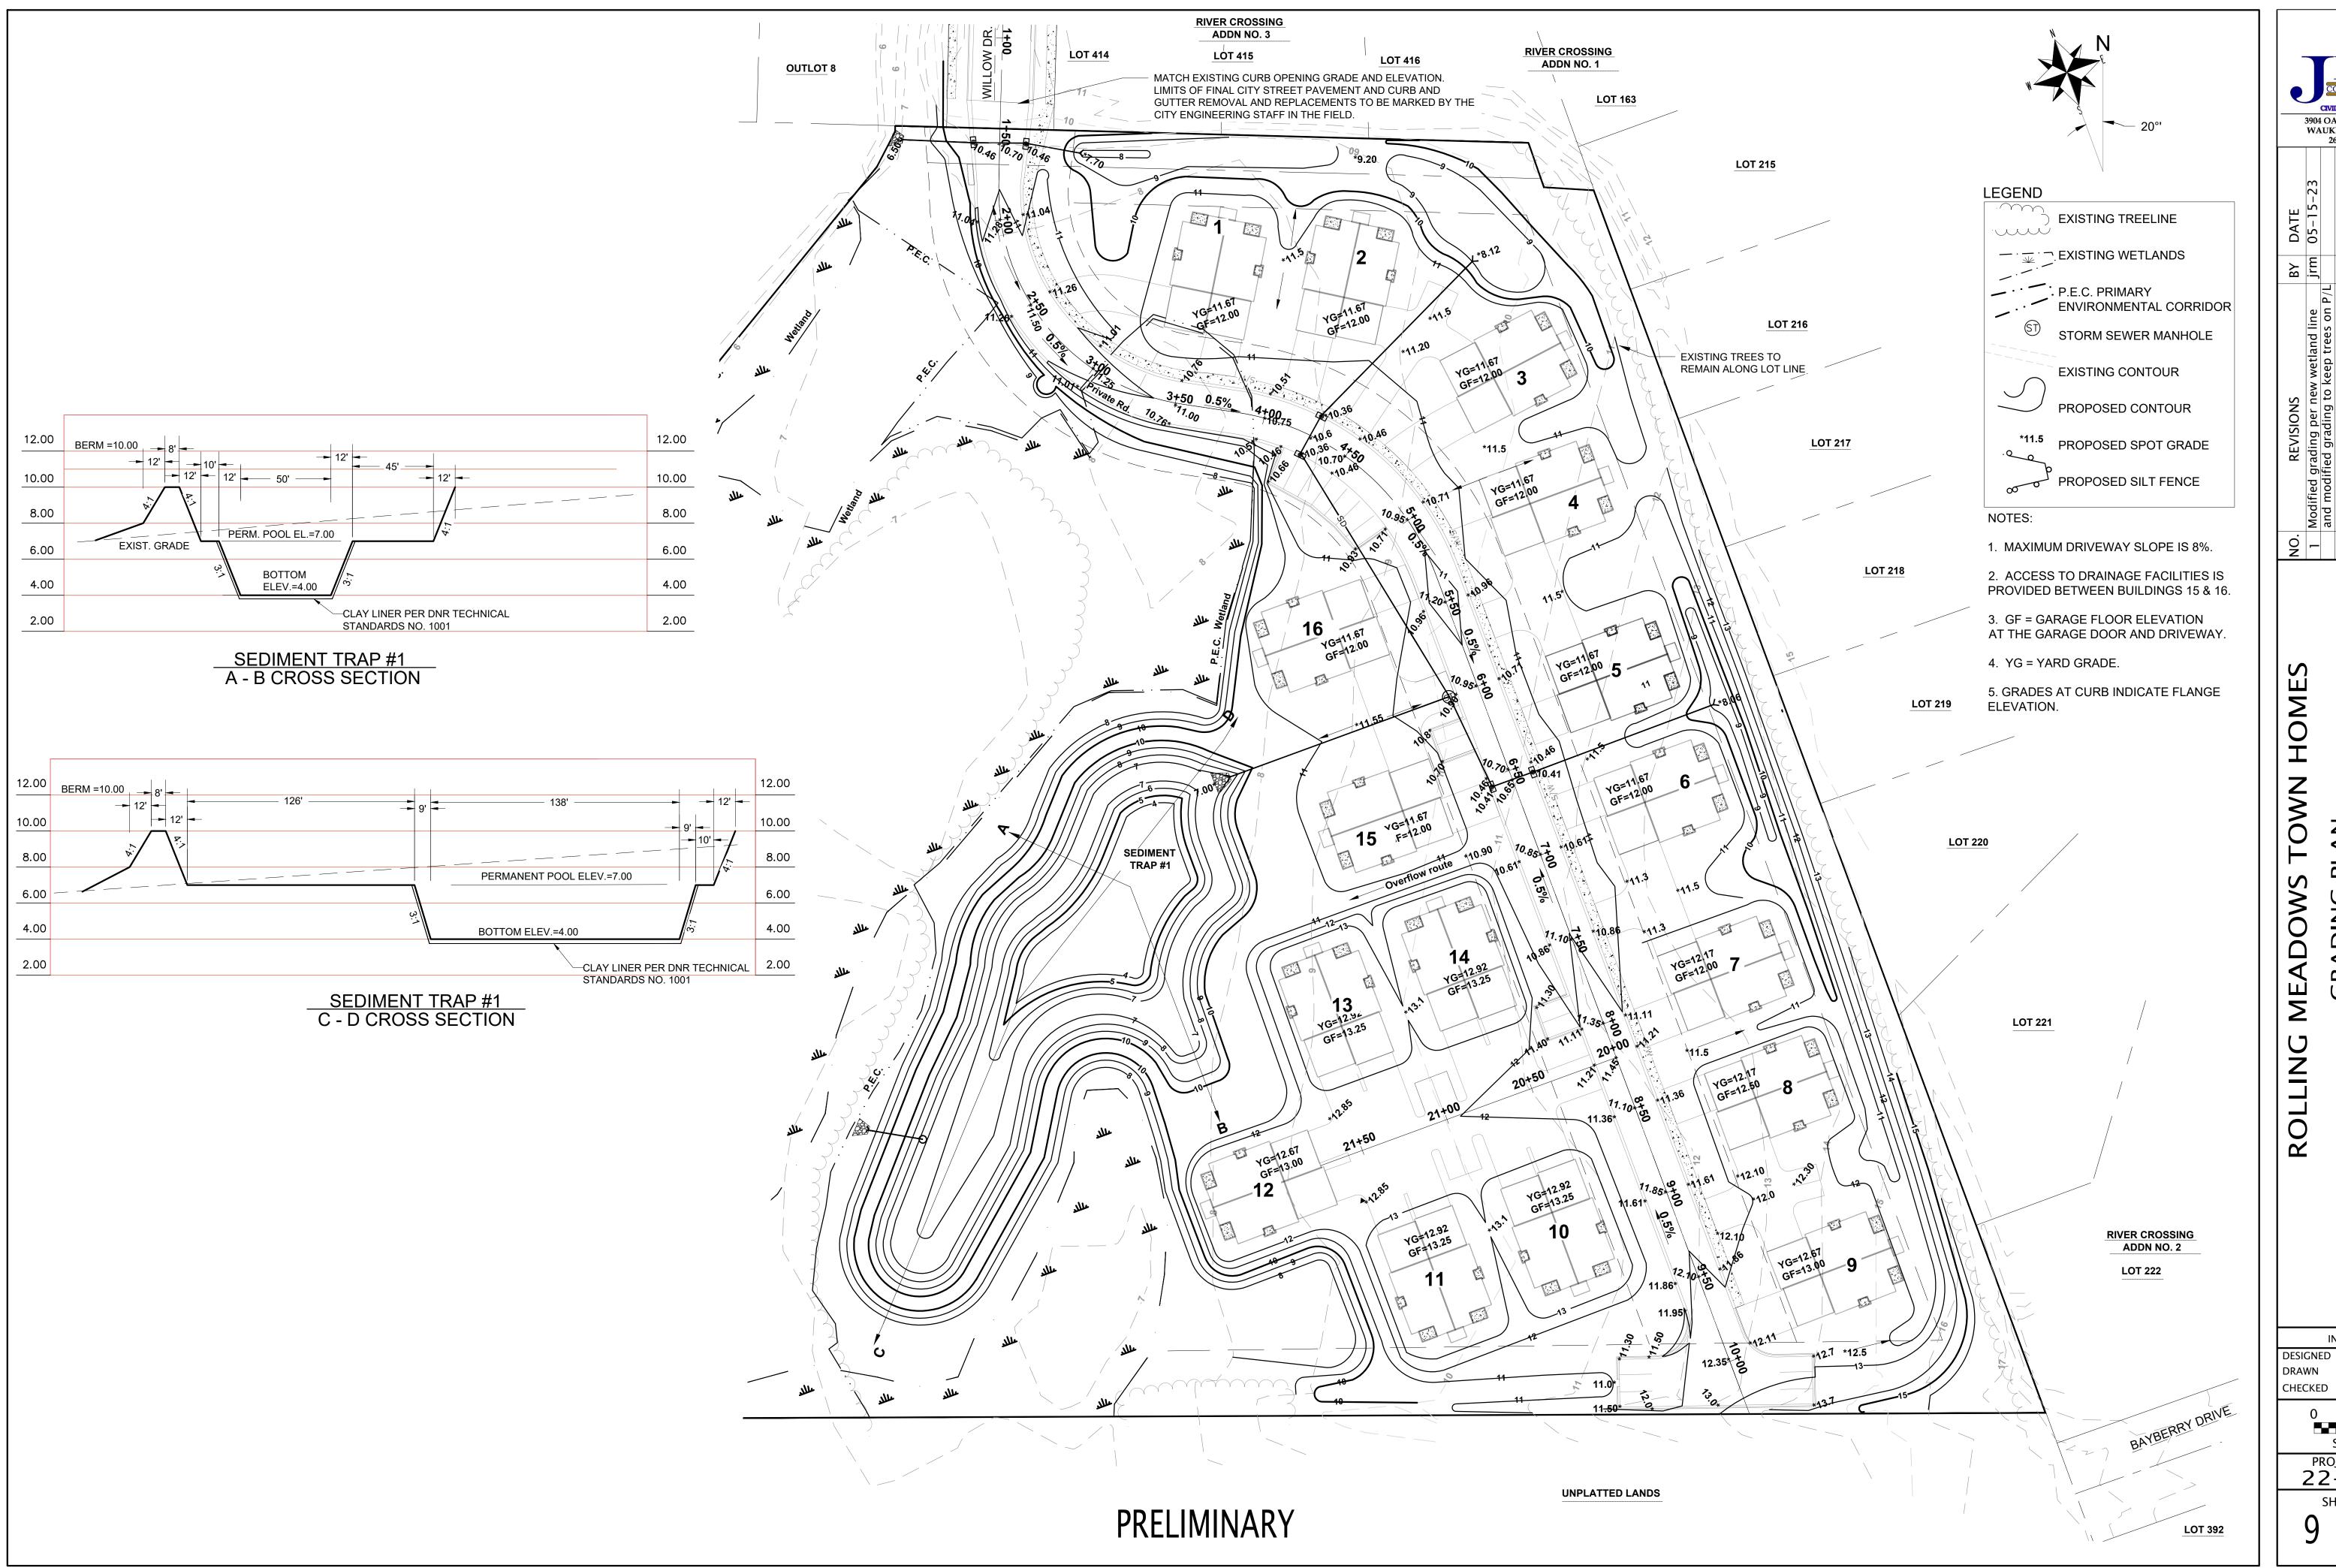

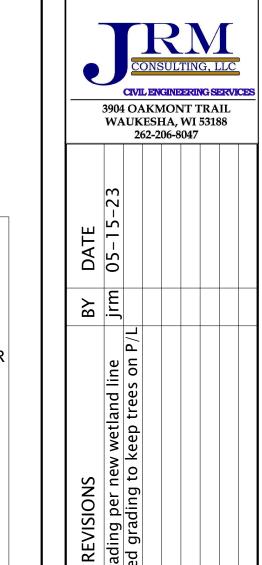REVISIONS

Modified grading per new wetland line
and modified grading to keep trees on P/L

ROLLING MEADOWS LOWN HOME,
EROSION CONTROL PLAN

INITIALS DATE

DESIGNED JRM 10/16/23

DRAWN JAB 10/16/23

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0 40'

SCALE

PROJECT NO. 22-044



SHEET NO.