

Friday | December 18th, 2020

City of Waukesha | Community Development 201 Delafield Street, Suite 200 Waukesha, WI 53188

Project: Hawthorne Elementary School

Site Address: 1111 Maitland Dr

Waukesha, WI 53188

Bray Project Number: 3353

Owner: School District of Waukesha

222 Maple Ave

Waukesha, WI 53186

Applicant / Architect: Bray Architects

829 S 1st Street

Milwaukee, WI 53204

Application for Development Review - Hawthorne Elementary School

Project Description:

The focus for the addition and renovations at Hawthorne Elementary School are to improve overall safety and security for the school, create an ADA compliant entrance, and improve accessibility in the building.

The building addition includes a new secure vestibule into the main office with reception, principal's office, and heath room; an elevator creating accessible access to the main levels of building; and two ADA compliant rest rooms. Interior renovations include creating a classroom in existing office space, the addition of a platform lift at existing stairs to increase accessibility to an additional level of the building, and renovations where the elevator connects to existing space.





City of Waukesha Application for Development Review

City of Waukesha Community Development Department - 201 Delafield Street, Suite 200, Waukesha, WI 53188 262-524-3750 City of Waukesha Department of Public Works Engineering Division—I 30 Delafield Street, Waukesha, WI 53188 262-524-3600 www.waukesha-wi.gov

APPLICANT INFORMATION	PROPERTY OWNER INFORMATION
Applicant Name: Kate Egan	Applicant Name: School District of Waukesha
Applicant Company Name: Bray Architects	Applicant Company Name: School District of Waukesha
Address: 829 S 1st Street	Address: 222 Maple Ave
City, State: Milwaukee, WI Zip: 53228	City, State: Waukesha, WI zip: 53186
Phone: 414-615-7679	Phone: 414-615-7679
_{E-Mail:} kegan@brayarch.com	_{E-Mail:} dclark@waukesha.k12.wi.us
ARCHITECT/ENGINEER/SURVEYOR INFORMATION	PROJECT & PROPERTY INFORMATION
Name: Kate Egan	Project Name: Hawthorne Elementary School
Company Name: Bray Architects	Property Address 1111 Maitland Dr, Waukesha, 53188
Address: 829 S 1st Street	Tax Key Number(s): WAKC 0993.966
City, State: Milwaukee, WI Zip: 53228	Zoning: Institutional - 1
Phone: 414-615-7679	Total Acreage: 6.484 Existing Building Square Footage 47,803
E-Mail: kegan@brayarch.com	Proposed Building/Addition Square Footage: 2,449
	Current Use of Property: Elementary School
us, a COLOR landscape plan, COLOR building elevation plans, and	PDF) and shall include a project location map showing a 1/2 mile radi- exterior lighting photometric maps and cut sheets. A pre-application risions, Planned Unit Developments, and Site and Architectural Plan mmission Reviews is Monday at 4:00 P.M, 30 days prior to
-	vveunesuay of each month.
provided one PDF of all required information. Any missing or incomplete this I also authorize The City of Waukesha or its agents to enter upon the Applicant Signature	
For Internal Use Only:	
Amount Due (total from page 2): Amou	unt Paid: Check #:
Trakit ID(s)	

City of Waukesha Application for Development Review

TYPE OF APPLICATION & FEES (CHECK ALL THAT APPLY) It tailed submittal checklists can be found in Appendix A of the Development Handb	., ,, .,	equirements. De- FEES
□ Plan Commission Consultation \$200		
□Traffic Impact Analysis		
Commercial, Industrial, Institutional, and Other Non-Res	idential \$480	
☐ Residential Subdivision or Multi-Family \$480	idential \$100	
Resubmittal (3rd and all subsequent submittals \$480		
ONE OF THE THREE FOLLOWING ITEMS IS REQUIRED	EOR SITE PLAN & ARCHITECTURAL REVI	IEWS (*).
* Preliminary Site Plan & Architectural Review	FOR SITE FLAN & ARCHITECTORAL REVI	L VV 3 (·).
Level 1: Buildings/additions less than 10,000 sq.ft. or sites	less than I acre \$2 200	
Level 1: Buildings/additions less than 10,000 sq.tc. of sites Level 2: Buildings/additions between 10,001-50,000 sq.ft.		
□ Level 3: Buildings/additions between 50,001-100,000 sq.ft		
□ Level 3: Buildings/additions over 100,001sq.ft. or sites gre		
Resubmittal Fees (after 2 permitted reviews) \$750	sater than 25.01 acres. ψ 2,300	
* X Final Site Plan & Architectural Review		\$1,320
□ Level 1: Buildings/additions less than 10,000 sq.ft. or sites	less than I acre \$1.320	41,020
□ Level 2: Buildings/additions between 10,001-50,000 sq.ft.		
□ Level 3: Buildings/additions between 50,001-100,000 sq.ft.		
□ Level 3: Buildings/additions over 100,001 sq.ft. or sites gre		
Resubmittal Fees (3rd and all subsequent submittals) \$75		
* Minor Site Plan & Architectural Review (total site dis		
Projects that do not require site development plans \$330		
Resubmittal Fees (3rd and all subsequent submittals) \$33		
□ Certified Survey Map (CSM)		
☐ 1-3 Lots \$500		
☐4 lots or more \$560		
☐ Resubmittal (3rd and all subsequent submittals) \$180		
□ Extra-territorial CSM \$260		
□ Preliminary Subdivision Plat (Preliminary Site Plan Review is also re	equired)	
□Up to 12 lots \$1,270	oquii odi,	
□ 13 to 32 lots \$1,390		
□ 36 lots or more \$1,510		
☐ Resubmittal (3rd and all subsequent submittals) \$630		
☐ Final Subdivision Plat (Final Site Plan Review is also required.)		
□Up to 12 lots \$660		
☐ 13 to 32 lots \$ 780		
□ 36 lots or more \$900		
Resubmittal (3rd and all subsequent submittals) \$480		
□ Extra-territorial Plat \$540		
☐Rezoning and/or Land Use Plan Amendment		
☐Rezoning \$630		
□Land Use Plan Amendment: \$630		
☐Conditional Use Permit		
☐ Conditional Use Permit with no site plan changes \$480		
☐Conditional Use Permit with site plan changes \$480 plus	applicable preliminary and final site plan fees above	
☐ Planned Unit Development or Developer's Agreement (Site Plan F		
□ New Planned Unit Development or Developer's Agreem		
☐ Planned Unit Development or Developer's Agreement A		
☐Annexation NO CHARGE		
☐ House/Building Move \$150		
☐Street or Alley Vacations \$150	A CHECK FROM THE SCHOOL	
	DISTRICT OF WAUKESHA WAS _	
TOTAL APPLICATION FEES:	DROPPED OFF ON 12/16/2020	\$1 320

City of Waukesha Development Review Submittal Requirements

PLAN COMMISSION CONSULTATION SUBMITTAL REQUIREMENTS AND ADDITIONAL INFORMATION

A Plan Commission Consultation my be submitted for review and comment for the owner/developer to ascertain the feasibility of a proposed project. A consultation is not required but may be submitted in advance of an actual submittal for a preliminary plat, CSM, Planned Unit Development, rezoning, conditional use or site plan. The Plan Commission will only provide feedback, no approvals will be given. Prior to applying for a Plan Commission Consultation you must discuss your project with the Planning Division to determine if a Plan Commission Consultation is recommended.

Review Time: Approximately 30 days
Reviewing Departments: Community Development Planning Division, Public Works Engineering Division, Fire Department, Water Utility.
Reviewing Boards: Plan Commission (optional)
In addition to this application and corresponding application fee you will also need:
□One (I) digital (PDF) copy of the plans you want conceptual review of □Attachment A: Development Review Checklist. You should also review all other corresponding checklists that relate to the project that you are seeking conceptual review of and include as much information as possible.
☐ Cover letter outlining project details.
TRAFFIC IMPACT ANALYSIS SUBMITTAL REQUIREMENTS AND ADDITIONAL INFORMATION
A Traffic Impact Analysis is required for projects that meet certain criteria. Please refer to the Developer's Handbook Section 4.4 to determine if your project requires a Traffic Impact Analysis
Review Time: Approximately 30 days
Reviewing Departments: Public Works Engineering Division
Reviewing Boards: None, however the Plan Commission may require a copy as part of site plan review process.
In addition to this application and corresponding application fee you will also need:
□One (I) digital (PDF) copy of the Traffic Impact Analysis
PRELIMINARY SITE PLAN & ARCHITECTURAL REVIEW SUBMITTAL REQUIREMENTS AND ADDITIONAL INFORMATION
Preliminary site and architectural plans are required for any new residential development with 4 or more units and all non-residential developments. Preliminary site plan approval is also required for additions or modifications to existing developments and projects where a stormwater management plan is needed. Preliminary approval is required unless it is determined by City staff in the Pre-Application meeting that the project only needs Final Site and Architectural Review.
Review Time: Approximately 30 days (45 if Common Council review is needed)
Reviewing Departments: Community Development Planning Division, Public Works Engineering Division, Fire Department, Water Utility.
Reviewing Boards: Plan Commission. Common Council and Board of Public Works review may be required for certain projects.
In addition to this application and corresponding application fee you will also need:
In addition to this application and corresponding application fee you will also need: One (I) digital (PDF) that includes of items listed below
☐ One (I) digital (PDF) that includes of items listed below
☐ One (I) digital (PDF) that includes of items listed below ☐ Cover letter outlining project details.
□ One (I) digital (PDF) that includes of items listed below □ Cover letter outlining project details. □ Color architectural elevations of all sides of the building and color perspective renderings
 □ One (I) digital (PDF) that includes of items listed below □ Cover letter outlining project details. □ Color architectural elevations of all sides of the building and color perspective renderings □ Conceptual Landscape Plan
 □ One (I) digital (PDF) that includes of items listed below □ Cover letter outlining project details. □ Color architectural elevations of all sides of the building and color perspective renderings □ Conceptual Landscape Plan □ Attachment A: Development Review Checklist
 □ One (I) digital (PDF) that includes of items listed below □ Cover letter outlining project details. □ Color architectural elevations of all sides of the building and color perspective renderings □ Conceptual Landscape Plan □ Attachment A: Development Review Checklist □ Site Plan (see Attachment B: Engineering Plan Checklist)
 □ One (I) digital (PDF) that includes of items listed below □ Cover letter outlining project details. □ Color architectural elevations of all sides of the building and color perspective renderings □ Conceptual Landscape Plan □ Attachment A: Development Review Checklist □ Site Plan (see Attachment B: Engineering Plan Checklist) □ Grading Plan (see Attachment C: Site Grading and Drainage Plan Checklist)
 □ One (I) digital (PDF) that includes of items listed below □ Cover letter outlining project details. □ Color architectural elevations of all sides of the building and color perspective renderings □ Conceptual Landscape Plan □ Attachment A: Development Review Checklist □ Site Plan (see Attachment B: Engineering Plan Checklist) □ Grading Plan (see Attachment C: Site Grading and Drainage Plan Checklist) □ Stormwater Management Plan (see Attachment D: Stormwater Management Plan Checklist)

FINAL SITE PLAN & ARCHITECTURAL REVIEW PLAN SUBMITTAL REQUIREMENTS AND ADDITIONAL INFORMATION
Final site and architectural plans are submitted only after the Plan Commission has approved Preliminary Site Plans for any new residential development with 4 or more units and all non-residential developments, including modifications to existing developments. Some projects may bypass Preliminary approval but only if it is determined by City staff in the Pre-Application meeting.
Review Time: Approximately 30 days (45 if Common Council review is needed)
Reviewing Departments: Community Development Planning Division, Public Works Engineering Division, Fire Department, Water Utility.
Reviewing Boards: Plan Commission. Common Council and Board of Public Works review may be required for certain projects.
In addition to this application and corresponding application fee you will also need:
💢 One (1) digital (PDF) that includes of items listed below
🛮 Cover letter outlining project details.
$ ot\!$ Color architectural elevations of all sides of the building and color perspective renderings
🛮 Landscape Plan (see Attachment I: Landscape Plan Checklist)
X Attachment A: Development Review Checklist
☑ Site Plan (see Attachment B: Engineering Plan Checklist)
☐ Grading Plan (see Attachment C: Site Grading and Drainage Plan Checklist)
N/A \square Stormwater Management Plan (see Attachment D: Stormwater Management Plan Checklist)
N/A□ Utility Plans (see Attachment H: Sewer Plan Review Checklist)
MINOR CITE DI ANI A ARCHITECTURAL REVIEW CURMITTAL REQUIREMENTS AND ARRITONAL INFORMATION
MINOR SITE PLAN & ARCHITECTURAL REVIEW SUBMITTAL REQUIREMENTS AND ADDITIONAL INFORMATION Minor Site and Architectural review is intended for projects that may not need the extensive submittal requirements for Preliminary and Final Site Plan approval. Projects that qualify for Minor Site Plan submittal may include landscape, façade and building changes or minor site modifications that don't result in the addition of impervious surface.
Review Time: Approximately 30 days (45 if Common Council review is needed)
Reviewing Departments: Community Development Planning Division, Public Works Engineering Division, Fire Department, Water Utility.
Reviewing Boards: Plan Commission. Common Council and Board of Public Works review may be required for certain projects.
In addition to this application and corresponding application fee you will also need:
☐ One (I) digital (PDF) that includes of items listed below
Cover letter outlining project details.
☐ Architectural elevations of all sides of the building being modified
□ In addition, depending on the type of project, you may also need the following items:
☐ Site Plan (see Attachment B: Engineering Plan Checklist)
☐ Landscape Plan (see Attachment I: Landscape Plan Checklist)
CERTIFIED SURVEY MAP SUBMITTAL REQUIREMENTS AND ADDITIONAL INFORMATION A Certified Survey Map may be used to divide up to eight (8) lots in Commercial, Industrial, and Mixed Use zoning districts and up to four (4) lots in all other zoning districts.
Review Time: Approximately 45-60 days. An extension letter will be required if the approval process will take more than 90 days.
Reviewing Departments: Community Development Planning Division, Public Works Engineering Division, Fire Department, Water Utility.
Reviewing Boards: Plan Commission. Common Council and Board of Public Works review may be required for certain projects.
In addition to this application and corresponding application fee you will also need:
☐ One (1) digital (PDF) that includes of items listed below
☐ Attachment E: Certified Survey Map Checklist
☐ Attachment A: Development Review Checklist and other attachments as applicable.
*Please note If any exterior architectural, landscape, or site plan changes are required you must also go through Site Plan Review and meet all of those submittal requirements.


PRELIMINARY PLAT SUBMITTAL REQUIREMENTS AND ADDITIONAL INFORMATION									
A Preliminary Plat shall be used to subdivide land in the City. The applicant is responsible for submitting the Preliminary Plat to Waukesha County and the State of Wisconsin for review.									
Review Time: Approximately 45-60 days. An extension letter will be required if the approval process will take more than 90 days.									
Reviewing Departments: Community Development Planning Division, Public Works Engineering Division, Fire Department, Water Utility.									
Reviewing Boards: Plan Commission. Common Council and Board of Public Works review may be required for certain projects.									
In addition to this application and corresponding application fee you will also need:									
☐ One (I) digital (PDF) that includes of items listed below									
☐ Attachment F: Preliminary Plat Checklist									
☐ Cover letter outlining project details.									
☐ Attachment A: Development Review Checklist and other attachments as applicable									
☐ Stormwater Management Plan (see Attachment D: Stormwater Management Plan Checklist)									
FINAL PLAT SUBMITTAL REQUIREMENTS AND ADDITIONAL INFORMATION									
A Final plat shall be used to subdivide land in the City. The applicant is responsible for submitting the Final Plat to Waukesha County and the State of Wisconsin for review.									
Review Time: Approximately 45-60 days. An extension letter will be required if the approval process will take more than 90 days.									
Reviewing Departments: Community Development Planning Division, Public Works Engineering Division, Fire Department, Water Utility.									
Reviewing Boards: Plan Commission. Common Council and Board of Public Works review may be required for certain projects.									
In addition to this application and corresponding application fee you will also need:									
☐ One (I) digital (PDF) that includes of items listed below									
☐ Attachment G: Final Plat Checklist									
☐ Cover letter outlining project details.									
☐ Attachment A: Development Review Checklist and other attachments as applicable.									
☐ Stormwater Management Plan (see Attachment D: Stormwater Management Plan Checklist)									
REZONING & COMPREHENSIVE PLAN AMENDMENT SUBMITTAL REQUIREMENTS AND ADDITIONAL INFORMATION									
This review is for any requests to rezone land or amend the City's Comprehensive Master Plan. For rezonings all property owners within 300 feet of the property will be notified of your request.									
Review Time: 45-60 Days									
Reviewing Departments: Community Development Planning & Building Inspection Divisions, Public Works Engineering Division, Fire Department, Water Utility.									
Reviewing Boards: Plan Commission, Common Council									
Additional Information: Rezonings must be done in accordance with the Comprehensive Plan. Please consult with Planning staff to determine if a Comprehensive Plan Amendment is also required prior to submitting a rezoning application.									
In addition to this application and corresponding application fee you will also need:									
☐ One (I) digital (PDF) that includes of items listed below									
☐ Cover letter outlining project details and rationale for rezoning									
☐ Rezoning Form including legal description and notarized owner(s) signatures (rezoning applications only)									
☐ Conceptual Plan (if applicable)									
*Please note this application fee only covers the rezoning and/or Comprehensive Plan Amendment. If you are proposing site plan changes or are subdividing land									

you will also need to meet the applicable submittal requirements for those proposals.

CONDITIONAL USE PERMIT SUBMITTAL REQUIREMENTS AND ADDITIONAL INFORMATION
Any use listed as a Conditional Use in Chapter 22 (Zoning Code) requires a Public Hearing in front of the Plan Commission prior to building or occupancy permits being issued. All property owners within 300 feet of the property will be notified of your request.
Review Time: 30-45 days
Reviewing Departments: Community Development Planning & Building Inspection Divisions, Public Works Engineering Division, Fire Department, Water Utility.
Reviewing Boards: Plan Commission
In addition to this application and corresponding application fee you will also need:
\square One (I) digital (PDF) that includes of items listed below
☐ Conditional Use Permit Application
*Please note If any exterior architectural, landscape, or site plan changes are required you must also go through Site Plan Review and meet all of those submittal requirements.
PLANNED UNIT DEVELOPMENT OR DEVELOPER'S AGREEMENT SUBMITTAL REQUIREMENTS AND ADDITIONAL INFORMATION
The PUD Overlay District is intended to permit development that will, over a period of time, be enhanced by coordinated area site planning, diversified ocation of structures, diversified building heights and types, and/or mixing of compatible uses. The PUD Overlay District under this Chapter will allow for flexibility of overall development design with benefits from such design flexibility intended to be derived by both the developer and the community,
while at the same time maintaining insofar as possible the standards or use requirements set forth in the underlying basic zoning district.
Developer's Agreements are used for any project that require public infrastructure improvements (sewer, storm sewer, sidewalks, etc) and other offsite improvements such as median openings, traffic signals, street widening, etc
Review Time: 45-60 days
Reviewing Departments: Community Development Planning & Building Inspection Divisions, Public Works Engineering Division, Fire Department, Water Utility.
Reviewing Boards: Plan Commission, Common Council. Some projects will also require Board of Public Works review.
In addition to this application and corresponding application fee you will also need:
\square One (I) digital (PDF) that includes of items listed below
□ Cover letter/statement that outlining project details and all of the required information set forth in the Zoning Ordinance Section 22.52 (4)(a)
\square Rezoning Form including legal description and notarized owner(s) signatures (rezoning applications only)
General Development Plan
☐ Proposed Supplemental Design Elements (required for all PUDs under the minimum required acreage) *Please note in addition to the PUD submittal requirements your project will also need additional application fees and submittal materials based on the project type. This may include Preliminary and Final Plats, Preliminary and Final Site and Architectural Plans, Certified Survey Maps, Traffic Impact Analysis. Staff will inform
you of any additional submittal requirements at the Pre-Application meeting, which is required prior to submitting your application.
ANNEXATION SUBMITTAL REQUIREMENTS AND ADDITIONAL INFORMATION
Requests for annexation as permitted under Section 66.0217 Wisconsin Statutes.
Review Time: 45-60 days
Reviewing Departments: Community Development Planning & Building Inspection Divisions, Public Works Engineering Division, Fire Department, Water Utility.
Reviewing Boards: Plan Commission, Common Council
In addition to this application and corresponding application fee you will also need:
\square One (I) digital (PDF) that includes of items listed below
\square Copy of your State of Wisconsin Request for Annexation Review Application
☐ Signed City of Waukesha Direct Annexation Petition
\square Map of property of property to be annexed.
\square A boundary description (legal description of property to be annexed)
\square Any additional information on the annexation.

IOUSE/BUILDING MOVE SUBMITTAL REQUIREMENTS AND ADDITIONAL INFORMATION
ny application to move a home or building from one location to another in the City requires review by staff and the Plan Commission.
eview Time: 30-45 days
leviewing Departments: Community Development Planning & Building Inspection Divisions, Public Works Engineering Division, Fire Department, Vater Utility, Police Department, Any affected Public Utilities
leviewing Boards: Plan Commission
addition to this application and corresponding application fee you will also need:
One (1) digital (PDF) that includes of items listed below
\square Address of existing structure and address of final destination for structure
\square Site Plan showing location of house/building at the new location
☐ Proposed route for moving structure. Should also include any overhead wires, mailboxes, or other obstructions that will need to be tem porarily relocated to allow for the house/building to get to the new site.
TREET VACATIONS
treet Vacations must be reviewed and approved by the Plan Commission.
eview Time: 45-60 days
Leviewing Departments: Community Development Planning & Building Inspection Divisions, Public Works Engineering Division, Fire Department, Vater Utility.
eviewing Boards: Plan Commission, Common Council
addition to this application and corresponding application fee you will also need:
One (1) digital (PDF) that includes a map and legal description of the areas to be vacated.

HAWTHORNE ELEMENTARY SCHOOL SCHOOL DISTRICT OF WAUKESHA

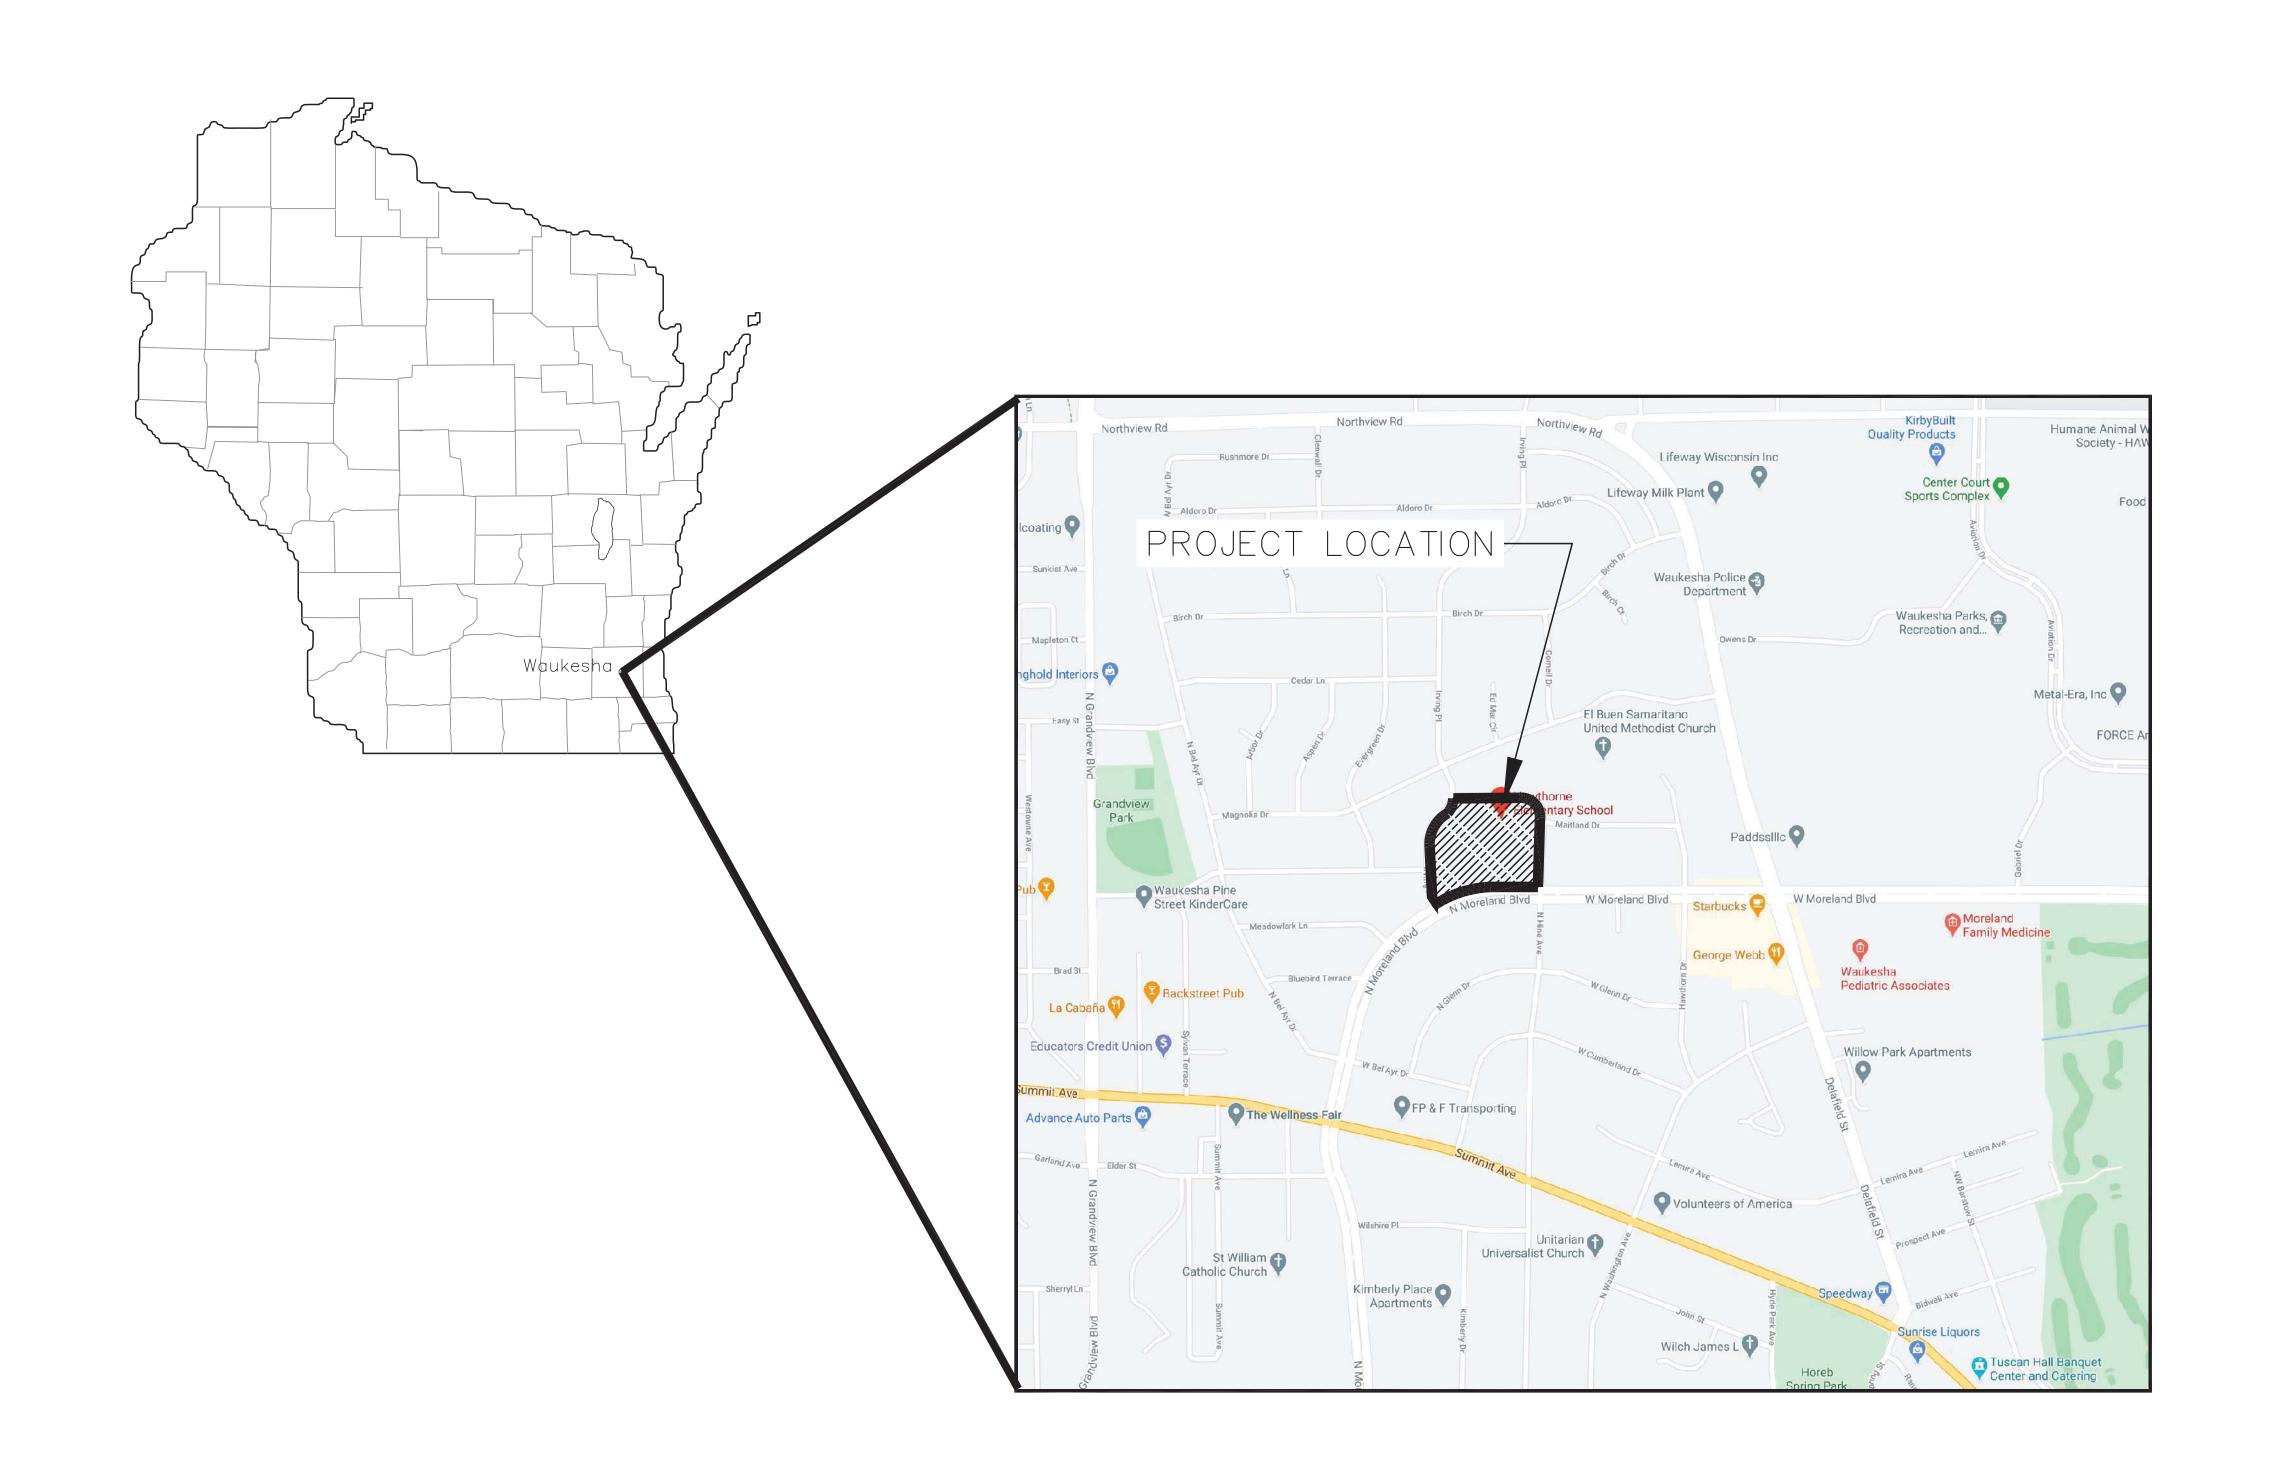

INDEX TO DRAWINGS

SHEET NO. TITLE

T1.1 TITLE SHEET & LOCATION MAP

C1.0 PLAT OF SURVEY WITH TOPOGRAPHY

C1.1 SITE DEMOLITION PLAN

C1.2 SITE LAYOUT & GEOMETRIC PLAN

C1.3 SITE GRADING & EROSION CONTROL PLAN

C2.1 SITE DETAILS







NOT FOR

CONSTRUCTION

Office Locations:

Davenport, IA 52801

Milwaukee

Milwaukee, Wisconsin 53204 T: 414.226.0200

PO Box 955 Sheboygan, Wisconsin 5308

www.brayarch.com

Milwaukee, WI 53217 www.kapurinc.com

Project Number:

3353 - M

Issued For:
PLAN
COMMISSION
REVIEW
DECEMBER 18, 2020
Sheet Title:
TITLE SHEET &
LOCATION MAP

Sheet Number:

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SURVEY INFORMATION

1) BEARINGS ARE BASED ON THE WISCONSIN STATE PLANE COORDINATE SYSTEM SOUTH ZONE NAD 27.

2) ELEVATIONS ARE BASED ON NGVD 29 DATUM.

3) EXISTING TOPOGRAPHY IS BASED ON FIELD SURVEY TAKEN ON 3/24/2020 BY KAPUR & ASSOCIATES, INC.

4) REFER TO PLAT OF SURVEY, SHEET C1.0 FOR ADDITIONAL INFORMATION.



*ALL SITE IMPROVEMENTS AND CONSTRUCTION SHOWN ON THE PLANS SHALL CONFORM TO THE CITY OF WAUKESHA DEVELOPMENT HANDBOOK & INFRASTRUCTURE SPECIFICATIONS. WHERE THE PLANS DO NOT COMPLY, IT SHALL BE THE SOLE RESPONSIBILITY AND EXPENSE OF THE DEVELOPER TO MAKE REVISIONS TO THE PLANS AND/OR CONSTRUCTED INFRASTRUCTURE TO COMPLY.

PLAT OF SURVEY WITH TOPOGRAPHY

CITY OF WAUKESHA BENCHMARK,

"OPEN" BOLT

MAITLAND DRIVE

(60' R/W)

MH RIM 153.11 8" IE 142.89 E 8" IE 142.91 W

S88°43'58"W 371.90'

MULTI STORY BRICK

COMMERCIAL BUILDING 47,803 SQ. FT. ±

ASPHALT PLAY AREA

HAWTHORNE ELEMENTARY SCHOOL

Area: 282,428 SQ. FT. 6.484 AC. ±

8" IE 134.27 E 6" IE 134.52 W

GRAVEL

10" PVC IE 127.46 W

N88°05'58"E 181.00


INLT RIM 129.34— 12" RCP IE 125.09 E

12" RCP IE 125.04 W 12" RCP IE 124.64 S

ADJ RINGS:2-2" CONC


MH:CC CB:CURB


6" IE 134.52 N (TO BLDG)

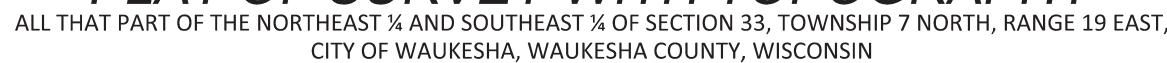



CURVE TABLE							
CURVE	LENGTH	RADIUS	CHORD	CHORD DIR			
C1	143.67	90.809'	129.15	N45°56'32"W			
C2	134.29	204.749	131.89'	S33°43'24"W			
С3	140.17	151.160'	135.20'	S25°56'51"W			
C4	121.11'	292.575	120.25	S12°28'35"E			
C5	16.12'	292.575	16.12'	S25°54'50"E			
C6	75.55'	914.342'	75.53'	N66°48'00"E			
C7	302.13'	914.342'	300.76	N78°38'00"E			

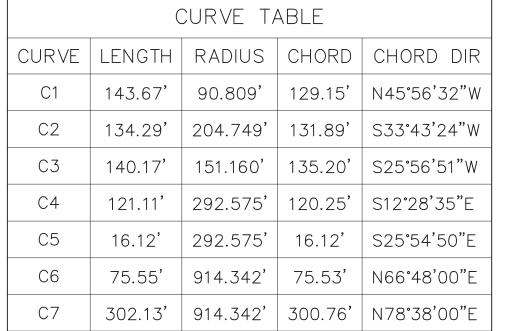

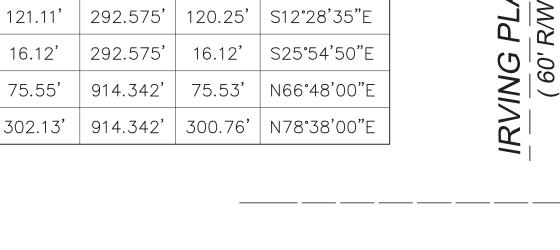

PINE STREET

2,708.31' S88°05'58"W TOTAL

THE SOUTH LINE OF THE NE 1/4 OF SEC-33-7-19

ADJ RINGS:1-2" CONC MH:CB ≤

INL RIM 130.18 + 12" RCP IE 125.98 SE

MH:CB CB:CURB

12" RCP IE 125.15 S 12" RCP IE 125.25 N



→ = LIGHT POLE • = POWER POLE

⊚guy = GUY WIRE POLE

(W) = WATER MANHOLE

 \boxplus = INLET

 \boxplus = CURB INLET

 \oslash = GAS VALVE

○ = LIGHT POLE WITH MAST

= TREE (CONIFEROUS) DRIP LINE SCALABLE () = TREE (DECIDUOUS) DRIP LINE SCALABLE

BEARINGS ARE BASED ON THE

SYSTEM SOUTH ZONE NAD 27.

CITY OF WAUKESHA DATUM

LEGEND

 \triangle = CONTROL POINT

 $O = 1 \frac{1}{4}$ " IRON PIPE O.D.

 \bullet = 1-1/4" O.D.x 18"LONG. IRON PIPE SET,

= SECTION CORNER MON.

O.D. = OUTSIDE DIAMETER

(MH) = MANHOLE TYPE NOTED

(SA) = SANITARY SEWER MANHOLE (ST) = STORM SEWER MANHOLE (E) = ELECTRIC MANHOLE (T) = TELEPHONE MANHOLE

(R.A.) = RECORDED AS

 \otimes = WATER VALVE

 \odot = FIRE HYDRANT

970.90= SPOT ELEVATION

☼ ♦ BUSH, SHRUB

 \bigcirc = BOULDER

 \mathbb{P} = PULLBOX

FOUND OR AS NOTED

WEIGHING 1.68 LBS./FT.

WISCONSIN STATE PLANE COORDINATE

oco = CLEANOUT OFLAG = FLAG POLE

OMP = UTILITY MARKER POST

□ = UTILITY CONTROL BOX

FL. EL. = FIRST FLOOR ELEVATION

= BUILDING OUTLINE

 \longrightarrow 3 \longrightarrow = MINOR CONTOUR ----5 = MAJOR CONTOUR → = FENCE = BEAM GUARD

----×---- = CHAINLINK FENCE = WOODED AREA/SHRUB EDGE ----- W----- = WATER MAIN

----- st ---- = STORM SEWER ----- SAN----- = SANITARY SEWER ———— G———— = NATURAL GAS MAIN — T — = UNDERGROUND TELEPHONE ——— E — UNDERGROUND ELECTRIC

——— OH——— = OVERHEAD UTILITY LINES ——— FO ——— = UNDERGROUND FIBER OPTIC ----- TV ----- = UNDERGROUND CABLE TV — C — = COMMUNICATION CONDUIT

= ASPHALT SURFACE

CONCRETE SURFACE = WETLANDS

CURVE; THENCE 137.23 FEET ALONG SAID EAST LINE AND THE ARC OF A CURVE HAVING A CHORD BEARING SOUTH 13°32'15" EAST, 135.98 FEET TO THE END OF SAID CURVE: THENCE SOUTH 24°51'35" EAST ALONG SAID EAST LINE, 13.86 FEET TO THE NORTH LINE OF N. MORELAND BLVD.; THENCE 377.68 FEET ALONG SAID NORTH LINE AND THE ARC OF A CURVE HAVING A CHORD BEARING NORTH 76°47' EAST, 375.00 FEET TO THE END OF SAID CURVE; THENCE NORTH 88°37' EAST ALONG SAID NORTH LINE, 181.33 FEET TO THE POINT OF BEGINNING.

12" RCP IE 125.8 NW 12" RCP IE 125.78 S

FOR INFORMATIONAL PURPOSES ONLY

PROPERTY ADDRESS: 1111 MAITLAND DRIVE, WAUKESHA, WI 53188 TAX KEY NO.: WAKC 0993.966

BASIS OF BEARINGS

134.668

BEARING ARE REFERENCED TO WISCONSIN STATE PLANE COORDINATE SYSTEM SOUTH ZONE NAD 27. ELEVATIONS ARE BASED ON NGVD 29 DATUM

FLOOD NOTE

6" IE 134.33 E (BTWN DUMPSTERS)

VEHICULAR ACCESS

TO IRVING PLACE

6" IE 125.23 NNE 8" IE 124.98 S

MH:CB STAIRS:FAIR

6" IE 134.28 SW

ASPHALT PARKING

DIAMOND

ACCORDING TO THE FLOOD INSURANCE RATE MAP OF THE CITY OF WAUKESHA, COMMUNITY PANEL NO. 55133C0213G, EFFECTIVE DATE OF NOVEMBER 5, 2014, THIS SITE FALLS IN ZONE X (AREAS DETERMINED TO BE OUTSIDE THE 0.2% ANNUAL CHANCE FLOODPLAIN).

	CONTROL POINTS							
POINT NO.	NORTHING	EASTING	ELEVATION	DESCRIPTION				
200	379010.190	2468831.053	146.50	CP PK				
201	378666.827	2468322.461	134.43	CP PK				
202	379179.258	2468328.063	147.06	CP PK				
203201774	378650.423	2468284.948	134.67	BM, ARROW BOLT ON HYDRANT, EAST SIDE OF IRVING PLACE 20' N. OF PINE ST.				
203241101	379050.300	2468443.254	152.95	BM, OPEN BOLT, HYDRANT NE CORNER OF IRVING PL.& MAITLAND DR				

8" IE 138.48 W 8" IE 138.43 SE

ADJ RINGS:5-2" CON

8" IE 133.51 NW 8" IE 133.46 SE

CONC MH:CC STAIRS:FAIR

6" IE 128.72 S 8" IE 128.82 NW

6" IE 129.37 W 6" IE 129.32 N

MH:CB STAIRS:POOR

12" RCP IE 125.5

12" RCP IE 125.7 !

MAITLAND DRIVE

(60' R/W)

Toll Free (800)242-8511 Milwaukee Area (414)259-1181 Hearing Impaired TDD (800)542-2289 www.DiggersHotline.com REGISTER'S HOTLINE TICKETS:

20201108133,20201108145, 20201108210, 20201108211, 20201108250, 20201108252, 20201108264, 20201108267 ALTHOUGH DIGGERS' HOTLINE WAS NOTIFIED THIS SURVEY DOES NOT GUARANTEE THAT ALL UTILITIES HAVE BEEN LOCATED ON SITE. SOME OF THE UTILITIES MAY HAVE BEEN DRAWN IN PER PLAN BASED ON MAPS RECEIVED FROM MEMBERS NOTIFIED. LACKING EXCAVATION THE EXACT LOCATION OF UNDERGROUND FEATURES CANNOT BE ACCURATELY, COMPLETELY AND RELIABLY DEPICTED. WHERE ADDITIONAL OR MORE DETAILED INFORMATION IS REQUIRED, THE CLIENT IS ADVISED THAT EXCAVATION MAY BE NECESSARY.

SURVEYOR'S CERTIFICATE:

→MH RIM 129.72

MH:CB

12" RCP IE 125.5 N

12" RCP IE 125.42 W

I, Brian Sandberg do hereby certify that that under My direction and control the the above described property was surveyed on 3/24/2020 in accordance with AE-7 of the Wisconsin Administrative Code and is correct to the best of my

Brian E. Sandberg ∨ S-2500 APRIL ##, 2020



Milwaukee, Wisconsin 53217

kapurinc.com

PROJECT:

NE 1/4 CORNER SECTION 33 T7N

R19E CON MON W/ SEWRPC BRASS CAP

HAWTHORNE ELEMENTARY SCHOOL

LOCATION:

1111 MAITLAND DR WAUKESHA, WI 53188

CLIENT:

SCHOOL DISTRICT OF WAUKESHA


RELEASE: DRAFT


DESCRIPTION | # | DATE


NORTH ARROW:

EAST 1/4 CORNER SECTION 33 T7N

R19E CON MON W/ BRASS CAP

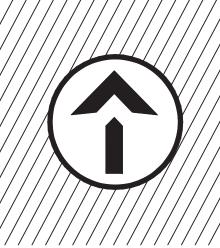

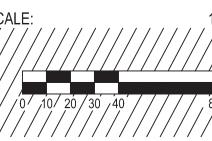

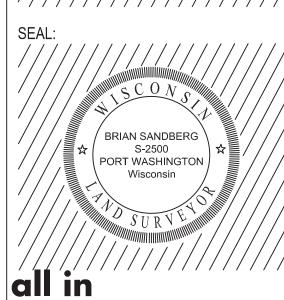

PLAT OF SURVEY

PROJECT MANAGER 200281.01 PROJECT NUMBER: 4/##/2020 DATE:

SHEET NUMBER:

CENTER OF SECTION 33 T7N R19E CON MON W/

SEWRPC BRASS CAP

ALL THAT PART OF THE NORTHEAST 1/4 AND SOUTHEAST 1/4 OF

WAUKESHA, WAUKESHA COUNTY, WISCONSIN, BOUNDED AND DESCRIBED AS

SECTION. 180.00 FEET: THENCE NORTH 0°06' WEST 50.0 FEET: THENCE

FOLLOWS: COMMENCING AT THE EAST 1/4 CORNER OF SAID SECTION 33: THENCE

BLVD. AND N. HINE AVENUE AND THE PLACE OF BEGINNING OF THE FOLLOWING

N. HINE AVENUE, 25.0 FEET TO THE BEGINNING OF A CURVE; THENCE 99.83 FEET

ALONG SAID WEST LINE AND THE ARC OF A CURVE HAVING A CHORD BEARING

NORTH 0°06' WEST ALONG SAID WEST LINE, 165.00 FEET TO THE BEGINNING OF

A CURVE ON THE SOUTH LINE OF MAITLAND DRIVE; THENCE 143.67 FEET ALONG

SOUTH 89°15' WEST ALONG SAID SOUTH LINE, 371.90 FEET TO THE EAST LINE OF

SOUTH 44°44'35" WEST. 132.46 FEET TO THE P.R.C.: THENCE 140.23 FEET ALONG

SOUTH 0°06' EAST ALONG SAID EAST LINE, 190.00 FEET TO THE BEGINNING OF A

IRVING PLACE AND THE BEGINNING OF A CURVE, THENCE 134.73 FEET ALONG

NORTH 4°12'48" EAST, 99.74 FEET TO THE P.R.C.; THENCE 99.83 FEET ALONG

SAID WEST LINE AND THE ARC OF A CURVE HAVING A CHORD BEARING

NORTH 4° 12' 48" EAST, 99.76 FEET TO THE END OF SAID CURVE; THENCE

SAID SOUTH LINE AND THE ARC OF A CURVE HAVING A CHORD BEARING

SAID EAST LINE AND THE ARC OF A CURVE HAVING A CHORD BEARING

SAID EAST LINE AND THE ARC OF A CURVE HAVING A CHORD BEARING

SOUTH 26°27'53" WEST, 135.20 FEET TO THE END OF SAID CURVE; THENCE


NORTH 45°25.5' WEST, 129.15 FEET TO THE END OF SAID CURVE; THENCE

DESCRIBED PROPERTY; THENCE NORTH 0°06' WEST ALONG THE WEST LINE OF

SECTION 33, TOWNSHIP 7 NORTH, RANGE 19 EAST, CITY OF

SOUTH 88°37' WEST ALONG THE EAST 1/4 LINE OF SAID

LEGAL DESCRIPTION

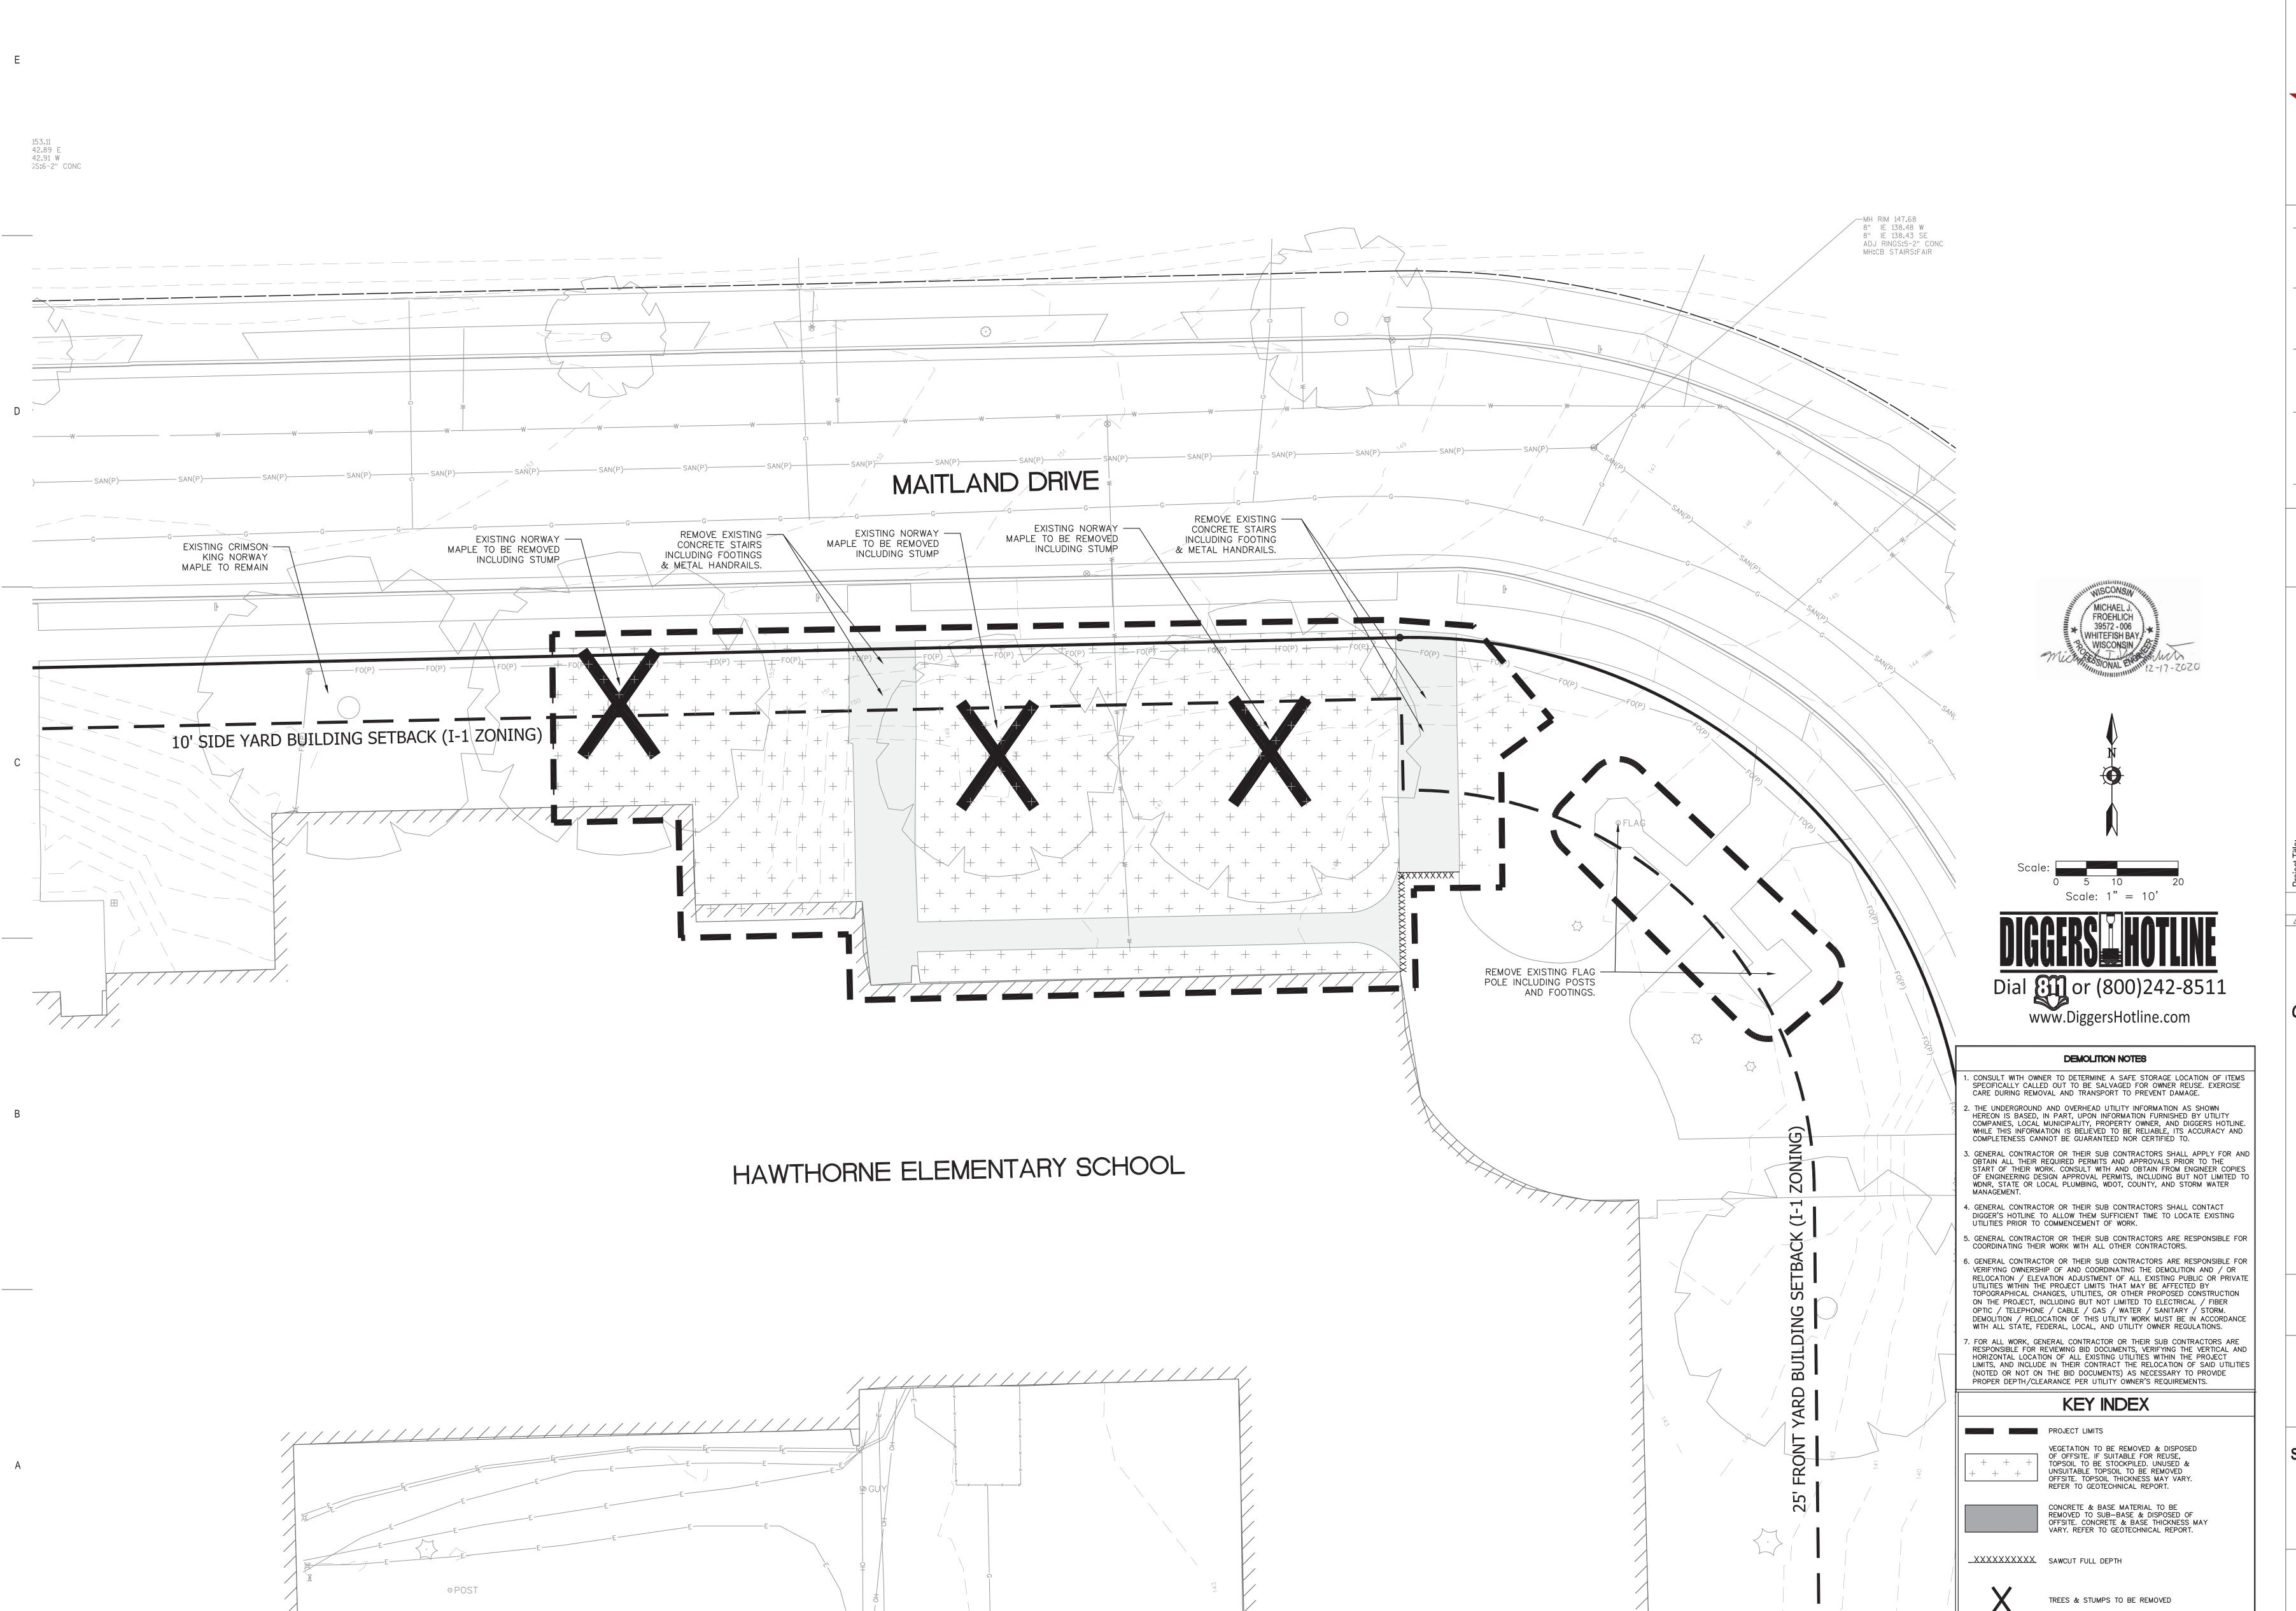

Office Locations: Davenport 220 Emerson Place, Suite 301 Davenport, IA 52801

> Milwaukee 829 South 1st Street Milwaukee, Wisconsin 53204 T: 414.226.0200

T: 563.526.6050

1465 41st Street, Suite 10 Moline, IL 61265 T: 309.762.0511

Sheboygan 1227A North 8th Street PO Box 955

Sheboygan, Wisconsin 53082

T: 920.459.4200

www.brayarch.com

REVISIONS: ⚠ DATE DESCRIPTION

NOT FOR CONSTRUCTION



Milwaukee, WI 53217 www.kapurinc.com Project Number:


3353 - M Issued For:


COMMISSION **DECEMBER 18, 2020** Sheet Title:

SITE DEMOLITION

Sheet Number:

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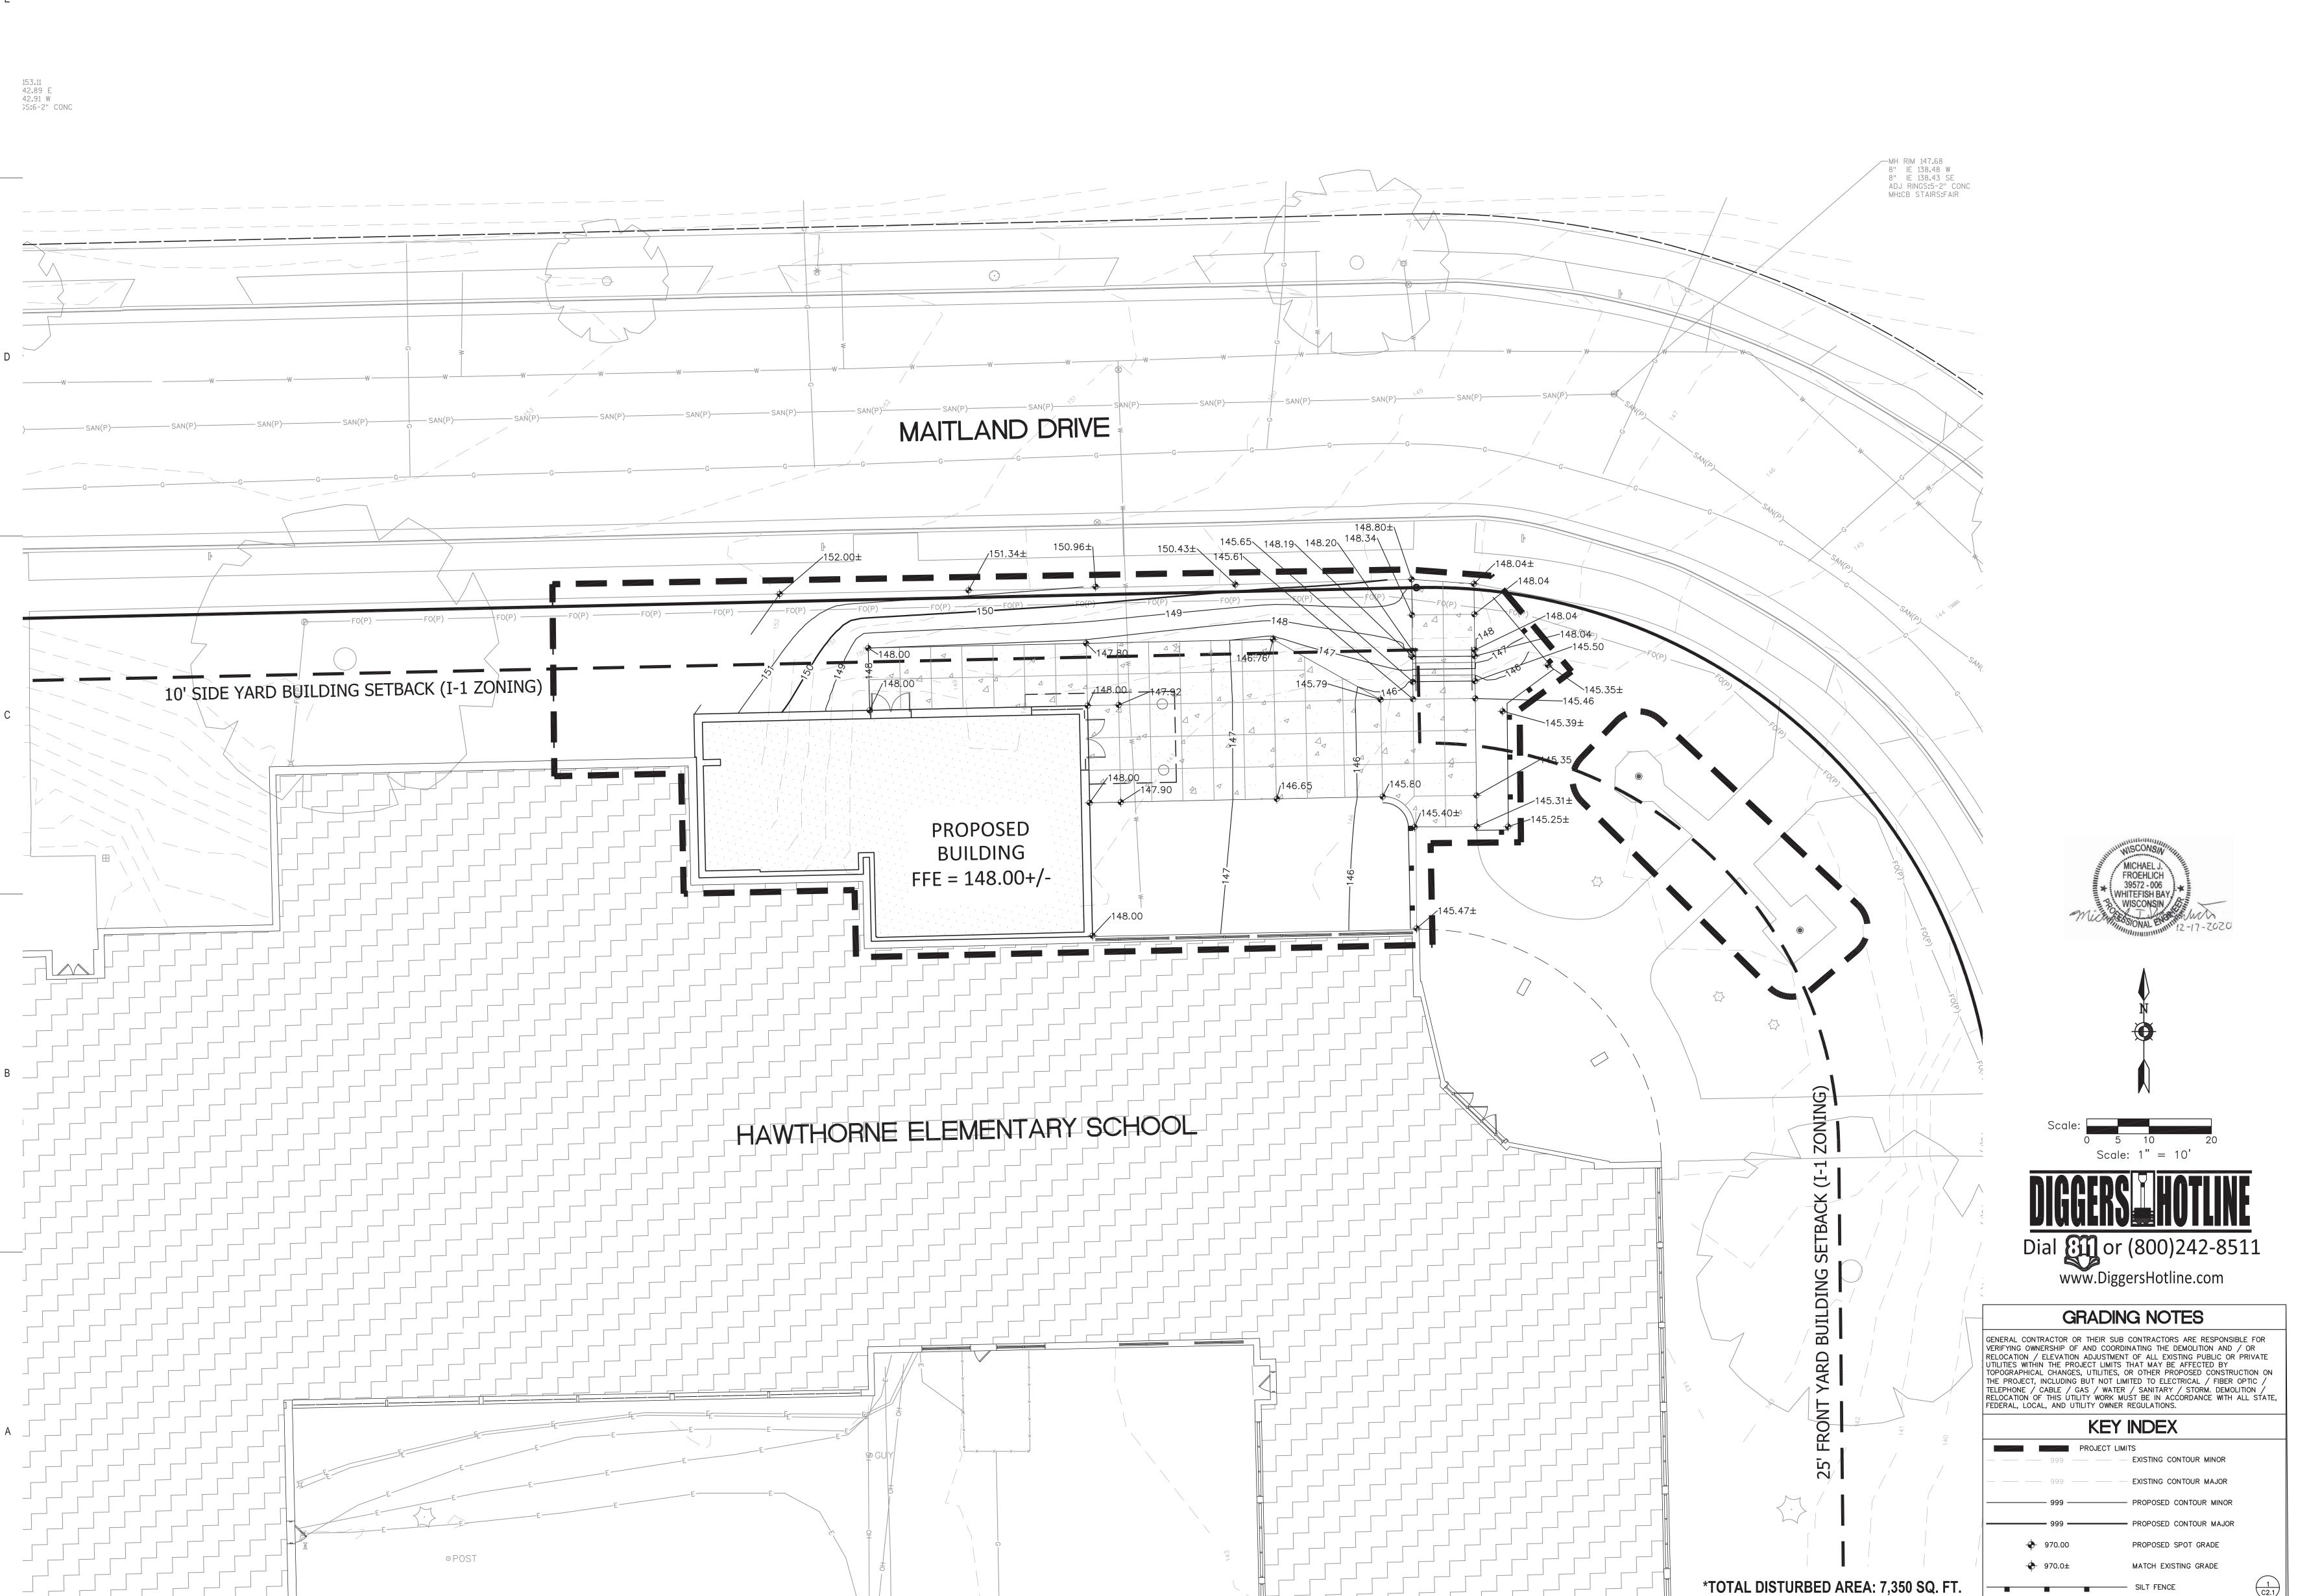
90% PROGRESS

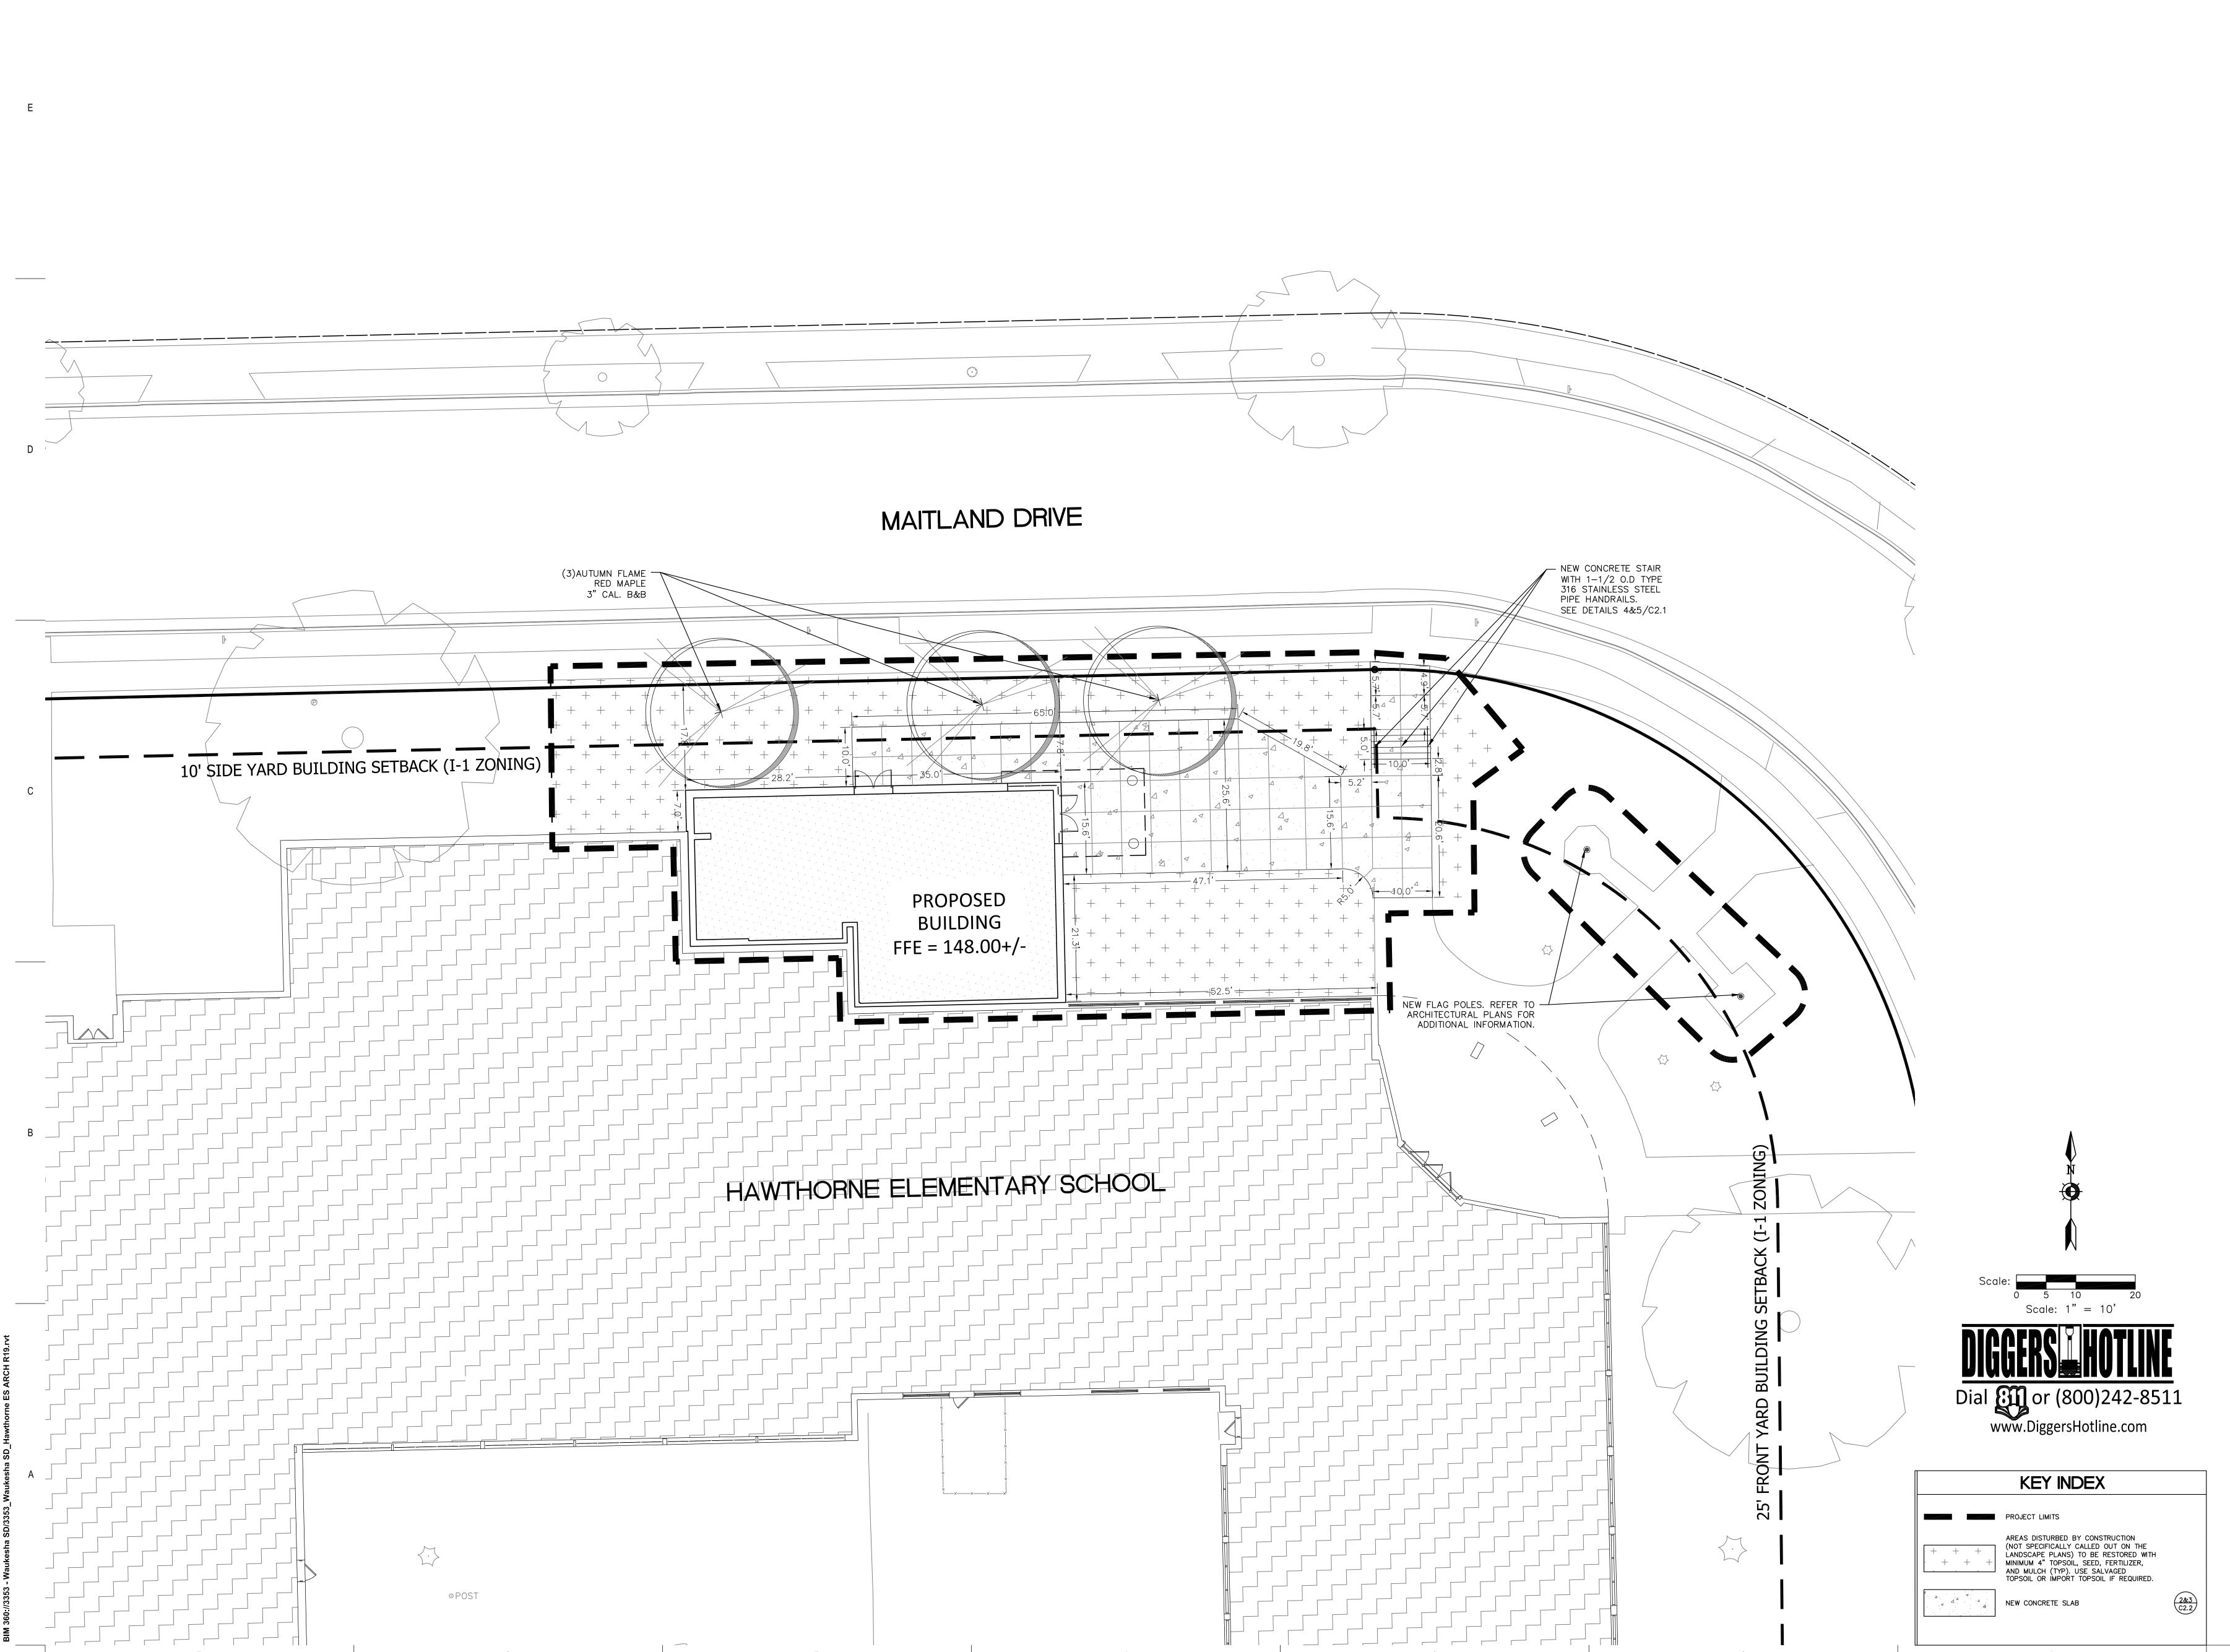DECEMBER 18, 2020 Sheet Title:

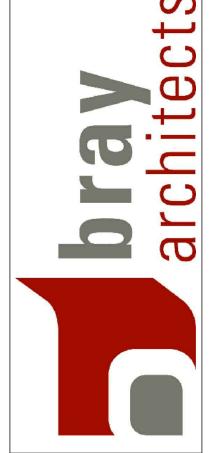SITE LAYOUT & **GEOMETRIC PLAN**

Sheet Number:

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Sheboygan

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PO Box 955
Sheboygan, Wisconsin 53082
T: 920.459.4200

www.brayarch.com

ADDITIONS AND REMODELING TO:
HAWTHORNE ELEMENTARY SCHOOL
WAUKESHA SCHOOL DISTRICT
MAIT! AND DR WAIIKESHA WI 53188

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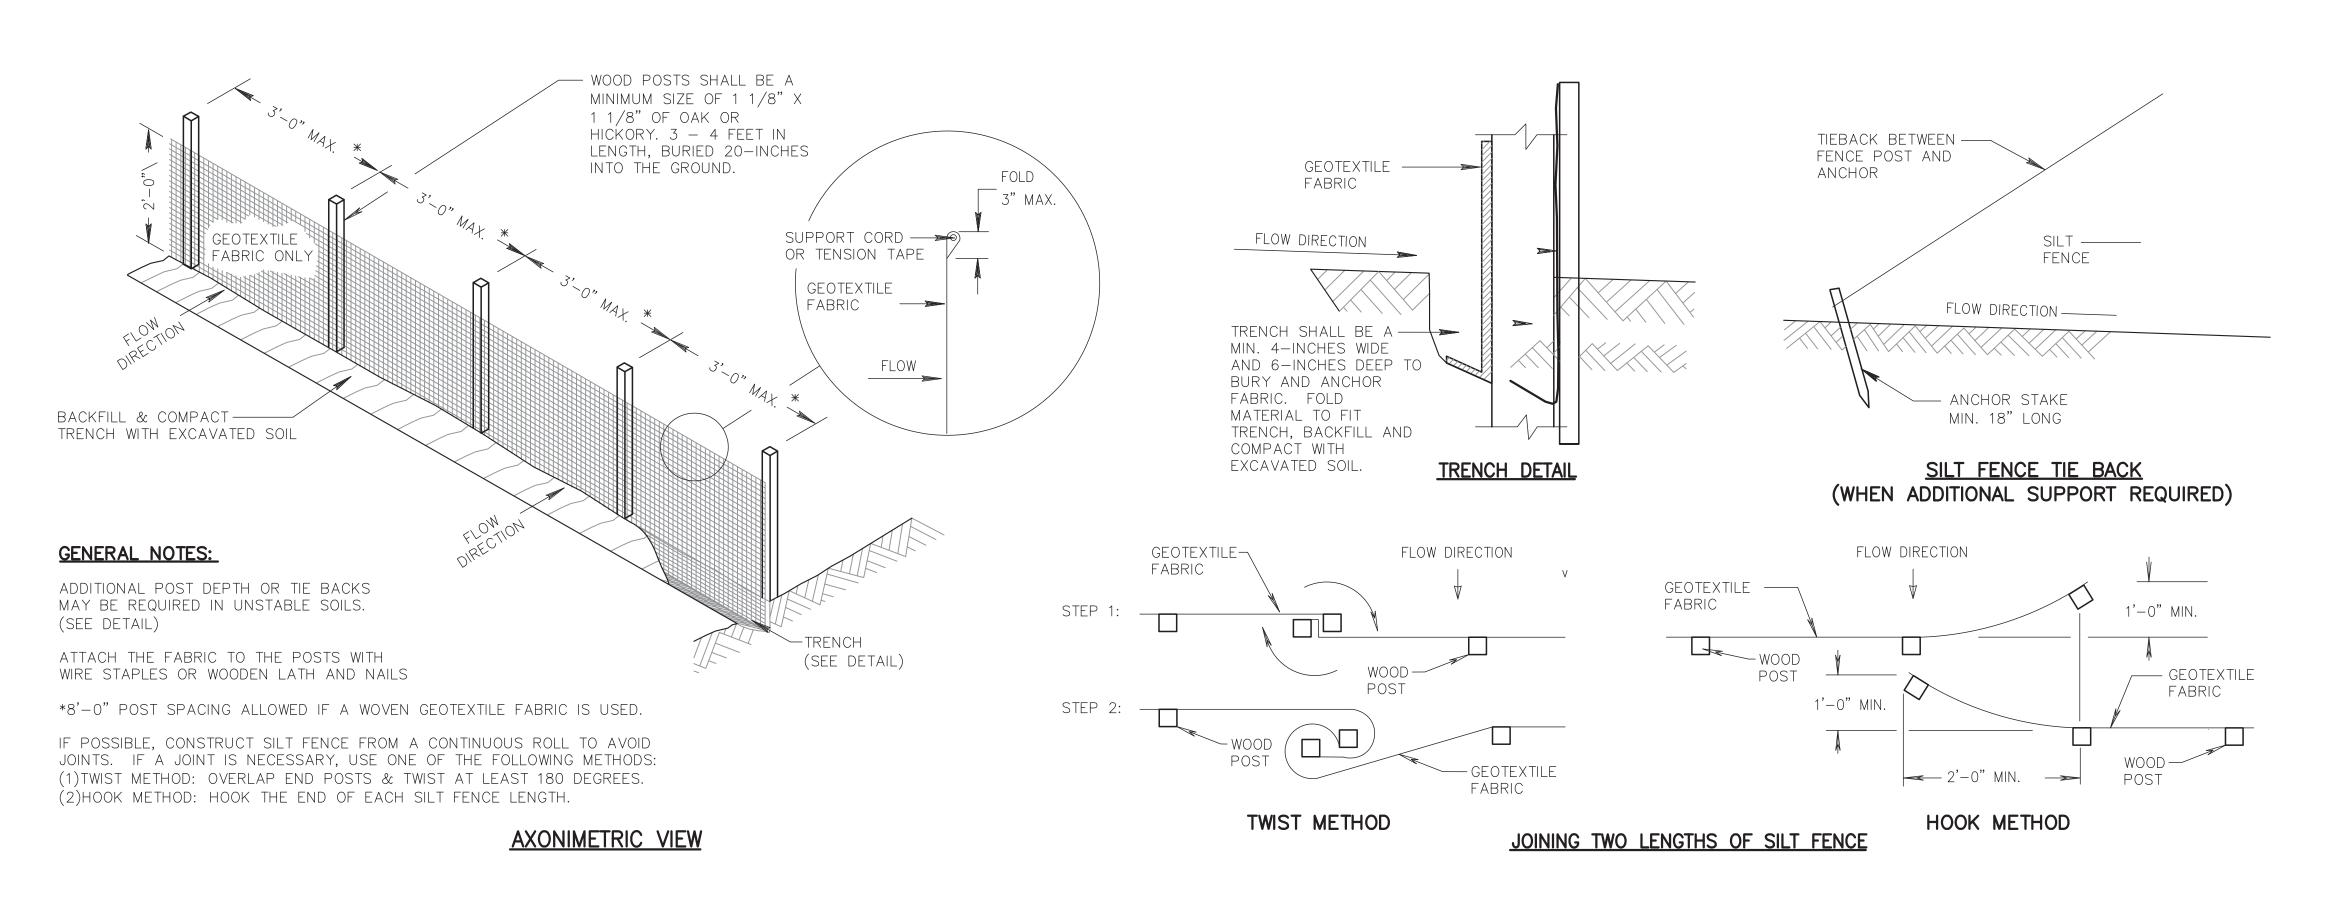
3353 - M

Issued For:
PLAN
COMMISSION
REVIEW
DECEMBER 18, 2020
Sheet Title:
SITE GRADING &
EROSION


Sheet Number:

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CONTROL PLAN





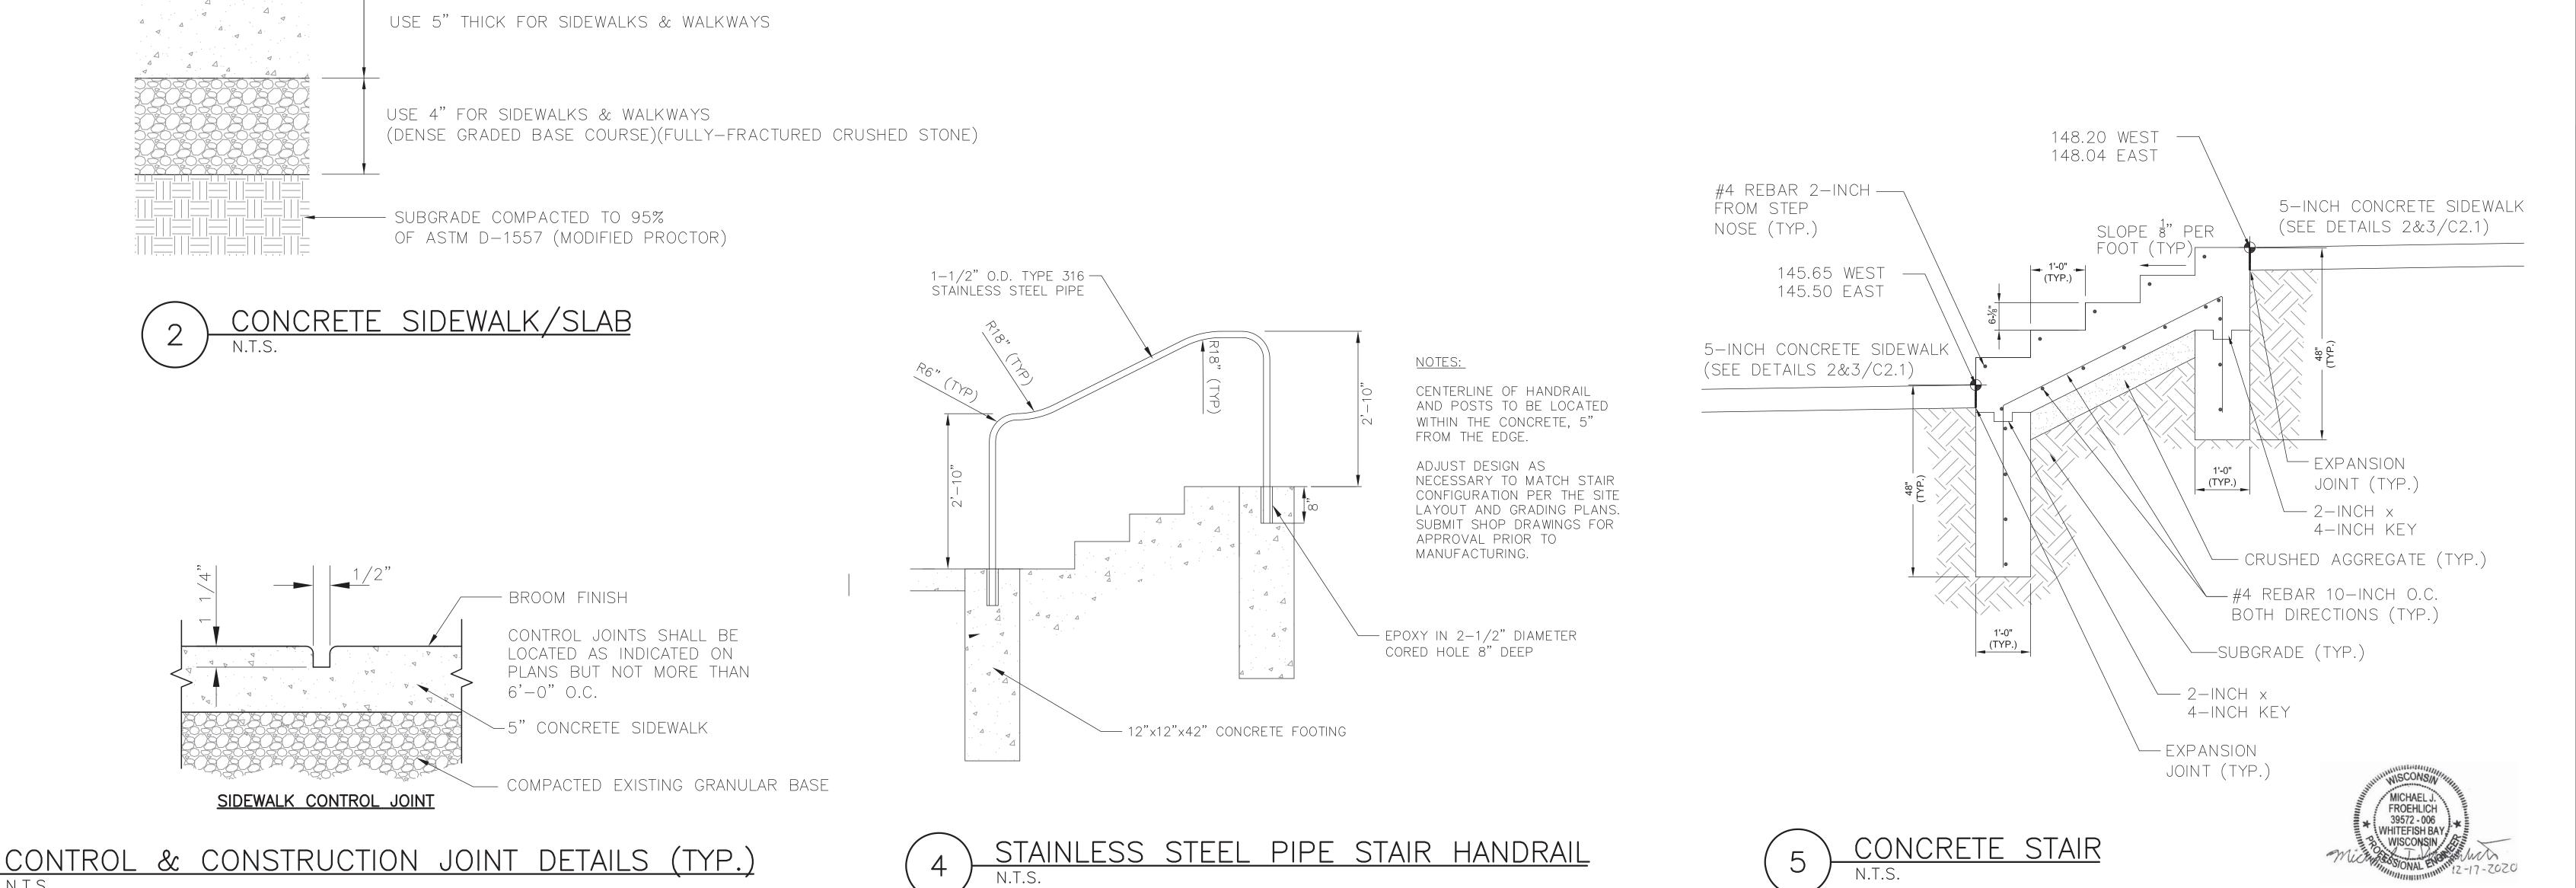

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ADDITIONS AND REMODELING TO:
HAWTHORNE ELEMENTARY SCHOOL
WAUKESHA SCHOOL DISTRICT

REVISIONS:

A DATE DESCRIPTION

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Project Number:


3353 - M

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DECEMBER 18, 2020
Sheet Title:
SITE DETAILS

Sheet Number:

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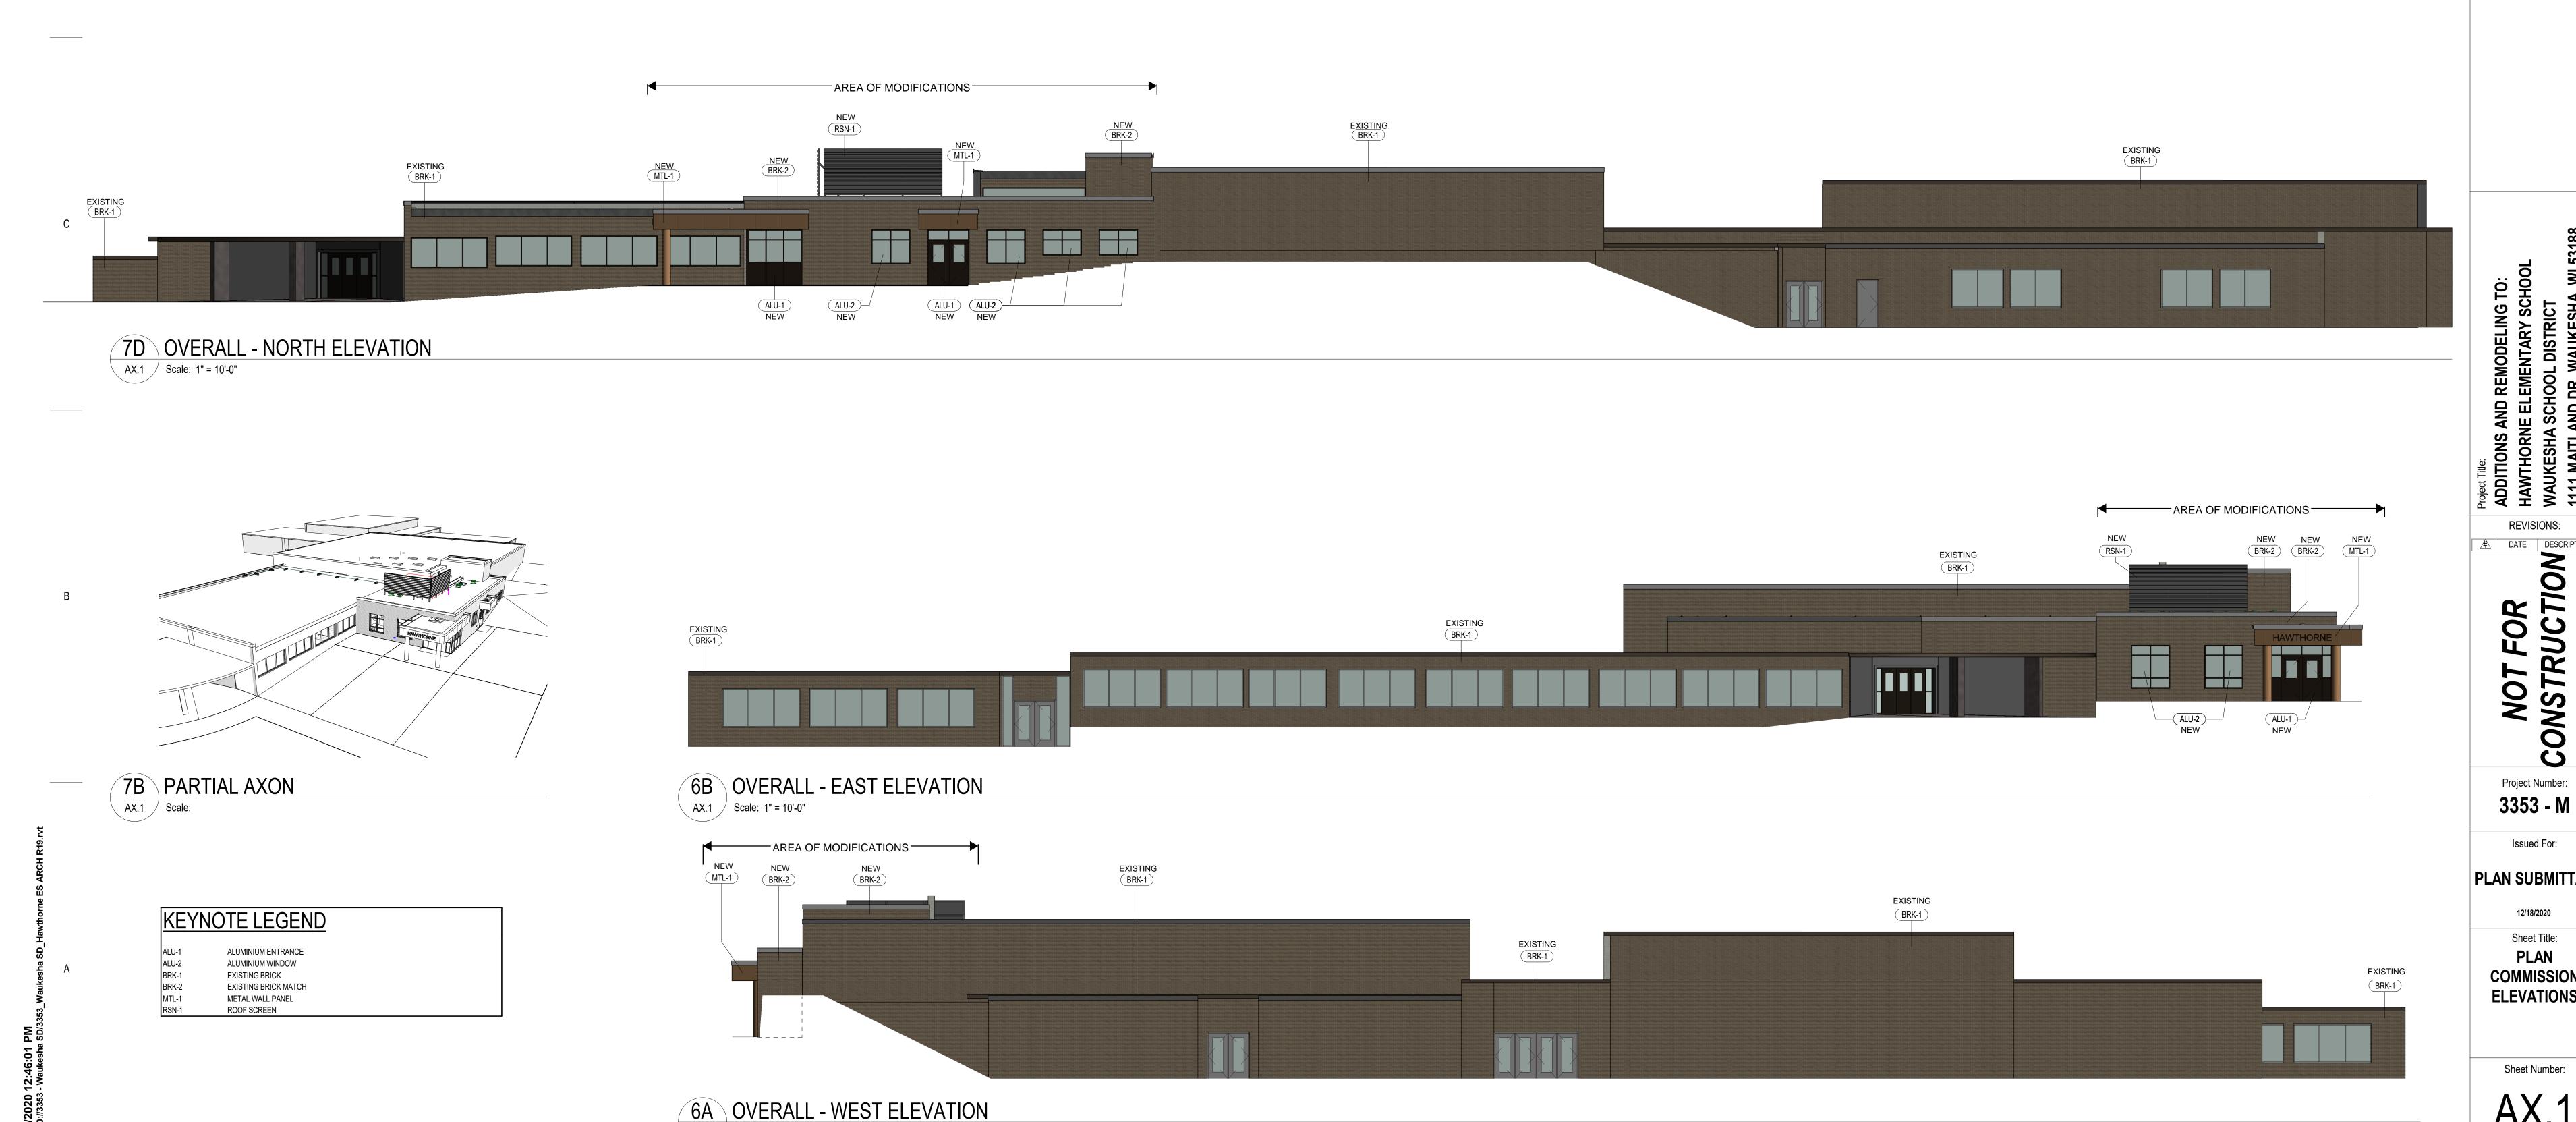
Project Number: 3353 - M

Issued For: PLAN COMMISSION **REVIEW DECEMBER 18, 2020** Sheet Title:

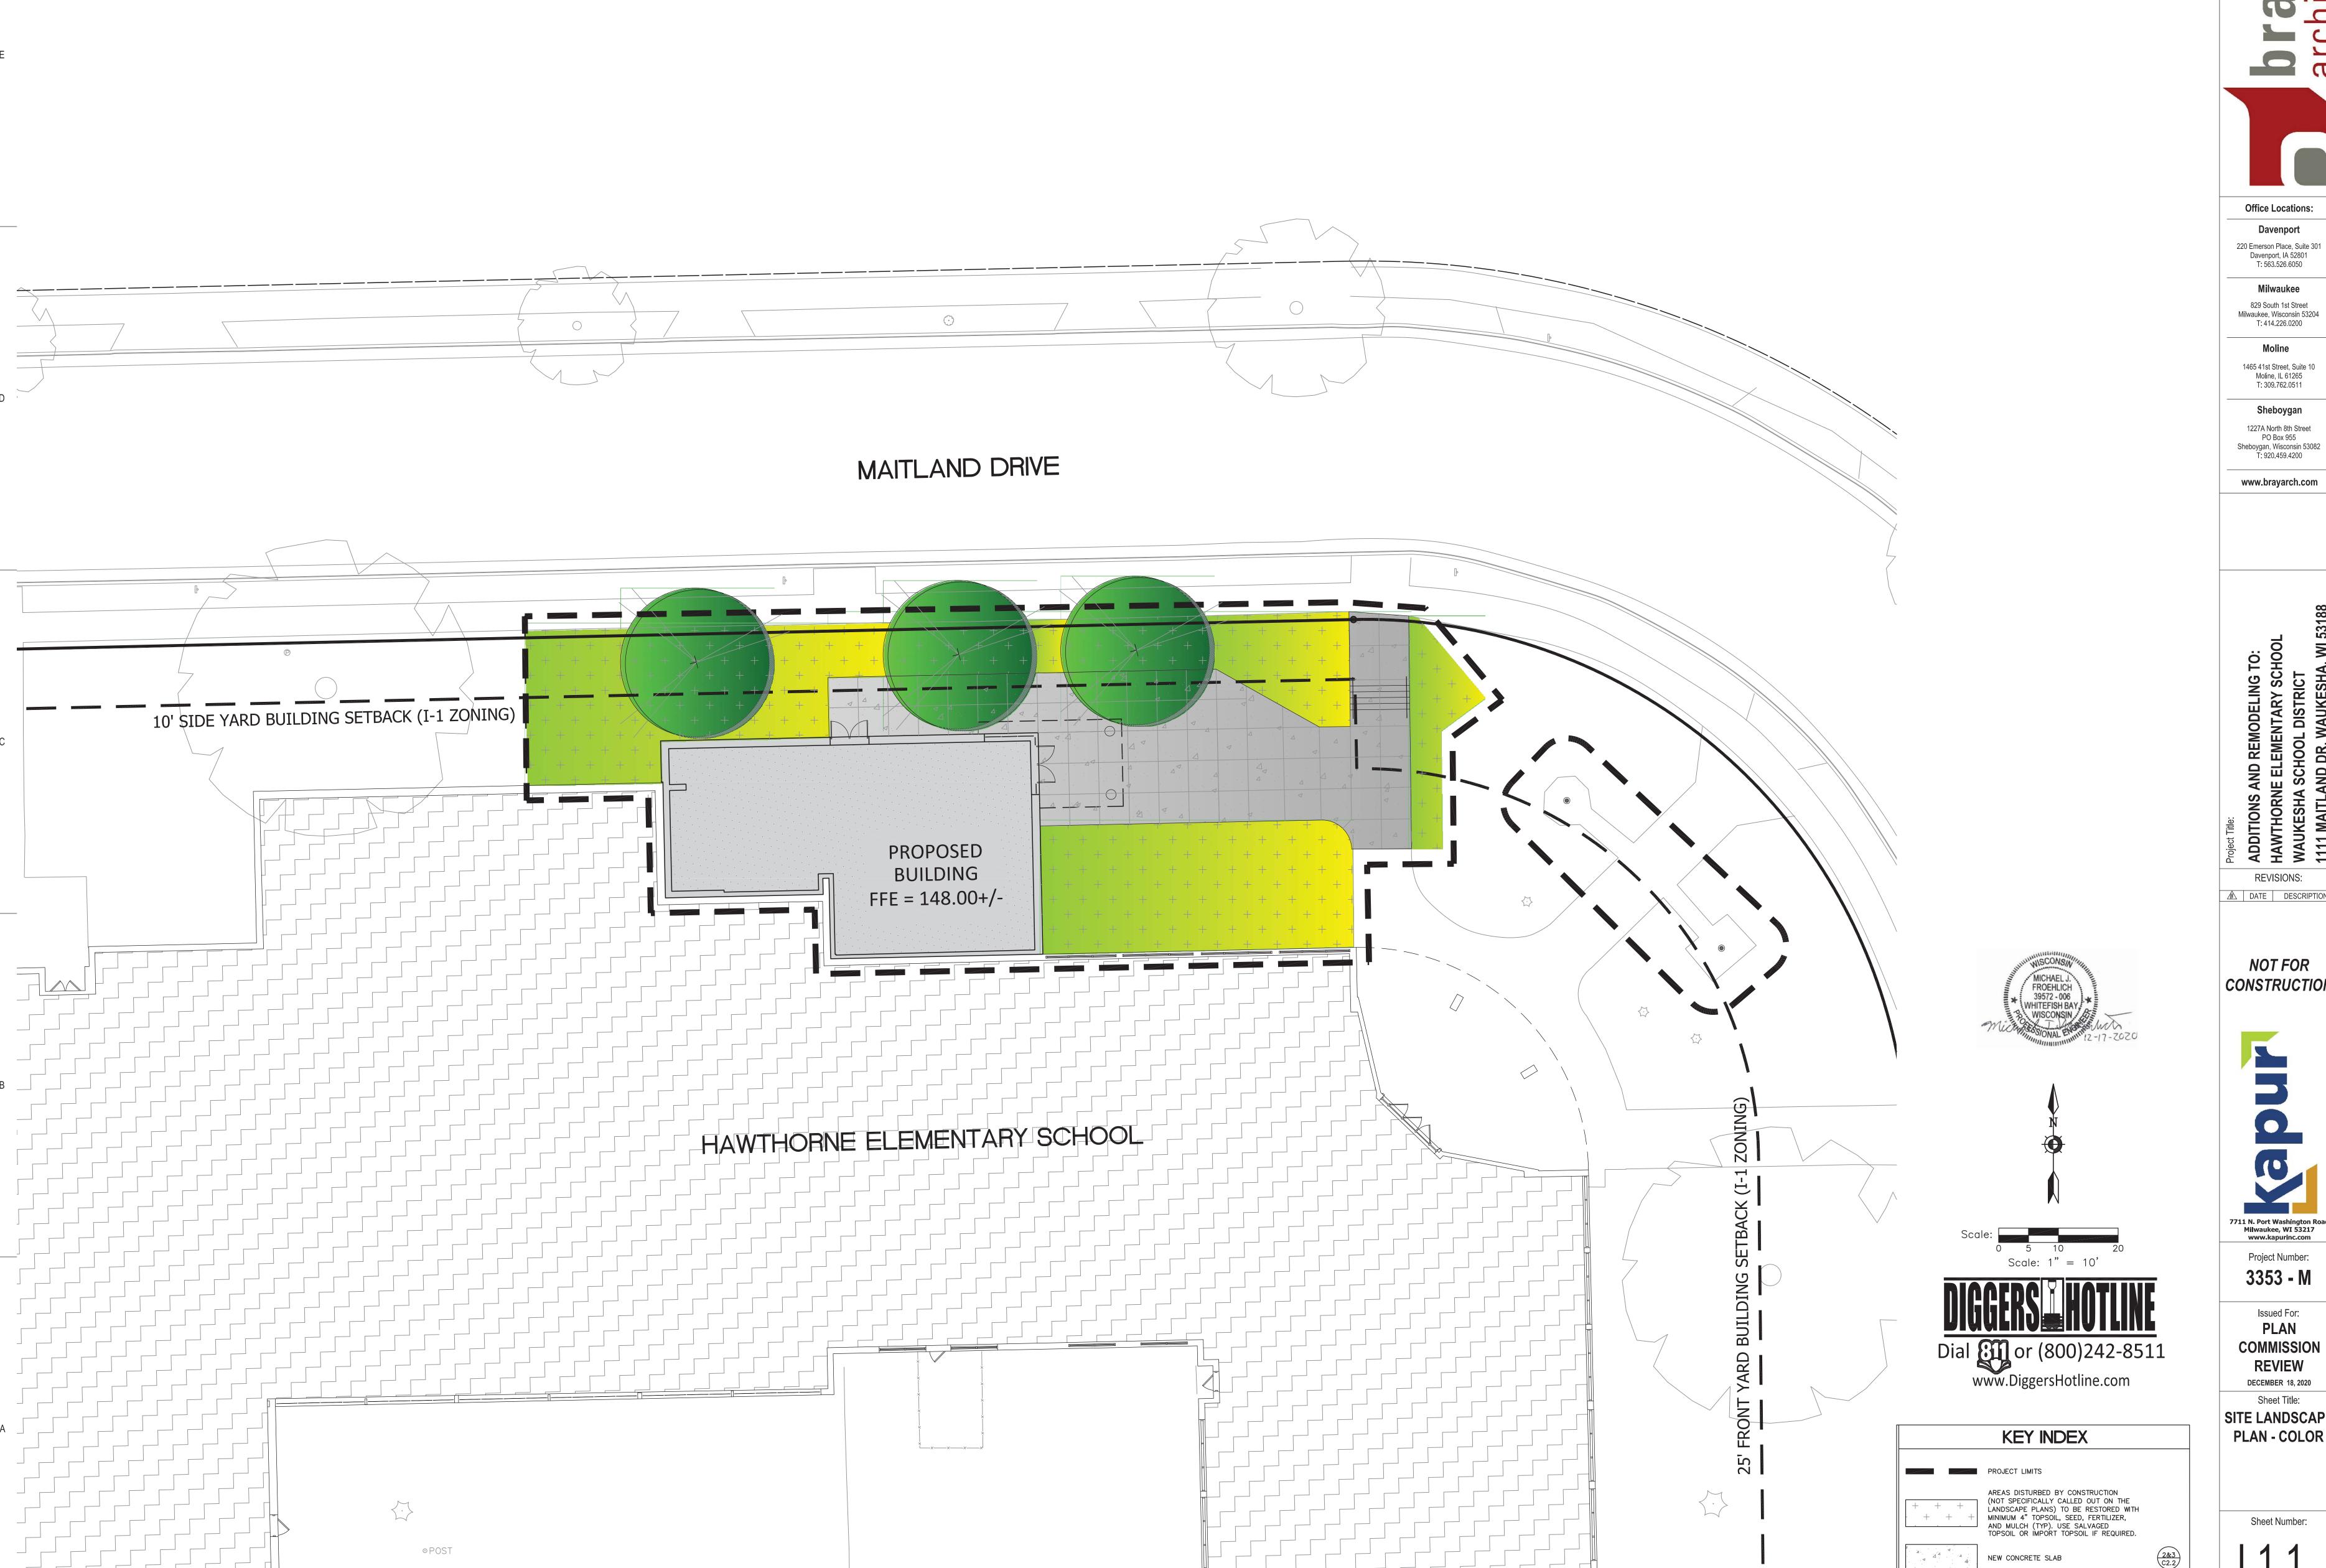SITE LANDSCAPE **PLAN - COLOR**

Sheet Number:

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AX.1 Scale: 1" = 10'-0"

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Milwaukee 829 S. 1st Street Milwaukee, Wisconsin 53204 T: 414.226.0200

Davenport, Iowa 52801

Sheboygan 1227A North 8th Street PO Box 955 Sheboygan, Wisconsin 53082 T: 920.459.4200

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REVISIONS:

Project Numbers Project Number:

Issued For:

PLAN SUBMITTAL

12/18/2020

Sheet Title: **PLAN** COMMISSION **ELEVATIONS**


Sheet Number:

AX.1

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1 FIRST FLOOR - ELECTRICAL
E1.0 Scale: 1" = 20'-0"

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www.brayarch.com

ENGINEERING
A DIVISION OF MSA
P.O. Box 235 | 116 Fremont St. Kiel, WI 53042
Phone 920.894.7800

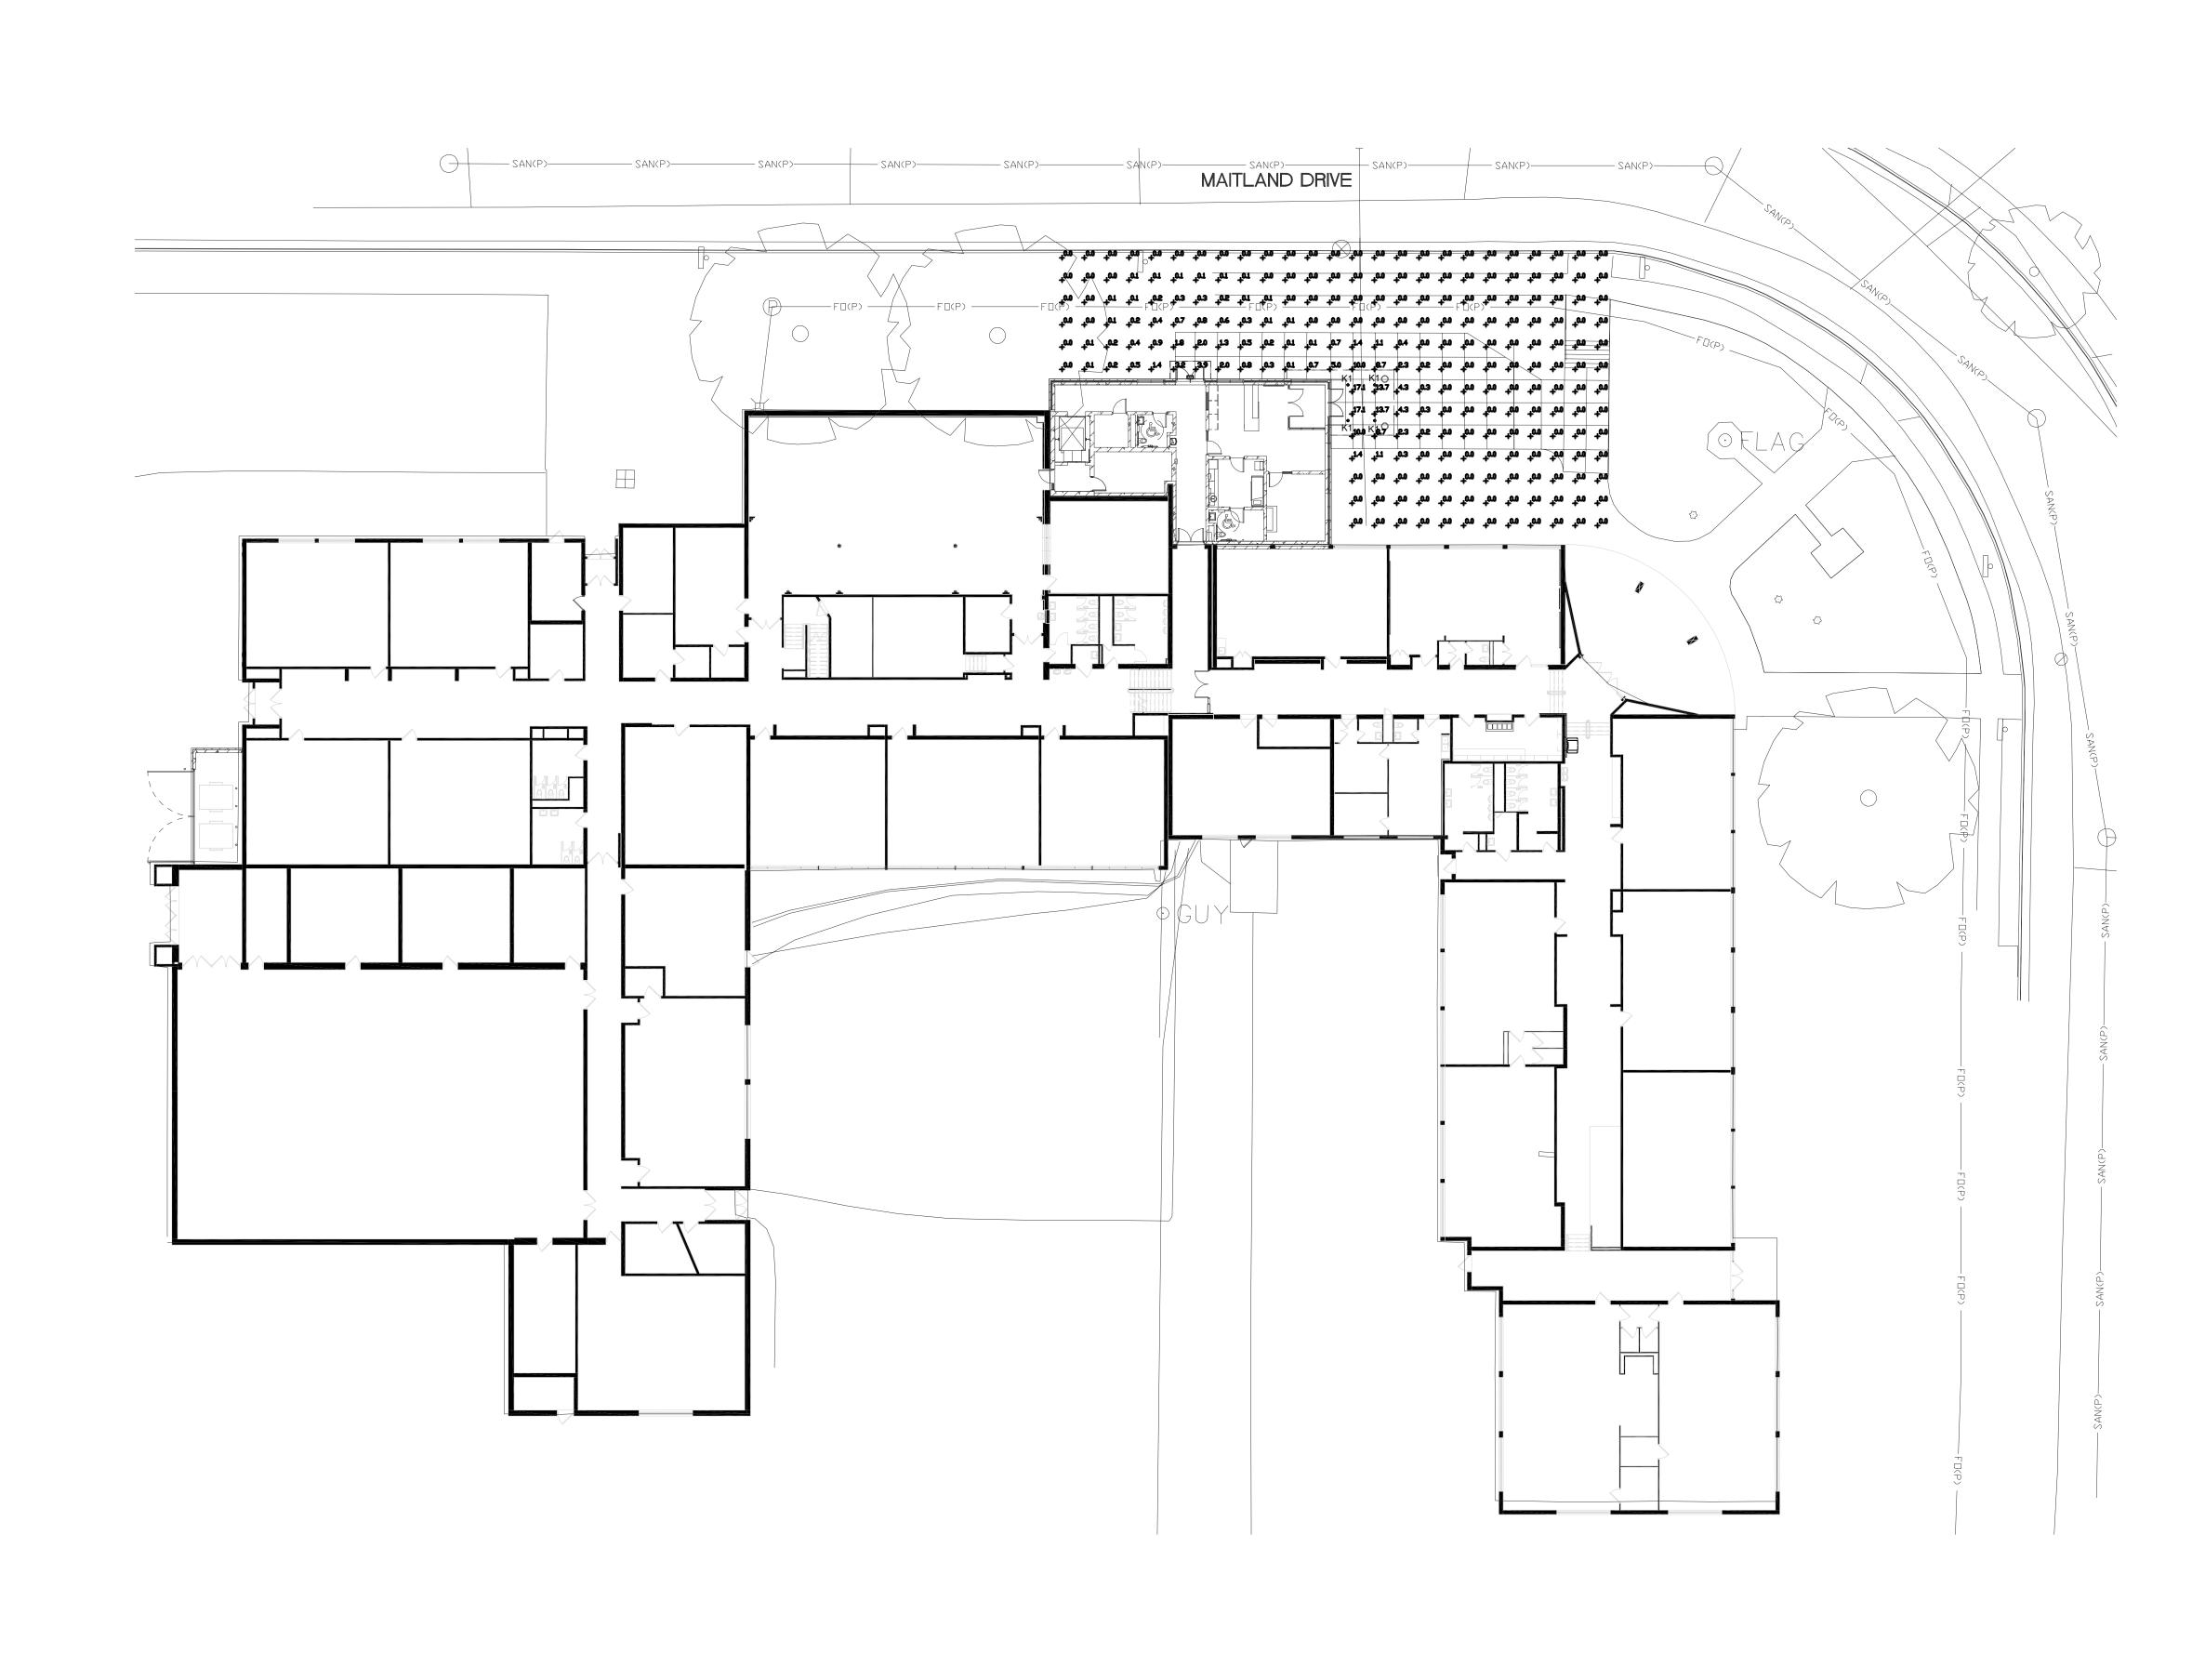Project Title:

ADDITIONS AND REMODELING TO:
HAWTHORNE ELEMENTARY SCHOOL
SIGNATIONS AND REMODELING TO:
HAWTHORNE ELEMENTARY SCHOOL
1111 MAITLAND DR, WAUKESHA, WI 53188

Project Number: 3353 - M

Issued For:

CITY SUBMITTAL

Sheet Title:

SITE PHOTOMETRIC

Sheet Number:

E1

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12/16/2020 12:09:15 PM BIM 360://3353 - Waukesha SD/19-2019009-HA



FEATURES & SPECIFICATIONS

INTENDED USE — Typical applications include corridors, lobbies, conference rooms and private offices. CONSTRUCTION — Galvanized steel mounting/plaster frame; galvanized steel junction box with bottom-hinged access covers and spring latches. Reflectors are retained by torsion springs.

Vertically adjustable mounting brackets with commercial bar hangers provide 3-3/4" total adjustment. Two combination 1/2"-3/4" and four 1/2" knockouts for straight-through conduit runs. Capacity: 8 (4 in, 4 out). No. 12 AWG conductors, rated for 90°C.

Accommodates 12"-24" joist spacing.

Passive cooling thermal management for 25°C standard; high ambient (40°C) option available. Light engine and drivers are accessible from above or below ceiling.

Max ceiling thickness 1-1/2".

OPTICS — LEDs are binned to a 3-step SDCM; 80 CRI minimum. 90 CRI optional.

LED light source concealed with diffusing optical lens.

General illumination lighting with 1.0 S/MH and 55° cutoff to source and source image.

Self-flanged anodized reflectors in specular, semi-specular, or matte diffuse finishes. Also available in white and black painted reflectors.

ELECTRICAL — Multi-volt (120-277V, 50/60Hz) 0-10V dimming drivers mounted to junction box, 10% or 1% minimum dimming level available.

0-10V dimming fixture requires two (2) additional low-voltage wires to be pulled.

70% lumen maintenance at 60,000 hours.

LISTINGS — Certified to US and Canadian safety standards. Wet location standard (covered ceiling). IP55 rated. ENERGY STAR® certified product.

WARRANTY — 5-year limited warranty. Complete warranty terms located at:

www.acuitybrands.com/support/warranty/terms-and-conditions

Note: Actual performance may differ as a result of end-user environment and application.

All values are design or typical values, measured under laboratory conditions at 25 °C.

Specifications subject to change without notice.



Catalog Number Notes Туре



LDN6

6" Open and WallWash LED Non-IC **New Construction Downlight**











Example: LDN6 35/15 LO6AR LSS MVOLT EZ10



ORDERING INFORMATION Lead times will vary depending on options selected. Consult with your sales representative.

LDN6											
Series	Color temperature	Lumens ¹		Aperture/Trim Color			Fini	Finish		Voltage	
(LDN6) 6" round	27/ 2700K 30/ 3000K 35/ 3500K (40/ 4000K	05 500 lumens 07 750 lumens 10 1000 lumens 15 1500 lumens 20 2000 lumens	25 2500 lumens 30 3000 lumens 40 4000 lumens 50 5000 lumens	LW6	Downlight Wallwash	AR WR ² BR ²	Clear White Black	LSS LD LS	Semi-specular Matte diffuse Specular	MVOLT 120 277 347 ³	Multi-volt 120V 277V 347V

Drive	er	Options		
GZ10 GZ1 D10 D1 EZ10	0-10V driver dims to 10% 0-10V driver dims to 1% Minimum dimming 10% driver for use with JOT Minimum dimming 1% driver for use with JOT	SF4 Single fuse TRW5 White painted flange EL6 Emergency battery pack with integral test switch. 10W Constant Power Not Certified in CA Title 20 MAEDBS ELR6 Emergency battery pack with remote test switch. 10W Constant Power Not Certified in CA Title 20 MAEDBS ELSD6 Emergency battery pack with self-diagnostics, integral test switch. 10W Constant Power, Not Certified in CA Title 20 MAEDBS ELRSD6 Emergency battery pack with self-diagnostics, remote test switch. 10W Constant Power, Not Certified in CA Title 20 MAEDBS E10WCP6 Emergency battery pack, 10W Constant Power with integral test switch Certified in CA Title 20 MAEDB	HAO 11 CP 12 RRL . NLTAIR 29, 10	nLight™ Lumen Compensation Wireless room control with "Just One Touch" pairing nLight® dimming pack controls 0-10V eldoLED drivers (EZ10, EZ1). nLight® dimming pack controls 0-10V eldoLED drivers (EZ10, EZ1). ER controls fixtures on emergency circuit. High ambient option Chicago Plenum RELOC®-ready luminaire connectors enable a simple and consistent factory installed option across all ABL luminaire brands. Available only in RRLA, RRLB, RRLAE, and RRLC12S. Refer to RRL spec sheet on www.acuitybrands.com for the RELOC product specifications. nLight® Air enabled
EDAB	performance down to 1%	E10WCPR ⁶ Emergency battery pack, 10W Constant Power with remote test switch Certified in CA Title 20 MAEDB NPP16D ⁷ nLight [®] network power/relay pack with 0-10V dimming for non-eldoLf drivers (GZ10, GZ1). NPP16DER ⁷ nLight [®] network power/relay pack with 0-10V dimming for non-eldoLf drivers (GZ10, GZ1). ER controls fixtures on emergency circuit.	D NLTAIREM2 ^{9,10}	nLight® AIR Dimming Pack Wireless Controls. Controls fixtures on emergency circuit, not available with battery pack options nLight® AIR Dimming Pack Wireless Controls. UL924 Emergency Operation, via power interrupt detection. Available with battery pack options. US point of manufacture High CRI (90+)

Accessories: Order as separate catalog number. PS1055CP FMC Power Sentry batterypack, T20 compliant, field installable, 10w constant power

Compact interruptible emergency AC power system EAC ISSM 375 Compact interruptible emergency AC power system EAC ISSM 125 GRA68 JZ Oversized trim ring with 8" outside diameter 1


- Overall height varies based on lumen package; refer to dimensional chart on page 3.
- Not available with finishes.
- Not available with emergency options.
- Must specify voltage 120V or 277V.
- Available with clear (AR) reflector only.
- 12.5" of plenum depth or top access required for battery pack maintenance.
- Specify voltage. ER for use with generator supply EM power. Will require an emergency hot feed and normal hot feed.
- Fixture begins at 80% light level. Must be specified with NP-S80EZ or NPS80EZ ER. Only available with EZ10 and EZ1 drivers.
- Not available with CP, NPS80EZ, NPS80EZER, NPP16D, NPP-16DER or N80 options.
- 10 NLTAIR2, NLTAIRER2 and NLTAIREM2 not recommended for metal ceiling installations.
- Fixture height is 6.5" for all lumen packages with HAO.
- 12 Must specify voltage for 3000lm and above. 5000lm with marked spacing 24 L x 24 W x 14 H. Not available with emergency battery pack option.
- 3 Must specify D10 or D1 driver. Not available with nLight options. Not available with CP. Not recommended for metal ceiling installation. Not for use with emergency backup power systems other than battery packs.

DOWNLIGHTING LDN₆


PHOTOMETRY

Distribution Curve	Distribution Data	Output Data	Coefficient of Utilization	Illuminance Data at 30" Above Floor for
				a Single Luminaire


LDN6 35/10 L06AR, input watts: 10.44, delivered lumens: 987.10, LM/W = 94.54, spacing criterion at 0 = 1.02, test no. ISF 30716P262.

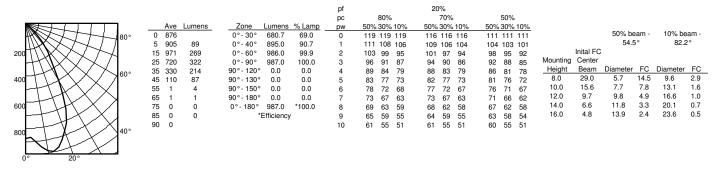

LDN6 35/15 LO6AR, input watts: 17.52, delivered lumens: 1572.9, LM/W = 89.77, spacing criterion at 0 = 1.02, test no. ISF 30716P265.

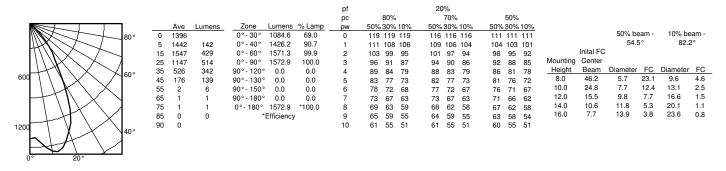



LDN6 35/30 LO6AR, input watts: 34.75, delivered lumens: 3138.5, LM/W = 90.31, spacing criterion at 0 = 1.02, test no. ISF 30716P274.

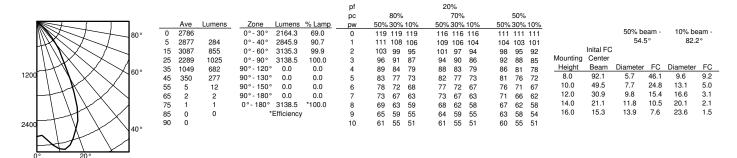

* All dimensions are inches (centimeters) unless otherwise noted.


LDN6 500 - 1500 LUMENS

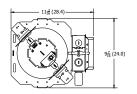


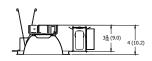

Aperture: 6-1/4 (15.9) Ceiling Opening: 7-1/8 (18.1) Overlap Trim: 7-1/2 (19.1)


LDN6 2000 - 3000 LUMENS

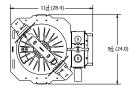


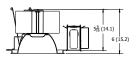

Aperture: 6-1/4 (15.9) Ceiling Opening: 7-1/8 (18.1


LDN6 4000 - 5000 LUMENS

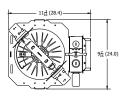

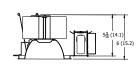


Marked Spacing: 24 x 24 x 10 Aperture: 6-1/4 (15.9) Ceiling Opening: 7-1/8 (18.1) Overlap Trim: 7-1/2 (19.1)


LDN6 CP

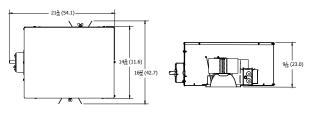

Aperture: 6-1/4 (15.9) Ceiling Opening: 7-1/8 (18.1) Overlap Trim: 7-1/2 (19.1)

LDN6 EL

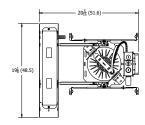

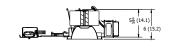

Marked Spacing above 3000 Lumens: $24 \times 24 \times 10$ Aperture: 6-1/4 (15.9) Ceiling Opening: 7-1/8 (18.1) Overlap Trim: 7-1/2 (19.1)

LDN6			
Nominal Lumens	Lumens	Wattage	Lm/W
500	527.9	5.8	90.5
750	758.1	8.9	85.1
1000	950.1	10.4	91.0
1500	1514	17.5	86.4
2000	2006	22.5	89.1
2500	2504	28.3	88.6
3000	3021	34.8	86.9
4000	4008	44.3	90.6
5000	4975	57.7	86.3

HOW TO ESTIMATE DELIVERED LUMENS IN EMERGENCY MODE

Use the formula below to estimate the delivered lumens in emergency mode

Delivered Lumens = 1.25 x P x LPW

P = Ouput power of emergency driver. P = 10W for PS1055CP

LPW = Lumen per watt rating of the luminaire. This information is available on the ABL luminaire spec sheet.

The LPW rating is also available at <u>Designlight Consortium</u>.

LUMEN OUTPUT MULTIPLIERS - FINISH						
	Clear (AR)	White (WR)	Black (BR)			
Specular (LS)	1.0	N/A	N/A			
Semi-specular (LSS)	0.950	N/A	N/A			
Matte diffuse (LD)	0.85	N/A	N/A			
Painted	N/A	0.87	0.73			

LUMEN OUTPUT MULTIPLIERS - CCT								
	2700K	3000K	3500K	4000K	5000K			
80CRI	0.950	0.966	1.000	1.025	1.101			

Notes

- Tested in accordance with IESNA LM-79-08.
- Tested to current IES and NEMA standards under stabilized laboratory conditions.
- · CRI: 80 typical.



ADDITIONAL DATA

The Sensor Switch JOT enabled solution offers a wireless, app-free approach to single room lighting control. JOT enabled products use Bluetooth® Low Energy (BLE) technology to enable wireless dimming and switching.

Diagram





Sensor Switch **WSXA JOT**



LDN6 Series

- 1. Power: Install JOT enabled fixtures and controls as instructed.
- 2. Pair: Insert the pairing tool into the pinhole on the wall switch; press and hold any button for 6 seconds.
- 3. Play: Once paired, each fixture will individually dim down to 10% brightness. All products will be fully functional.

СОМ	PATIBLE 0-10V WALL-MOUNT DIMMERS			
MANUFACTURER	PART NO.	POWER BOOSTER AVAILABLE		
	Diva® DVTV			
Lutron®	Diva® DVSCTV			
Lutron	Nova T® NTFTV			
	Nova® NFTV			
	AWSMT-7DW	CN100		
	AWSMG-7DW	PE300		
Leviton®	AMRMG-7DW			
	Leviton Centura Fluorescent Control System			
	IllumaTech® IP7 Series			
	ISD BC			
Synergy®	SLD LPCS	RDMFC		
	Digital Equinox (DEQ BC)			
Douglas Lighting Controls	WPC-5721			
	Tap Glide TG600FAM120 (120V)			
Entertainment Technology	Tap Glide Heatsink TGH1500FAM120 (120V)			
	Oasis 0A2000FAMU			
H	EL7315A1019	EL7305A1010		
Honeywell	EL7315A1009	(optional)		
	Preset slide: PS-010-IV and PS-010-WH			
	Preset slide: PS-010-3W-IV and PS-010-3W-WH			
	Preset slide, controls FD-010: PS-IFC-010-IV and			
HUNT Dimming	PS-IFC-010-WH-120/277V			
	Preset slide, controls FD-010: PS-IFC-010-3W-IV and PS-IFC-010-3W-WH-120/277V			
	Remote mounted unit: FD-010			
Lehigh Electronic Products	Solitaire	PBX		
PDM Electrical Products	WPC-5721			
Starfield Controls	TR61 with DALI interface port	RT03 DALInet Router		
WattStopper®	LS-4 used with LCD-101 and LCD-103			

****** Capable Luminaire

This item is an A+ capable luminaire, which has been designed and tested to provide consistent color appearance and out-of-the-box control compatibility with simple commissioning.

- · All configurations of this luminaire meet the Acuity Brands' specification for chromatic consistency
- This luminaire is part of an A+ Certified solution for nLight® control networks when ordered with drivers marked by a shaded background*
- This luminaire is part of an A+ Certified solution for nLight control networks, providing advanced control functionality at the luminaire level, when selection includes driver and control options marked by a shaded background*

To learn more about A+, visit www.acuitybrands.com/aplus.


*See ordering tree for details



EXAMPLE

Group Fixture Control*

*Application diagram applies for fixtures with eldoLED drivers only.

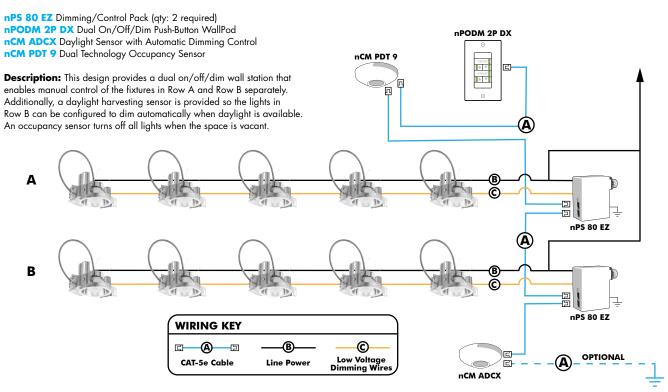

Choose Wall Controls

nLight offers multiple styles of wall controls - each with varying features and user experience.



Push-Button Wallpod Traditional tactile buttons and LED user feedback



Graphic Wallpod Full color touch screen provides a sophisticated look and feel

	nLight [®] Wired Controls Accessories:							
Order as separate catalo	Order as separate catalog number. Visit www.acuitybrands.com/products/controls/nlight for complete listing of nLight controls.							
WallPod Stations	Model number	Occupancy sensors	Model Number					
On/Off	nPODM (Color)	Small motion 360°, ceiling (PIR/dual Tech)	nCM 9 / nCM PDT 9					
On/Off & Raise/Lower	nPOD DX (Color)	Large motion 360°, ceiling (PIR/dual tech)	nCM 10 / nCM PDT 10					
Graphic Touchscreen	nPOD GFX (Color)	Wide View (PIR/dual tech)	nWV 16 / nWV PDT 16					
Photocell controls	Model Number	Wall Switch w/ Raise/Lower (PIR/dual tech)	nWSX LV DX / nWSX PDT LV DX					
Dimming	nCM ADCX	Cat-5 cables (plenum rated)	Model Number					
		10', CAT5 10FT	CATS 10FT J1					
		15, CATS 15FT	CATS 15FT J1					

nLight® AIR Control Accessories:

Order as separate catalog number. Visit www.acuitybrands.com/products/controls/nlightair.

oraci as separate catarog ramoen visit ii	
Wall switches	Model number
On/Off single pole	rPODB [color]
On/Off two pole	rPODB 2P [color]
On/Off & raise/lower single pole	rPODB DX [color]
On/Off & raise/lower two pole	rPODB 2P DX [color]
On/Off & raise/lower single pole	rPODBZ DX WH ¹

Notes

Can only be ordered with the RES7Z zone control sensor version.

nLight AIR

nLight AIR is the ideal solution for retrofit or new construction spaces where adding communication is cost prohibitive. The integrated nLight AIR rPP20 Power Pack is part of each Lithonia LDN Luminaire. These individually addressable controls offer the ultimate in flexibility during initial setup and for space repurposing.





Simple as 1,2,3

- 1. Install the nLight® AIR fixtures with embedded smart sensor
- 2. Install the wireless battery-powered wall switch
- 3. With CLAIRITY app, pair the fixtures with the wall switch and if desired, customize the sensor settings for the desired outcome





LDN6



Attachment A - Application for Development Review Checklist

Project Name: Hawthorne Elementary School

Engineering Design Firm: Kapur Inc. - Civil Engineers

Muermann Engineering - Electrical Engineers

Checklist Items	CSM	Preliminary Plat	Final Plat	Property Survey for Bldg Permit	Storm Water Plan	Erosion Control Plan	Site, Grading, Drainage Plan	Street Plan	Utility Plan	Landscape Plan	Traffic Control Plan	Traffic Impact Analysis	Conditional Use or Home Indus.	PUD or Developer's Ag.	Minor site or Arch. Change	Conditional Use	Rezoning & Comp. Plan Change
Followed Construction Drawing Sheet Layout standards in Development Handbook						Yes	Yes	N.A.	N.A.	Yes							
Followed Development Handbook and Storm Water Ordinance standards for Erosion control plans						Yes											
Obtained geotechnical evaluation for storm water and pavement design					N.A.		N.A.	N.A.	N.A.								
Followed Development Handbook standards, and Wisconsin Administrative Code for Property Survey Verified proposed basement floor elevation is at least 1 foot above the highest seasonal high water				N.A.													
table elevation Followed Development Handbook standards and Ordinance for Preliminary Plat		N.A.															
Followed Site, Grading, and Drainage Plan design standards in Development Handbook and Storm Water Ordinance							Yes						N.A.		N.A.	N.A.	N.A.
Followed Traffic impact analysis standards in Development Handbook Specifications conform to current City Standard					N.A.	Yes	Yes	N.A.	N.A.	Yes	N.A.	N.A.		N.A.			
Specifications Followed Lighting Plan standards in Development Handbook					N.A.	100	163	IV.A.	N.A.	163	N.A.			N.A.			
Development site contains Contaminated Waste							No										
Followed storm water management requirements in Development Handbook, and Ordinance					N.A.												
Site contains mapped FEMA floodplain or a local 100-year storm event high water limits							N.A.										
Site contains wetlands or Natural Resource limits (ie. Primary, Secondary, Isolated , shoreland limits)							N.A.										
CSM follows standards in Development Handbook, City Ordinance, and State Statutes	N.A.																
Followed Development Handbook standards for Street plans and profiles								N.A.									
Followed Development Handbook standards for utility plans and profiles									N.A.								
Existing sanitary sewer lateral has been televised							N.A.		N.A.				N.A.		N.A.	N.A.	N.A.

Checklist Items	CSM	Preliminary Plat	Final Plat	Property Survey for Bldg Permit	Storm Water Plan	Erosion Control Plan	Site, Grading, Drainage Plan	Street Plan	Utility Plan	Landscape Plan	Traffic Control Plan	Traffic Impact Analysis	Conditional Use or Home Indus.	PUD or Developer's Ag.	Minor site or Arch. Change	Conditional Use	Rezoning & Comp. Plan Change
Development Agreement needed for Public Infrastructure														N.A.			
Followed Development Handbook standards for Landscape plans										Yes							
Followed Development Handbook standards, State Statures and Ordinance for Final Plat			N.A.														
A-E 2.02(4): Each sheet of plans, drawings, documents, specifications and reports for architectural, landscape architectural, professional engineering, design or land surveying practice should be signed, sealed, and dated by the	N.A.	N.A.	N.A.	N.A.	N.A.	Yes	Yes	N.A.	N.A.	Yes		N.A.	N.A.	N.A.	N.A.	N.A.	N.A.
32.10(e)(12.)H. A cover sheet stamped and signed by a professional engineer registered in the State of Wisconsin indicating that all plans and supporting documentation have been reviewed and approved by the engineer and certifying that they have read					N.A.												
City, DNR, County or State Permits are needed					N.A.		N.A.	N.A.	N.A.		N.A.						
Complete and submit Plan Sheet and Submittal Specific checklists in Development Handbook	N.A.	N.A.	N.A.	N.A.	N.A.	Yes	Yes	N.A.	N.A.	Yes		N.A.					
Proposed easements needed are shown.	N.A.		N.A.		N.A.		N.A.	N.A.	N.A.								
All Existing easements are shown	N.A.	N.A.	N.A.	N.A.	N.A.	N.A.	N.A.	N.A.	N.A.	N.A.			N.A.	N.A.	N.A.	N.A.	N.A.



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Engineering Plan Checklist

Attachment B (Rev 12/18)

Project Name:	Hawthorne Elementary School	
Engineering & D	Design Firm: Kapur Inc Civil Engineers	

General Information

Plans shall include the seal and signature of the Wisconsin licensed professional engineer responsible for the preparation of the construction plans on the cover sheet or on each sheet

YES	NO	N/A	
			Provide a copy of the WisDOT permit for any work in the State of Wisconsin right of way.
			Provide a copy of the Waukesha County Department of Public Works permit for any work in right of way of Waukesha County.
		X	Provide a copy of Wisconsin Department of Natural Resources Water Resources Application for Project Permits (WRAPP) for all sites greater than one acre.
		X	Provide a copy of US Army Corps of Engineers 404 permit.
		X	Provide cross access agreements for use of entrances.
		X	Provide off-site utility easements.
			Provide hydraulic gradeline calculations for all storm sewer pipes signed and sealed by a professional engineer licensed in the State of Wisconsin.
			Provide a storm water management plan and calculations signed and sealed by a professional engineer licensed in the State of Wisconsin.

All Plan Sheets

YES	NO	N/A	
×			Plans prepared on sheets measuring 11" high by 17" wide or no larger than 24" high by 36" wide.
			Sanitary Sewer, watermain and storm sewer system plans for the entire development are included.
		X	A profile view is located below a plan view on plan and profile sheets and both views are aligned by stationing whenever possible. In general, stationing is from left to right.
			Plan and profile sheets start and terminate at match lines.
X			The assumed bearing base, control monuments and stationing reference line(s)
X			Right-of-way limits and easement limits
X			Edge of pavement or flange, face and back of curb
X			Name of each existing, proposed, and future roadway and any intersecting roadways
X			Lot lines, lot and block numbers
X			Addresses and names of Owners for existing parcels

×		All obstructions located within the project limits including, but not limited to: trees, signs, utilities, fences, light poles, structures, etc.
×		A note warning that underground utilities must be located by "Diggers Hotline" prior to start of construction
\square		Legend (relevant to each sheet) showing all special symbols, line types and hatch used
		Title block includes at a minimum, the following information:
		Name and address of engineering (design) firm and owner/developer
N71		Date of the drawing and last revision
X		Scale
		Plan sheet number (# of #)
		Name and location description of development
		North to the top or right of the sheet and shown by a north arrow, clearly shown without intrusion.
X		Scale of the plans 1" = 40' horizontally and 1" = 8' vertically for 11" by 17" plan sheets and 1" = 20' horizontally and 1" = 4' vertically for 22" by 34" sheets. Partial site plans have a scale of 1" = 20' or larger. The scale of details is such that the detail is clearly shown. The scale is shown with a line scale and text.
X		Existing surface objects indicated with screened lines and clearly labeled.

Cover Sheet

YES	NO	N/A	
X			Project title.
×			Location Map (Proximity to two main streets minimum).
X			Index of all plan sheets
		X	For large or phased subdivisions, a key map of layout and phases.
		X	A minimum of two (2) current SEWRPC reference benchmarks. Survey documentation of tie to Wisconsin State Plane Coordinate System, South Zone (horizontal) and City of Waukesha datum (vertical) provided. Elevations shown based on City of Waukesha datum.
×			All permanent or temporary benchmarks and elevations.
×			A description of the locations of the benchmarks; and the basis or origin of the vertical control network.
×			Date of plan preparation and applicable revision date(s)
×			The following statement: "All site improvements and construction shown on the plans shall conform to the City of Waukesha Development Handbook & Infrastructure Specifications. Where the plans do not comply, it shall be the sole responsibility and expense of the Developer to make revisions to the plans and/or constructed infrastructure to comply."

Roadway

YES	NO	N/A	
			For all new streets, a site specific geotechnical evaluation and pavement design submitted with the plans.
			A separate detail sheet showing typical cross-sections for each roadway standard width and cul-de-sac if applicable.

Plan View

YES	NO	N/A	
			The assumed bearing base, control monuments and stationing reference line along the centerline of the roadway, including cul-de-sacs.
		X	At least one clearly labeled benchmark or control point per sheet.
		X	Pavement and median dimensions.
		×	Final grade elevations at 25' intervals at the right-of-way including at the edge of pavement for rural sections or at the flange of curb for urban sections.
		×	Final grade elevations for cul-de-sacs at 25' intervals at the right-of-way including at the edge of pavement for rural sections or at the flange of curb for urban sections.
			Label all PVC's, PVT's, and PC's, PT's for vertical and horizontal curves. Radii of all intersections (edge of pavement or flange of curb, with note indicating which is referenced).
		X	Driveways for all lots adjacent to storm inlets and intersections.
		X	Sidewalks labeled and dimensioned.
		X	Existing, proposed, future streets and drives labeled and dimensioned.
		X	All roadside ditch locations, flowline elevations at 50' intervals of the ditches.
		X	Slope intercepts.
		X	Invert profile for 200' downstream for any existing ditches receiving flow from a proposed road or street.
		X	Limits of any areas which need special stabilization techniques.
		X	Specific details of all existing connected roadways. Pavement, shoulders, ditches, curb alignment, and grades shall be shown as needed to adequately make the transition.

Intersection Details

YES	NO	N/A	
			Radii of all intersections (edge of pavement or flange of curb, with note indicating which is referenced).
		X	Sidewalks and accessible ramps labeled and dimensioned.
			Right of way corner clips and sight visibility easements.
		X	Spot grades as necessary to ensure proper drainage and compliant ADA slopes.
		×	Spot grades shall be shown at end of radius for all curb and gutter and the end radius for all back of sidewalk.
		X	Drainage clarified by flow arrows, high points, sags, ridges, etc. Slope intercepts shall be clearly labeled by station, elevation to the nearest 0.1', and offset distance (left or right) from the reference line.
		X	Invert elevation of ditches (for rural roadway).
		X	Final subgrade elevation at the centerline of the street or roadway.

Cross Sections

YES	NO	N/A	
		X	Right of way limits.
		X	Slope intercepts clearly labeled.
		X	Elevations to the nearest 0.01'.
		X	Offset distance (left or right) from the reference line.
		×	Final grade elevations at back of walk, face of walk, top of curb, flange elevation (edge of pavement for rural section), and the centerline of the street or roadway.
		X	Cross slope of sidewalk, terrace area, and roadway.
		X	Invert elevation of ditches (for rural section)



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Site, Grading and Drainage Plan **Conditional Use Permit Checklist**

Attachment C (Rev 12/18)

Project Name:		: Ha	awthorne Elementary School				
-	Engineering & Design Firm: Kapur Inc Civil Engineers						
	General Requirements						
1/50							
YES	NO	N/A	Applicant's name				
			Name and location of development				
XI NZI			Scale and north arrow				
<u>X</u>			Date of original and revisions noted				
<u>X</u>			License number and professional seal				
			Digital Drawings in AutoCAD format of the site layout & building plan layout				
			· · · · · · · · · · · · · · · · · · ·				
X			Pay impact fees				
Buildin	g Plan	<u>s</u>					
YES	NO	N/A					
			Contact Community Development Department				
Site Pla	ans						
YES	NO	N/A					
X			Dimensions of development site				
X			Location, footprint, and outside dimensions				
X			Existing and proposed pedestrian access points				
		X	Existing and proposed vehicular access points				
		X	Parking lots, driveways shown				
X			Front, side and rear yard setbacks shown and labeled				
		X	Location, identification and dimensions of all existing or planned easements				
		X	Identification of all land to be dedicated				
		X	Location, elevation, and dimensions of walls and fences				
			Location of outdoor lighting with lighting design plan and calculations				
			Sign complies with City Code Book				
			Location of existing and proposed signs				

Site Access

YES	NO	N/A	
			Legal description or certified survey of property
X			Development compatible with its zoning district
X			Sidewalks to be shown
		\boxtimes	Site entrance drive dimensions
		\boxtimes	Individual development vehicular entrances at least 125 feet apart
		X	Adjacent development share driveway where possible
		X	At least one vehicular and pedestrian access point to each adjoining site granted by cross easements
		X	Cross access to be provided with minimum paved width of 24 feet
		X	Design detail for all new public streets

Parking/Traffic

YES	NO	N/A	
X			5-foot wide (min) paved walkway to building entrance
		X	7-foot parking separation from front of building
		X	Minimum parking spaces provided
		X	Service truck parking in designated service areas
		X	Parking spaces and layout dimensioned
		X	Lot paved with HMA or concrete
		X	Handicap parking provided
		X	Minimum required stacking distance
		X	Concrete curb and gutter around parking lot

Grading and Drainage Plans

YES	NO	N/A	
X			Show existing tree lines and any obstructions (fences, structures, power poles, etc.) within the project limits.
		X	All proposed lot lines and lot numbers or addresses
		X	Lot line dimensions
			Outline of buildable areas for each lot
		X	Typical setbacks of buildable area to front, side and back lot lines
			All existing buildings, structures and foundations
		X	All existing drainage channels and watercourses
		\boxtimes	Emergency overflow routes
			Drainage clarified by flow arrows, high points, sags, ridges, and valley gutters
			Proposed retaining wall locations with top and bottom of wall elevations at key locations
			100-year flood plain limit (both pre-and post-project)
		X	100-year storm water surface elevation
			Wetlands. Wetland limits labeled with bearings and distances and dimensioned to lot lines. Bearings and distances may be shown in tabulated format.

		All environmental corridors, & or environmentally sensitive areas as required by DNR
	X	All existing and proposed easements.
X		Existing topography of the site and all areas within 50 feet of the site shown at a one foot contour interval using City of Waukesha datum. Existing contours shown as thin, dashed screened or grey lines with a readily discernable heavier line used for the 5-foot contour intervals.
X		Proposed grading shown at a contour interval of 1 foot using City of Waukesha datum. Proposed contour lines shown as solid medium lines, with a discernible heavier line use for the 5-foot contour intervals.
X		The yard grade and first floor elevation of proposed building and any existing buildings located within 150 feet of the parcel boundary.
	X	Proposed road(s), curb and gutter, all storm sewer grates and storm sewer manholes (or cross-culverts for open ditches). Show any off-road storm inlets and discharge locations with surface entry elevations.
X		Spot grades as necessary to ensure proper drainage and compliant ADA slopes and routing where applicable.
	X	At front setback line show a typical house shell on each lot and the proposed yard grade to the nearest tenth of a foot (assumed to be 0.7' below the top of block) for each building. Show proposed finished elevations to the nearest tenth of a foot at all lot corners and alongside lot lines adjacent to the front and back corners of the typical house. Show proposed finished elevations to the nearest tenth of a foot at high and low points along any side or back lot lines, and at high and low points if roads to demonstrate proposed drainage.
	X	The grading plan for any house that will require special design due to topography, clearly show separate grades for the garage and yard grade if extra steps are needed. Separate spot finish elevations shown for rear or side exposure or walkout.
	×	Indicate minimum finished floor elevations adjacent to floodplains, ponds, creeks/channels, etc.
	X	Proposed storm inlets shown on each grading plan. Each plan also includes specific details on all applicable retention/detention basins, ponds, overflows, etc. Separate sheets or notes as required.
X		Locations of existing and proposed streets, drives, alleys, easements, right-of-way, parking as required, vehicular and pedestrian access points, and sidewalks
	\boxtimes	Outline of any development stages
	X	Location and details on any required emergency access roads
		Soil characteristics
X		Existing and proposed topography shown for the site and or adjacent properties
	X	Floodplain, shore land, environmental and wetlands shown
	X	Location and dimensions of on-site storm water drainage facilities
X		Location and footprint of all existing buildings
X		Locations and species of existing trees
	X	Berm detail
	X	Lot grades and swales shown
		Drainage calculations provided

Erosion Control

YES	NO	N/A	
\boxtimes			Location Map
		\boxtimes	Soils Survey Map
		\boxtimes	Existing Land Use Mapping
\boxtimes			Predeveloped Site Conditions
\boxtimes			Existing contours
\boxtimes			Property lines
\boxtimes			Existing flow paths and direction
		X	Outlet locations
		X	Drainage basin divides and subdivides
		X	 Existing drainage structures on and adjacent to the site
		X	Nearby watercourses
		X	 Lakes, streams, wetlands, channels, ditches, etc.
		X	Limits of the 100-year floodplain
X			Practice location/layout/cross sections
X			Construction Details
		X	Name of receiving waters
X			Site description/Nature of construction activity
X			Sequence of construction
X			Estimate of site area and disturbance area
		X	Pre- and post-developed runoff coefficients
X			Description of proposed controls, including
		X	Interim and permanent stabilization practices
		X	Practices to divert flow from exposed soils
X			Practices to store flows or trap sediment
		X	Any other practices proposed to meet ordinance
X			Existing topography of the site and all areas within 50 feet of the site shown at a one foot contour interval using City of Waukesha datum. Existing contours shown as thin, dashed screened or grey lines with a readily discernable heavier line used for the 5-foot contour intervals.
X			Proposed grading shown at a contour interval of 1 foot using City of Waukesha datum. Proposed contour lines shown as solid medium lines, with a discernible heavier line use for the 5-foot contour intervals.
\boxtimes			List the total disturbed acreage including offsite areas.
			Provide free survey in accordance with City Erosion Control Ordinance
X			Proposed limits of disturbance including proposed tree cutting areas.
		\boxtimes	Location and dimensions of all temporary topsoil and dirt stockpiles.
X			Location and dimensions of all appropriate best management practices (BMP).
		X	Phasing of BMP's with the construction activities listed / described.
		×	Schedule of anticipated starting and completion date of each land disturbing and land developing activity, including the installation of the BMP measures that are needed.
		X	Location of all channels, pipes, basins or other conveyances proposed to carry runoff to the nearest adequate outlet, including applicable design assumptions and computations.

		Areas to be sodded or seeded and mulched or otherwise stabilized with vegetation, describing the type of final vegetative cover.
		Areas of permanent erosion control (other than vegetation).
X		Boundaries of the construction site
X		Drainage patterns/slopes after grading activities
X		Areas of land disturbance
X		Locations of structural and nonstructural controls
	X	Drainage basin delineations and outfall locations

Optional Submittals as Determined by Review Authority

YES	NO	N/A	
		\boxtimes	Traffic impact analysis
		\boxtimes	Environmental impact statement
		X	Soil and Site Evaluation Report per DNR Technical Standard 1002
		X	Plot of effect of exterior illumination on site and adjacent properties
		\boxtimes	Description of any unusual characteristics
		\boxtimes	Street perspectives showing view corridors
		\boxtimes	Historic site
			Economic feasibility study
		\boxtimes	Contaminated Waste Site

I hereby certify that I have reviewed the City ordinances and provided one (1) full-sized set of all required information along with all the required reduced copies of plans.



City of Waukesha Department of Public Works 130 Delafield Street Waukesha, WI 53188 Waukesha-wi.gov

Landscape Plan Checklist

Attachment I (Rev 04/18)

Project Name: H	Hawthorne Elementary School					
Engineering & Desi	ign Firm: Kapur Inc Civil Engineers					

□ Cor	□ Contact Community Development Department for Requirements							
Listed below are general design considerations only:								
YES	NO	N/A						
		X	Show easements					
X			Location and footprint of any and all buildings					
		\boxtimes	Dimensions of development site along property line					
X			Existing and proposed streets					
X			Pedestrian and vehicular access points					
		X	Location and dimensions of parking lots, etc.					
		X	Location and dimensions of all existing or planned easements					
		X	Location and dimensions of snow removal and storage areas					
			Location and dimensions of outdoor lighting fixtures					
		X	Interior parkway provided					
		X	Parkway provided					
		X	Buffer strip provided					
		X	Dumpster enclosure details					
		X	Parking lot landscaping					
		X	Utility/mechanical equipment screened					
		X	Service area screened					
		X	Location of freestanding signs					
		X	Walls and fences shown					
		X	Location of utilities					
X			Existing and proposed contours and grades, including berm elevations					
X			Location, name and size of proposed plant materials					
X			Specifications of all types of all proposed ground cover, i.e., seed, sod, etc.					
X			Location, species, and size of existing trees					
X			Clear identification of trees to be removed					
		X	Square footage of parking lot area					
		X	Tree protection plan					