



Exterior Renovations and ADA Upgrade for **TRI CITY NATIONAL BANK**

201 East Sunset Drive
Waukesha, Wisconsin
52189



Architect


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Owner

NDC LLC
6312 South 27th Street
Oak Creek, Wisconsin 53154
Phone: 414-530-1333

Date

Review Set February 12, 2018

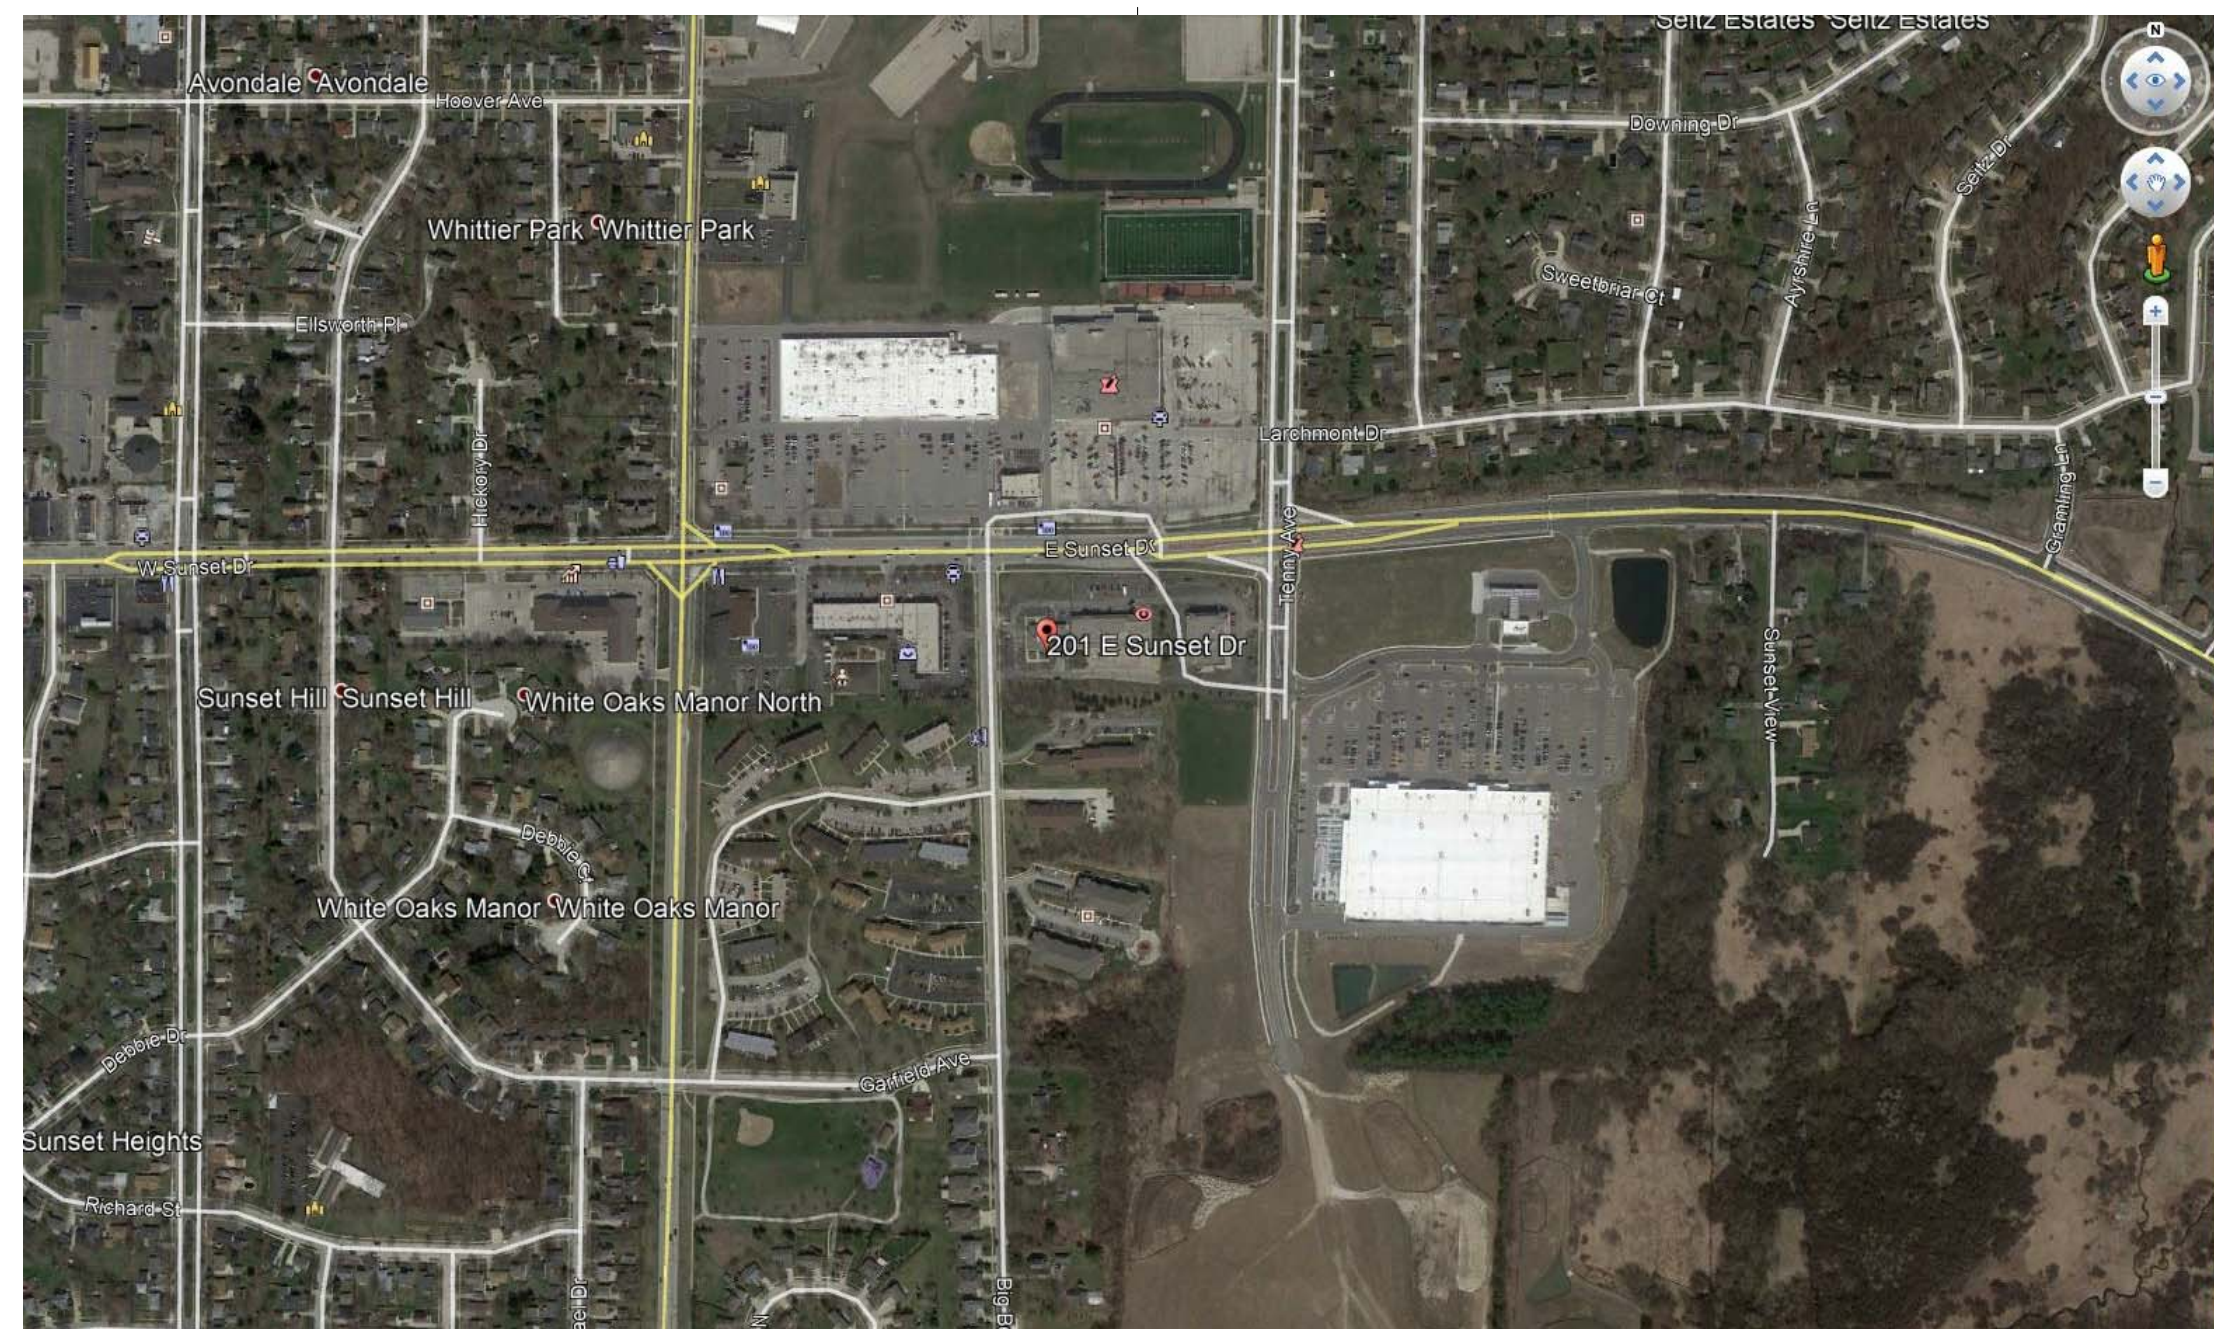

2 PROJECT LOCATION

DIVISION 1 GENERAL CONDITIONS

SECTION 01 100 - SUMMARY

- 1.1 SUMMARY OF WORKS:
- A. Project: Exterior Renovations and ADA upgrade for TRI CITY NATIONAL BANK
201 East Sunset Drive
Waukesha, Wisconsin 52109
 - B. BUILDING OWNER: NDC LLC
6312 South 27th Street
Oak Creek, Wisconsin 53154
 - C. Architect: Russell E. LaFrombois, III, LLC
229 East Wisconsin Avenue Suite 701
Milwaukee, Wisconsin
- D. The Work consists of the remodeling of the building as described in the Contract Documents.
- END OF SECTION 01 100

SECTION 01 600 - PRODUCT REQUIREMENTS

- 1.1 SECTION REQUIREMENTS
- A. Provide products of same kind from a single source. The term "product" includes the terms "material," "equipment," "system," and "similar terms."
 - B. Product Substitutions: Substitutions include products and methods of construction differing from that required by the Contract Documents and proposed by Contractor after award of the Contract.
 1. Submit four copies of each request for product substitution.
 2. Submit requests within 10 days after signing the Contract.
 3. Submit requests in time to permit processing of request and subsequent submittals, if any, sufficiently in advance of when materials are required in the Work. Do not submit unapproved substitutions on Shop Drawings or other submittals.
 4. Identify product to be replaced and provide complete documentation showing compliance of proposed substitution with applicable requirements. Include a full comparison with the specified product, a list of changes to other Work required to accommodate the substitution, and any proposed changes in the Contract Sum or the Contract Time should the substitution be accepted.
 5. Architect will review the proposed substitution and notify Contractor of its acceptance or rejection.
 - C. Comparable Product Submittal:
 1. Submit four copies of each request for approval of products as comparable to basis-of-design products. Submit requests in time to permit processing of request and subsequent submittals, if any, sufficiently in advance of when materials are required in the Work. Do not submit unapproved products on Shop Drawings or other submittals.
 2. Identify product to be replaced and provide complete documentation showing compliance of proposed product with applicable requirements. Include a full comparison with the specified product.
 3. Architect will review the proposed product and notify Contractor of its acceptance or rejection.
 - D. Deliver, store, and handle products using means and methods that will prevent damage, deterioration, and loss, including theft. Comply with manufacturer's written instructions.
 1. Schedule delivery to minimize long-term storage at Project site and to prevent overcrowding of construction spaces.
 2. Deliver products to Project site in manufacturer's original sealed container or packaging, complete with labels and instructions for handling, stoning, unpacking, protecting, and installing.
 3. Inspect products on delivery to ensure compliance with the Contract Documents and to ensure that products are undamaged and properly protected.
 4. Store materials in a manner that will not endanger Project structure.
 5. Store products that are subject to damage by the elements, under cover in a weathertight enclosure above ground, with ventilation adequate to prevent condensation.
- 1.2 PRODUCT OPTIONS
- A. Provide products that comply with the Contract Documents, are undamaged, and are new at the time of installation.
 1. Provide products complete with accessories, trim, finish, and other devices and components needed for a complete installation and the intended use and effect.
 - B. Select products to comply with all of the following that are applicable:
 1. Where only a single product or manufacturer is named, provide the item indicated. No substitutions will be permitted.
 2. Where two or more products or manufacturers are named, provide one of the items indicated. No substitutions will be permitted.
 3. Where products or manufacturers are specified by name, accompanied by the term "available products" or "available manufacturers," provide one of the named items or comply with provisions for "comparable product" to obtain approval for use of an unnamed product or manufacturer.
 4. Where a single product is named as the "basis-of-design" together with the names of other manufacturers, provide the named product or comply with provisions for "comparable product submittal" to obtain approval for use of a product of one of the other named manufacturers.
 5. Where a product is described with required characteristics, provide a product that complies with those characteristics.
 6. Where compliance with performance requirements is specified, provide products that comply and are recommended in writing by the manufacturer for the application.
 7. Where compliance with codes, regulations, or standards, is specified, select a product that complies with the codes, regulations, or standards referenced.
 - C. Unless otherwise indicated, Architect will select color, pattern, and texture of each product from manufacturer's full range of options that includes both standard and premium items.
- END OF SECTION 01 600

CONSTRUCTION NOTES APPLIES TO ALL CONTRACTORS

- A. ALL CONTRACTORS SHALL COORDINATE WORK WITH LANDLORD'S STANDARDS FOR WORK.
- B. CONTRACTOR SHALL OBTAIN ALL NECESSARY PERMITS AND PAY ALL REQUIRED FEES.
- C. CONTRACTOR SHALL GUARANTEE ALL LABOR AND MATERIALS FOR ONE (1) YEAR.
- D. CONTRACTOR SHALL SUPERVISE AND DIRECT ALL WORK USING HIS BEST SKILL AND ATTENTION. CONTRACTOR SHALL BE SOLELY RESPONSIBLE FOR ALL CONSTRUCTION MEANS AND METHODS TECHNIQUES AND SEQUENCES OF PROCEDURES, FOR COORDINATING ALL PORTIONS OF THE WORK UNDER THE CONTRACT.
- E. CONTRACTOR SHALL EXAMINE SITE, FIELD VERIFY ALL DIMENSIONS AND FIELD CONDITIONS PRIOR TO SUBMITTAL OF BID. COORDINATE ALL SITE VISITS W/ THE BUILDING OWNER/TENANT. CONTRACTOR SHALL BECOME FAMILIAR WITH CONDITIONS AFFECTING THE WORK PRIOR TO BEGINNING OF WORK.
- F. DIMENSIONS INDICATED IN CONTRACT DOCUMENTS SHALL GOVERN. DO NOT SCALE DRAWINGS. CONTRACTOR SHALL NOTIFY ARCHITECT OF ANY DISCREPANCIES PRIOR TO THE CONTINUATION OF WORK.
- G. IN CASE OF CONFLICT BETWEEN DRAWINGS, LARGER SCALE DRAWINGS SHALL TAKE PRECEDENCE OVER SMALLER SCALE DRAWINGS.
- H. DEFINITIONS
 1. "ALIGN" SHALL MEAN TO ACCURATELY LOCATE FINISH FACES IN THE SAME PLANE.
 2. "SIMILAR" MEANS COMPARABLE CHARACTERISTICS FOR THE CONDITION NOTED. VERIFY DIMENSIONS AND ORIENTATION ON PLANS AND ELEVATIONS.

PATCHING AND CUTTING APPLIES TO ALL CONTRACTORS

- A. GENERAL: AT ALTERED CONSTRUCTION, REPAIR CUT EDGES, REPLACE CONSTRUCTION AND FIT NEW TO EXISTING CONSTRUCTION AS REQUIRED TO MATCH EXISTING WORK. MAKE JOINTS OF NEW AND EXISTING PATCHES SMOOTH, AND EVEN. PREPARE WALL FOR NEW FINISHES. SEE ROOM FINISH SCHEDULE.
- B. ALL FLOOR PENETRATIONS MUST MAINTAIN THE 2 HOUR FIRE CODE RATING.
- C. WHERE NEW PAINT OR OTHER FINISHES ARE JOINED, CARRY TO NEAREST BREAK IN SURFACES, CORNER, OR OTHER BREAK IN CONSTRUCTION AS REQUIRED FOR CONTINUOUS FINISHED APPEARANCE.
- D. CONCRETE: WHERE FLOORS REQUIRE LEVELING, PROVIDE MINIMUM 2,500 PSI PORTLAND CEMENT. COAT CONCRETE JOINED WITH NEW CONCRETE WITH CONCRETE BOND; MIX AND APPLY IN STRICT ACCORDANCE WITH MANUFACTURER'S RECOMMENDATIONS FOR THE CONDITIONS OF THE APPLICATION.
- E. DOORS AND FRAMES: CAREFULLY REMOVE DOORS FROM FRAMES AND REMOVE FRAMES FROM OPENING, AVOID DAMAGE. REMOVE HARDWARE, AND STORE PER OWNER INSTRUCTIONS. REPAIR AND REWORK FRAMES AND DOORS AS REQUIRED FOR REINSTALLATION WHERE INDICATED. FOR DOORS AND FRAMES TO BE SALVAGED, CAREFULLY REMOVE FROM OPENING AND DELIVER FOR STORAGE AS DIRECTED BY OWNER.

ELECTRICAL NOTES

- A. ELECTRICAL SHALL BE DESIGN BUILD. CONTRACTOR SHALL BE RESPONSIBLE FOR OBTAINING SEPARATE PERMIT. THE WORK SHALL BE INCLUDED IN BID.
- B. ELECTRICAL WORK SHALL BE DESIGNED AND BUILT IN ACCORDANCE WITH THE FOLLOWING:
 - IBC 2009
 - IEBC 2009
 - IEC 2009
 - SFS 361-366
- C. ELECTRICAL DEVICES AND ALL WIRING FOR ELECTRICAL OUTLETS, CONTROL DEVICES, OR OTHER ELECTRICAL DEVICES SHALL BEAR APPROVAL OF UNDERWRITERS LABORATORIES AND SHALL BE RATED FOR PLENUM CEILING.
- D. ELECTRICAL CONTRACTOR SHALL BE RESPONSIBLE FOR DETERMINING ELECTRICAL REQUIREMENTS FOR THE SCOPE OF THE WORK AND THAT ADEQUATE POWER IS AVAILABLE TO THE MODIFIED SPACES. ACCOMMODATE REVISED AREAS. WORK SHALL INCLUDE BUT IS NOT LIMITED TO:
 1. PROVIDE EXTERIOR LIGHTING IN NEW CANOPY.
 2. COORDINATE ELECTRICAL REQUIREMENTS OF ALL SIGNAGE.
 3. SUBMITTING LIGHTING CALCULATIONS ARE REQUIRED.
 4. SUBMITTING EMERGENCY LIGHTING PLANS AS REQUIRED.
- D. ELECTRICAL CONTRACTOR SHALL BE RESPONSIBLE FOR THE SUBMITTAL OF LIGHTING CALCULATIONS. SHOULD COMPLIANCE WITH COMM CHAPT 63 REQUIRE A REVISION TO THE PROPOSED LAYOUT THE CONTRACTOR SHALL COORDINATE WITH THE ARCHITECT.
- E. ELECTRICAL ITEMS ARE SHOWN FOR LOCATION ONLY. ELECTRICAL SUBCONTRACTOR SHALL BE RESPONSIBLE FOR CIRCUITING AND SWITCHING IN ACCORDANCE WITH CODE.
- F. INDICATED DIMENSIONS ARE TO THE CENTERLINE OF THE RECEPTACLE OR CLUSTER OF RECEPTACLES, UNLESS OTHERWISE NOTED. WHERE ELECTRICAL RECEPTACLES, TELEPHONE/DATA RECEPTACLES, ETC. ARE SHOWN ADJACENT, LOCATE AS CLOSELY AS POSSIBLE AT DIMENSION LINES SHOWN.
- G. STANDARD ELECTRICAL WALL RECEPTACLES SHALL BE MOUNTED VERTICALLY, AT 18" MIN. ABOVE UNFINISHED FLOOR TO CENTER OF BOX UNLESS OTHERWISE NOTED.
- H. RECEPTACLES SHALL NOT BE INSTALLED BACK TO BACK.
- I. PROVIDE EMERGENCY LIGHTING AND ILLUMINATED EXIT SIGNS AS REQUIRED BY THE STATE OF WISCONSIN AND LOCAL OFFICIALS.
- J. ALL CEILING FIXTURES AND WIRING FOR LIGHT FIXTURES, EXIT SIGNS, OR OTHER ELECTRICAL DEVICES SHALL BE U.L. APPROVED AND SHALL BE INSTALLED IN RIGID CONDUIT.
- K. LIGHT FIXTURES: SUBMITTALS FOR ALL LIGHT FIXTURES INCLUDING SPECIFICATIONS AND LOCATIONS ARE REQUIRED FOR APPROVAL BY OWNER PRIOR TO PURCHASE OF MATERIALS/FIXTURES. ALL FIXTURES TO MEET LANDLORD STANDARDS.
- L. LIGHT FIXTURE PLACEMENT MAY BE ADJUSTED FOR UNIFORM LIGHT LEVELS SUBJECT TO APPROVAL BY OWNER.
- M. ALL LIGHT FIXTURES SHALL BE FULLY OPERATIONAL. REPLACE LAMPS, REPAIR BALLAST, AND CLEAN OR REPLACE LENSES AS REQUIRED.
- N. ELECTRICAL OUTLETS ILLUSTRATED ON ARCHITECTURAL PLANS ARE FOR REFERENCE ONLY. THE ELECTRICAL CONTRACTOR SHALL PROVIDE OUTLETS AS REQUIRED BY CODE AND TO MEET OWNER REQUIREMENTS.
- O. WHERE WALL MOUNTED PHONE, AND CABLE OUTLETS ARE SHOWN, THE CONTRACTOR SHALL PROVIDE PULL STRINGS AND RINGS. PHONE, DATA AND CABLE WIRING AND TERMINATIONS SHALL BE BY TENANT. COORDINATE WITH LANDLORD'S STANDARDS FOR TELEPHONE DATA AND CABLE CONNECTIONS.
- P. ELECTRICAL CONTRACTOR SHALL SUBMIT PLANS AND SPECIFICATIONS TO OWNER FOR REVIEW.

STRUCTURAL NOTES

GENERAL NOTES

- 1. VERIFY ALL CONDITIONS AND DIMENSIONS IN THE FIELD PRIOR TO FABRICATION OF ANY MATERIAL OR PERFORMING ANY WORK.
- 2. WHERE DRAWINGS AND SPECIFICATIONS LANGUAGE DISAGREE, SPECIFICATIONS SHALL TAKE PRECEDENT.
- 3. LOADS:
 - ROOF LOADS: 1.6 PSF (DEAD) 30 PSF (LIVE) = 46 PSF (TOTAL)
 - DECK LOADS: 2.1 PSF (DEAD) 40 PSF (LIVE) = 61 PSF (TOTAL)
 - FLOOR LOADS: 1.6 PSF (DEAD) 40 PSF (LIVE) = 56 PSF (TOTAL)
- WOOD NOTES
 1. ALL CONSTRUCTION SHALL BE EXECUTED IN CONFORMANCE WITH THE REQUIREMENTS OF THE FOLLOWING:
 - PLYWOOD- US PRODUCT STANDARDS PS 1-83
 - SOFT WOOD PLYWOOD STRUCTURE SDX U.N.O.
 - SHEATHING SHALL BE AS FOLLOWS U.N.O.
 - ROOF: 5/8" OSB
 - WALLS: 5/8" OSB
 - PLYWOOD UNDERLAYMENT: 3/4" TONGUE AND GROOVE.
 2. LAY ALL STRUCTURAL PLYWOOD ON ROOF AND FLOORS WITH FACE GRAIN PERPENDICULAR TO SUPPORTS UNLESS NOTED OTHERWISE. PROVIDE "H" CLIPS AT MID SPAN BETWEEN ADJOINING SHEETS.
 3. PRESSURE TREATED DOUGLAS FIR - 1988 UBC STANDARD NO. 25-12
 4. ALL STRUCTURAL WOOD SHALL CONFORM WITH THE FOLLOWING SPECIFICATIONS:
 - DOUGLAS FIR - COAST REGION - WCLB GRADING RULES #1 6
 - BEAMS JOISTS AND POSTS - DF #1 STRUCTURAL
 - STUDS AND BLOCKING - DF #1 STRUCTURAL U.N.O.
 - PLATES - DF #1
 5. ALL WOOD IN DIRECT CONTACT WITH EARTH OR CONCRETE SHALL BE PRESSURE TREATED BEARING AND SHEAR WALLS SHALL HAVE DOUBLE TOP PLATE LAPPED AT WALL AND PARTITION INTERSECTION WITH (3) 1GD NAILS. STAGGER SPLICES OF UPPER AND LOWER TOP PLATES
 7. PROVIDE SOLID BLOCKING BETWEEN JOISTS AND RAFTERS AT ALL SUPPORTS
 8. HOLES FOR BLOTS IN WOOD SHALL BE PORED WITH A BIT OF THE SAME NOMINAL DIAMETER AS THE BOLT PLUS 1/16"
 9. HOLES FOR LAG SCREWS SHALL BE FIRST BORED TO THE SAME NOMINAL DIAMETER AND DEPTH AS THE SHANK AND THE REST NO LARGER THAN THE ROOF OF THE THREAD.
 10. LAG SCREWS AND WOOD SCREWS SHALL BE SCREWED AND NOT DRIVEN INTO PLACE. SOAP MAY BE USED TO LUBRICATE SCREWS.
 11. ALL BOLTS AND LAG SCREWS SHALL BE PROVIDED WITH METAL WASHERS UNDER HEADS AND NUTS WHICH BEAR ON WOOD (APPLIES ALSO TO INSERTED EXPANDING FASTENERS, RED HEAD ETC).

BOLT DIAMETER	MACHINE WASHER	STEEL PLATE WASHER
5/8" DIA	2 3/4" DIA X 1/16"	2 1/2" X 2 1/2" X 1/4"
3/4" DIA	3" DIA X 7/16"	3" X 3" X 5/16"
7/8" DIA	3 1/2" DIA X 7/16"	3 1/2" X 3 1/2" X 3/8"
1" DIA	4" DIA X 1/2"	3 3/4" X 3 3/4" X 3/8"
 12. ALL BOLTS AND LAG SCREWS SHALL BE TIGHTENED ON INSTALLATION AND RETIGHTED BEFORE CLOSING IN OR AT THE COMPLETION OF THE JOB (IF DROPPED)
 13. CONNECTOR HARDWARE MODEL NUMBERS ARE THOSE FOR THE SIMPSON STRONG TIE COMPANY. EQUIVALENT CONNECTORS WITH I.C.B.O. ACCEPTANCE MAY BE SUBSTITUTED. ALL JOIST HANGERS HSALL BE SIMPSON U STANDARD UNLESS NOTED OTHERWISE.
 14. ALL NAILS FOR STRUCTURAL WORK SHALL BE COMMON WIRE NAILS CONFORMING TO THE FOLLOWING MINIMUM SIZES:
 - 8D 0.131" DIAMETER X 2 1/2"
 - 10D 0.148" DIAMETER X 3"
 - 10D SHORTS 0.148" DIAMETER X 1 5/8" + THICKNESS OF SPLICE
 - 16D 0.162" DIAMETER X 3 1/2"
 - 20D 0.192" DIAMETER X 4"
- 15. HOLES SHALL BE PRE-DRILLED WHERE NECESSARY TO PREVENT SPLITTING. NAILING PATTERNS AND SCHEDULES SHALL BE IN ACCORDANCE WITH THE IBC 2009 WISCONSIN ENROLLED VERSION TABLE 2304.9.1 "FASTENING SCHEDULE"

TRUSS NOTES

- 1. TRUSS MANUFACTURER SHALL VERIFY ALL DIMENSIONS WITH THE ARCHITECT'S DRAWING AND IN THE FIELD.
 - 2. LOCATIONS OF TRUSS GIRDERS AND HIP TRUSSES SHALL BE REVIEWED BY THE ARCHITECT PRIOR TO FABRICATION OF ANY MATERIAL.
 - 3. TRUSS DESIGNER SHALL VERIFY ADEQUACY OF ALL TRUSS, AND GIRDER TRUSS BEARING AREAS. TRUSS DESIGNER SHALL NOTIFY THE ARCHITECT IF INSUFFICIENT AREA IS CALLED FOR.
 - 4. SUBMIT TRUSS DESIGN SHOP DRAWINGS FOR ARCHITECT'S REVIEW PRIOR TO FABRICATION ANY MATERIAL.
 - 5. UNLESS NOTED OTHERWISE ALL FLOOR TRUSSES SHALL BE SPACED AT 16" OC MAX AND SHALL BE BOTTOM CHORD BEARING.
 - 6. ALL TRUSSES SHALL BE MANUFACTURED WITH GRADE 4X21 1950F 1.7E MRS OR BETTER.
- CONCRETE NOTES**
- 1. ALL CONCRETE WALLS SHALL BE 4000 PSI IN 28 DAYS
 - 2. CONCRETE SLABS SHALL BE 4000 PSF IN 28 DAYS
 - 3. REINFORCEMENT FOR CONCRETE WALLS SHALL BE ASTM A615 GR 60
 - 4. REINFORCEMENT FOR SLABS ON GRADE SHALL BE WWM GG 1.4 X 1.4 MID THICKNESS OF SLAB.

SHEET INDEX

Sheet Number	Sheet Name
T1	SHEET INDEX AND GENERAL NOTES
C1	LANDSCAPING PLANS
C2	PAVING PLANS
A1	OVERALL PLAN AND TELLER LINE PLANS
A2	CANOPY PLANS AND DETAILS
A3	ROOF PLANS
A4	NORTH ELEVATIONS
A5	WEST ELEVATIONS
A6	SPECIFICATIONS

BUILDING DATA

APPLICABLE CODES	INTERNATIONAL EXISTING BUILDING CODE
A. BUILDING CODE	INTERNATIONAL BUILDING CODE, WISCONSIN ENROLLED VERSION, LATEST EDITION WISCONSIN SFS 361-366
PROPOSED OCCUPANCY INCIDENTAL USE PREVIOUS OCCUPANCY	B BUSINESS B EDUCATIONAL (NO SEPARATION REQUIRED) B BUSINESS
B. ZONING CODE ZONING CLASSIFICATION ZONING USE	WALUKESHA COMMERCIAL COMMERCIAL
PROJECT INFORMATION TENANT SQUARE FOOTAGE CURRENT PROPOSED	-NO CHANGE - -NO CHANGE-
CAPACITY OF BUILDING OFFICE PLUMBING REQUIREMENTS-NO CHANGE-	-NO CHANGE- +
CONSTRUCTION EXTENT	EXTERIOR + ADA UPGRADE AT TELLER LINE
IEBC CLASSIFICATION OF WORK:	ALTERATION LEVEL 1
RELEVANT CHAPTERS OF IEBC CHAPTER 6	BUILDING ELEMENTS AND MATERIALS FIRE PROTECTION MEANS OF EGRESS ACCESSIBILITY:
602.1-4 603. 604.1 605.1	NO CHANGE REQUIRED NO CHANGE REQUIRED NO CHANGE REQUIRED NEW SERVICE COUNTER TO MEET ANSH 117 REQUIREMENTS NA
606 607	STRUCTURAL ENERGY CONSERVATION
	NA NA

Exterior Renovations for TRI CITY NATIONAL BANK

201 East Sunset Drive
Waukesha, Wisconsin



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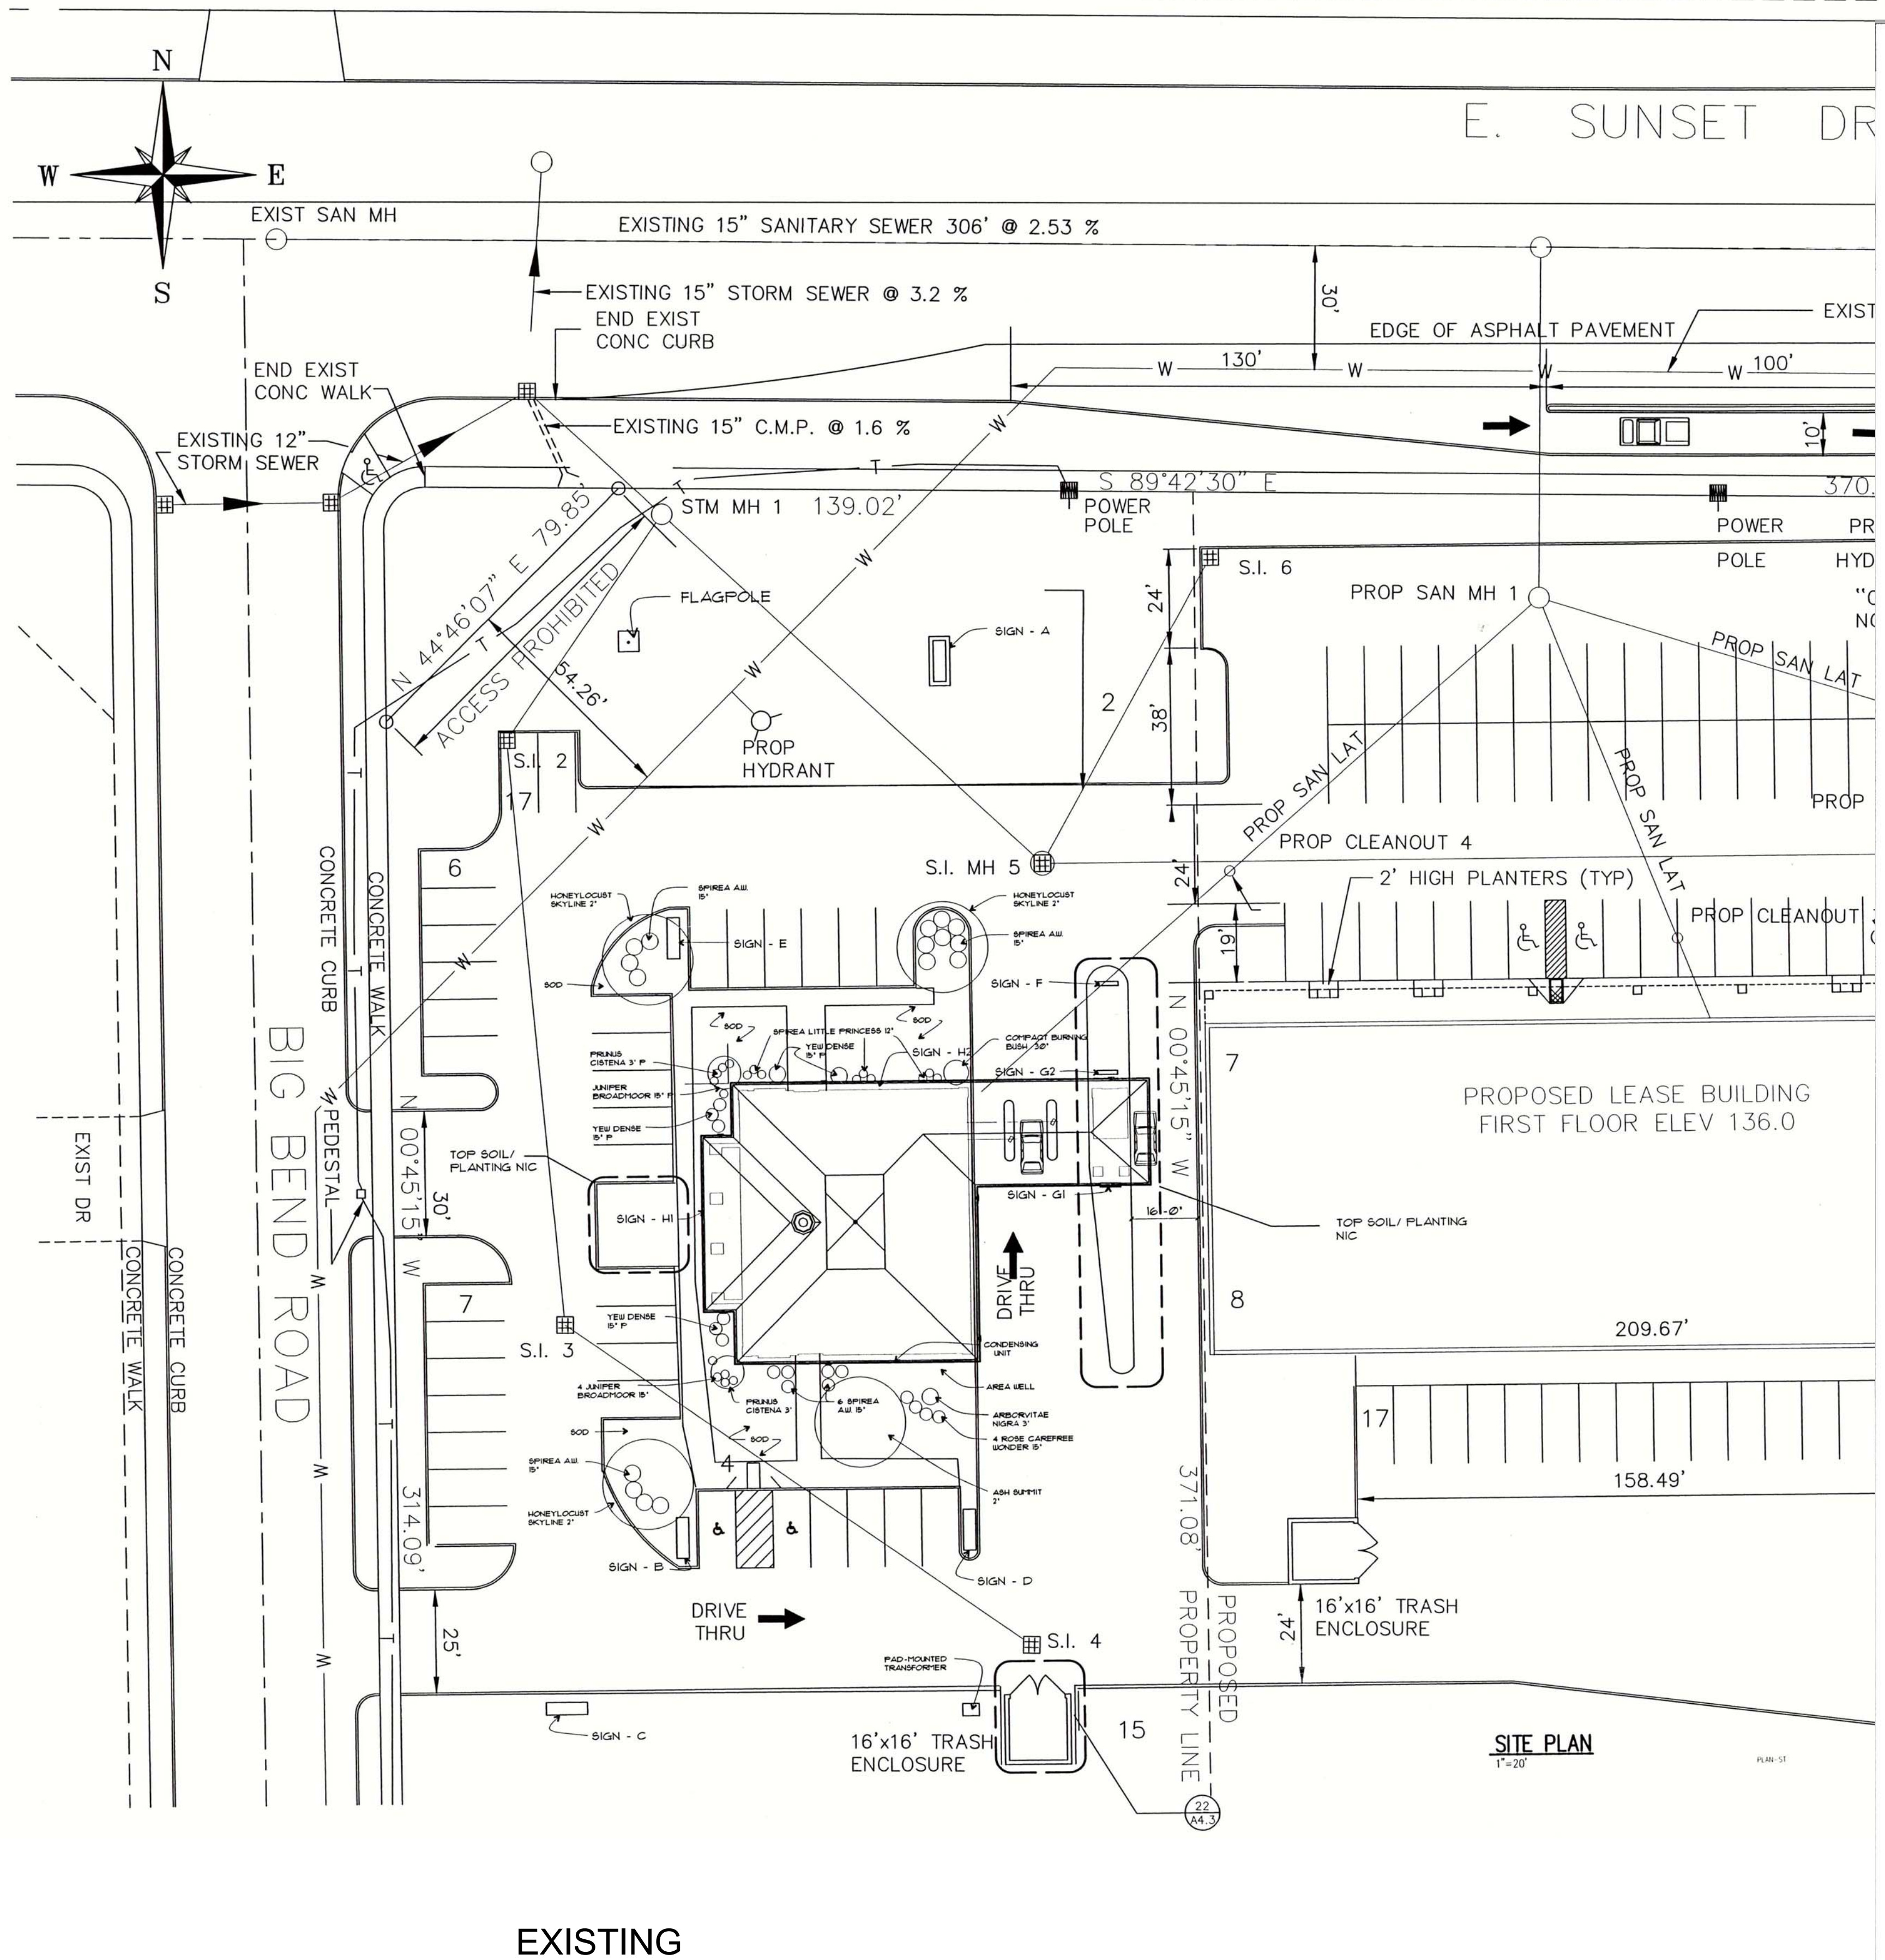
Sheet Number
SHEET INDEX AND
GENERAL NOTES

T1


Date 02-12-18
Project Number: 176006



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EXISTING




PROPOSED

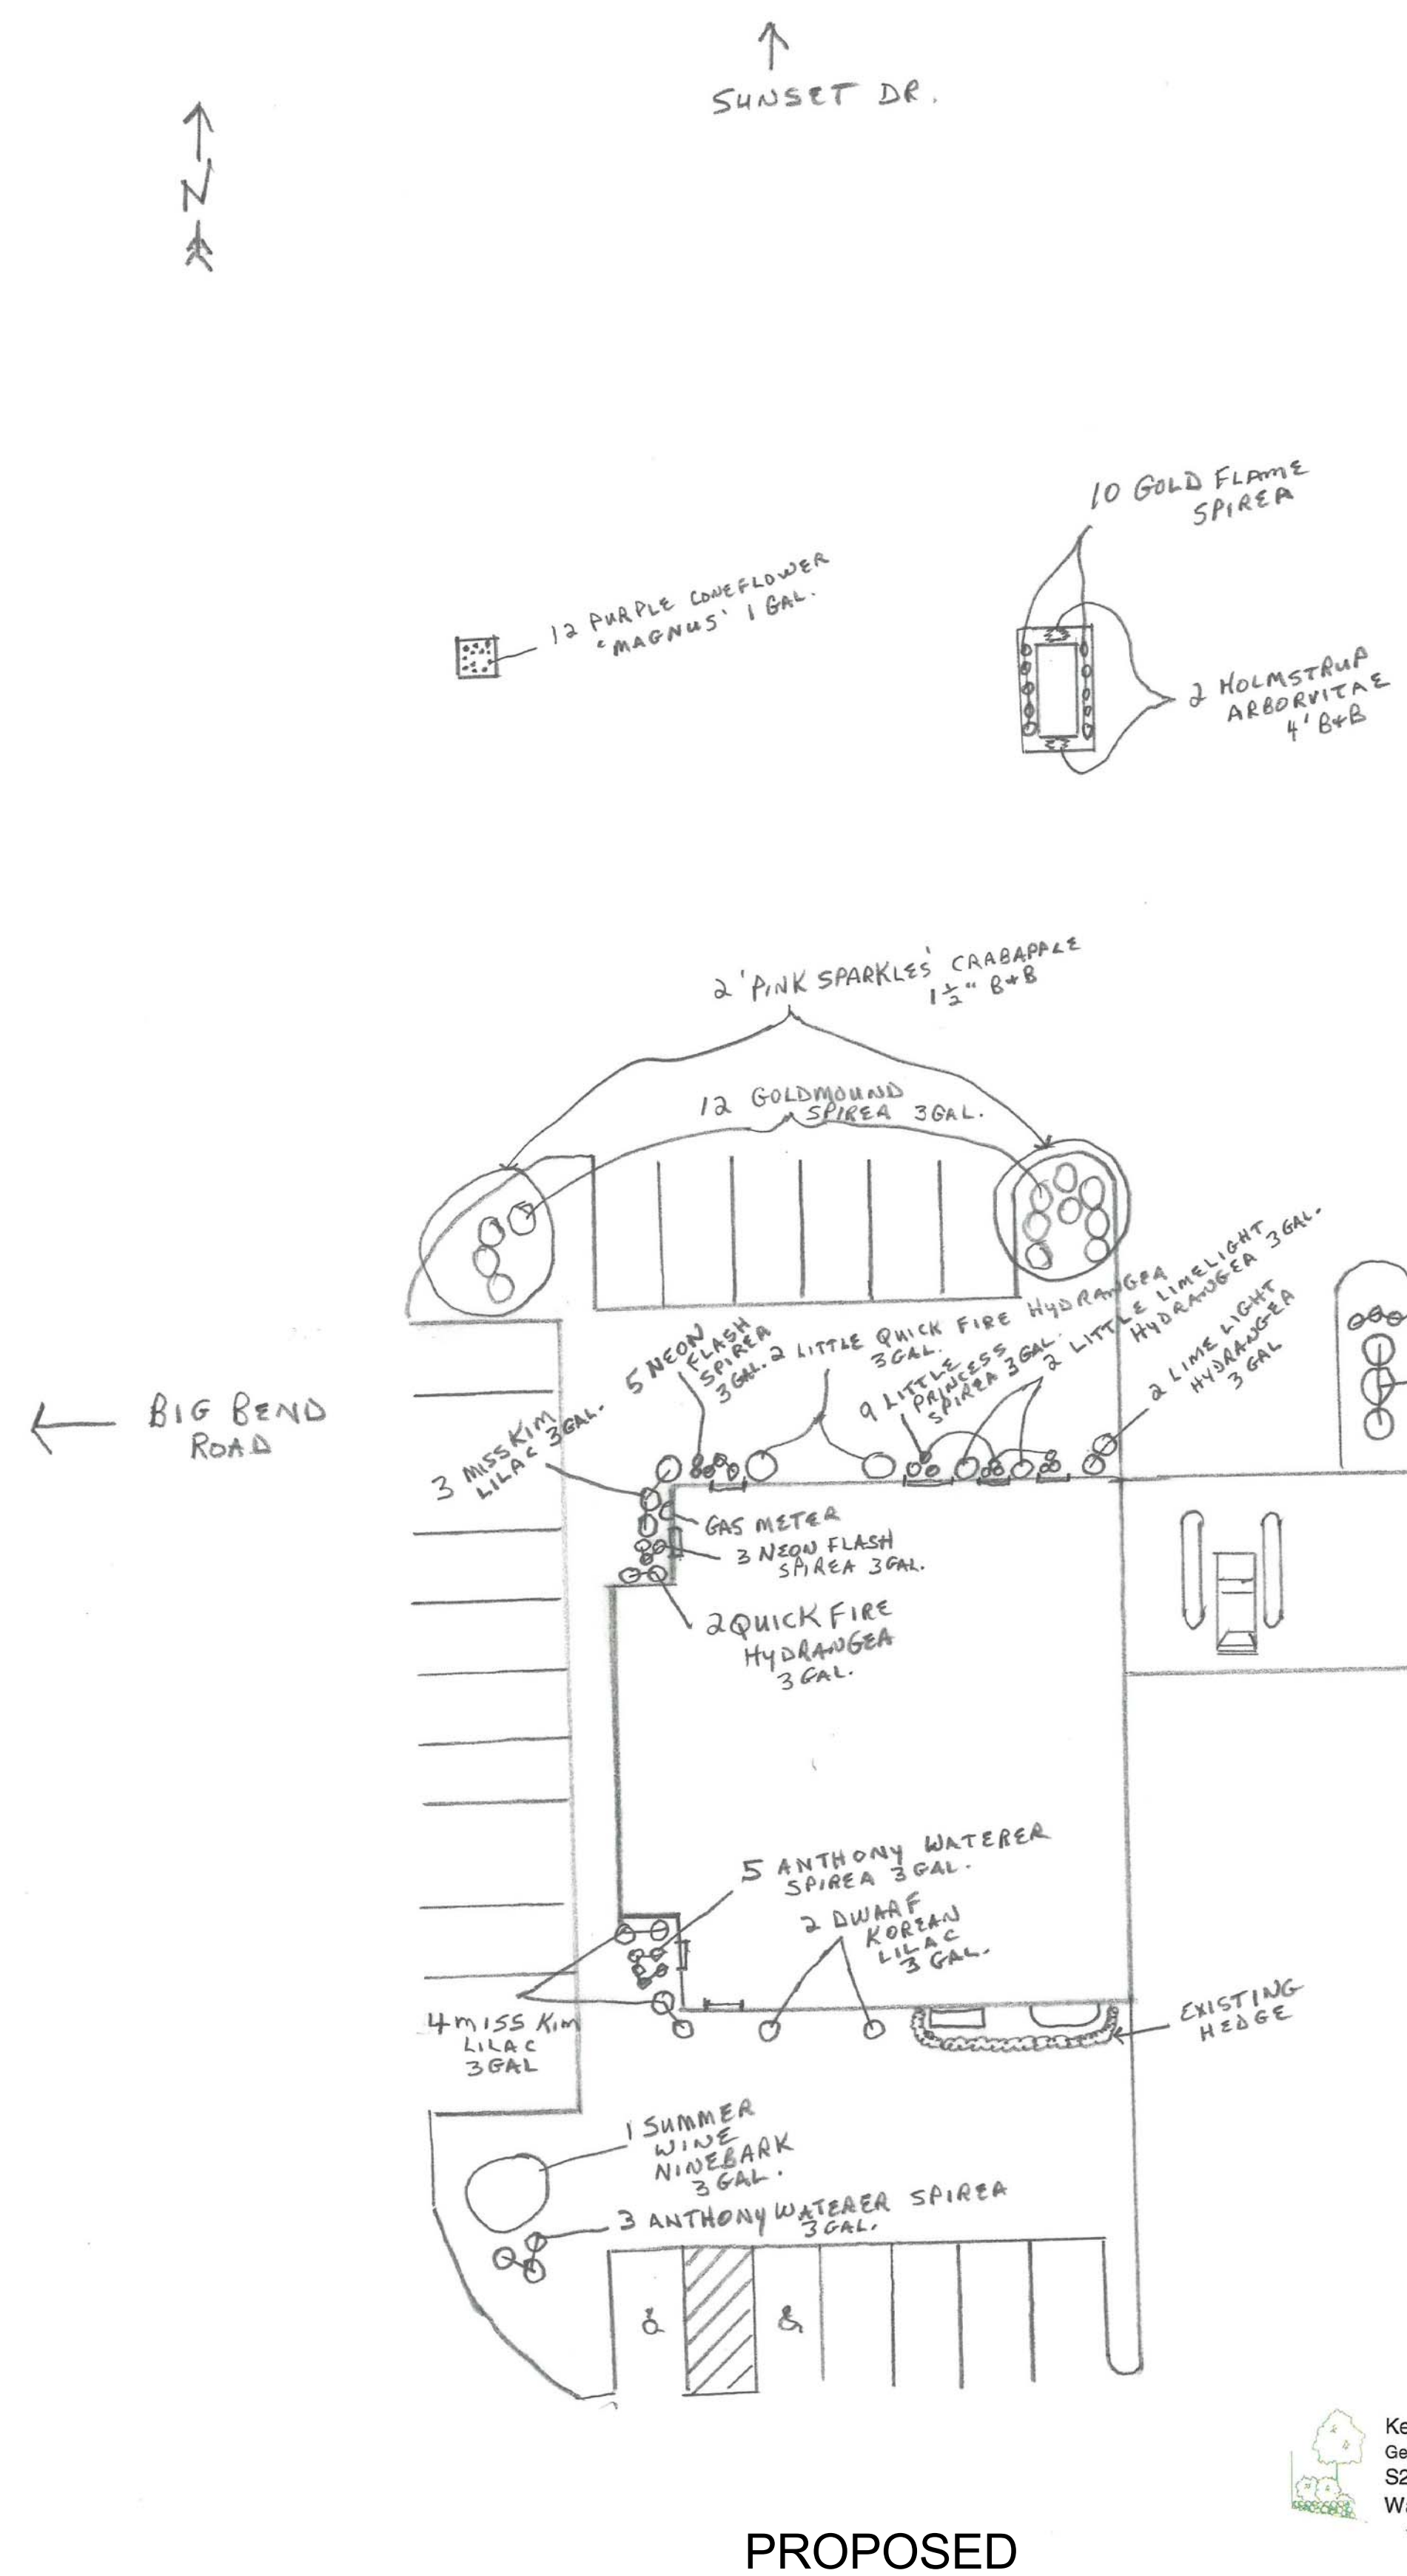
Kerry W. "BUZZ" Elwood
 Genesee Nursery & Landscaping
 S29 W31189 Hwy DE
 Waukesha, WI 53189
 2-11-18



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POBLOCKI PAVING CORP.

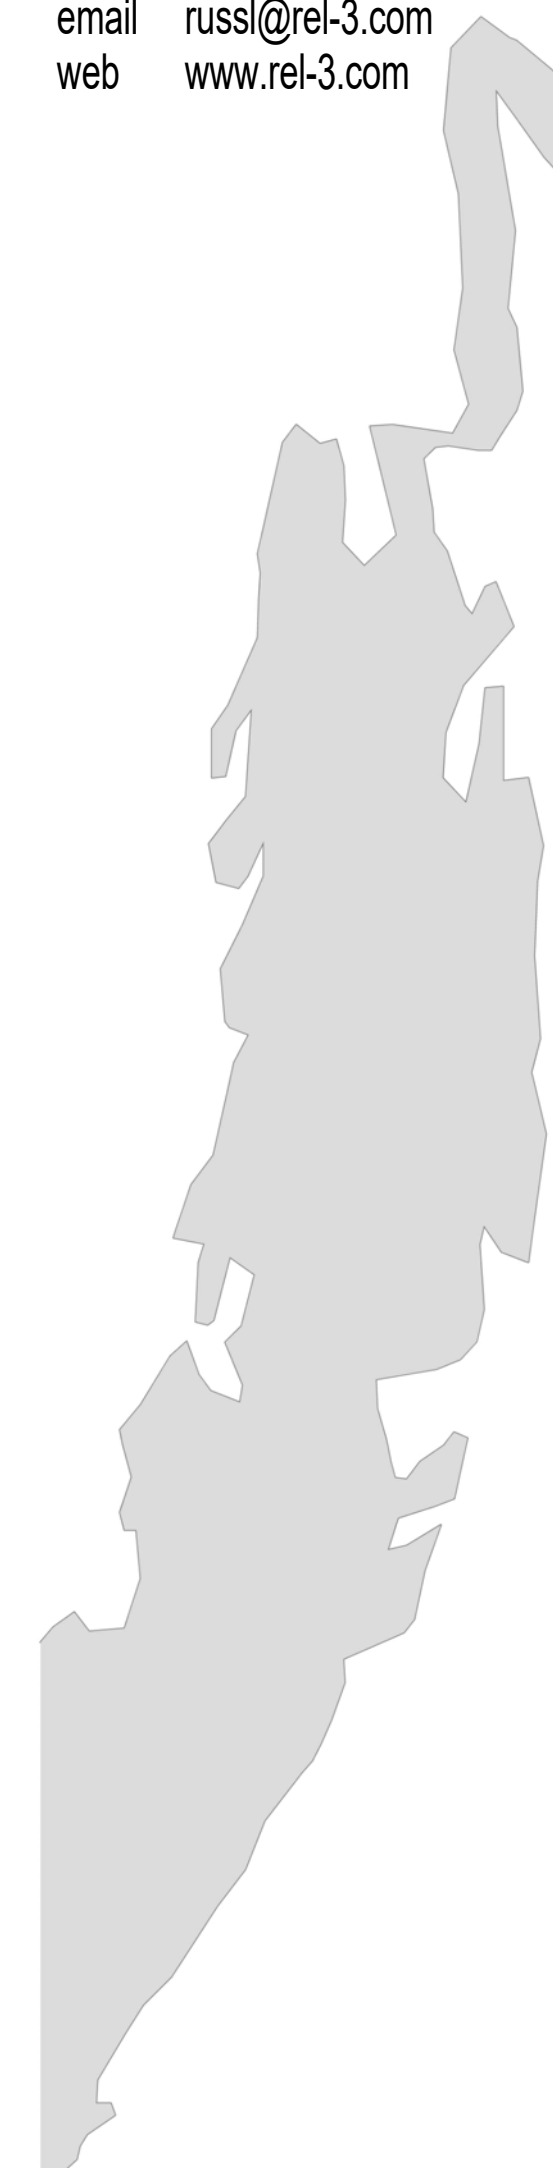


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Date: 9/25/17
Contact: Dave DeBlanc
Company: NDC LLC
Location: 201 E Sunset Dr
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POBLOCKI PAVING CORP.

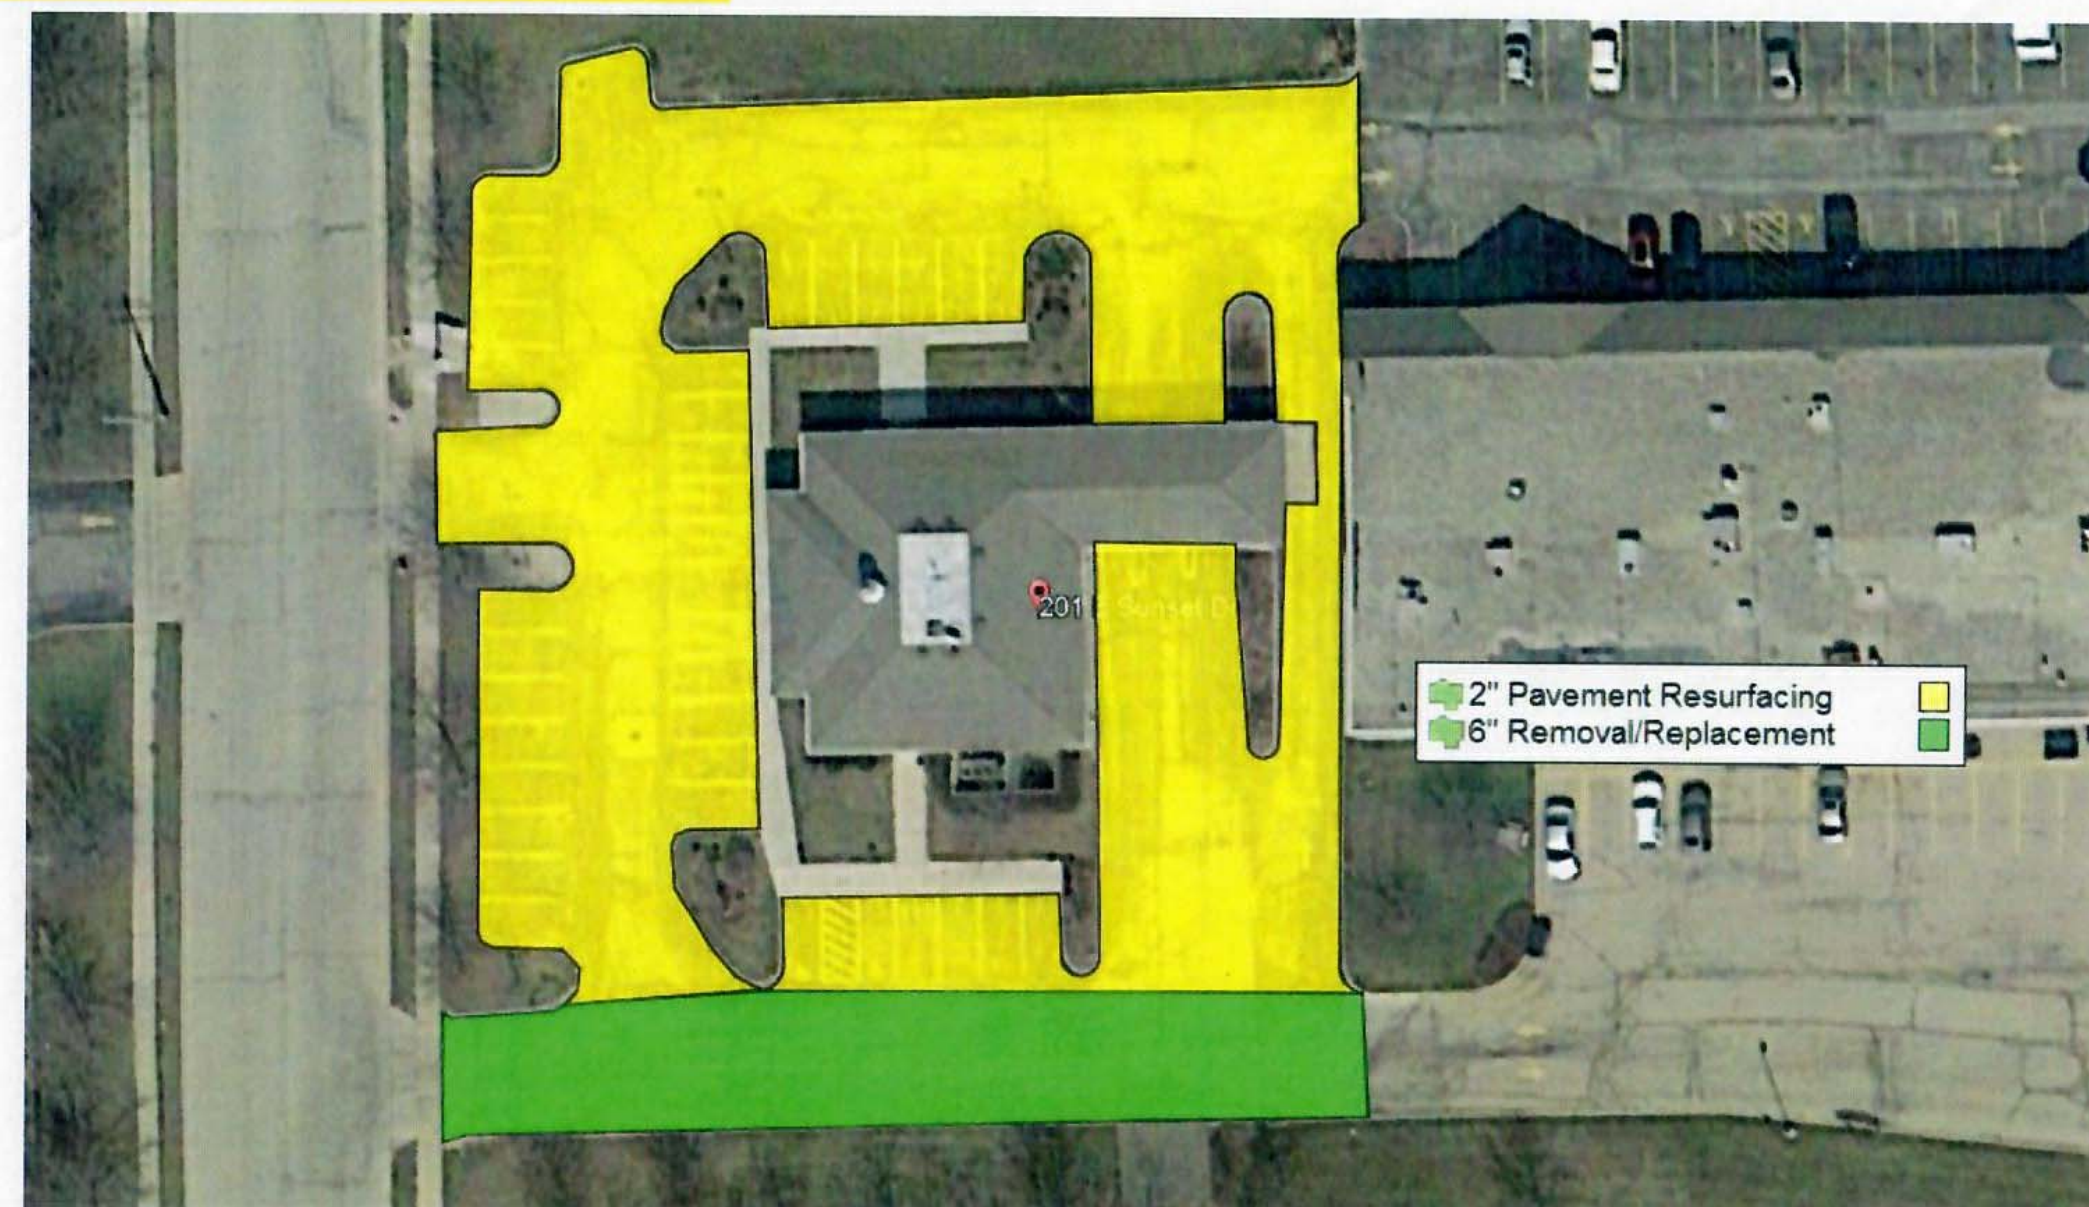

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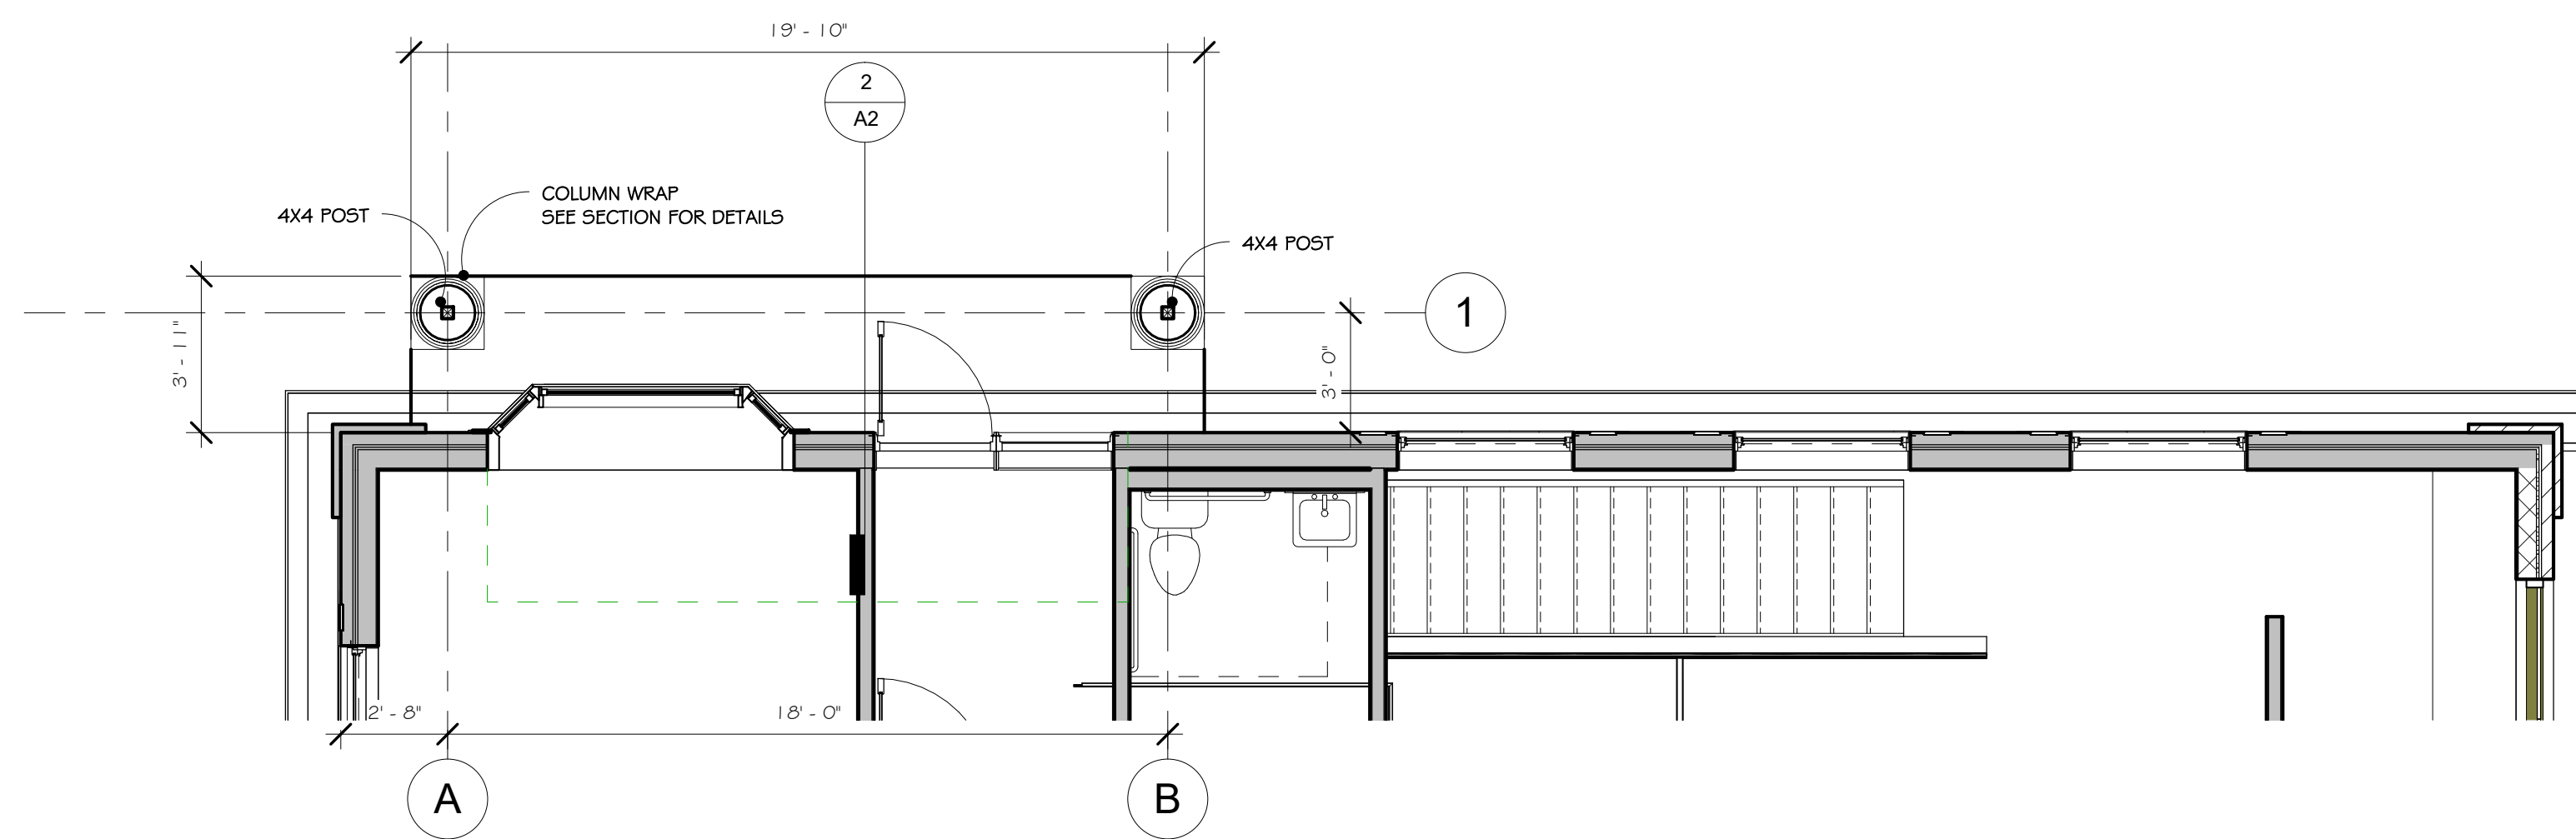
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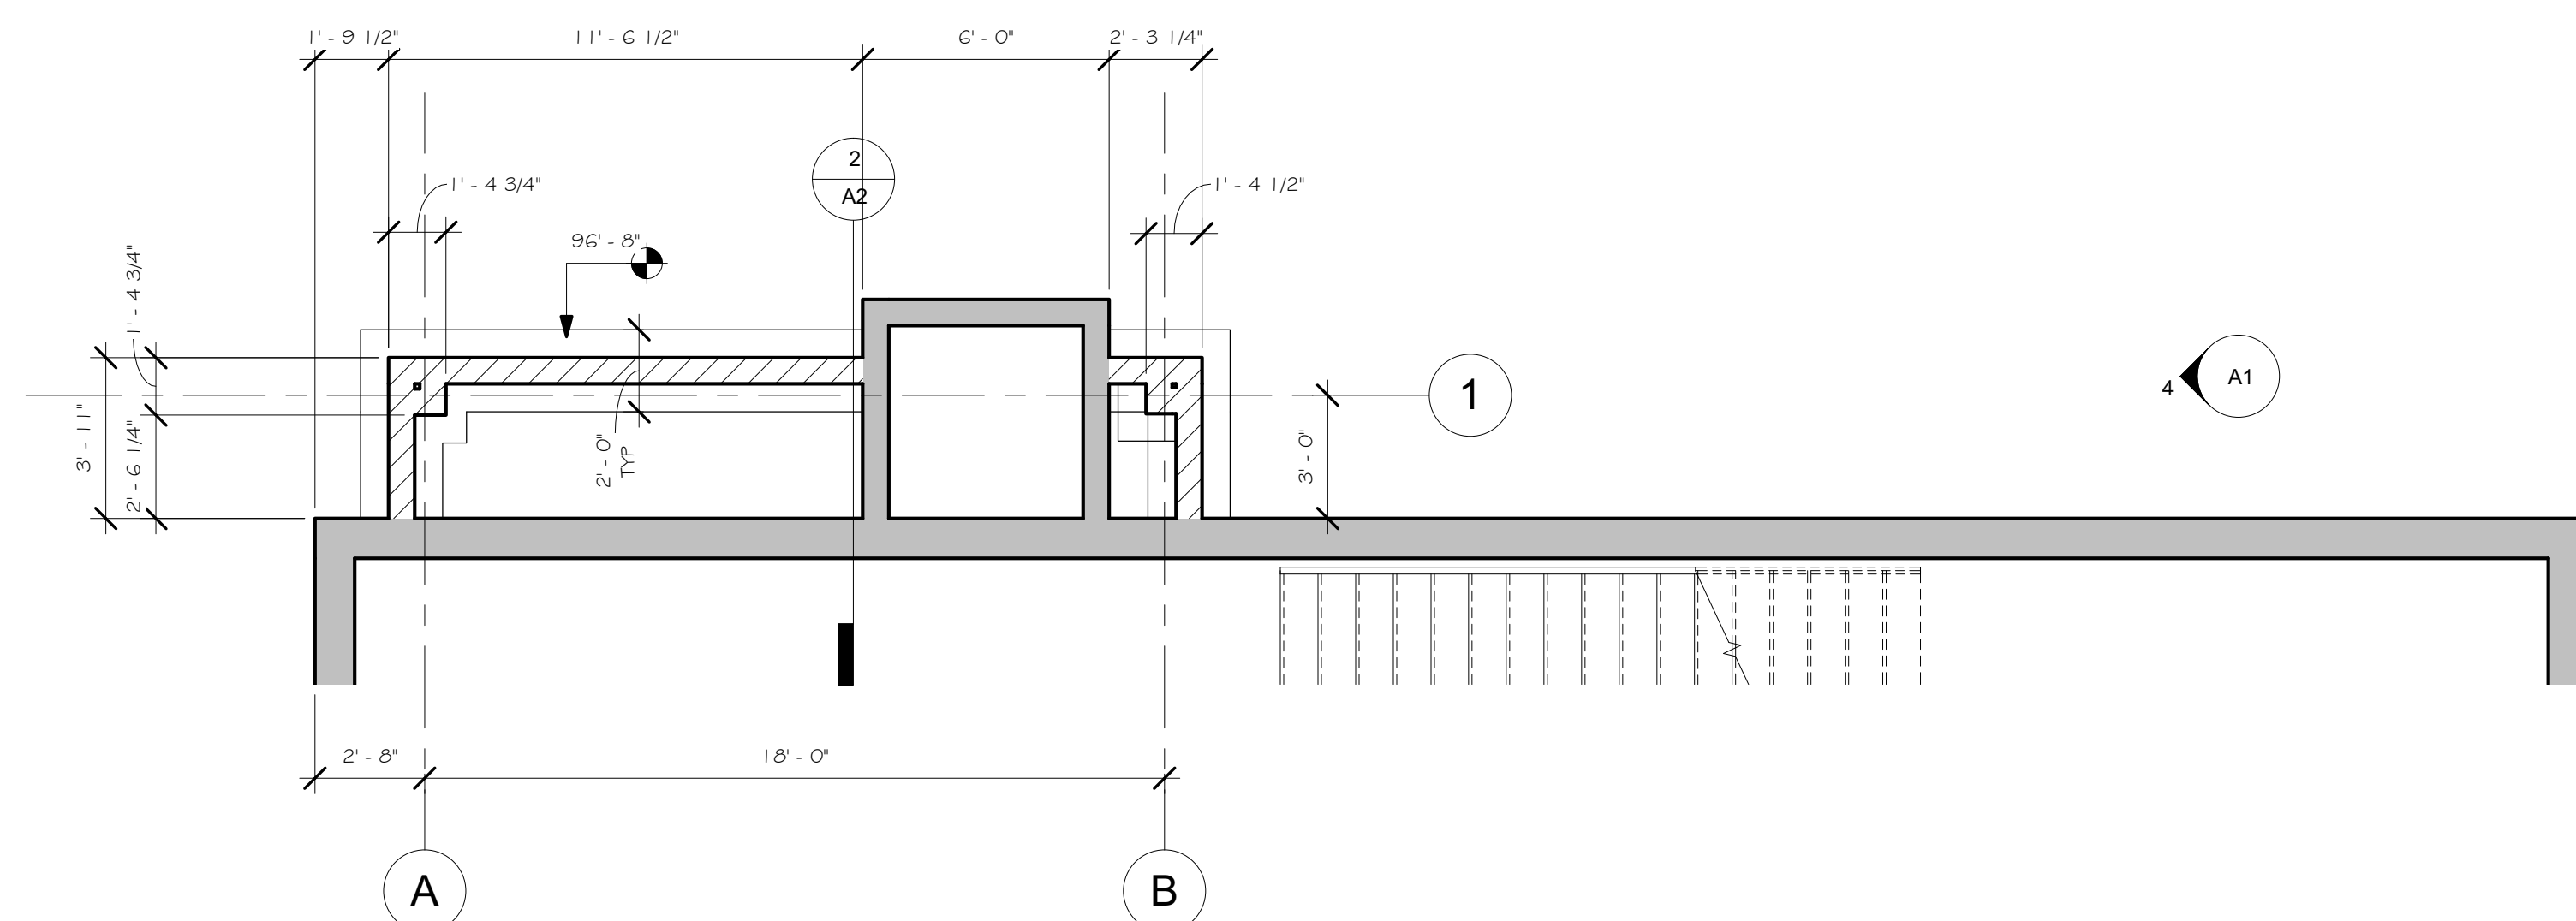
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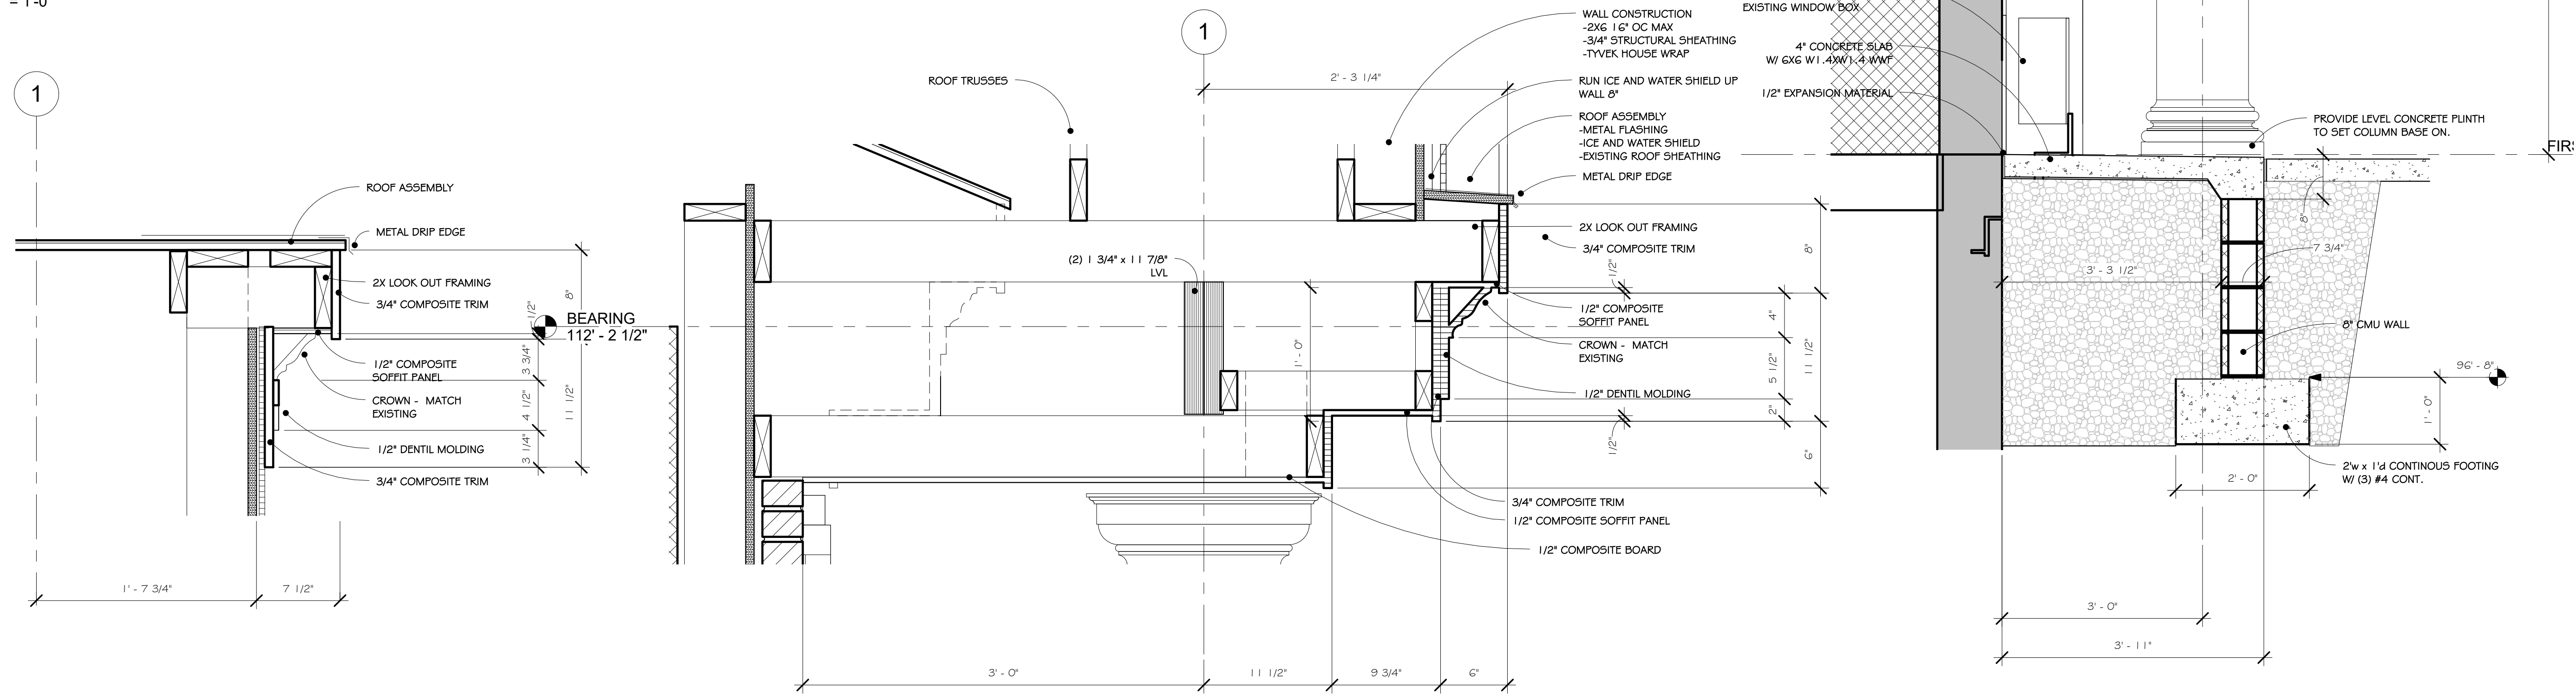
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1 ENLARGED PLAN - ENTRY FIRST FLOOR
 1/4" = 1'-0"




3 ENLARGED PLAN - ENTRY BASEMENT
 1/4" = 1'-0"

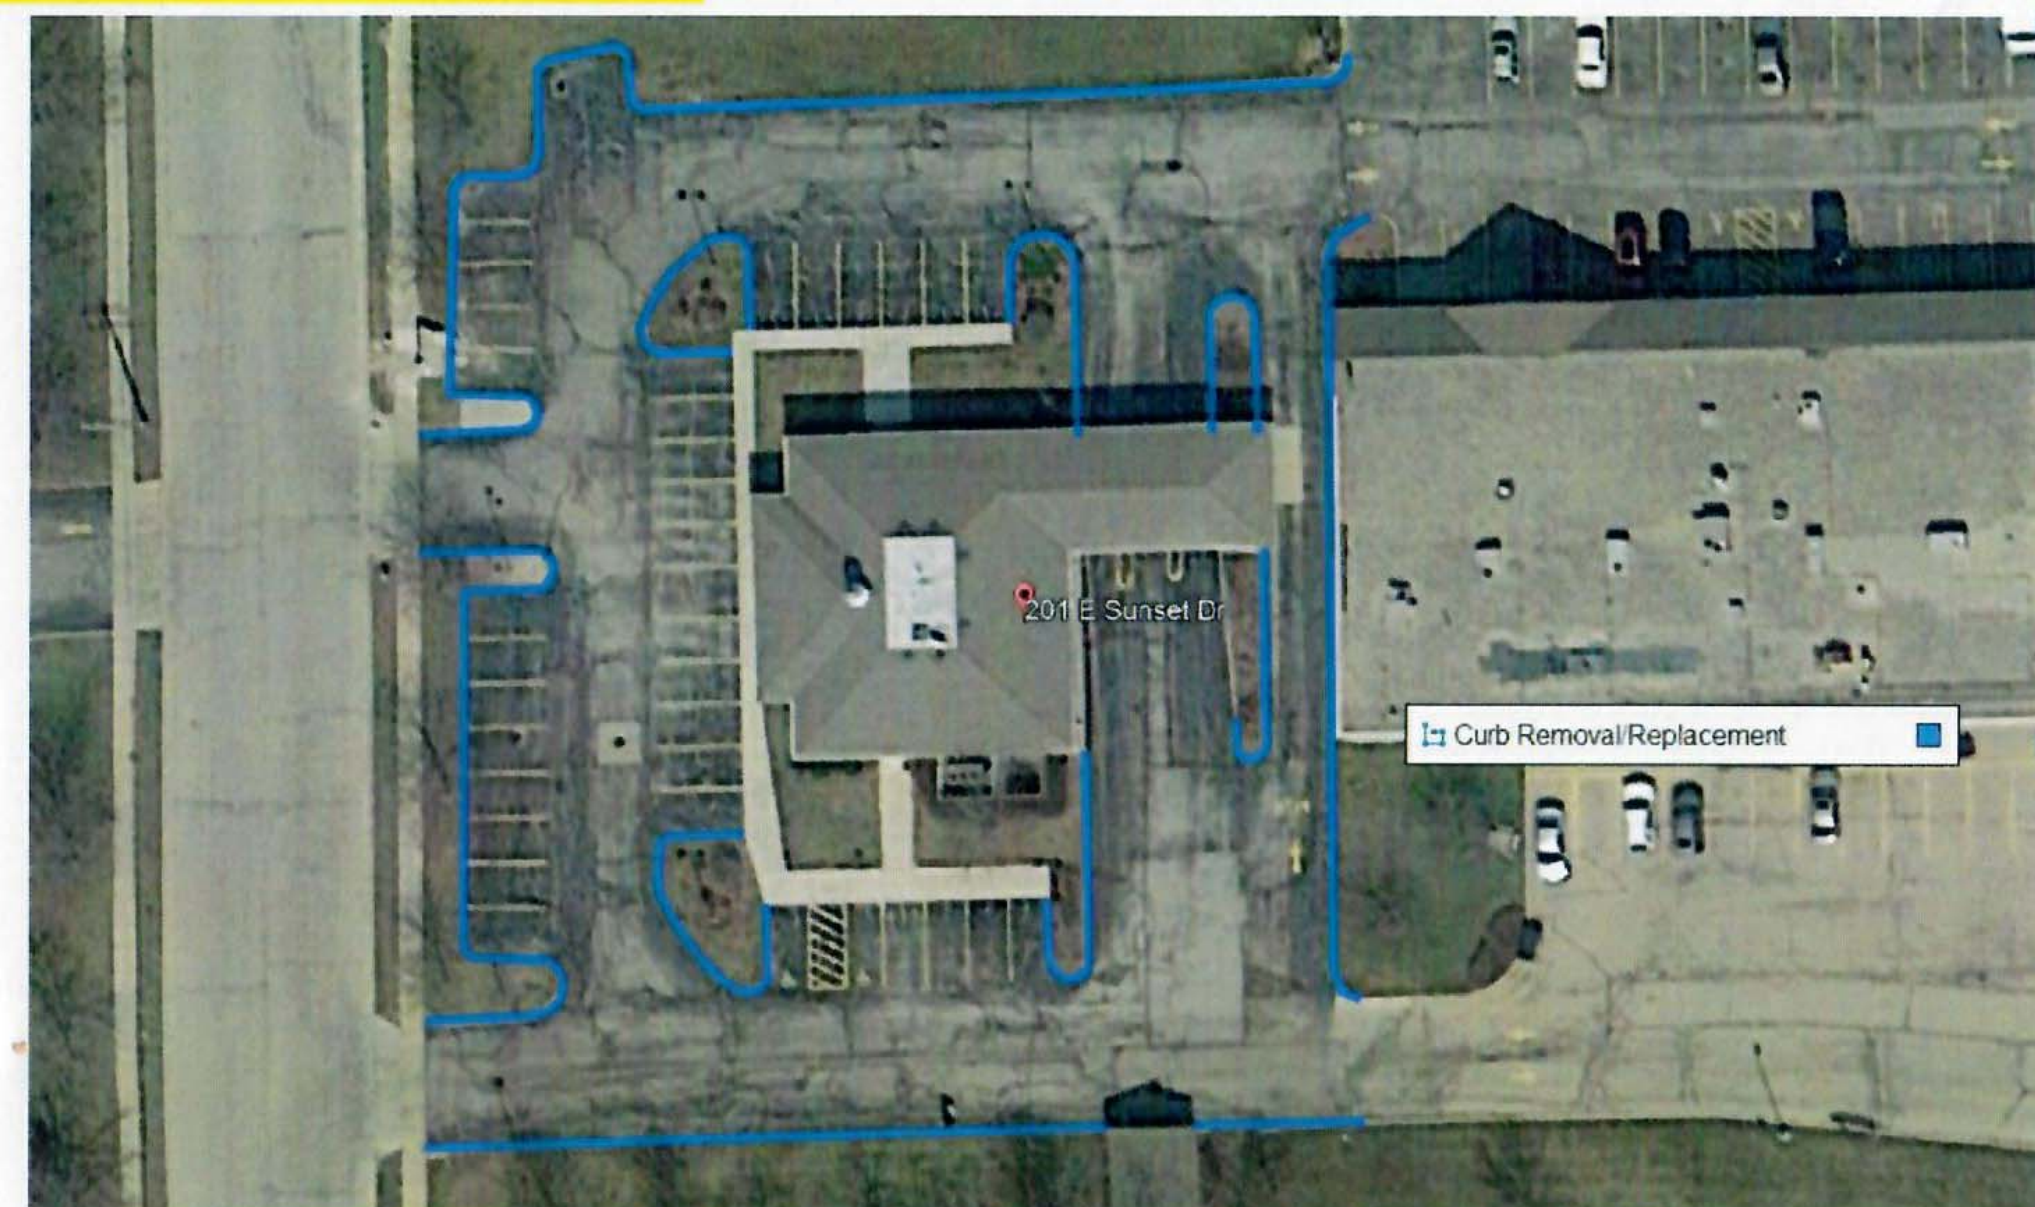



4 SECTION DETAIL - PORTICO RAKE
 1 1/2" = 1'-0"

5 SECTION DETAIL - PORTICO SOFFIT
 1 1/2" = 1'-0"


2 WALL SECTION - PORTICO
 3/4" = 1'-0"

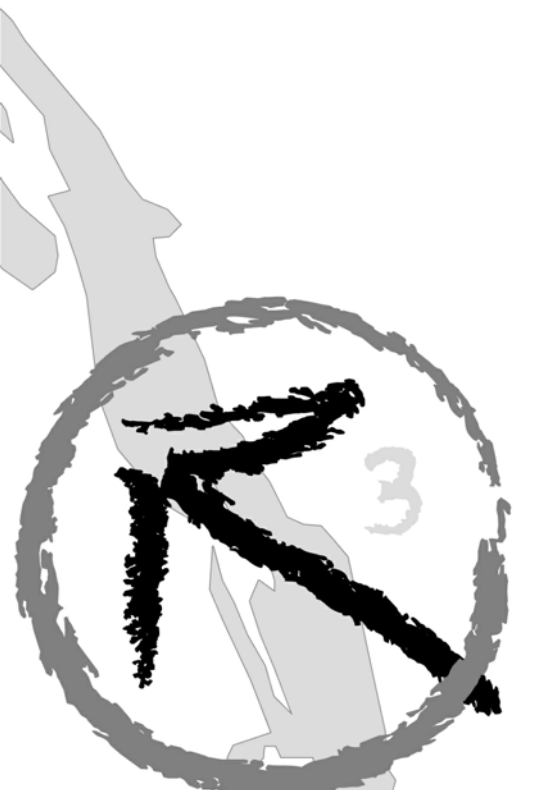


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1 EXISTING PLAN - ROOF
 1/8" = 1'-0"

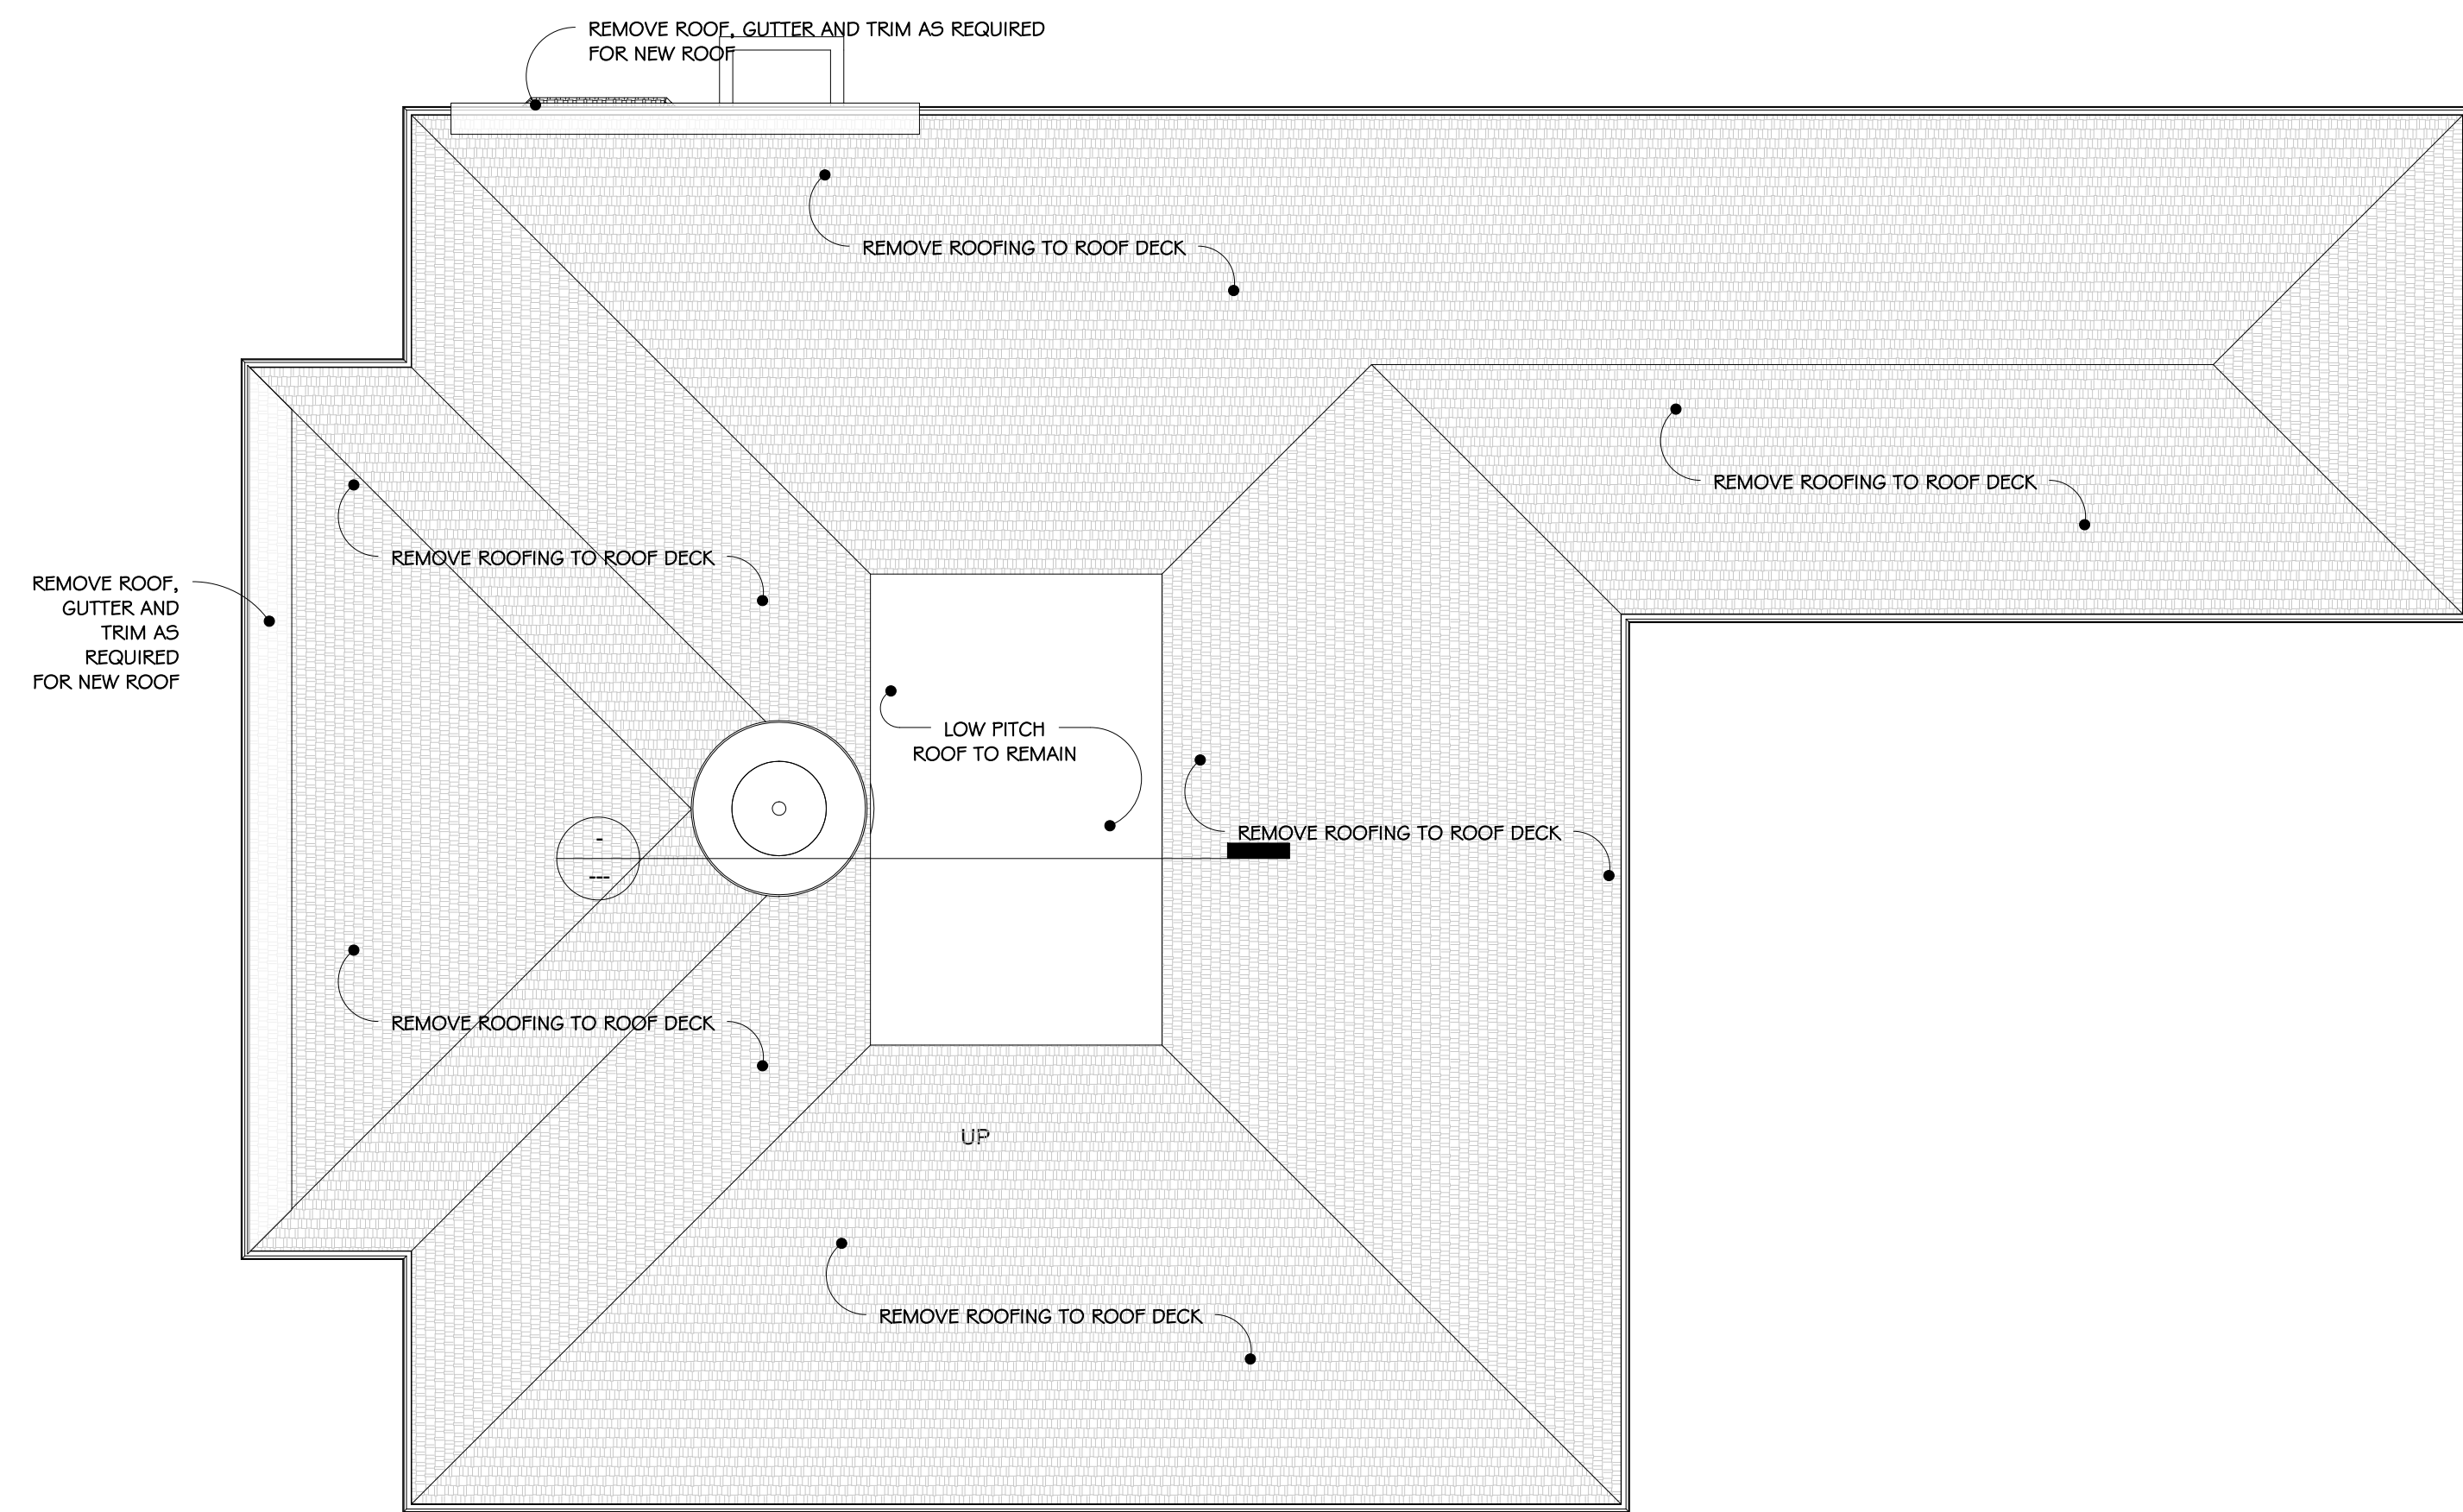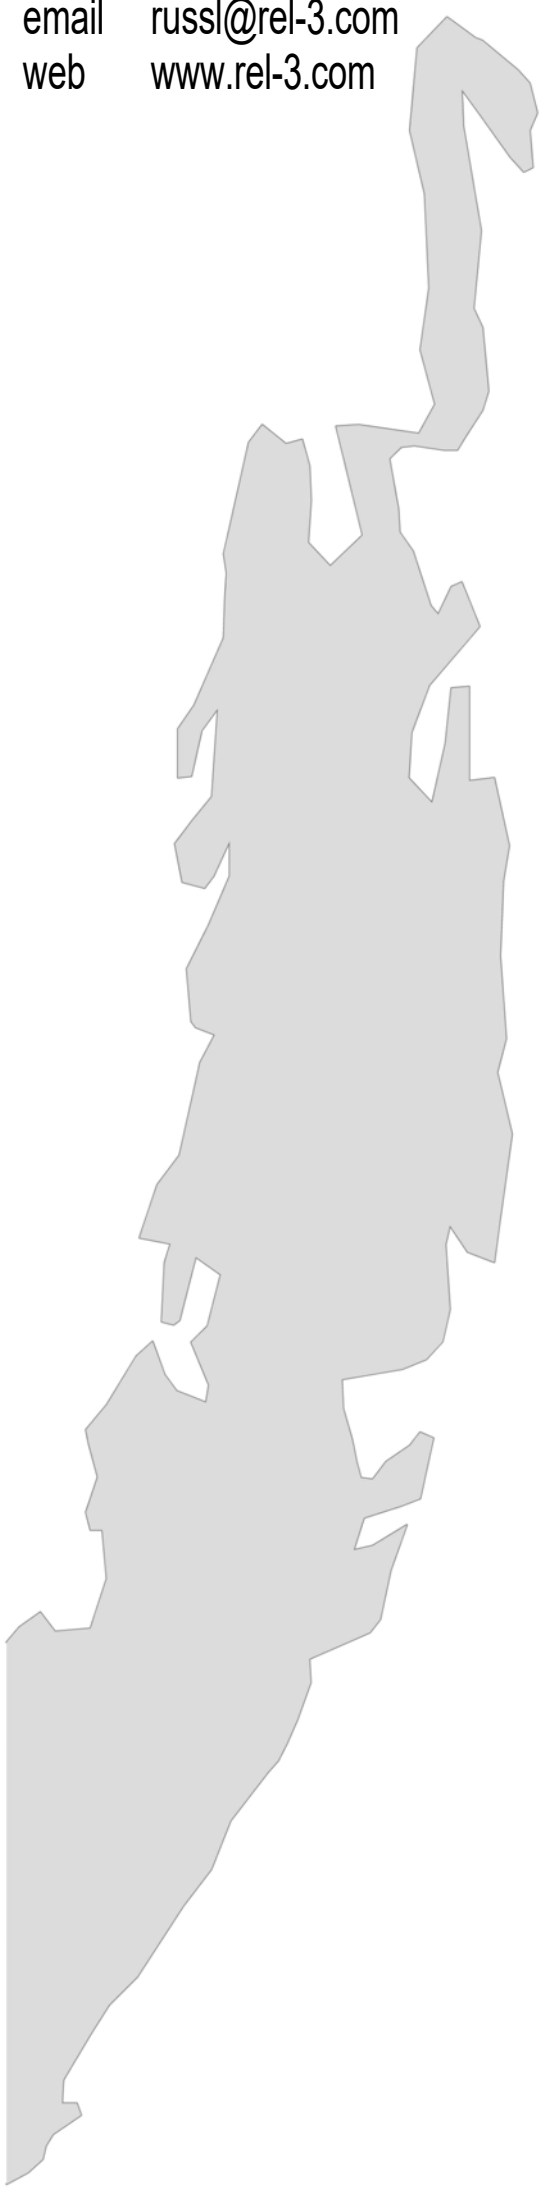



2 PROPOSED PLAN - ROOF
 1/8" = 1'-0"

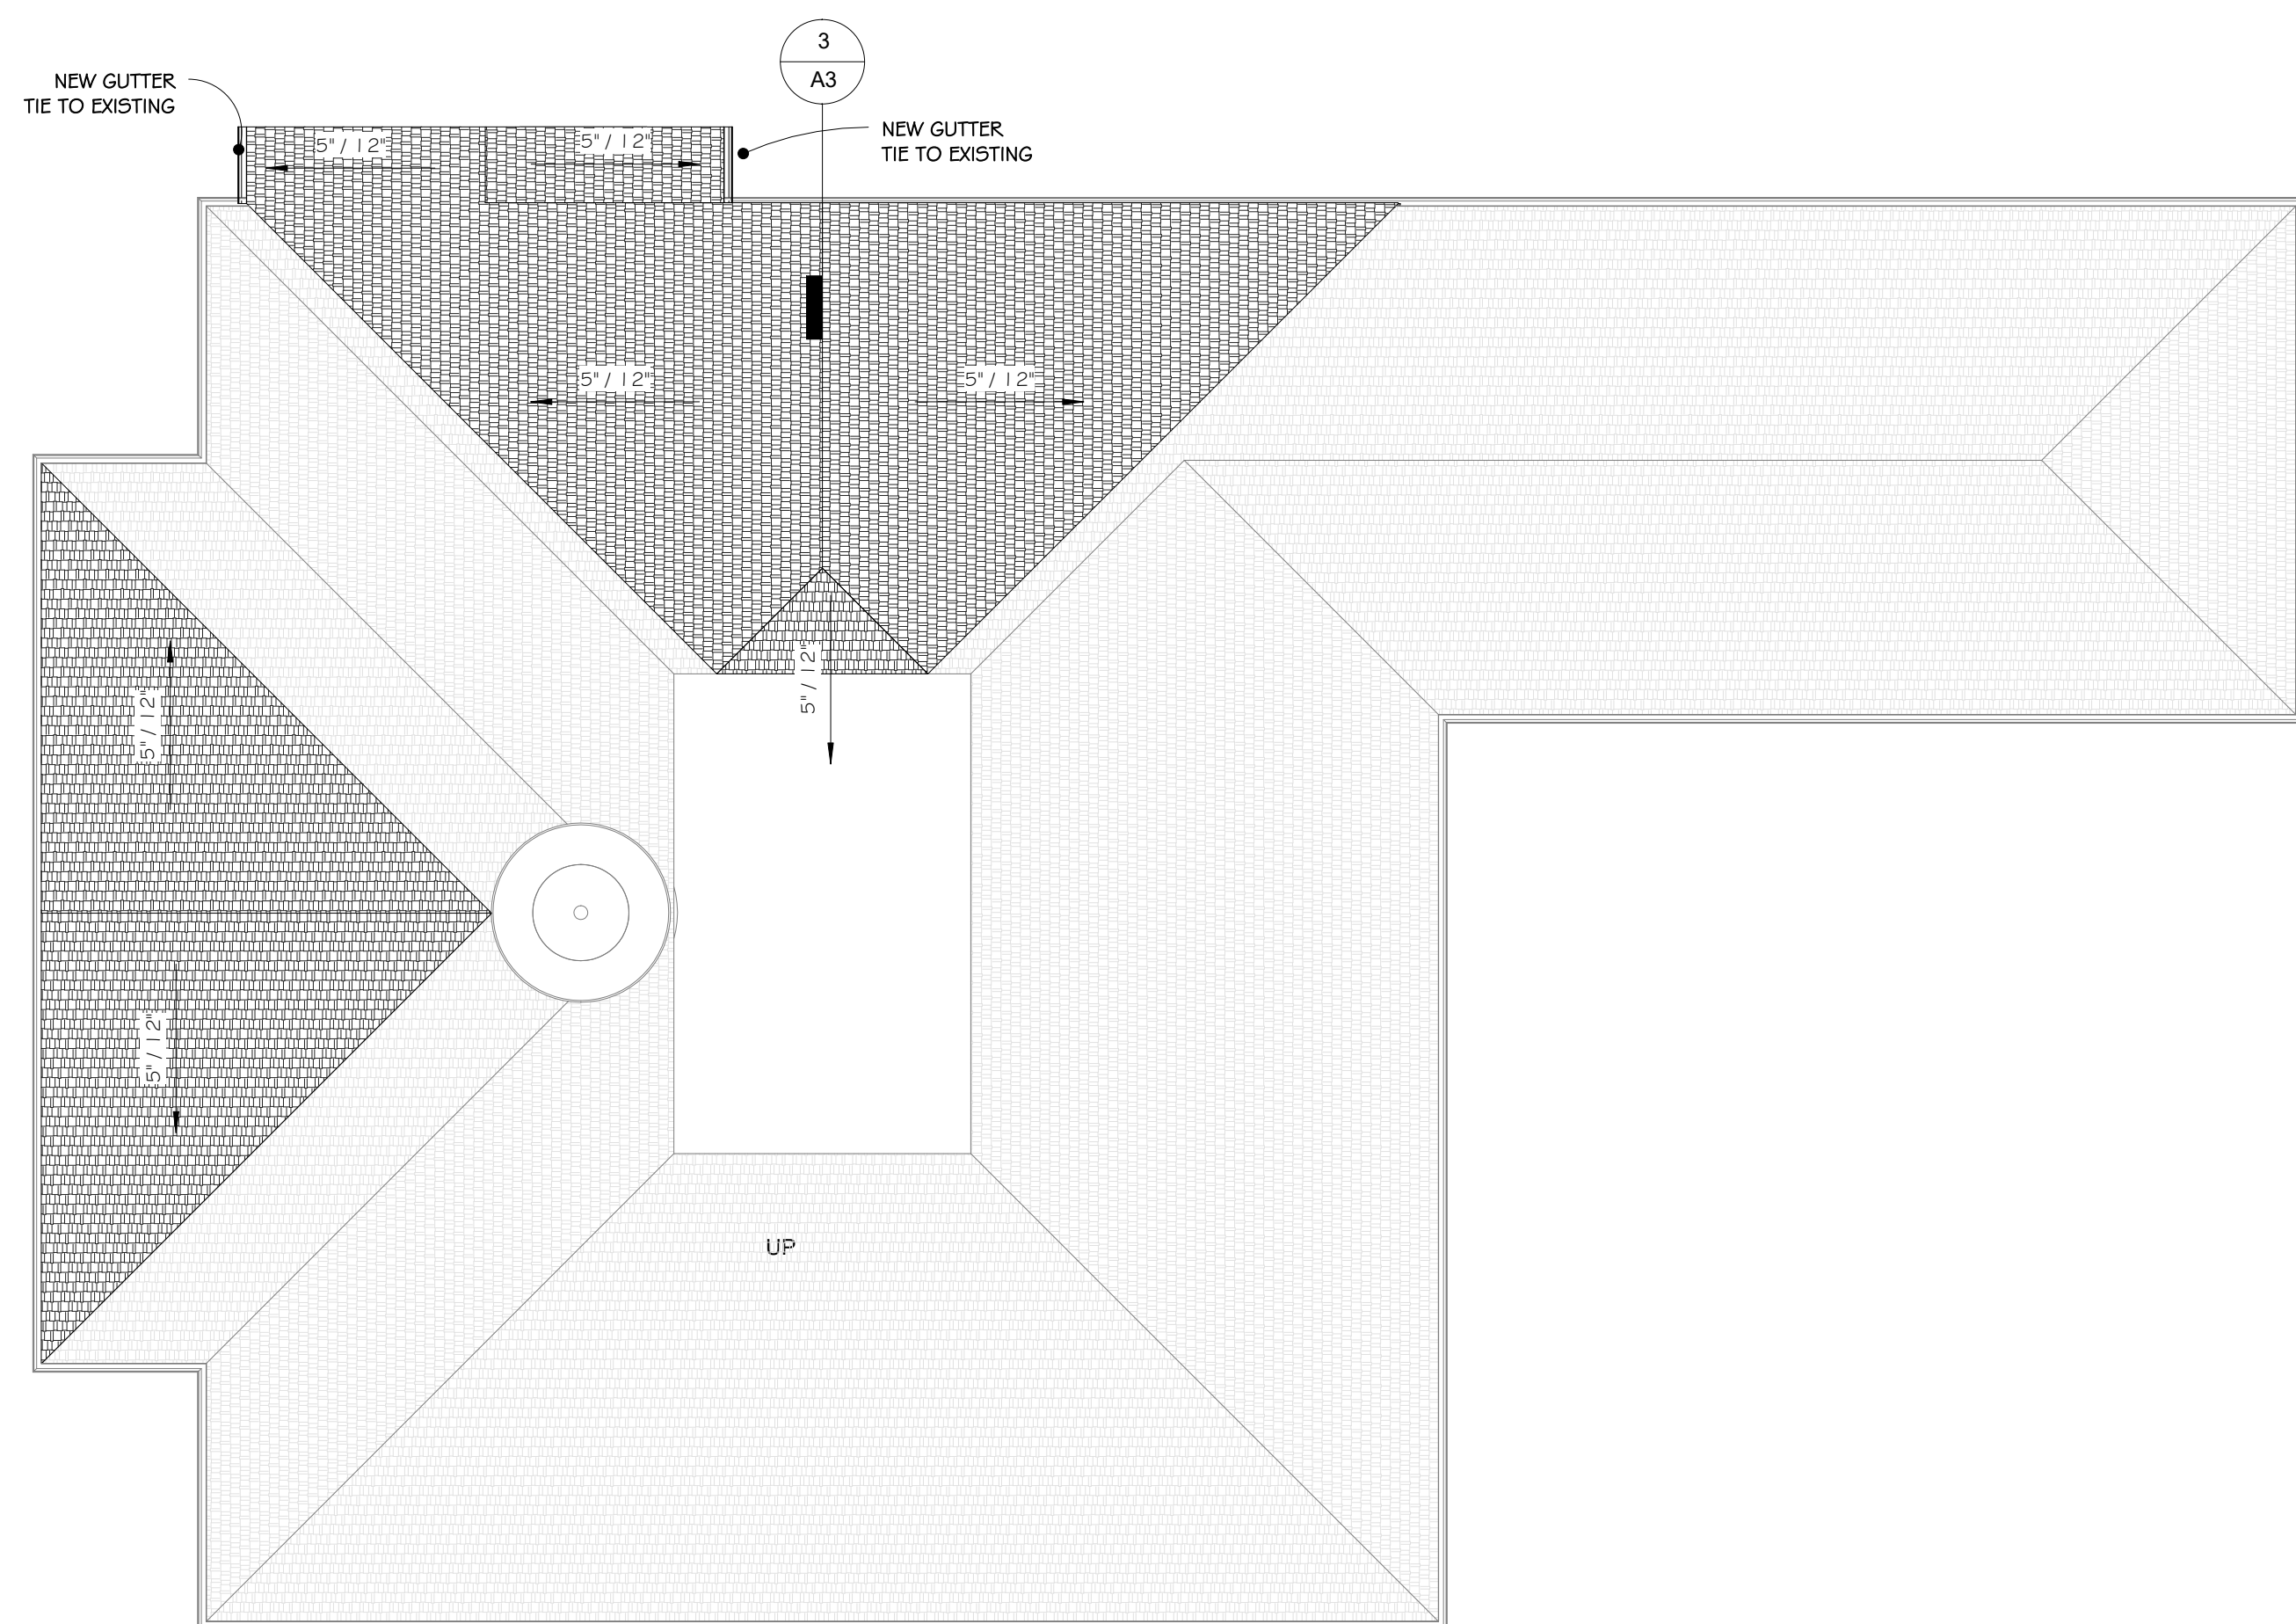


3 SECTION DETAIL - NORTH PEDIMENT
 1" = 1'-0"

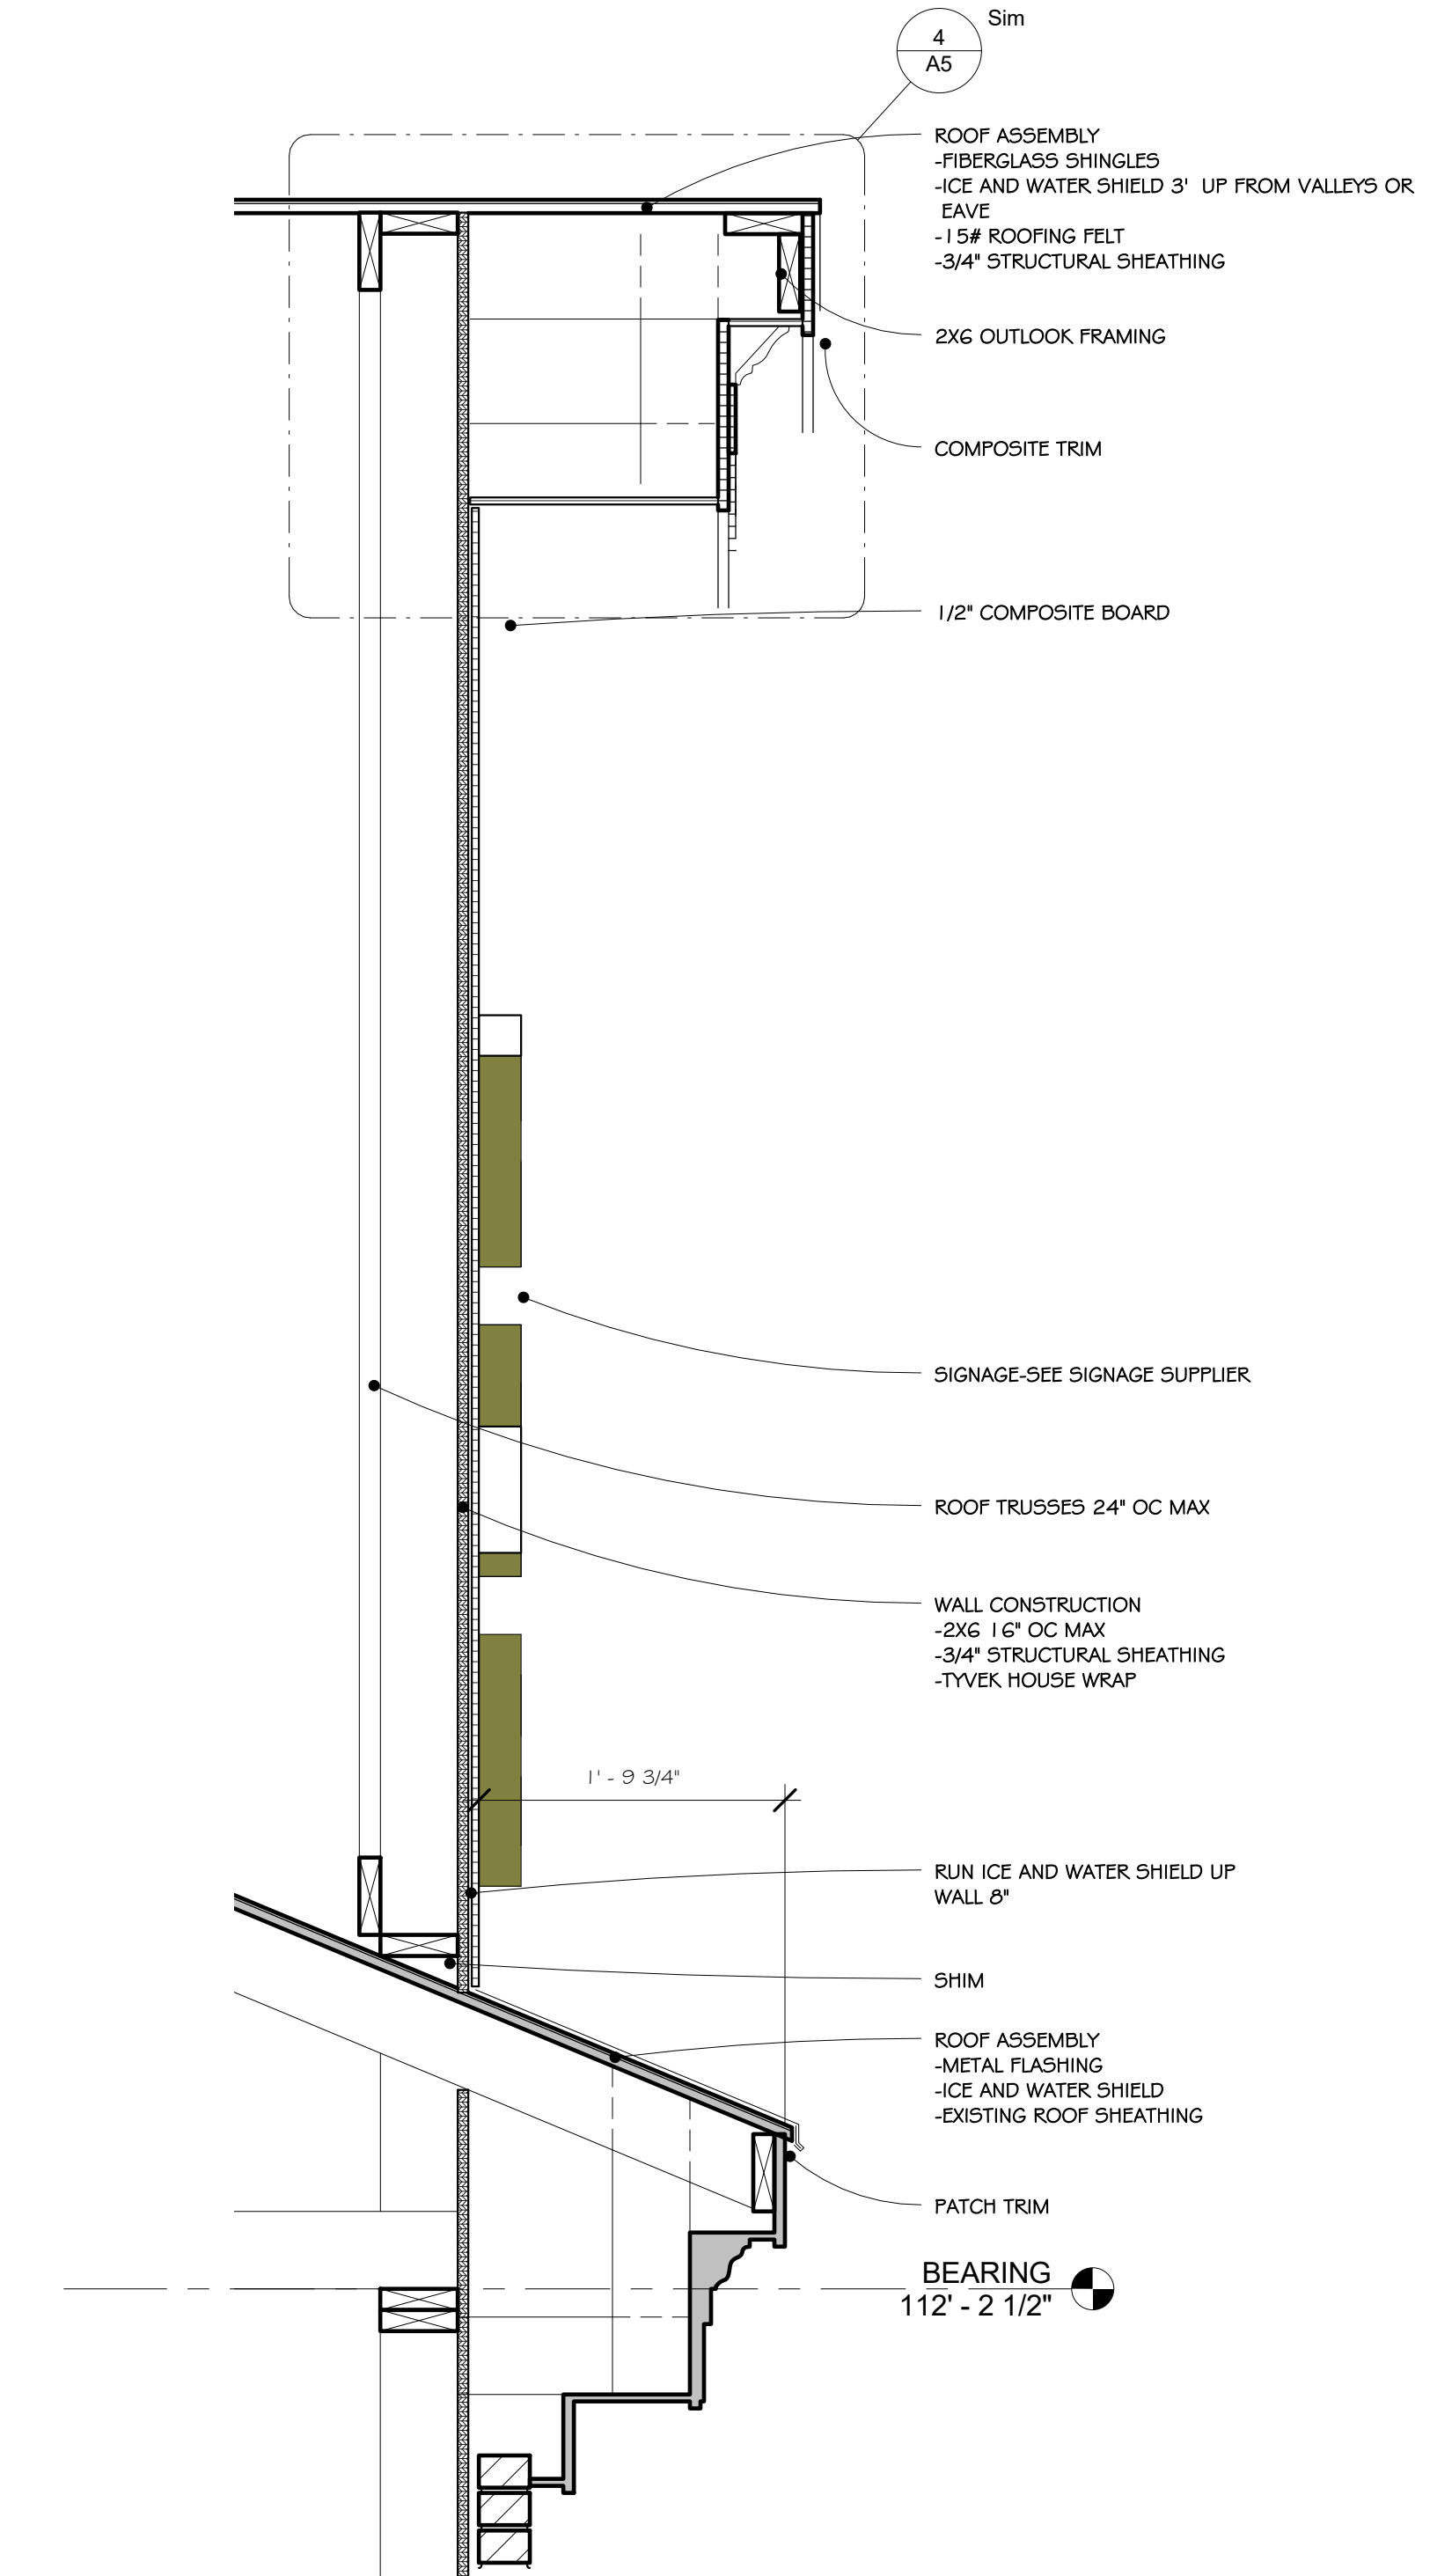

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① EXISTING ELEVATION - NORTH
 1/4" = 1'-0"

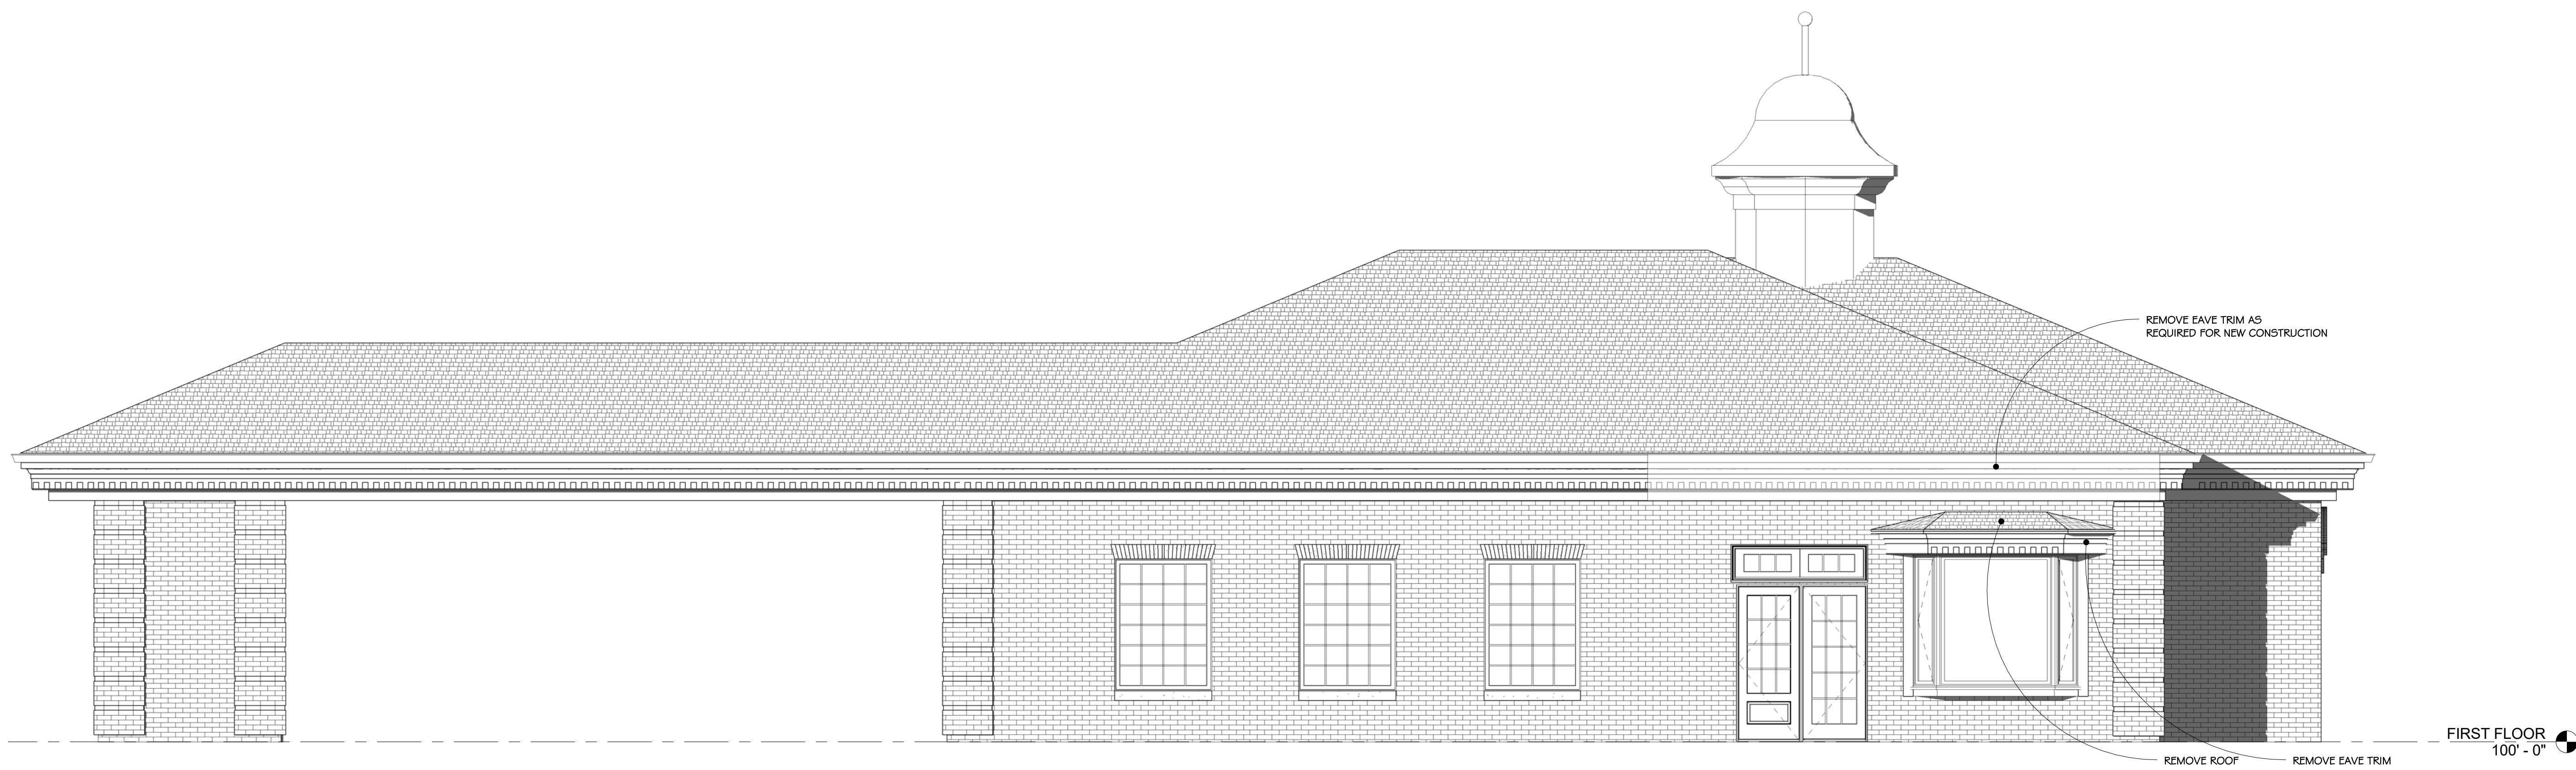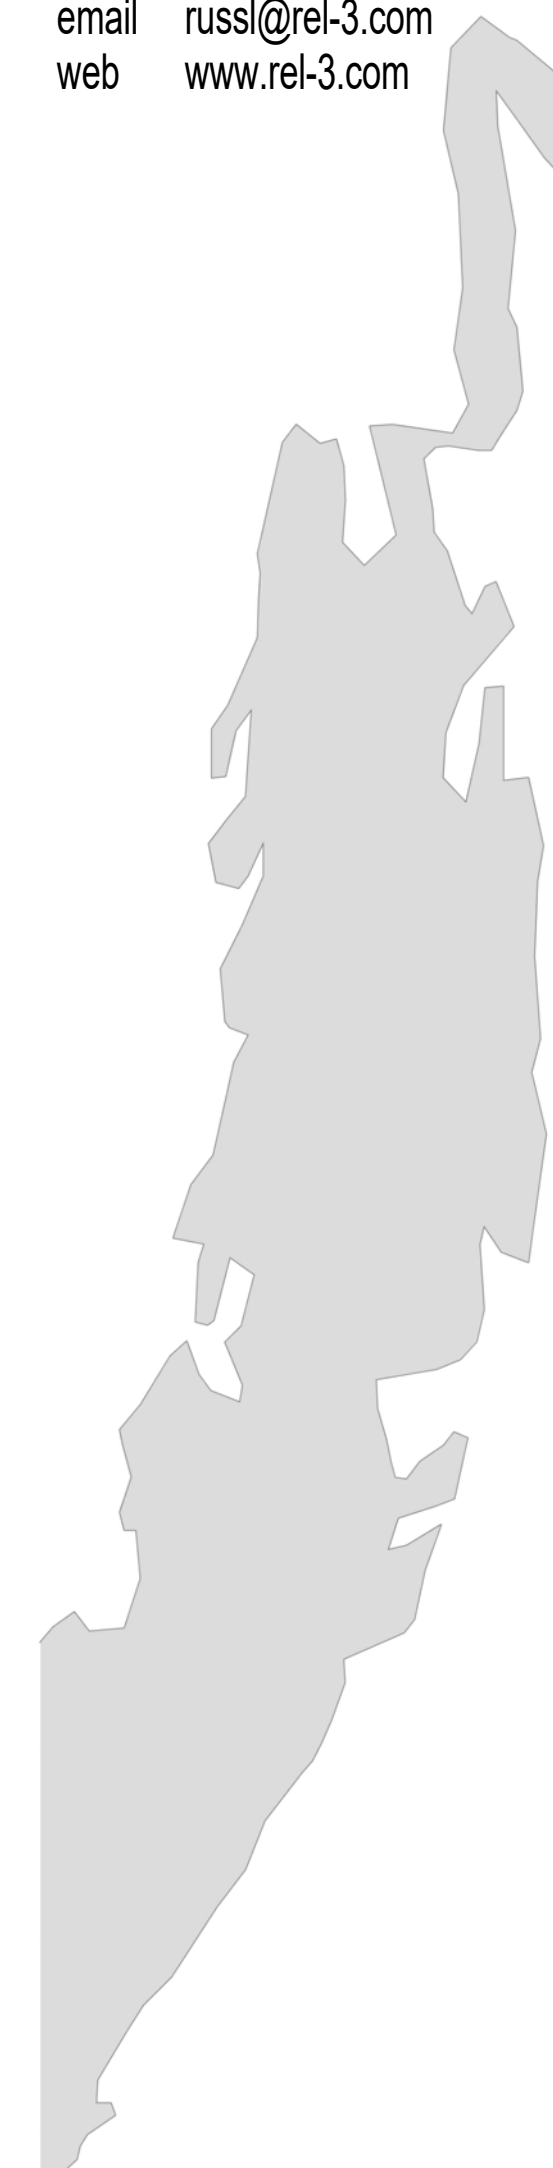

② PROPOSED ELEVATION - NORTH
 1/4" = 1'-0"

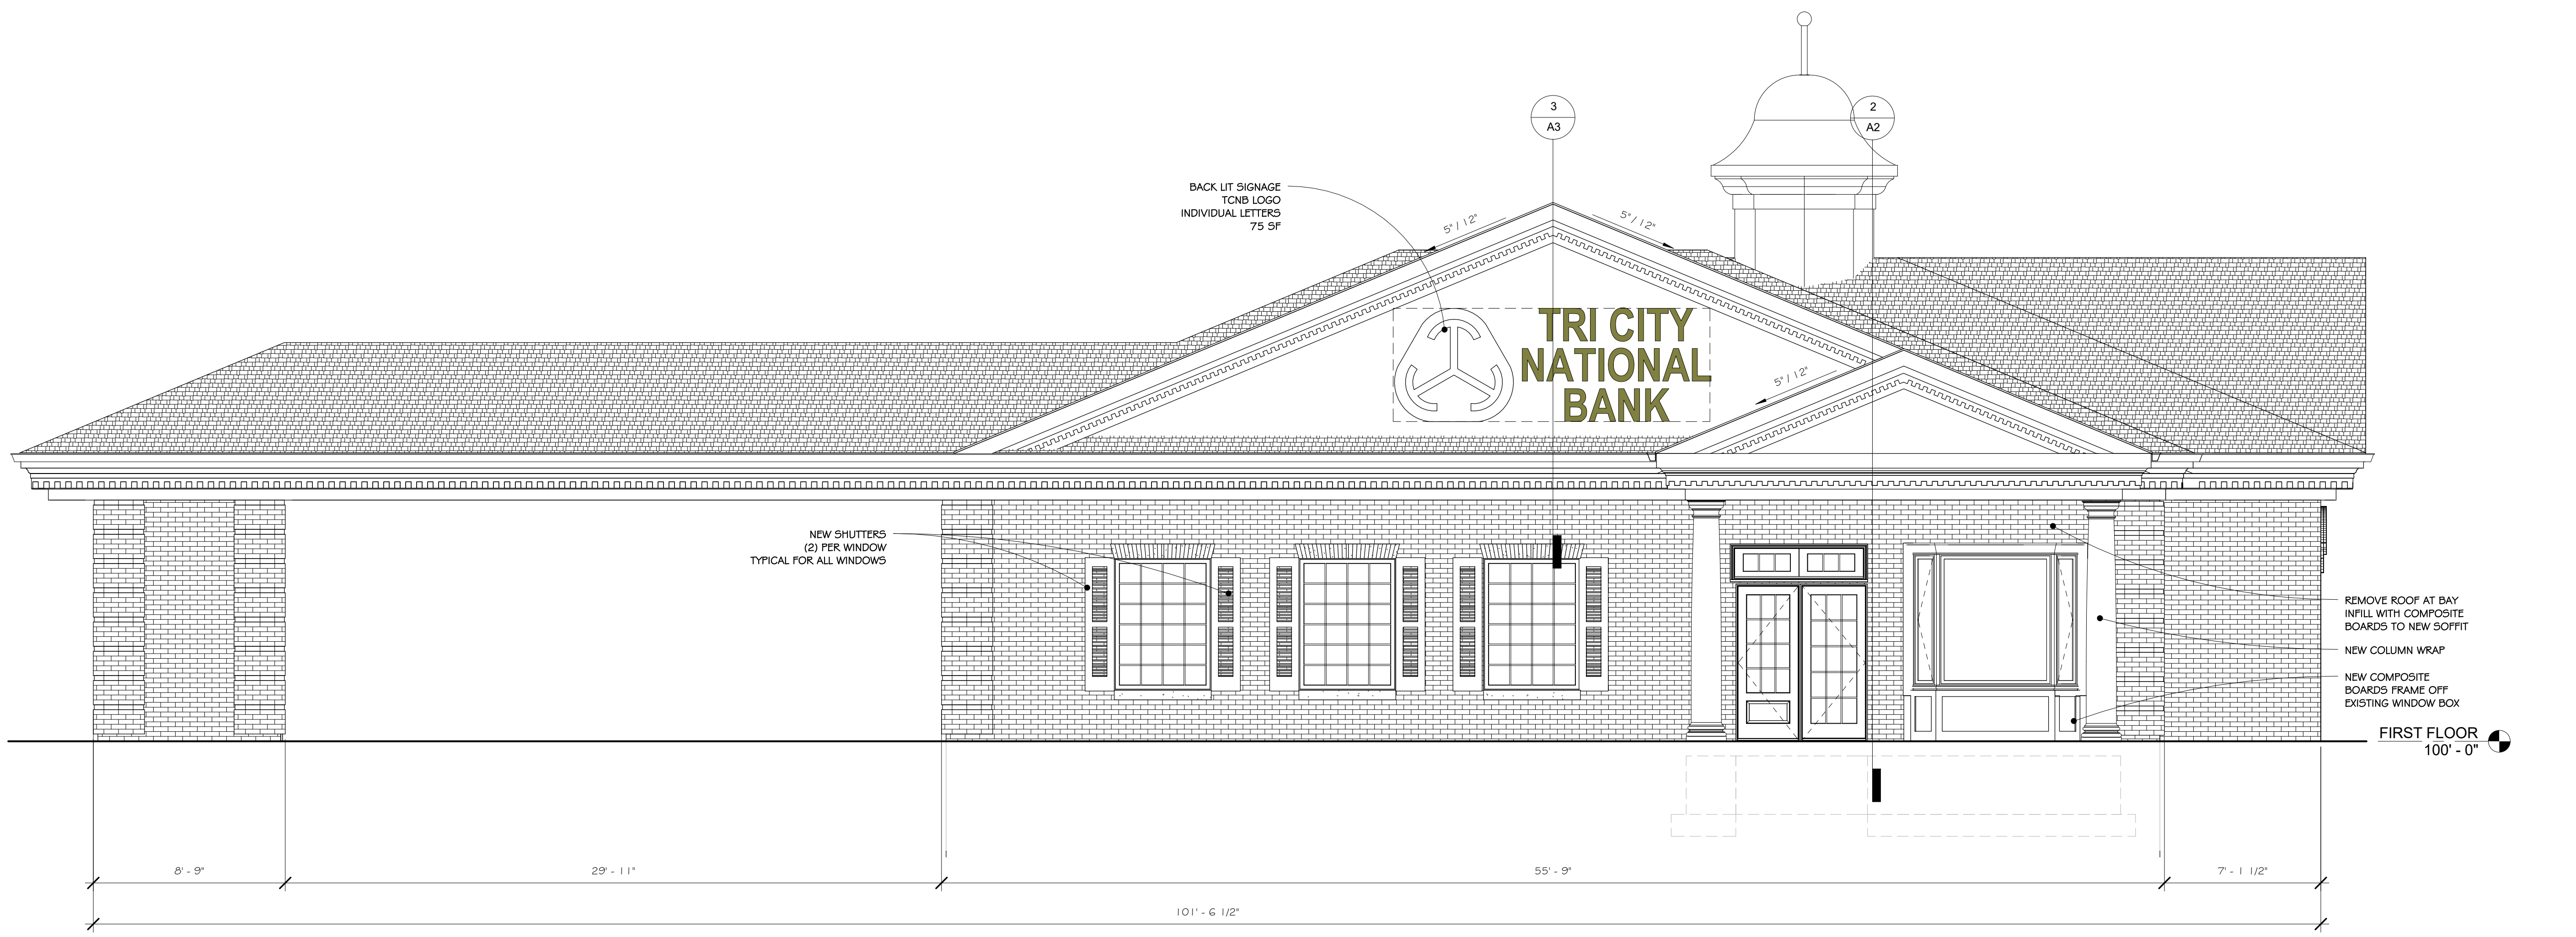Sheet Number
 NORTH ELEVATIONS

A4

Date 02-12-18
 Project Number: 176006




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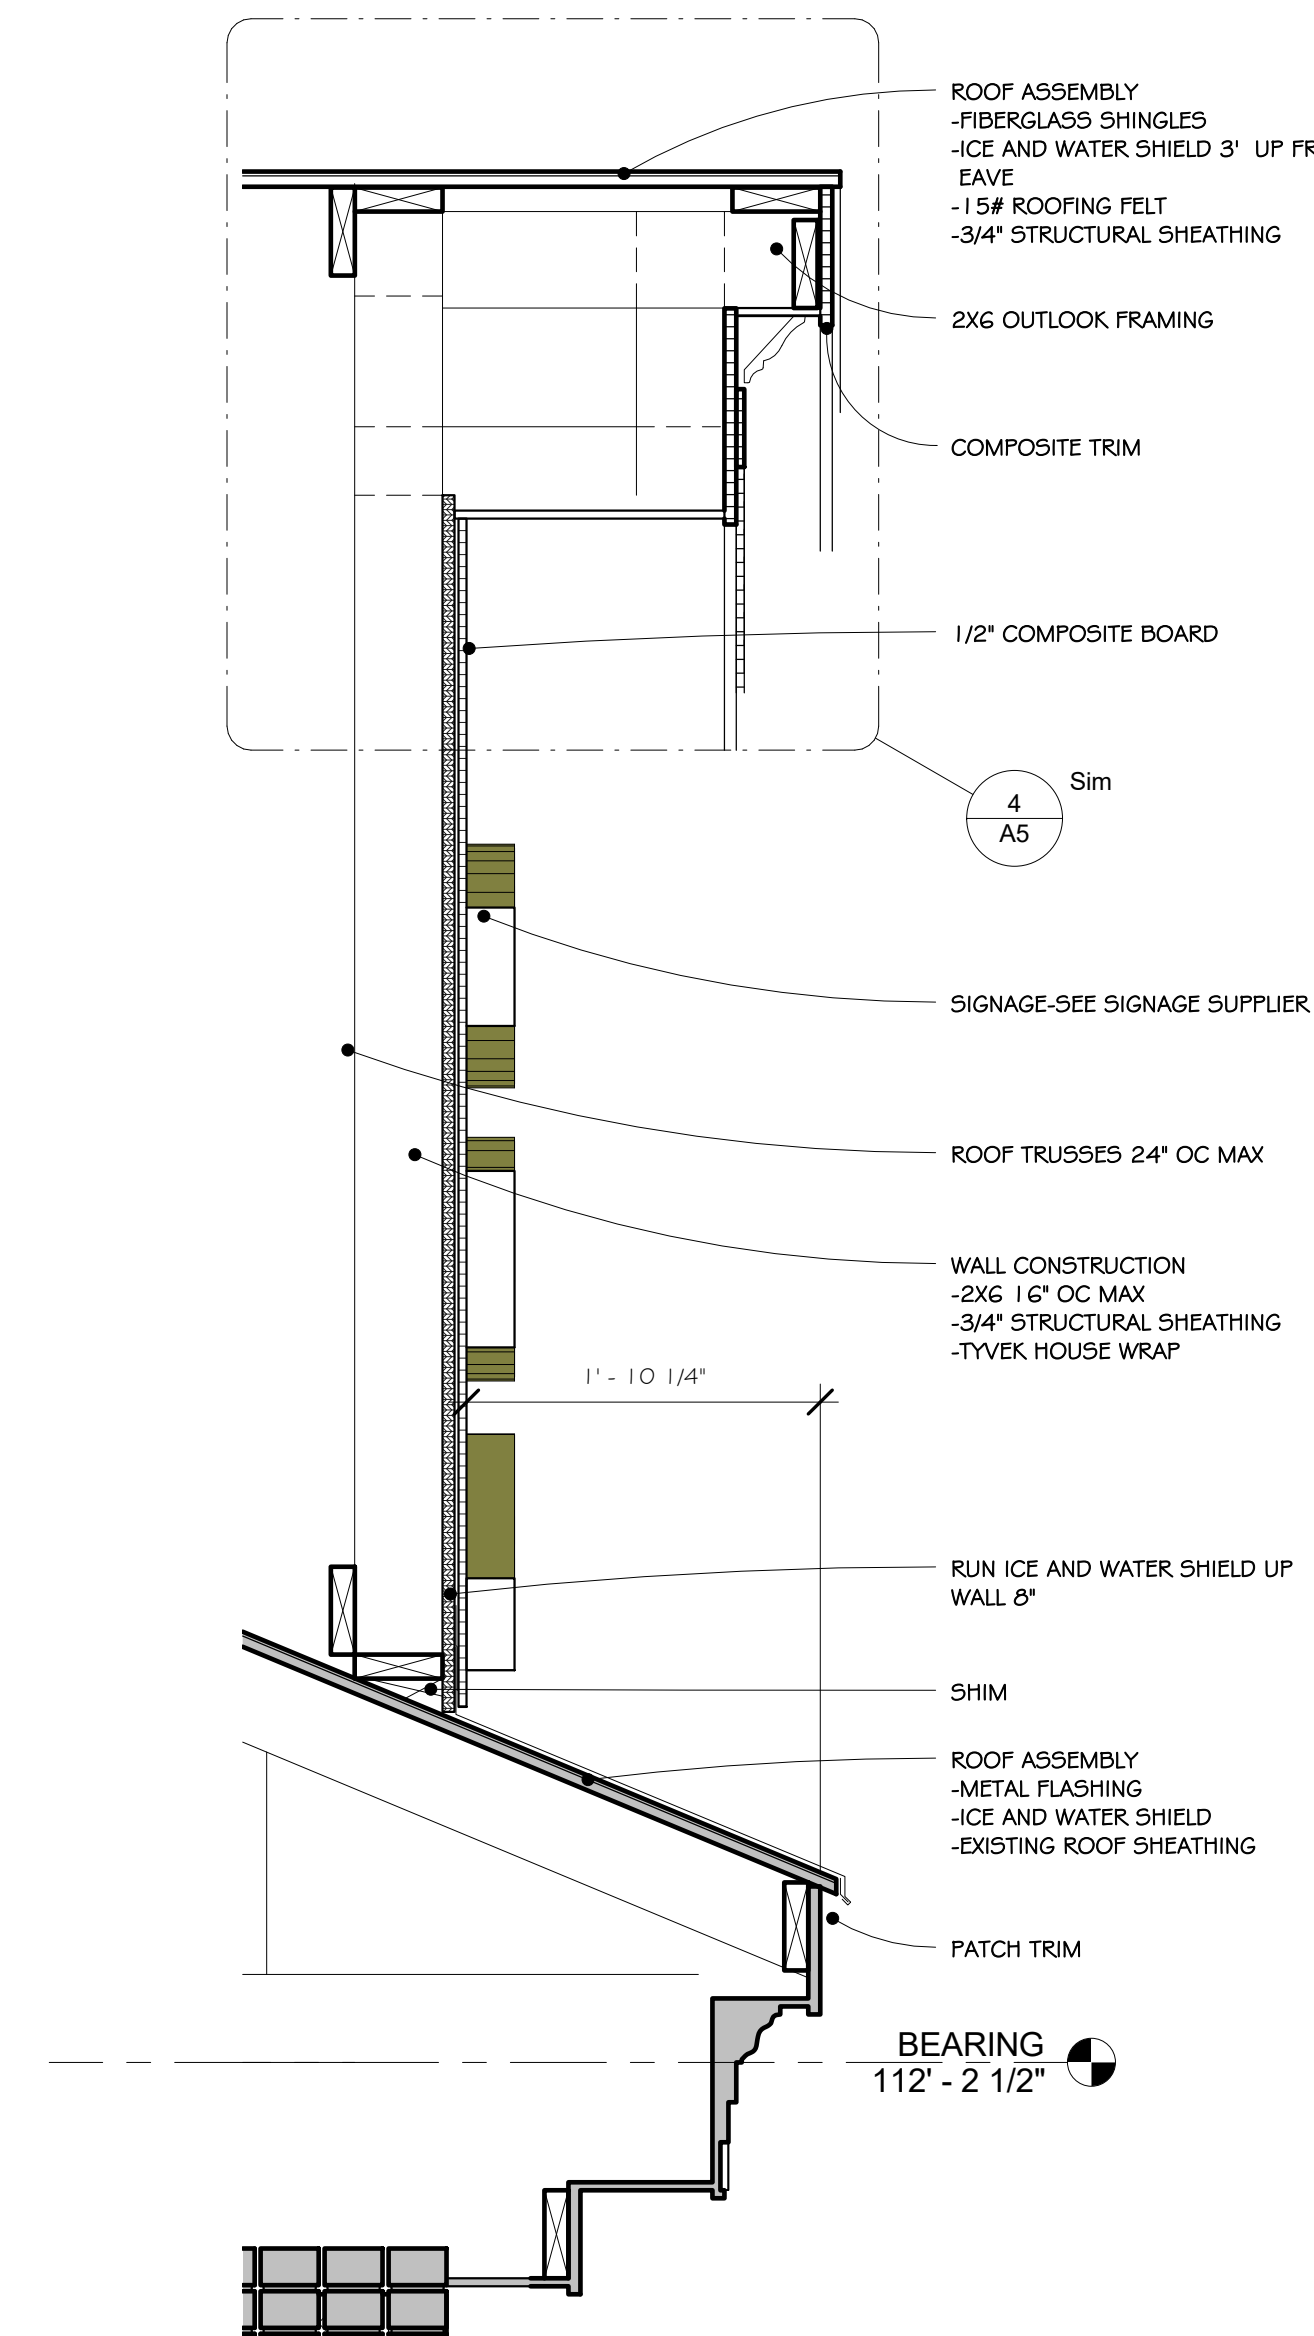
Sheet Number
 WEST ELEVATIONS

A5


Date 092-12-18
 Project Number: 176006

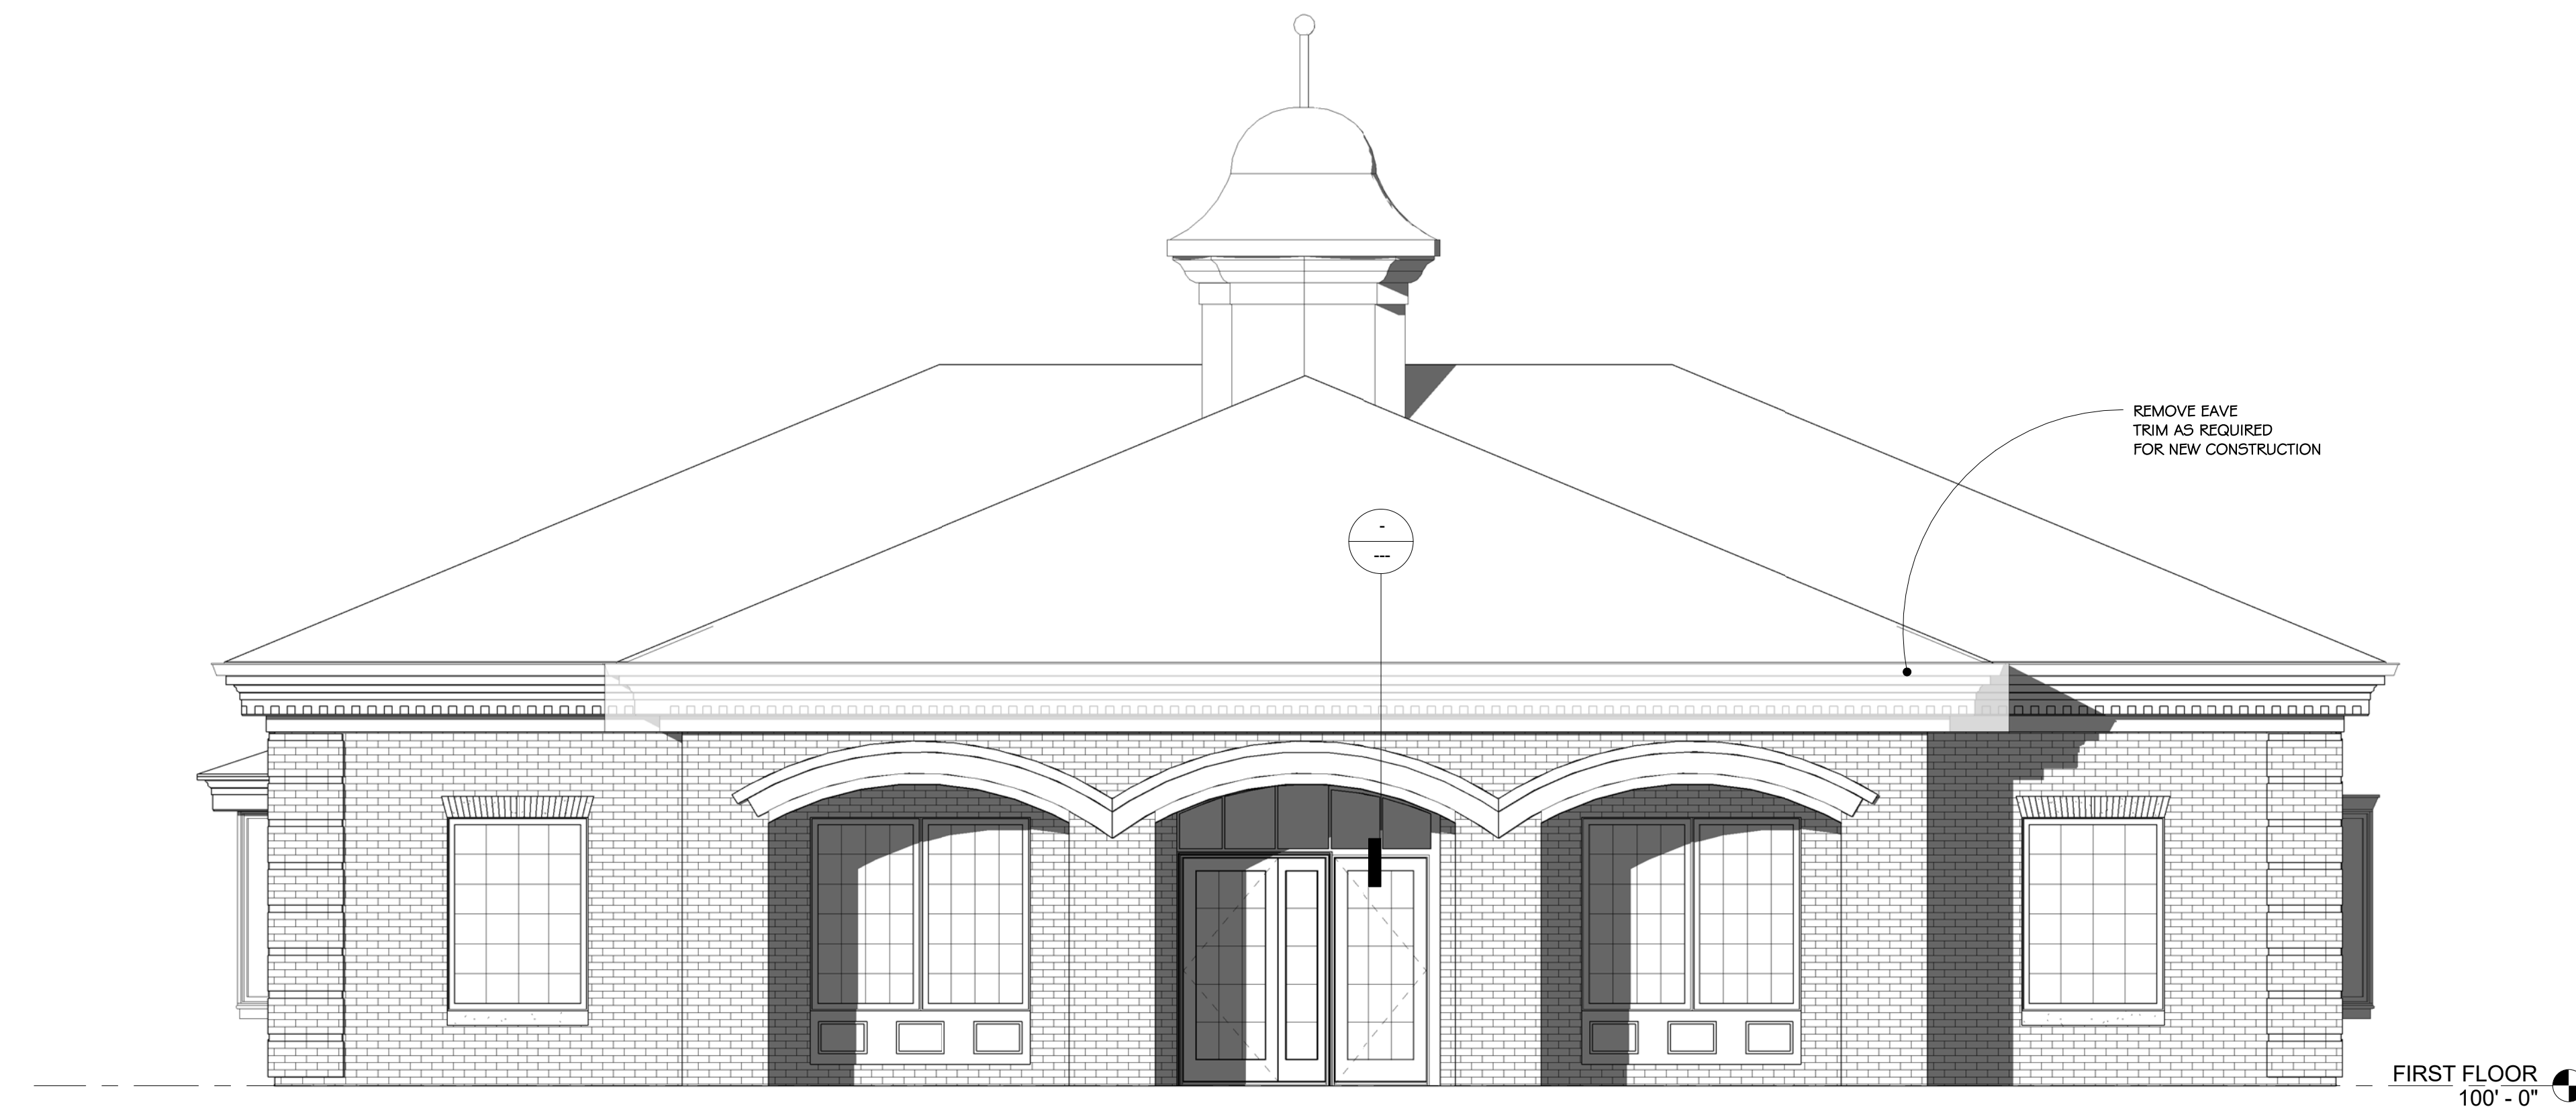


1 EXISTING ELEVATION - WEST
 1/4" = 1'-0"



3 SECTION DETAIL - WEST PEDIMENT
 1" = 1'-0"

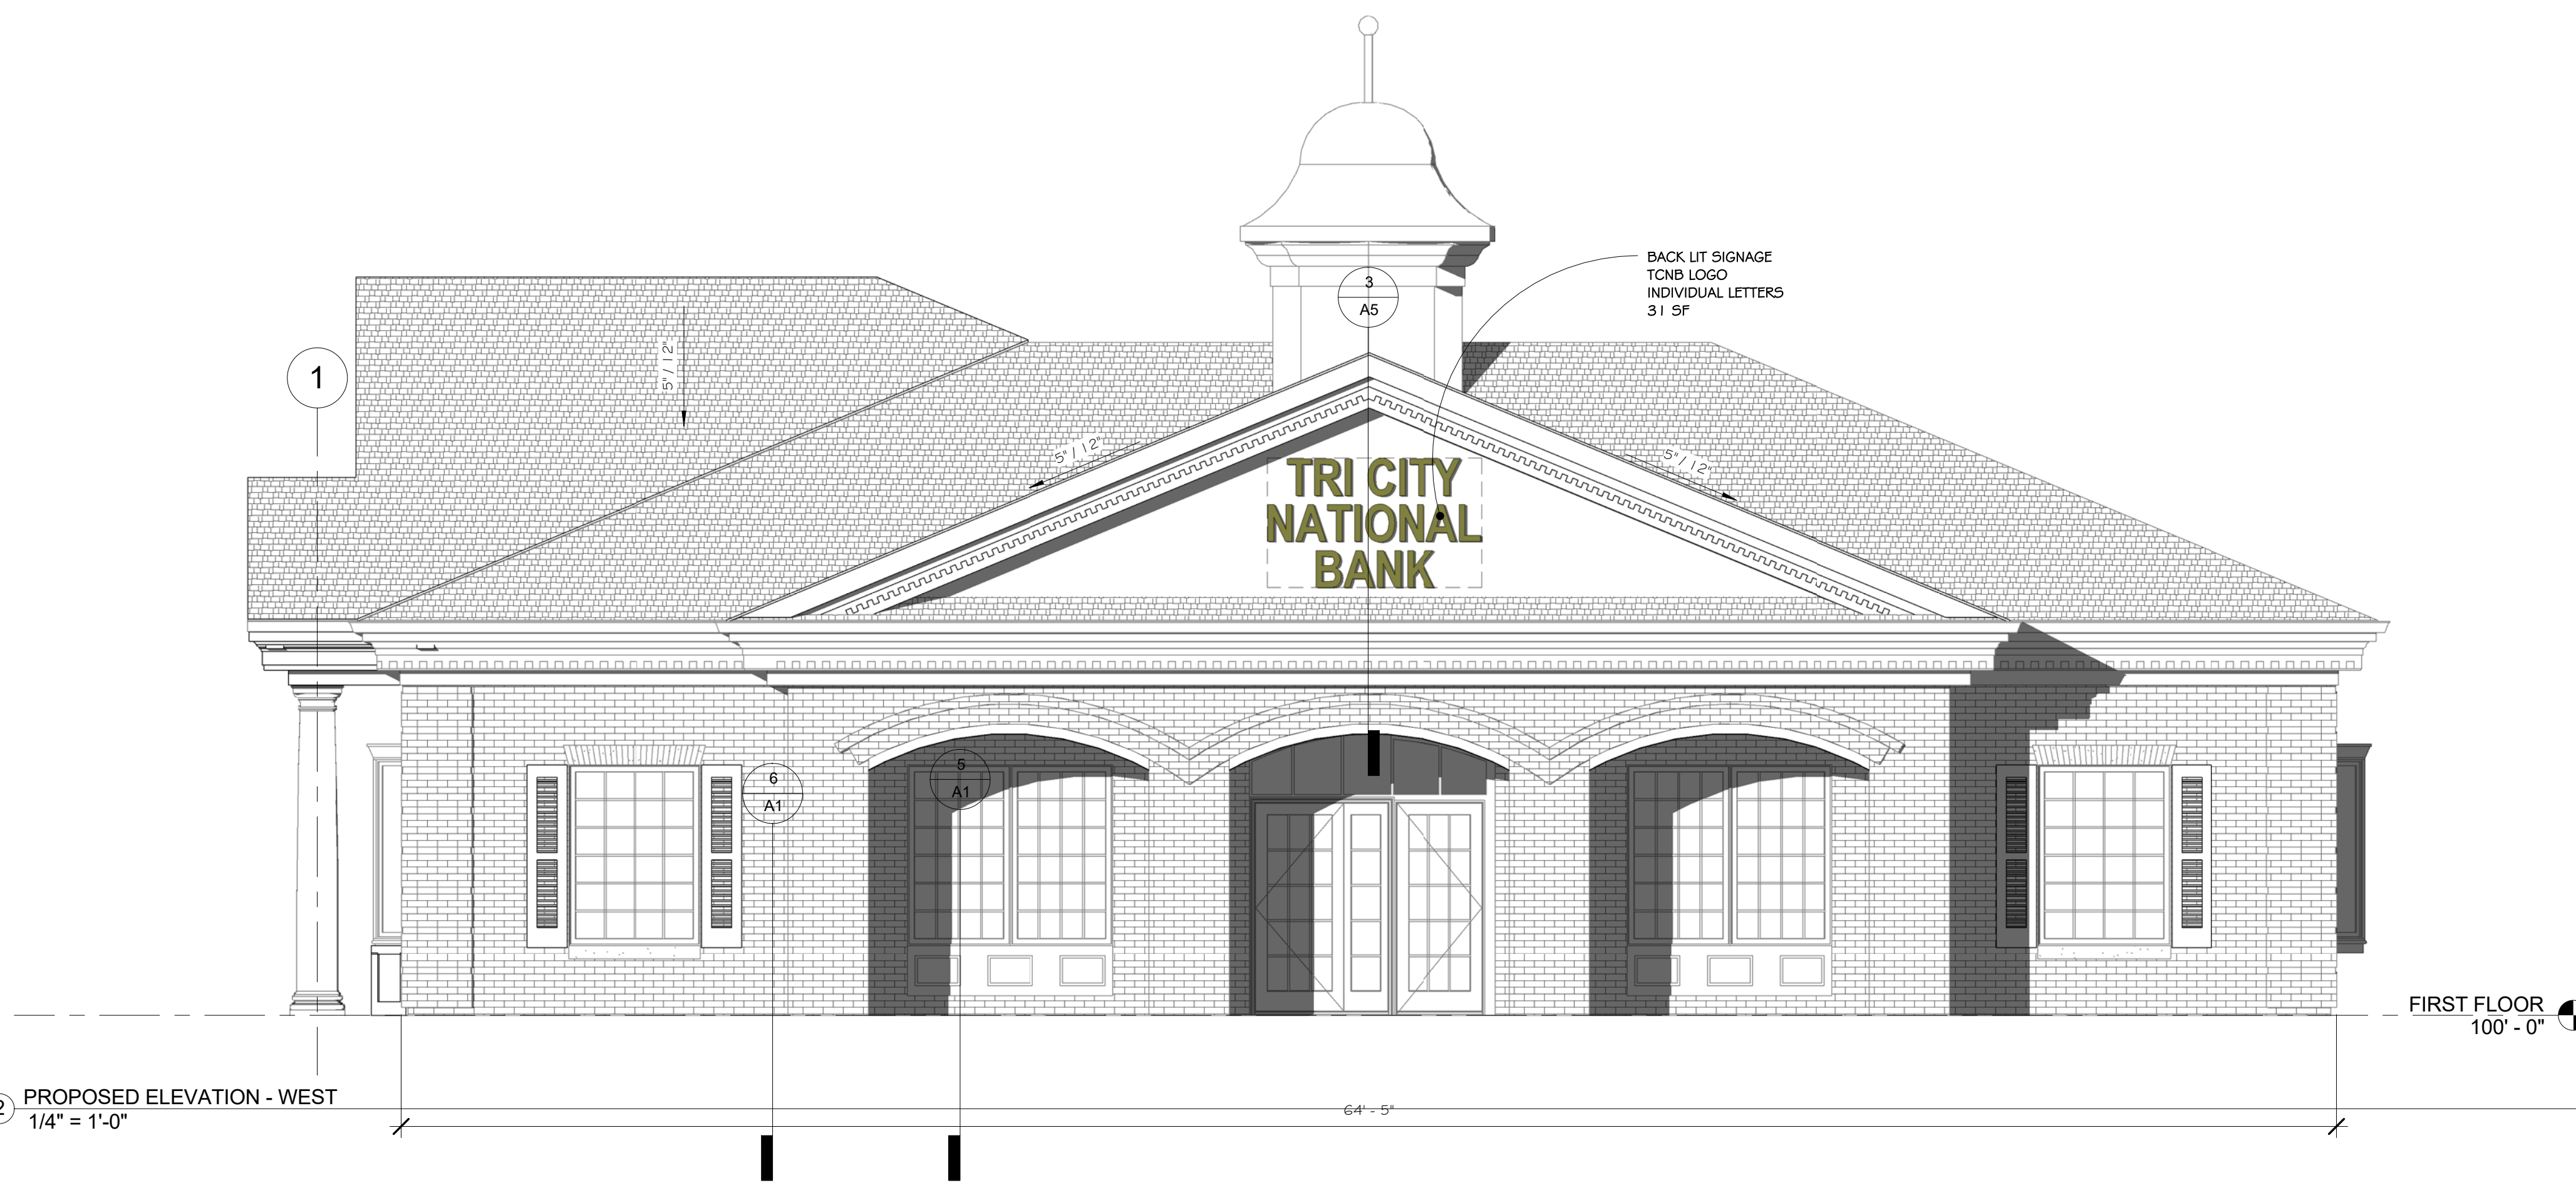

2 PROPOSED ELEVATION - WEST
 1/4" = 1'-0"

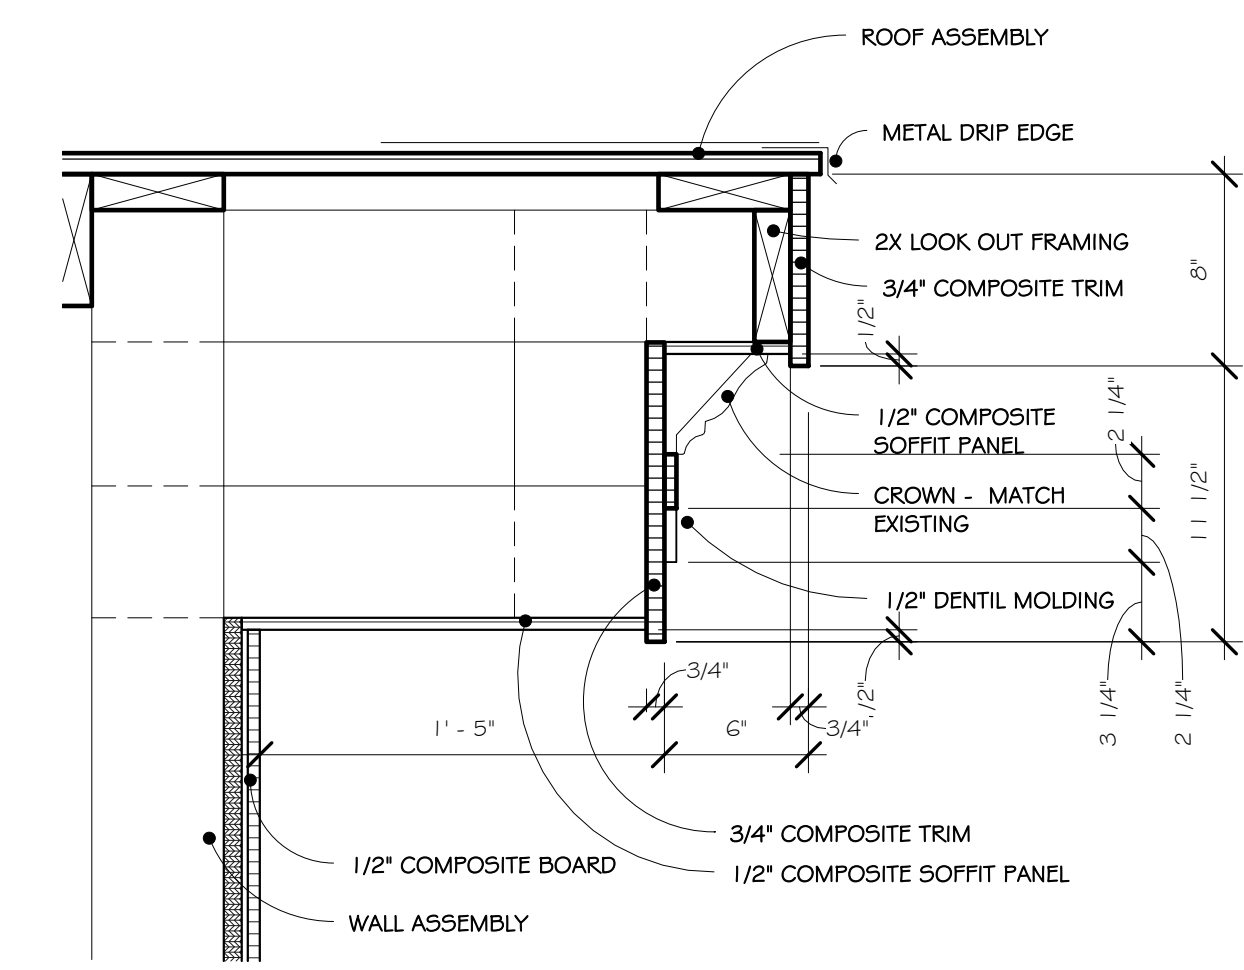

4 SECTION DETAIL - RAKE
 1 1/2" = 1'-0"

