MSI GENERAL CORPORATION

W215 E. WISCONSIN AVE.

NASHOTAH, WI 53058

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SINGLE SOURCE RESPONSIBILITY.™

DESIGNING EXCELLENCE. BUILDING TRUST.

MILESTONE ISSUE DATES

OWNER REVIEW:

BUDGET SET:

PROPOSAL SET:

REVISIONS:

PLAN COMMISSION SET

CONSTRUCTION SET

RECORD DRAWING SET

SUBMITTAL FOR PERMIT SET:

PROJECT DESCRIPTION

CITY/ STATE / ZIP Waukesha, WI 53188

ALL WORK TO BE COMPLETED AS SHOWN, AND IN ACCORDANCE WITH THE LATEST EDITION OF THE MSI GENERAL MASTER SPECIFICATION

PROJECT ARCHITECT	STRUCTURAL ENGINEER	LANDSCAPE DESIGN
BJZ	SPIRE	DJB
	ENGINEERING	
<u>DESIGN</u> <u>ARCHITECT</u>	CIVIL ENGINEER :	REVIEWED BY
TNK	MTS	MTS

ARCHITE

MTS SHEET TITLE: **COVER SHEET**

PROJECT NUMBER:


ONSITE CIVIL ENGINEERING INFRASTRUCTURE PLANS FISHER BARTON

WAUKESHA, WISCONSIN

PLANS PREPARED

FISHER BARTON

570 BLUEMOUND ROAD WAUKESHA, WI 53188

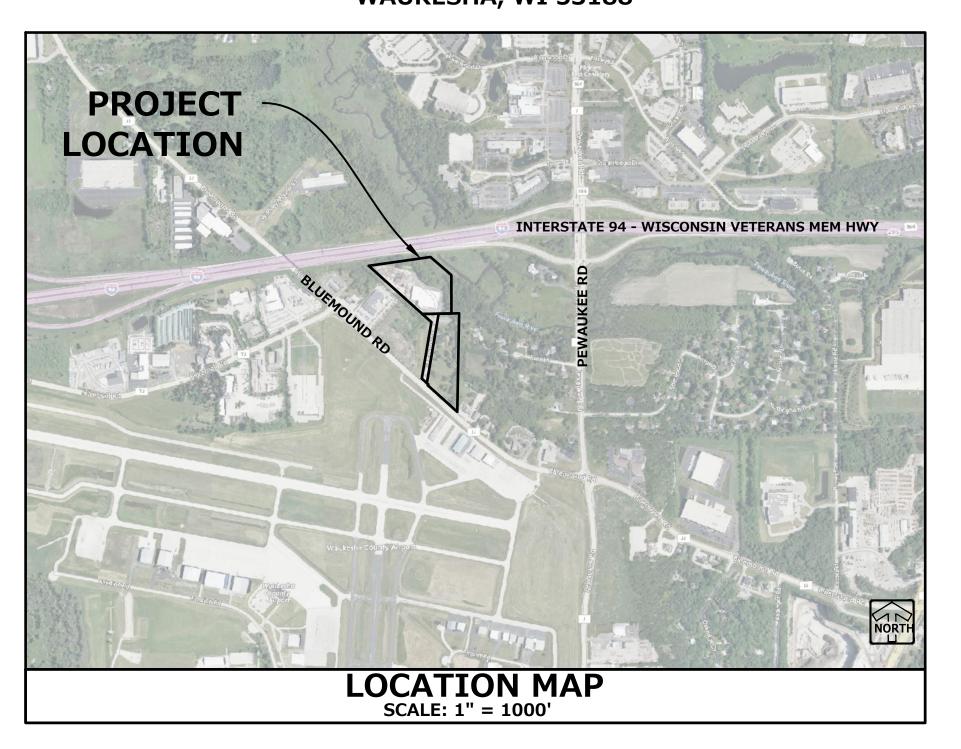

GENERAL NOTES


- 1. THE INTENTION OF THE PLANS AND SPECIFICATIONS IS TO SET FORTH PERFORMANCE AND 9. SHOULD ANY DISCREPANCIES OR CONFLICTS IN THE PLANS OR SPECIFICATIONS BE DISCOVERED CONSTRUCTION MATERIAL STANDARDS FOR THE PROPER EXECUTION OF WORK. ALL WORKS CONTAINED WITHIN THE PLANS AND SPECIFICATIONS SHALL BE COMPLETED IN ACCORDANCE WITH ALL REQUIREMENTS FROM LOCAL, STATE, FEDERAL OR OTHER GOVERNING AGENCY'S LAWS, REGULATIONS, JURISDICTIONAL ORDINANCES/CODES/RULES/ETC., AND THE OWNER'S DIRECTION.
- NOVEMBER 29, 2022 FOR THE PROJECT SITE. THE DATA ON SUB-SURFACE SOIL CONDITIONS IS NOT INTENDED AS A REPRESENTATION OR WARRANTY OF THE CONTINUITY OF SUCH CONDITIONS BETWEEN BORINGS OR INDICATED SAMPLING LOCATIONS. IT SHALL BE EXPRESSLY UNDERSTOOD THAT OWNER WILL NOT BE RESPONSIBLE FOR ANY INTERPRETATIONS OR CONCLUSIONS DRAWN THERE FROM BY THE CONTRACTOR. DATA IS MADE AVAILABLE FOR THE CONVENIENCE OF THE 11. CONTRACTOR. THE CONTRACTOR IS RESPONSIBLE FOR PERFORMING ANY ADDITIONAL SOILS INVESTIGATIONS THEY FEEL IS NECESSARY FOR THE PROPER EVALUATION OF THE SITE FOR PURPOSES OF PLANNING, BIDDING, OR CONSTRUCTING THE PROJECT AT NO ADDITIONAL COST TO THE OWNER.
- THE CONTRACTOR IS RESPONSIBLE TO REVIEW AND UNDERSTAND ALL COMPONENTS OF THE PLANS AND SPECIFICATIONS, INCLUDING FIELD VERIFYING SOIL CONDITIONS, PRIOR TO
- OF THEIR REVIEW OF PLANS, SPECIFICATIONS, REPORTS AND FIELD INVESTIGATIONS.
- THE CONTRACTOR IS SOLELY RESPONSIBLE FOR THE COMPUTATION OF QUANTITIES AND WORK REQUIRED TO COMPLETE THIS PROJECT. THE CONTRACTOR'S BID SHALL BE BASED ON ITS OWN 14. COMPUTATIONS AND IN NO SUCH INSTANCE RELY ON THE ENGINEER'S ESTIMATE.
- QUESTIONS/CLARIFICATIONS WILL BE INTERPRETED BY ENGINEER/OWNER PRIOR TO THE AWARD OF CONTRACT. ENGINEER/OWNER WILL SUBMIT OFFICIAL RESPONSES IN WRITING. 15. INTERPRETATIONS PRESENTED IN OFFICIAL RESPONSES SHALL BE BINDING ON ALL PARTIES ASSOCIATED WITH THE CONTRACT. IN NO WAY SHALL WORD-OF-MOUTH DIALOG CONSTITUTE AN OFFICIAL RESPONSE.
- CONDITIONS OF THE SITE, AND SHALL ACCOUNT FOR CONDITIONS THAT AFFECT, OR MAY AFFECT CONSTRUCTION INCLUDING, BUT NOT LIMITED TO, LIMITATIONS OF WORK ACCESS, SPACE LIMITATIONS, OVERHEAD OBSTRUCTIONS, TRAFFIC PATTERNS, LOCAL REQUIREMENTS, ADJACENT ACTIVITIES, ETC. FAILURE TO CONSIDER SITE CONDITIONS SHALL NOT BE CAUSE FOR CLAIM OF JOB EXTRAS.
- COMMENCEMENT OF CONSTRUCTION SHALL EXPLICITLY CONFIRM THAT THE CONTRACTOR HAS REVIEWED THE PLANS AND SPECIFICATIONS IN ENTIRETY AND CERTIFIES THAT THEIR SUBMITTED BID PROPOSAL CONTAINS PROVISIONS TO COMPLETE THE PROJECT, WITH THE EXCEPTION OF UNFORESEEN FIELD CONDITIONS; ALL APPLICABLE PERMITS HAVE BEEN OBTAINED; AND CONTRACTOR UNDERSTANDS ALL OF THE REQUIREMENTS OF THE PROJECT.

- TWO GEOTECHNICAL REPORTS HAVE BEEN PREPARED BY CGC DATED NOVEMBER 23, 2022 & 10. THE CONTRACTOR SHALL, AT ITS OWN EXPENSE, OBTAIN ALL NECESSARY PERMITS AND LICENSES TO COMPLETE THE PROJECT. OBTAINING PERMITS, OR DELAYS, IS NOT CAUSE FOR DELAY OF THE CONTRACT OR SCHEDULE. CONTRACTOR SHALL COMPLY WITH ALL PERMIT
 - THE CONTRACTOR SHALL NOTIFY ALL INTERESTED GOVERNING AGENCIES, UTILITY COMPANIES AFFECTED BY THIS CONSTRUCTION PROJECT, AND DIGGER'S HOTLINE IN ADVANCE OF CONSTRUCTION TO COMPLY WITH ALL JURISDICTIONAL ORDINANCES/CODES/RULES/ETC., PERMIT STIPULATIONS, AND OTHER APPLICABLE STANDARDS.
 - RESPONSIBLE TO INITIATE, INSTITUTE, ENFORCE, MAINTAIN, AND SUPERVISE ALL SAFETY

 - THE CONTRACTOR SHALL INDEMNIFY THE OWNER, ENGINEER, AND THEIR AGENTS FROM ALL LIABILITY INVOLVED WITH THE CONSTRUCTION, INSTALLATION, AND TESTING OF THE WORK ON
 - UPON COMPLETION OF SITE WORK FOR ENGINEERING REVIEW. PUBLIC INFRASTRUCTURE DEDICATION SHALL BE ACCEPTED BY COMMON COUNCIL PRIOR TO OCCUPANCY PERMITS.
- PRIOR TO START OF WORK, CONTRACTOR SHALL BE COMPLETELY FAMILIAR WITH ALL 16. ALL SITE IMPROVEMENTS AND CONSTRUCTION SHOWN ON THE PLANS SHALL CONFORM TO THE CITY OF WAUKESHA DEVELOPMENT HANDBOOK & INFRASTRUCTURE SPECIFICATIONS

- 4. THE CONTRACTOR SHALL PROMPTLY REPORT ANY ERRORS OR AMBIGUITIES LEARNED AS PART

- AFTER THE AWARD OF CONTRACT, ENGINEER SHALL BE NOTIFIED IN WRITING IMMEDIATELY AND CONSTRUCTION OF ITEMS AFFECTED BY THE DISCREPANCIES/CONFLICTS SHALL NOT COMMENCE, OR CONTINUE, UNTIL A WRITTEN RESPONSE FROM ENGINEER/OWNER IS DISTRIBUTED. IN THE EVENT OF A CONFLICT BETWEEN REFERENCED CODES, STANDARDS, SPECIFICATIONS AND PLANS, THE ONE ESTABLISHING THE MOST STRINGENT REQUIREMENTS SHALL BE FOLLOWED.
- REQUIREMENTS.
- 12. SAFETY IS THE SOLE RESPONSIBILITY OF THE CONTRACTOR. THE CONTRACTOR SHALL BE PRECAUTIONS AND JOB SITE SAFETY PROGRAMS IN CONNECTION WITH THE WORK.
- 13. CONTRACTOR SHALL KEEP THE JOBSITE CLEAN AND ORDERLY AT ALL TIMES. ALL LOCATIONS OF THE SITE SHALL BE KEPT IN A WORKING MANNER SUCH THAT DEBRIS IS REMOVED CONTINUOUSLY AND ALL RESPECTIVE CONTRACTORS OPERATE UNDER GENERAL "GOOD
- GRADING AND DRAINAGE RECORD DRAWINGS AND UTILITY ASBUILTS/ RECORDS ARE REQUIRED BY DEVELOPMENT AGREEMENT. THESE SUBMITTALS SHALL BE PREPARED PER CITY STANDARDS

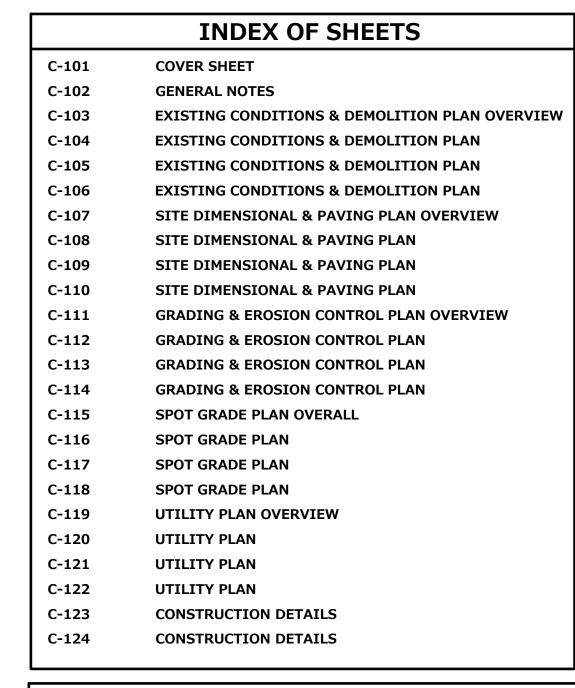

GOVERNMENT CONTACTS

GOVERNMENT AGENTS: CITY OF WAUKESHA (262) 524-3756 E-MAIL: DKOEHLER@WAUKESHA-WI.GOV

SURVEYOR:

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MII WAUKFF, WI 53204

E-MAIL: DON@CHAPUTLANDSURVEYS.COM

MAIN: (414) 224-8068

PROJECT TEAM CONTACTS

CIVIL ENGINEER:

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E-MAIL: mseidl@pinnacle-engr.com

MAIN: (414) 403-1166

APPLICANT/OWNER: PAUL KREJCAREK

E-MAIL: pkrejcarek@fisherbarton.com

FISHER BARTON

Architect: BERT ZENKER, AIA, NCARB **MSI GENERAL** W215 E. WISCONSIN AVE

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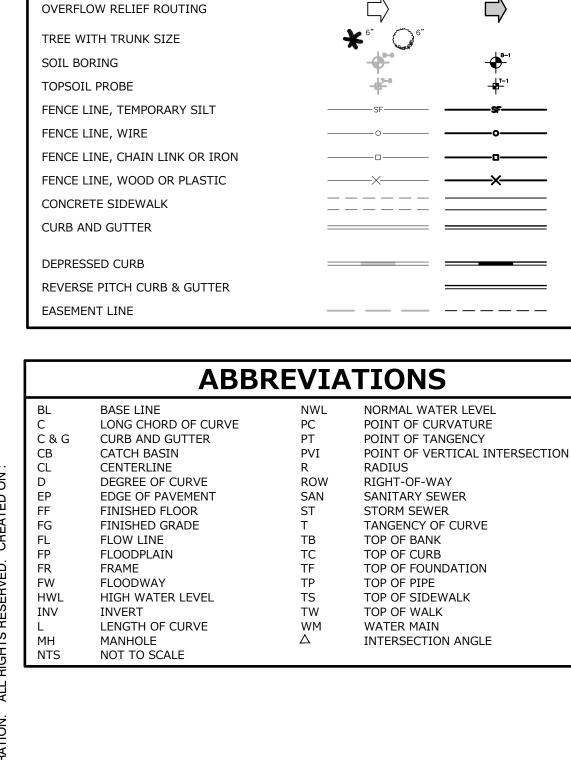
www.DiggersHotline.com

PINNACLE ENGINEERING GROUP, LLC **ENGINEER'S LIMITATION**

PINNACLE ENGINEERING GROUP, LLC AND THEIR CONSULTANTS DO NOT WARRANT OR GUARANTEE THE ACCURACY AND COMPLETENESS OF THE DELIVERABLES HEREIN BEYOND A REASONABLE DILIGENCE. IF ANY MISTAKES, OMISSIONS, OR DISCREPANCIES ARE FOUND TO EXIST WITHIN THE DELIVERABLES. THE ENGINEER SHALL BE PROMPTLY NOTIFIED PRIOR TO BID SO THAT HE MAY HAVE THE OPPORTUNITY TO TAKE WHATEVER STEPS NECESSARY TO RESOLVE THEM. FAILURE TO PROMPTLY NOTIFY THE ENGINEER OF SUCH CONDITIONS SHALL ABSOLVE THE ENGINEER FROM ANY RESPONSIBILITY FOR THE CONSEQUENCES OF SUCH FAILURE. ACTIONS TAKEN WITHOUT THE KNOWLEDGE AND CONSENT OF THE ENGINEER, OR IN CONTRADICTION TO THE ENGINEER'S DELIVERABLES OR RECOMMENDATIONS, SHALL BECOME THE RESPONSIBILITY NOT OF THE ENGINEER BUT OF THE PARTIES RESPONSIBLE FOR TAKING SUCH ACTION.

FURTHERMORE, PINNACLE ENGINEERING GROUP, LLC IS NOT RESPONSIBLE FOR CONSTRUCTION SAFETY OR THE MEANS AND METHODS OF CONSTRUCTION.

SHEET NUMBER



LEGEND

EXISTING

SANITARY SEWER MANHOLE

STORM SEWER AREA DRAIN

PRECAST FLARED END SECTION

STORM SEWER INLET (ROUND CASTING)

STORM SEWER INLET (RECTANGULAR CASTING)

STORM SEWER MANHOLE

CONCRETE HEADWALL

VALVE VAULT

FIRE HYDRANT

BUFFALO BOX

SANITARY SEWER

CLEANOUT

FORCE MAIN

STORM SEWER

DRAIN TILE

WATER MAIN

LIGHTING

UTILITY CROSSING

ELECTRICAL CABLE

OVERHEAD WIRES

OR PEDESTAL POWER POLE

STREET SIGN

TELEPHONE LINE

SPOT ELEVATION

GAS MAIN

CONTOUR

WETLANDS

FLOODWAY FLOODPLAIN

ELECTRICAL TRANSFORMER

POWER POLE WITH LIGHT

HIGH WATER LEVEL (HWL)

DITCH OR SWALE

DIVERSION SWALE

NORMAL WATER LEVEL (NWL)

DIRECTION OF SURFACE FLOW

CAUTION EXISTING UTILITIES NEARBY

VALVE BOX

PROPOSED

CAUTION

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CONTRACTOR SHALL PERFORM ALL DEMOLITION WORK IN ACCORDANCE WITH ALL APPLICABLE FEDERAL. STATE. AND LOCAL REQUIREMENTS.

5. VOIDS LEFT BY REMOVAL OF FEATURES SHALL BE MODIFIED/FILLED TO PREVENT PONDING OF WATER.

CLEARING AND GRUBBING DESIGNATIONS SHALL INCLUDE CLEARING, GRUBBING, REMOVING, AND DISPOSING OF ALL VEGETATION AND DEBRIS WITHIN THE LIMITS OF CONSTRUCTION, AS DESIGNATED ON THE PLANS. CONTRACTOR SHALL REMOVE ONLY THOSE TREES ABSOLUTELY NECESSARY TO ALLOW FOR

8. CONTRACTOR SHALL REMOVE EXISTING FENCING IN A MANNER TO ALLOW REUSE. ANY FENCING MATERIAL TO BE REUSED IN THE CONSTRUCTION OF RELOCATED FENCE LINES SHALL BE PRESENTED TO ENGINEER FOR INSPECTION AND PROPOSED CONTRACT DEDUCT ASSOCIATED WITH REUSE OF THE SALVAGED MATERIAL. ENGINEER OR OWNER WILL PROVIDE WRITTEN ACCEPTANCE OF THE PROPOSED SALVAGED MATERIAL.

PUBLIC UTILITY CONNECTIONS TO SITE.

10. CONTRACTOR SHALL COORDINATE STOCKPILE LIMITS AND LOCATIONS WITH ENGINEER/OWNER PRIOR TO DEMOLITION.

DEMOLITION NOTES

PERIMETER SILT FENCING AND CONSTRUCTION ENTRANCES SHALL BE INSTALLED PRIOR TO ANY DEMOLITION. PLEASE REFER TO GRADING AND EROSION AND SEDIMENT CONTROL PLAN SHEETS FOR FURTHER DETAILS.

4. COORDINATE WITH ALL APPLICABLE UTILITY COMPANIES AND THE MUNICIPALITY TO PROTECT EXISTING FUNCTIONING UTILITIES, BULKHEAD/REMOVE CONNECTIONS AS NECESSARY, AND TO ENSURE ALL UTILITIES ARE INACTIVE PRIOR TO ANY DEMOLITION ACTIVITIES. CONTRACTOR SHALL TAKE ADEQUATE PRECAUTIONS TO ENSURE PROTECTION OF EXISTING UTILITIES THAT ARE NOT TO BE IMPACTED. THE CONTRACTOR IS RESPONSIBLE FOR REPAIR OF ANY EXISTING UTILITIES DAMAGED AS A RESULT OF THE DEMOLITION.

6. DEMOLISH AND DISPOSE EXISTING PIPING. CABLE/WIRES. STRUCTURES. OR OTHER SURFACE FEATURES INDICATED ON THE PLANS TO BE REMOVED.

9. CONTRACTOR SHALL COORDINATE WITH THE MUNICIPALITY FOR TERMINATION OF

GENERAL SPECIFICATIONS FOR CONSTRUCTION ACTIVITIES

1. THE PROPOSED IMPROVEMENTS SHALL BE CONSTRUCTED ACCORDING TO THE WISCONSIN D.O.T. STANDARD SPECIFICATIONS FOR HIGHWAY AND STRUCTURE CONSTRUCTION, LATEST EDITION, THE STANDARD SPECIFICATIONS FOR SEWER & WATER IN WISCONSIN, AND WISCONSIN ADMINISTRATIVE CODE, SPS 360, 382-383, AND THE LOCAL ORDINANCES AND SPECIFICATIONS. 2. THE CONTRACTOR SHALL OBTAIN ALL PERMITS REQUIRED FOR EXECUTION OF THE WORK. THE CONTRACTOR SHALL CONDUCT THEIR WORK ACCORDING TO THE REQUIREMENTS OF THE PERMITS

3. THE CONTRACTOR SHALL NOTIFY THE OWNER AND THE MUNICIPALITY FORTY- EIGHT (48) HOURS PRIOR TO THE START OF CONSTRUCTION. 4. THE MUNICIPALITY SHALL HAVE THE RIGHT TO INSPECT, APPROVE, AND REJECT THE CONSTRUCTION OF THE PUBLIC PORTIONS OF THE WORK. THE OWNER SHALL HAVE THE RIGHT TO INSPECT,

APPROVE, AND REJECT THE CONSTRUCTION OF ALL PRIVATE PORTIONS OF THE WORK. 5. THE CONTRACTOR SHALL INDEMNIFY THE OWNER, THE ENGINEER, AND THE MUNICIPALITY, THEIR AGENTS, ETC, FROM ALL LIABILITY INVOLVED WITH THE CONSTRUCTION, INSTALLATION, AND TESTING OF THE WORK ON THIS PROJECT.

6. SITE SAFETY SHALL BE THE SOLE RESPONSIBILITY OF THE CONTRACTOR.

7. THE CONTRACTOR IS RESPONSIBLE FOR FIELD VERIFYING ALL UTILITY INFORMATION SHOWN ON THE PLANS PRIOR TO THE START OF CONSTRUCTION. THE CONTRACTOR SHALL CALL DIGGER'S HOTLINE AT 1-800-242-8511 TO NOTIFY THE UTILITIES OF HIS INTENTIONS, AND TO REQUEST FIELD STAKING OF EXISTING UTILITIES.

8. SILT FENCE AND OTHER EROSION CONTROL FACILITIES MUST BE INSTALLED PRIOR TO CONSTRUCTION OR ANY OTHER LAND DISTURBING ACTIVITY. FOLLOW THE SEQUENCE OF CONSTRUCTION ON THE GRADING & EROSION CONTROL PLAN FOR MORE DETAILS. INSPECTIONS SHALL BE MADE WEEKLY OR AFTER EVERY RAINFALL OF 0.5" OR MORE. REPAIRS SHALL BE MADE IMMEDIATELY. THE CONTRACTOR SHALL BE RESPONSIBLE FOR REMOVING ALL EROSION CONTROL FACILITIES ONCE THE THREAT OF EROSION HAS PASSED WITH THE APPROVAL OF THE GOVERNING AGENCY.

9. ANY ADJACENT PROPERTIES OR ROAD RIGHT-OF-WAYS WHICH ARE DAMAGED DURING CONSTRUCTION MUST BE RESTORED BY THE CONTRACTOR

10. TRASH AND DEBRIS SHALL BE NOT BE ALLOWED TO ACCUMULATE ON THIS SITE AND THE SITE SHALL BE CLEAN UPON COMPLETION OF WORK 11. THE OWNER SHALL HAVE THE RIGHT TO HAVE ALL MATERIALS USED IN CONSTRUCTION TESTED FOR COMPLIANCE WITH THESE SPECIFICATIONS.

12. SPOT ELEVATIONS REPRESENT THE GRADE ON PAVEMENT SURFACE OR FLOW LINE UNLESS OTHERWISE NOTED.

13. THE CONTRACTOR SHALL IMMEDIATELY NOTIFY ENGINEER/OWNER IF GROUNDWATER IS ENCOUNTERED DURING EXCAVATION.

14. WORK WITHIN ANY ROADWAY RIGHT-OF-WAY SHALL BE COORDINATED WITH THE APPROPRIATE MUNICIPAL OFFICIAL PRIOR TO COMMENCEMENT OF ANY CONSTRUCTION ACTIVITIES. CONTRACTOR SHALL BE RESPONSIBLE FOR OBTAINING ALL NECESSARY PERMITS AND FEES. GRADING WITHIN RIGHT-OF-WAY IS SUBJECT TO APPROVAL BY SAID OFFICIALS. RESTORATION OF RIGHT-OF-WAY IS CONSIDERED INCIDENTAL AND SHALL BE INCLUDED IN THE COST OF GRADING. RESTORATION SHALL INCLUDE ALL ITEMS NECESSARY TO RESTORE RIGHT-OF-WAY IN-KIND INCLUDING

15. CONTRACTOR SHALL COMPLY WITH ALL CITY OF WAUKESHA CONSTRUCTION STANDARDS/ORDINANCES.

16. LANDSCAPE AND TURF AREAS SHALL HAVE A MINIMUM OF 4-INCH TOPSOIL REPLACEMENT.

SPECIFICATIONS FOR GRADING & EROSION CONTROL

1. THE CONTRACTOR SHALL ASSUME SOLE RESPONSIBILITY FOR THE COMPUTATIONS OF ALL GRADING AND FOR ACTUAL LAND BALANCE, INCLUDING UTILITY TRENCH SPOIL. THE CONTRACTOR SHALL IMPORT OR EXPORT MATERIAL AS NECESSARY TO COMPLETE THE PROJECT. CONTRACTOR SHALL NOTIFY OWNER OF THE NEED TO IMPORT OR HAUL OFF SOIL. ON-SITE LOCATIONS SUITABLE FOR BORROW OR FILL MAY BE PRESENT. COORDINATE WITH OWNER.

2. THE CONTRACTOR IS RESPONSIBLE FOR VERIFYING SOIL CONDITIONS PRIOR TO COMMENCEMENT OF CONSTRUCTION. A GEOTECHNICAL REPORT MAY BE AVAILABLE FROM THE OWNER.

3. SITE SHALL BE CLEARED TO THE LIMITS SHOWN ON THE PLANS. REMOVE VEGETATION FROM THE SITE. BURNING IS NOT PERMITTED. PROTECT TREES AND OTHER FEATURES FROM DAMAGE WITH

FENCING. STOCKPILES SHALL NOT BE LOCATED CLOSER THAN 25' TO A DRAINAGE STRUCTURE OR FEATURE AND SHALL BE SURROUNDED WITH SILT FENCE.

4. THE GEOTECHNICAL ENGINEER IS RESPONSIBLE FOR VERIFYING COMPACTION AND FILL PLACEMENT IN THE FIELD. THE GEOTECHNICAL ENGINEER MAY SUPERCEDE THESE SPECIFICATIONS IF THERE IS GOOD CAUSE TO DO SO. AN EXPLANATION MUST BE SUBMITTED TO THE ENGINEER IN WITTING BEFORE ANY DEVIATIONS ARE MADE.

5. IF NO GEOTECHNICAL RECOMMENDATION IS AVAILABLE, THEN THE FOLLOWING SPECIFICATIONS SHALL APPLY. ALL FILL SHALL BE CONSIDERED STRUCTURAL FILL AND SHALL BE PLACED IN ACCORDANCE WITH THE FOLLOWING: THE COMPACTED FILL SUBGRADE SHALL CONSIST OF AND SHALL BE UNDERLAIN BY SUITABLE BEARING MATERIALS, FREE OF ALL ORGANIC. FROZEN OR OTHER DELETERIOUS MATERIAL AND INSPECTED AND APPROVED BY THE RESIDENT GEOTECHNICAL ENGINEER. PREPARATION OF THE SUBGRADE, AFTER STRIPPING, SHALL CONSIST OF PROOF-ROLLING TO DETECT UNSTABLE AREAS THAT MIGHT BE UNDERCUT, AND COMPACTING THE SCARIFIED SURFACE TO THE SAME MINIMUM DENSITY INDICATED BELOW. THE COMPACTED FILL MATERIALS SHALL BE FREE OF ANY DELETERIOUS, ORGANIC OR FROZEN MATTER AND SHALL HAVE A MAXIMUM LIQUID LIMIT (ASTM-D-423) AND PLASTICITY INDEX (ASTM D-424) IF 30 AND 10 RESPECTFULLY, UNLESS SPECIFICALLY TESTED AND FOUND TO HAVE LOW EXPANSIVE PROPERTIES AND APPROVED BY AN EXPERIENCED SOILS ENGINEER. THE TOP TWELVE (12") INCHES OF COMPACTED FILL SHOULD HAVE A MAXIMUM THREE (3") INCH PARTICLE DIAMETER AND ALL UNDERLYING COMPACTED FILL A MAXIMUM SIX (6") INCH PARTICLE DIAMETER UNLESS SPECIFICALLY APPROVED BY AN EXPERIENCED SOILS ENGINEER. ALL FILL MATERIAL MUST BE TESTED AND APPROVED UNDER THE DIRECTION AND SUPERVISION OF AN EXPERIENCED SOILS ENGINEER PRIOR TO PLACEMENT, IF THE FILL IS TO PROVIDE NON-FROST SUSCEPTIBLE CHARACTERISTICS, IT MUST BE CLASSIFIED AS A CLEAN GW, GP, SW, OR SP PER UNITED SOIL CLASSIFICATION SYSTEM (ASTM D-2487). FOR STRUCTURAL FILL THE DENSITY OF THE STRUCTURAL COMPACTED FILL AND SCARIFIED SUBGRADE AND GRADES SHALL NOT BE LESS THAN 95 PERCENT OF THE MAXIMUM DRY DENSITY AS DETERMINED BY THE STANDARD PROCTOR (ASTM D-698) WITH THE EXCEPTION TO THE TOP 12 INCHES OF PAVEMENT SUBGRADE WHICH SHALL A MINIMUM IN-SITU DENSITY OF 100 PERCENT OF THE MAXIMUM DRY DENSITY, OR 5 PERCENT HIGHER THAN UNDERLYING FILL MATERIALS. THE MOISTURE CONTENT OF COHESIVE SOIL SHALL NOT VARY BY MORE THAN -1 TO +3 PERCENT AND GRANULAR SOIL ±3 PERCENT OF OPTIMUM WHEN PLACED AND COMPACTED OR RECOMPACTED, UNLESS SPECIFICALLY APPROVED BY THE SOILS ENGINEER TAKING INTO CONSIDERATION THE TYPE OF MATERIALS AND COMPACTION EQUIPMENT BEING USED. THE COMPACTION EQUIPMENT SHOULD CONSIST OF SUITABLE MECHANICAL EQUIPMENT SPECIFICALLY DESIGNED FOR SOIL COMPACTION, BULLDOZERS OR SIMILAR TRACKED VEHICLES ARE TYPICALLY NOT SUITABLE FOR COMPACTION, MATERIAL THAT IS TOO WET TO PERMIT PROPER COMPACTION MAY BE SPREAD ON THE FILL AND PERMITTED TO DRY. DISCING, HARROWING OR PULVERIZING MAY BE NECESSARY TO REDUCE THE MOISTURE CONTENT TO A SATISFACTORY VALUE, AFTER WHICH IT SHALL BE COMPACTED. THE FINISHED SUBGRADE AREAS OF THE SITE SHALL BE COMPACTED TO 100 PERCENT OF THE STANDARD PROCTOR (ASTM D-398) MAXIMUM DENSITY.

6. NO FILL SHALL BE PLACED ON A WET OR SOFT SUBGRADE. THE SUBGRADE SHALL BE PROOF-ROLLED AND INSPECTED BY THE GEOTECHNICAL ENGINEER BEFORE ANY MATERIAL IS PLACED.

7. SUBGRADE TOLERANCES ARE +/-1" FOR LANDSCAPE AREAS AND +/- 1/2" FOR ALL PAVEMENT AND BUILDING AREAS.

8. TOPSOIL SHALL BE FREE OF DELETERIOUS MATERIALS, ROOTS, OLD VEGETATION, ROCKS OVER 2" DIAMETER AND SHALL NOT BE EXCESSIVELY CLAYEY IN NATURE. NO CLUMPS LARGER THAN 4" ARE ACCEPTABLE. TOPSOIL MAY BE AMENDED AS NEEDED WITH SAND OR COMPOST TO BE LOOSE WHEN SPREAD.

9. THE CONTRACTOR SHALL MAINTAIN SITE DRAINAGE THROUGHOUT CONSTRUCTION. THIS MAY INCLUDE THE EXCAVATION OF TEMPORARY DITCHES OR PUMPING TO ALLEVIATE WATER PONDING. ANY DEWATERING SHALL NOT GO DIRECTLY TO STREAMS, CREEKS, WETLANDS OR OTHER ENVIRONMENTALLY SENSITIVE AREAS WITHOUT BEING TREATED FIRST. A DIRT BAG OR OTHER DEWATERING TREATMENT DEVICE MAY BE USED TO CAPTURE SEDIMENT FROM THE PUMPED WATER.

). CONTRACTOR IS ADVISED THAT ALL MUD AND DEBRIS MUST NOT BE DEPOSITED ONTO THE ADJACENT ROADWAYS PER THE REQUIREMENT OF THE MUNICIPALITY OR OTHER APPROPRIATE GOVERNMENT AGENCIES. IN THE EVENT THIS OCCURS, THE ROADWAYS SHALL BE POWER SWEPT IMMEDIATELY AND ALL SEDIMENT REMOVED FROM DOWNSTREAM FACILITIES.

SPECIFICATIONS FOR PRIVATE UTILITIES

1. BEFORE PROCEEDING WITH ANY UTILITY CONSTRUCTION. THE CONTRACTOR SHALL EXCAVATE EACH EXISTING LATERAL OR POINT OF CONNECTION AND VERIFY THE LOCATION AND ELEVATION OF

ALL UTILITIES. IF ANY EXISTING UTILITIES ARE NOT AS SHOWN ON THE DRAWINGS, THE CONTRACTOR SHALL NOTIFY THE ENGINEER IMMEDIATELY FOR POSSIBLE REDESIGN.

2. ALL CONNECTIONS TO EXISTING PIPES AND MANHOLES SHALL BE CORED CONNECTIONS. CONNECTIONS TO WATERMAIN SHALL BE WET TAPED WITH A STAINLESS STEEP TAPPING SLEEVE.

3. PROPOSED SANITARY SEWER AND INTERNALLY CONNECTED STORM SEWER SHOWN ON THIS PLAN SHALL TERMINATE AT A POINT FIVE (5) FEET FROM THE EXTERIOR BUILDING WALL. THE EXACT LOCATION OF ALL DOWN SPOUTS CONNECTIONS SHALL BE PER THE ARCHITECTURAL PLANS.

4. CONTRACTOR SHALL NOT SHUT OFF WATER OR PLUG SANITARY SEWER IN MUNICIPAL LINES WITHOUT PRIOR APPROVAL. 5. MATERIALS FOR STORM SEWER SHALL BE AS FOLLOWS: STORM SEWER PIPE 48" OR LESS SHALL BE HIGH DENSITY POLYETHYLENE (HDPE) CORRUGATED PIPE WITH AN INTEGRALLY FORMED SMOOTH WATERWAY SUCH AS ADS N-12. FOR PIPE 10" OR LESS IN DIAMETER, PVC. ASTM D-3034, SDR-26, MAY ALSO BE USED. WHERE SPECIFICALLY REQUIRED, REINFORCED CONCRETE PIPE (RCP) ASTM C-76, CLASS III OR HIGHER, MAY BE USED. TRENCH SECTION SHALL BE CLASS "B" FOR PVC AND HDPE AND CLASS "C" FOR CONCRETE (PER STANDARD SPECIFICATIONS). MANHOLES, INLETS AND CATCH BASINS SHALL BE PRE CAST REINFORCED CONCRETE, ASTM C-478. CASTINGS SHALL BE HEAVY DUTY CAST IRON. AREA DRAINS SHALL BE PER DETAIL ON PLAN OR EQUIVALENT AND SHALL BE A MINIMUM OF 24" IN DIAMETER. CONNECTIONS TO EXISTING PIPES SHALL BE MADE WITH INSERTA WYE OR EQUIVALENT. LAST (3) THREE JOINTS SHALL BE RESTRAINED WITH RODS.

6. MATERIALS FOR SANITARY SEWER SHALL BE AS FOLLOWS: SANITARY SEWER SHALL BE PVC, ASTM D-3034, SDR-35 WITH RUBBER GASKETED JOINTS, CONFORMING TO ASTM D-3212. TRENCH SECTIONS SHALL BE CLASS "B" BEDDING (PER STANDARD SPECIFICATIONS). CRUSHED STONE CHIPS SHALL BE USED FOR BEDDING MATERIAL. CONNECTIONS SHALL BE MAD WITH A INSERTA WYE

OR EQUIVALENT. A MINIMUM OF 6' OF COVER IS REQUIRED FOR ALL SANITARY SEWER. 7. MATERIALS FOR WATER SERVICES AND PRIVATE HYDRANTS SHALL BE AS FOLLOWS: WATER SERVICES SHALL BE PVC, HDPE, OR DI AS ALLOWED BY MUNICIPAL CODE, PVC SHALL BE AWWA C-900. DI SHALL BE AWWA C151. CLASS 52 (OR AS REQUIRED BY LOCAL CODE). TRENCH SECTIONS SHALL BE CLASS "B" BEDDING (PER STANDARD SPECIFICATIONS). CRUSHED STONE CHIPS SHALL BE USED FOR BEDDING MATERIAL. CONNECTION SHALL BE MADE WITH A WET TAP, CORPORATE STOP AND VALVE BOX PER MUNICIPAL STANDARDS. A MINIMUM OF 6' COVER IS REQUIRED FOR ALL WATERMAIN. VALVES SHALL BE NONRISING STEM, RESILIENT SEATED GATE VALVES COMPLYING WITH AWWA C509 WITH A THREE PIECE CAST IRON VALVE BOX. INSTALL THRUST BLOCKS AT ALL BENDS AND TEES. DISINFECT ALL NEW LINES AND OBTAIN SAFE WATER SAMPLE PRIOR TO USE.

8. EXTREME CAUTION MUST BE FOLLOWED REGARDING THE COMPACTION OF ALL UTILITY TRENCHES. MECHANICALLY COMPACTED GRANULAR BACKFILL IS REQUIRED UNDER & WITHIN 5 FEET OF ALL PAVEMENT INCLUDING SIDEWALKS. FLOODING OF BACKFILL MATERIAL IS NOT ALLOWED.

9. TRACER WIRE (NO. 12 SINGLE STRAND COPPER) AND WARNING TAPE SHALL BE INSTALLED ON ALL UTILITIES IN ACCORDANCE WITH THE LOCAL AND STATE CODES. TRACER WIRE SHALL TERMINATE IN A VALVECO TERMINAL BOX AT EACH END.

10. MANDREL TESTING ON SANITARY LINES AND PRESSURE TESTING ON WATERMAIN MAY BE REQUIRED BY THE OWNER OR MUNICIPALITY.

11. UPON COMPLETION OF FINAL PAVING OPERATIONS, THE UTILITY CONTRACTOR SHALL ADJUST ALL MANHOLE AND INLET RIMS AND VALVE BOXES TO FINISHED GRADE.

12. 45° BENDS SHALL BE USED IN PLACE OF 90° BENDS WHEREVER POSSIBLE

SPECIFICATIONS FOR PAVING

1. ALL DIMENSIONS ARE TO FACE OF CURB OR FACE OF BUILDING UNLESS NOTED OTHERWISE. ALL UTILITY DIMENSIONS ARE TO OUTSIDE OF PIPE OR CENTER OF STRUCTURE UNLESS OTHERWISE NOTED. ALL PAVING DIMENSIONS ARE TO FACE OF CURB OR TO EDGE OF PAVEMENT; EXCEPT FOR THE SETBACK FROM PARKING LOTS, MANEUVERING LANES AND FIRE ACCESS LANES, WHERE THE SETBACK IS MEASURED FROM THE BACK OF CURB TO THE PROPERTY LINE.

2. AGGREGATES USED IN THE CRUSHED STONE BASE SHALL CONFORM TO THE GRADATION REQUIREMENTS SECTIONS 301.2 AND 305.2.2 OF THE STANDARD SPECIFICATIONS. THICKNESS SHALL BE PER THE DETAIL ON THE PLANS. BASE SHALL BE 1 1/2 INCH DIAMETER LIMESTONE UNLESS NOTED OTHERWISE. RECYCLED MATERIALS MAY BE ALLOWED WITH APPROVAL FROM THE OWNER. 3. SUBGRADE SHALL BE PROOFROLLED AND APPROVED BY A GEOTECHNICAL ENGINEER PRIOR TO PLACEMENT OF STONE BASE. EXCAVATE UNSUITABLE AREAS AND REPLACE WITH BREAKER RUN

STONE AND RECOMPACT. REFER TO THE GEOTECHNICAL REPORT FOR ADDITIONAL SPECIFICATIONS. 4. EXISTING PAVEMENT SHALL BE SAWCUT IN NEAT STRAIGHT LINES TO FULL DEPTH AT ANY POINT WHERE EXISTING PAVEMENT IS REMOVED. CURB AND WALK SHALL BE REMOVED TO THE NEAREST

JOINT. REMOVED PAVEMENT SHALL BE REPLACED WITH THE SAME SECTION AS EXISTING. MUNICIPAL STANDARDS MAY REQUIRE ADDITIONAL WORK. 5. ASPHALT FOR PARKING AREAS AND THE PRIVATE ROAD SHALL BE PER THE DETAILS. MATERIALS AND PLACEMENT SHALL CONFORM TO THE DOT STANDARD SPECIFICATIONS, SECTION 450 AND 460

TYPE LT IS REQUIRED UNLESS NOTED OTHERWISE. A COMMERCIAL GRADE MIX MAY BE SUBSTITUTED ONLY WITH APPROVAL FROM THE OWNER. CONCRETE FOR CURB, DRIVEWAY, WALKS AND NON-FLOOR SLABS SHALL CONFORM TO THE SECTION 415 OF THE STANDARD SPECIFICATIONS, GRADE A, ASTM C-94, 6 BAG MIX, WITH A MINIMUM 28 DAY COMPRESSIVE STRENGTH OF 3,500 PSI. JOINTING SHALL BE PER SECTION 415.3.7 OF THE STANDARD SPECIFICATION WITH CONSTRUCTION JOINTS HAVING A MAXIMUM SPACING OF 10'. EXPANSION JOINTS SHALL BE PROVIDED EVERY 50'. CONCRETE SHALL BE FINISHED PER SECTION 415.3.8 WITH A MEDIUM BROOM TEXTURE. A CURING MEMBRANE IN CONFORMANCE WITH SECTION

7. PROVIDE CONTRACTOR GRADE ACRYLIC, STRIPING PAINT FOR NEW ASPHALT OR COATED ASPHALT. APPLY MARKING PAINT AT A RATE OF ONE (1) GALLON PER THREE TO FOUR HUNDRED (300-400)

LINEAL FEET OF FOUR (4) INCH WIDE STRIPES OR TO MANUFACTURER'S SPECIFICATION, WHICHEVER IS GREATER. 8. THOROUGHLY CLEAN SURFACES FREE OF DIRT, SAND, GRAVEL, OIL AND OTHER FOREIGN MATTER. CONTRACTOR RESPONSIBLE TO INSPECT EXISTING PAVEMENT SURFACES FOR CONDITIONS AND

DEFECTS THAT WILL ADVERSELY AFFECT QUALITY OF WORK, AND WHICH CANNOT BE PUT INTO AN ACCEPTABLE CONDITION THROUGH NORMAL PREPARATORY WORK AS SPECIFIED.

1. ALL CONSTRUCTION SHALL ADHERE TO THE REQUIREMENTS SET FORTH IN EPA'S NATIONAL POLLUTANT DISCHARGE FLIMINATION SYSTEM (NPDES) STORMWATER GENERAL PERMIT FOR CONSTRUCTION SITE LAND DISTURBANCE ACTIVITIES. ALL EROSION AND SEDIMENT CONTROL MEASURES ARE TO BE CONSTRUCTED AND MAINTAINED IN ACCORDANCE WITH LOCAL, STATE AND FEDERAL TECHNICAL STANDARDS AND PROVISIONS IN EFFECT AT THE TIME OF CONSTRUCTION. THESE PROCEDURES AND STANDARDS SHALL BE REFERRED TO AS BEST MANAGEMENT PRACTICES (BMP'S). IT IS THE RESPONSIBILITY OF ALL CONTRACTORS ASSOCIATED WITH THE PROJECT TO OBTAIN A COPY OF, AND UNDERSTAND, THE BMP'S PRIOR TO THE START OF CONSTRUCTION ACTIVITIES.

GENERAL EROSION AND SEDIMENT CONTROL NOTES

THE EROSION CONTROL MEASURES INDICATED ON THE PLANS ARE THE MINIMUM REQUIREMENTS. ADDITIONAL CONTROL MEASURES AS DIRECTED BY OWNER/ENGINEER OR GOVERNING AGENCIES SHALL BE INSTALLED WITHIN 24

3. MODIFICATIONS TO THE APPROVED SWPPP IN ORDER TO MEET UNFORESEEN FIELD CONDITIONS ARE ALLOWED IF MODIFICATIONS CONFORM TO BMP'S. ALL MODIFICATIONS MUST BE APPROVED BY OWNER/ENGINEER/GOVERNING AGENCY PRIOR TO DEVIATION OF THE APPROVED PLAN.

4. INSTALL PERIMETER EROSION CONTROL MEASURES (SUCH AS CONSTRUCTION ENTRANCES, SILT FENCE AND EXISTING INLET PROTECTION) PRIOR TO ANY SITE WORK, INCLUDING GRADING OR DISTURBANCE OF EXISTING SURFACE COVER, AS SHOWN ON PLAN IN ORDER TO PROTECT ADJACENT PROPERTIES/STORM SEWER SYSTEMS

CONSTRUCTION ENTRANCES SHALL BE INSTALLED AT ALL LOCATIONS OF VEHICLE INGRESS/EGRESS POINTS. CONTRACTOR IS RESPONSIBLE TO COORDINATE LOCATION(S) WITH THE PROPER AUTHORITIES, PROVIDE NECESSARY FEES AND OBTAIN ALL REQUIRED APPROVALS OR PERMITS. ADDITIONAL CONSTRUCTION ENTRANCES OTHER THAN AS SHOWN ON THE PLANS MUST BE APPROVED BY THE APPLICABLE GOVERNING AGENCIES PRIOR TO INSTALLATION.

6. PAVED SURFACES ADJACENT TO CONSTRUCTION ENTRANCES SHALL BE SWEPT AND/OR SCRAPED TO REMOVE ACCUMULATED SOIL, DIRT AND/OR DUST IMMEDIATELY AND AS REQUESTED BY THE GOVERNING AGENCIES.

ALL EXISTING STORM SEWER FACILITIES THAT WILL COLLECT RUNOFF FROM DISTURBED AREAS SHALL BE PROTECTED TO TO PREVENT SEDIMENT DEPOSITION WITHIN STORM SEWER SYSTEMS. INLET PROTECTION SHALL BE IMMEDIATELY FITTED AT THE INLET OF ALL INSTALLED STORM SEWER AND SILT FENCE SHALL BE IMMEDIATELY FITTED AT ALL INSTALLED CULVERT INLETS . ALL INLETS, STRUCTURES, PIPES, AND SWALES SHALL BE KEPT CLEAN AND FREE OF SEDIMENTATION AND DEBRIS.

8. EROSION CONTROL FOR UTILITY CONSTRUCTION (STORM SEWER, WATER MAIN, ETC.) OUTSIDE OF THE PERIMETER CONTROLS SHALL INCORPORATE THE FOLLOWING:

PLACE EXCAVATED TRENCH MATERIAL ON THE HIGH SIDE OF THE TRENCH.

BACKFILL, COMPACT AND STABILIZE THE TRENCH IMMEDIATELY AFTER PIPE CONSTRUCTION.

DISCHARGE TRENCH WATER INTO A SEDIMENTATION BASIN OR FILTERING TANK IN ACCORDANCE WITH BMP'S PRIOR TO RELEASE INTO STORM SEWER OR DITCHES.

9. AT A MINIMUM, SEDIMENT BASINS AND NECESSARY TEMPORARY DRAINAGE PROVISIONS SHALL BE CONSTRUCTED AND OPERATIONAL BEFORE BEGINNING OF SIGNIFICANT MASS GRADING OPERATIONS TO PREVENT OFFSITE DISCHARGE OF UNTREATED RUNOFF.

10. IF APPLICABLE, ALL WATERCOURSES AND WETLANDS SHALL BE PROTECTED WITH DOUBLE ROW OF SILT FENCE TO PREVENT ANY DIRECT DISCHARGE FROM DISTURBED SOILS.

11. ALL TEMPORARY AND PERMANENT EROSION CONTROL MEASURES MUST BE MAINTAINED AND REPAIRED AS NEEDED. THE GENERAL CONTRACTOR WILL BE RESPONSIBLE FOR INSPECTION AND REPAIR DURING CONSTRUCTION. THE OWNER WILL BE RESPONSIBLE IF EROSION CONTROL IS REQUIRED AFTER THE CONTRACTOR HAS COMPLETED THE

12. TOPSOIL STOCKPILES SHALL HAVE A BERM OR TRENCH AROUND THE CIRCUMFERENCE AND PERIMETER SILT FENCE TO CONTROL SILT. IF TOPSOIL STOCKPILE REMAINS UNDISTURBED FOR MORE THAN SEVEN (7) DAYS, TEMPORARY SEEDING AND STABILIZATION IS REQUIRED.

13. EROSION CONTROL MEASURES TEMPORARILY REMOVED FOR UNAVOIDABLE CONSTRUCTION ACTIVITIES SHALL BE IN WORKING ORDER IMMEDIATELY FOLLOWING COMPLETION OF SUCH ACTIVITIES OR PRIOR TO THE COMPLETION OF EACH WORK DAY, WHICH EVER OCCURS FIRST.

14. MAINTAIN SOIL EROSION CONTROL DEVICES THROUGH THE DURATION OF THIS PROJECT, ALL TEMPORARY EROSION AND SEDIMENT CONTROL MEASURES SHALL BE REMOVED WITHIN THIRTY (30) DAYS AFTER FINAL SITE STABILIZATION IS ACHIEVED OR AFTER THE TEMPORARY MEASURES ARE NO LONGER NEEDED. DISTURBANCES ASSOCIATED WITH EROSION CONTROL REMOVAL SHALL BE IMMEDIATELY STABILIZED.

15. PUMPS MAY BE USED AS BYPASS DEVICES. IN NO CASE SHALL PUMPED WATER BE DIVERTED OUTSIDE THE PROJECT LIMITS, PUMP DISCHARGE SHALL BE DIRECTED INTO AN APPROVED FILTER BAG OR APPROVED SETTLING DEVICE.

16. GRADING EFFORTS SHALL BE CONDUCTED IN SUCH A MANNER AS TO MINIMIZE EROSION. EROSION AND SEDIMENT CONTROL MEASURES SHALL CONSIDER THE TIME OF YEAR, SITE CONDITIONS, AND THE USE OF TEMPORARY OR PERMANENT MEASURES, ALL DISTURBED AREAS THAT WILL NOT BE WORKED, FOR A PERIOD OF FOURTEEN (14) DAYS REQUIRE TEMPORARY SEEDING FOR EROSION CONTROL. SEEDING FOR EROSION CONTROL SHALL BE IN ACCORDANCE WITH TECHNICAL STANDARDS.

17. ALL DISTURBED SLOPES EXCEEDING 4:1, SHALL BE STABILIZED WITH NORTH AMERICAN GREEN S75BN EROSION MATTING (OR APPROVED EQUAL) AND ALL CHANNELS SHALL BE STABILIZED WITH NORTH AMERICAN GREEN C125BN (OR APPROVED EQUAL) OR APPLICATION OF AN APPROVED POLYMER SOIL STABILIZATION TREATMENT OR A COMBINATION THEREOF, AS REQUIRED. EROSION MATTING AND/OR NETTING USED ONSITE SHALL BE INSTALLED IN ACCORDANCE WITH MANUFACTURER'S GUIDELINES.

18. DURING PERIODS OF EXTENDED DRY WEATHER, THE CONTRACTOR SHALL KEEP A WATER TRUCK ON SITE FOR THE PURPOSE OF WATERING DOWN SOILS WHICH MAY OTHERWISE BECOME AIRBORNE.THE CONTRACTOR IS RESPONSIBLE FOR CONTROLLING WIND EROSION (DUST) DURING CONSTRUCTION AT HIS/HER EXPENSE.

19. DISTURBED AREAS AND AREAS USED FOR STORAGE OF MATERIALS THAT ARE EXPOSED TO PRECIPITATION SHALL BE VISUALLY INSPECTED FOR EVIDENCE OF, OR THE POTENTIAL FOR, POLLUTANTS ENTERING THE DRAINAGE SYSTEM

20. QUALIFIED PERSONNEL (PROVIDED BY THE GENERAL/PRIME CONTRACTOR) SHALL INSPECT DISTURBED AREAS OF THE CONSTRUCTION SITE THAT HAVE NOT BEEN FINALLY STABILIZED AND EROSION AND SEDIMENT CONTROLS WITHIN 24 HOURS OF ALL 0.5-INCH, OR MORE, PRECIPITATION EVENTS WITH A MINIMUM INSPECTION INTERVAL OF ONCE EVERY SEVEN (7) CALENDAR DAYS IN THE ABSENCE OF A QUALIFYING RAIN OR SNOWFALL EVENT. REPORTING SHALL BE IN ACCORDANCE WITH OF THE GENERAL PERMIT. CONTRACTOR SHALL IMMEDIATELY ARRANGE TO HAVE ANY DEFICIENT ITEMS REVEALED DURING INSPECTIONS REPAIRED/REPLACED.

21. SEE ADDITIONAL DETAILS AND NOTES ON SITE STABILIZATION AND CONSTRUCTION DETAILS.

PINNACLE ENGINEERING GROUP WISCONSIN OFFICE 20725 WATERTOWN RD BROOKFIELD, WI 53186 (262) 754-8888 CHICAGO I MILWAUKEE : NATIONWIDE PEG PROJECT #: 2989.00

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PLAN COMMISSION SET:

CONSTRUCTION SET:

RECORD DRAWING SET:

SUBMITTAL FOR PERMIT SET:

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FISHER BARTON GROUP (ACCURATE SPECIALTIES INC.)

PROJECT DESCRIPTION

CITY/ STATE / ZIP Waukesha, WI 53188

570 Bluemound Road

ALL WORK TO BE COMPLETED AS SHOWN, AND IN ACCORDANCE WITH THE LATEST EDITION OF THE MSI GENERAL MASTER SPECIFICATION

SPIRE DJB **ENGINEERING** CIVIL ENGINEER: REVIEWED BY MTS MTS TNK

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SHEET TITLE:

GENERAL NOTES

SHEET NUMBER

PROJECT NUMBER



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Waukesha, WI 53188

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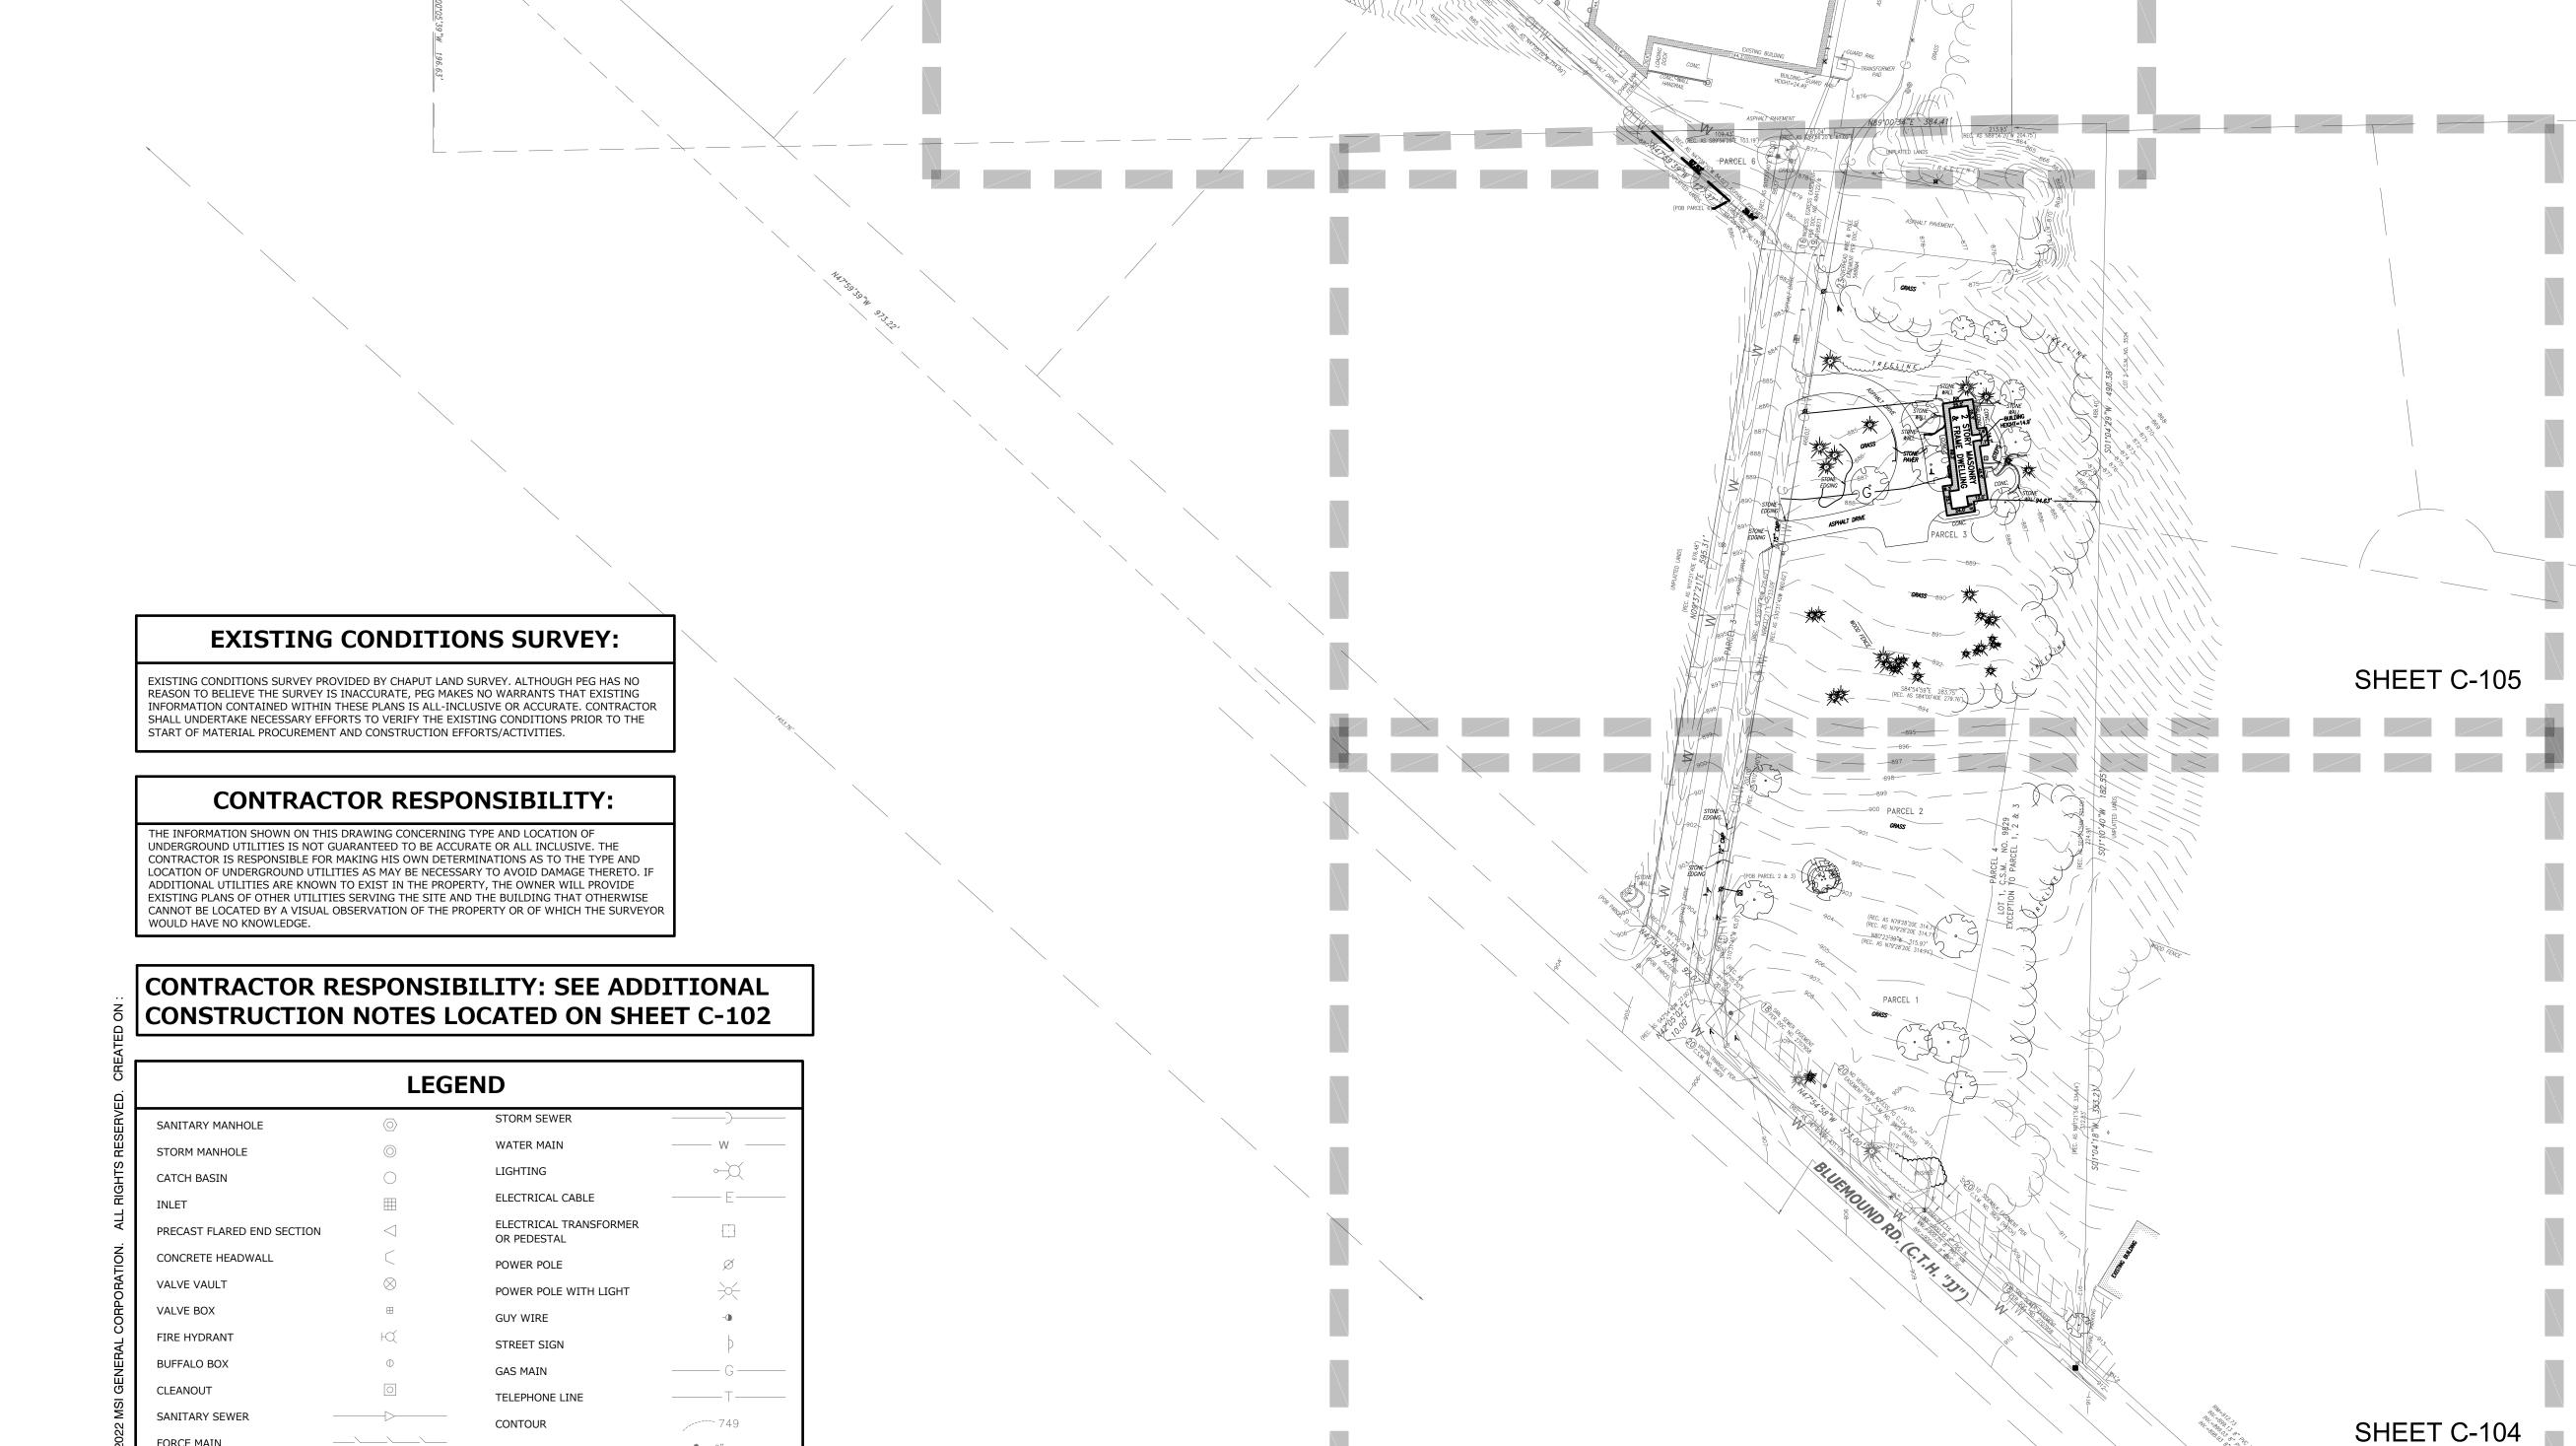
> SPIRE DJB **ENGINEERING**

MTS

DEMOLITION PLAN

C-103

GRAPHICAL SCALE (FEET)



FORCE MAIN

CONCRETE SIDEWALK

TREE WITH TRUNK SIZE

EASEMENT LINE

SHEET C-106

PINNACLE ENGINEERING GROUP WISCONSIN OFFICE: 20725 WATERTOWN RD BROOKFIELD, WI 53186

CHICAGO I MILWAUKEE : NATIONWIDE PEG PROJECT #: 2989.00



STREET ADDRESS

570 Bluemound Road

MTS TNK

SHEET TITLE:

EXISTING CONDITIONS & OVERVIEW

SHEET NUMBER:

PROJECT NUMBER:

LEADERS

ENGINEERS

BUDGET SET: PROPOSAL SET: PLAN COMMISSION SET: SUBMITTAL FOR PERMIT SET: CONSTRUCTION SET:

REVISIONS:

RECORD DRAWING SET:

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(262) 754-8888 CHICAGO I MILWAUKEE : NATIONWIDE PEG PROJECT #: 2989.00



Accurate Specialties

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STREET ADDRESS

Waukesha, WI 53188

570 Bluemound Road CITY/ STATE / ZIP

PROJECT DESCRIPTION

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THE MSI GENERAL MASTER SPECIFICATION SPIRE DJB

ENGINEERING MTS MTS TNK

SHEET TITLE:

EXISTING CONDITIONS & DEMOLITION PLAN

ARCHITECT


SHEET NUMBER:

C-104

PROJECT NUMBER:

GRAPHICAL SCALE (FEET)

P13417

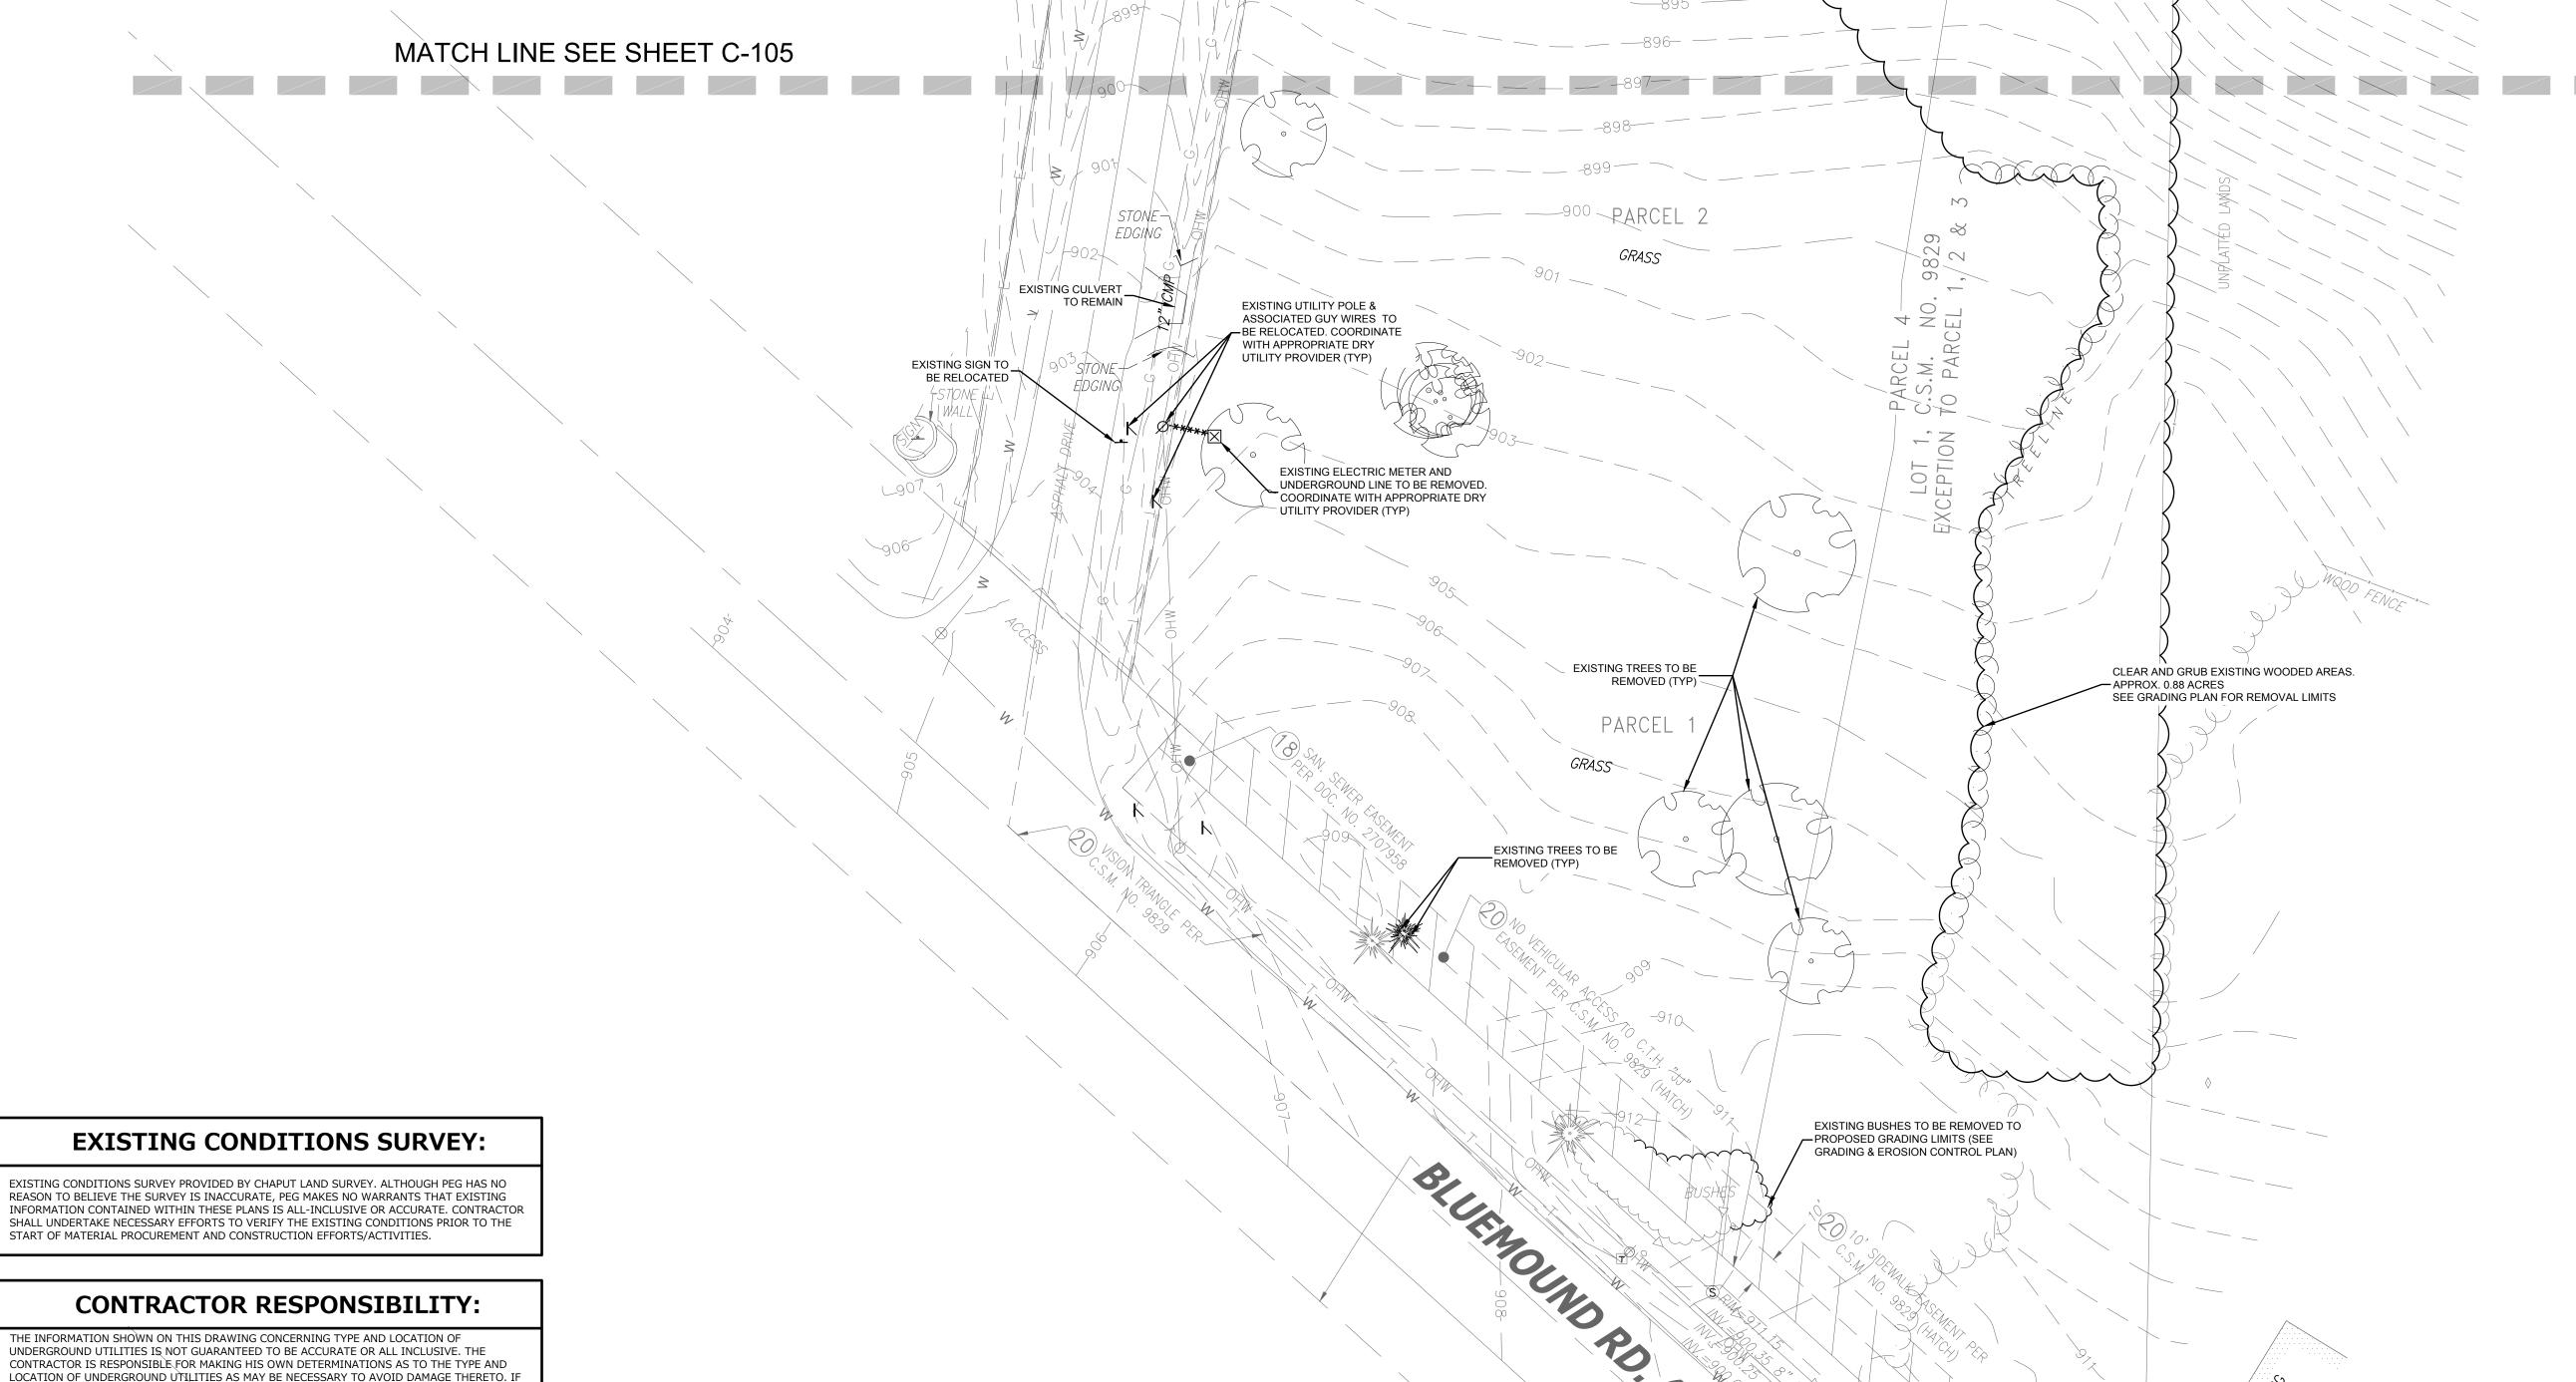

THE INFORMATION SHOWN ON THIS DRAWING CONCERNING TYPE AND LOCATION OF UNDERGROUND UTILITIES IS NOT GUARANTEED TO BE ACCURATE OR ALL INCLUSIVE. THE CONTRACTOR IS RESPONSIBLE FOR MAKING HIS OWN DETERMINATIONS AS TO THE TYPE AND LOCATION OF UNDERGROUND UTILITIES AS MAY BE NECESSARY TO AVOID DAMAGE THERETO. IF ADDITIONAL UTILITIES ARE KNOWN TO EXIST IN THE PROPERTY, THE OWNER WILL PROVIDE EXISTING PLANS OF OTHER UTILITIES SERVING THE SITE AND THE BUILDING THAT OTHERWISE CANNOT BE LOCATED BY A VISUAL OBSERVATION OF THE PROPERTY OR OF WHICH THE SURVEYOR WOULD HAVE NO KNOWLEDGE.

CONTRACTOR RESPONSIBILITY: SEE ADDITIONAL CONSTRUCTION NOTES LOCATED ON SHEET C-102

LEGEND							
SANITARY MANHOLE	$\langle \bigcirc \rangle$	STORM SEWER					
STORM MANHOLE		WATER MAIN	W				
CATCH BASIN	\bigcirc	LIGHTING	\rightarrow				
INLET		ELECTRICAL CABLE	E-				
PRECAST FLARED END SECTION	\triangleleft	ELECTRICAL TRANSFORMER OR PEDESTAL					
CONCRETE HEADWALL		POWER POLE	Ø				
VALVE VAULT	\otimes	POWER POLE WITH LIGHT	-				
VALVE BOX	⊞	GUY WIRE	-0				
FIRE HYDRANT	FQ	STREET SIGN	þ				
BUFFALO BOX	Ф	GAS MAIN	G -				
CLEANOUT	0	TELEPHONE LINE	T-				
SANITARY SEWER —	$\overline{}$	CONTOUR	749				
FORCE MAIN —		TREE WITH TRUNK SIZE	4 6"				
CONCRETE SIDEWALK		EASEMENT LINE	₹				

EXISTING TREES TO BE REMOVED (TYP)

EXISTING CONDITIONS SURVEY:

CONTRACTOR RESPONSIBILITY:

STORM SEWER

WATER MAIN

LIGHTING

EXISTING CONDITIONS SURVEY PROVIDED BY CHAPUT LAND SURVEY. ALTHOUGH PEG HAS NO REASON TO BELIEVE THE SURVEY IS INACCURATE, PEG MAKES NO WARRANTS THAT EXISTING INFORMATION CONTAINED WITHIN THESE PLANS IS ALL-INCLUSIVE OR ACCURATE. CONTRACTOR SHALL UNDERTAKE NECESSARY EFFORTS TO VERIFY THE EXISTING CONDITIONS PRIOR TO THE

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ENGINEERS

CONTRACTORS

ARCHITECT

CHICAGO I MILWAUKEE : NATIONWIDE

PEG PROJECT #: 2989.00

FISHER BARTON GROUP (ACCURATE SPECIALTIES INC.) PROJECT DESCRIPTION

STREET ADDRESS 570 Bluemound Road

CITY/ STATE / ZIP Waukesha, WI 53188

ALL WORK TO BE COMPLETED AS SHOWN, AND IN ACCORDANCE WITH THE LATEST EDITION OF THE MSI GENERAL MASTER SPECIFICATION

SPIRE DJB **ENGINEERING** MTS MTS TNK


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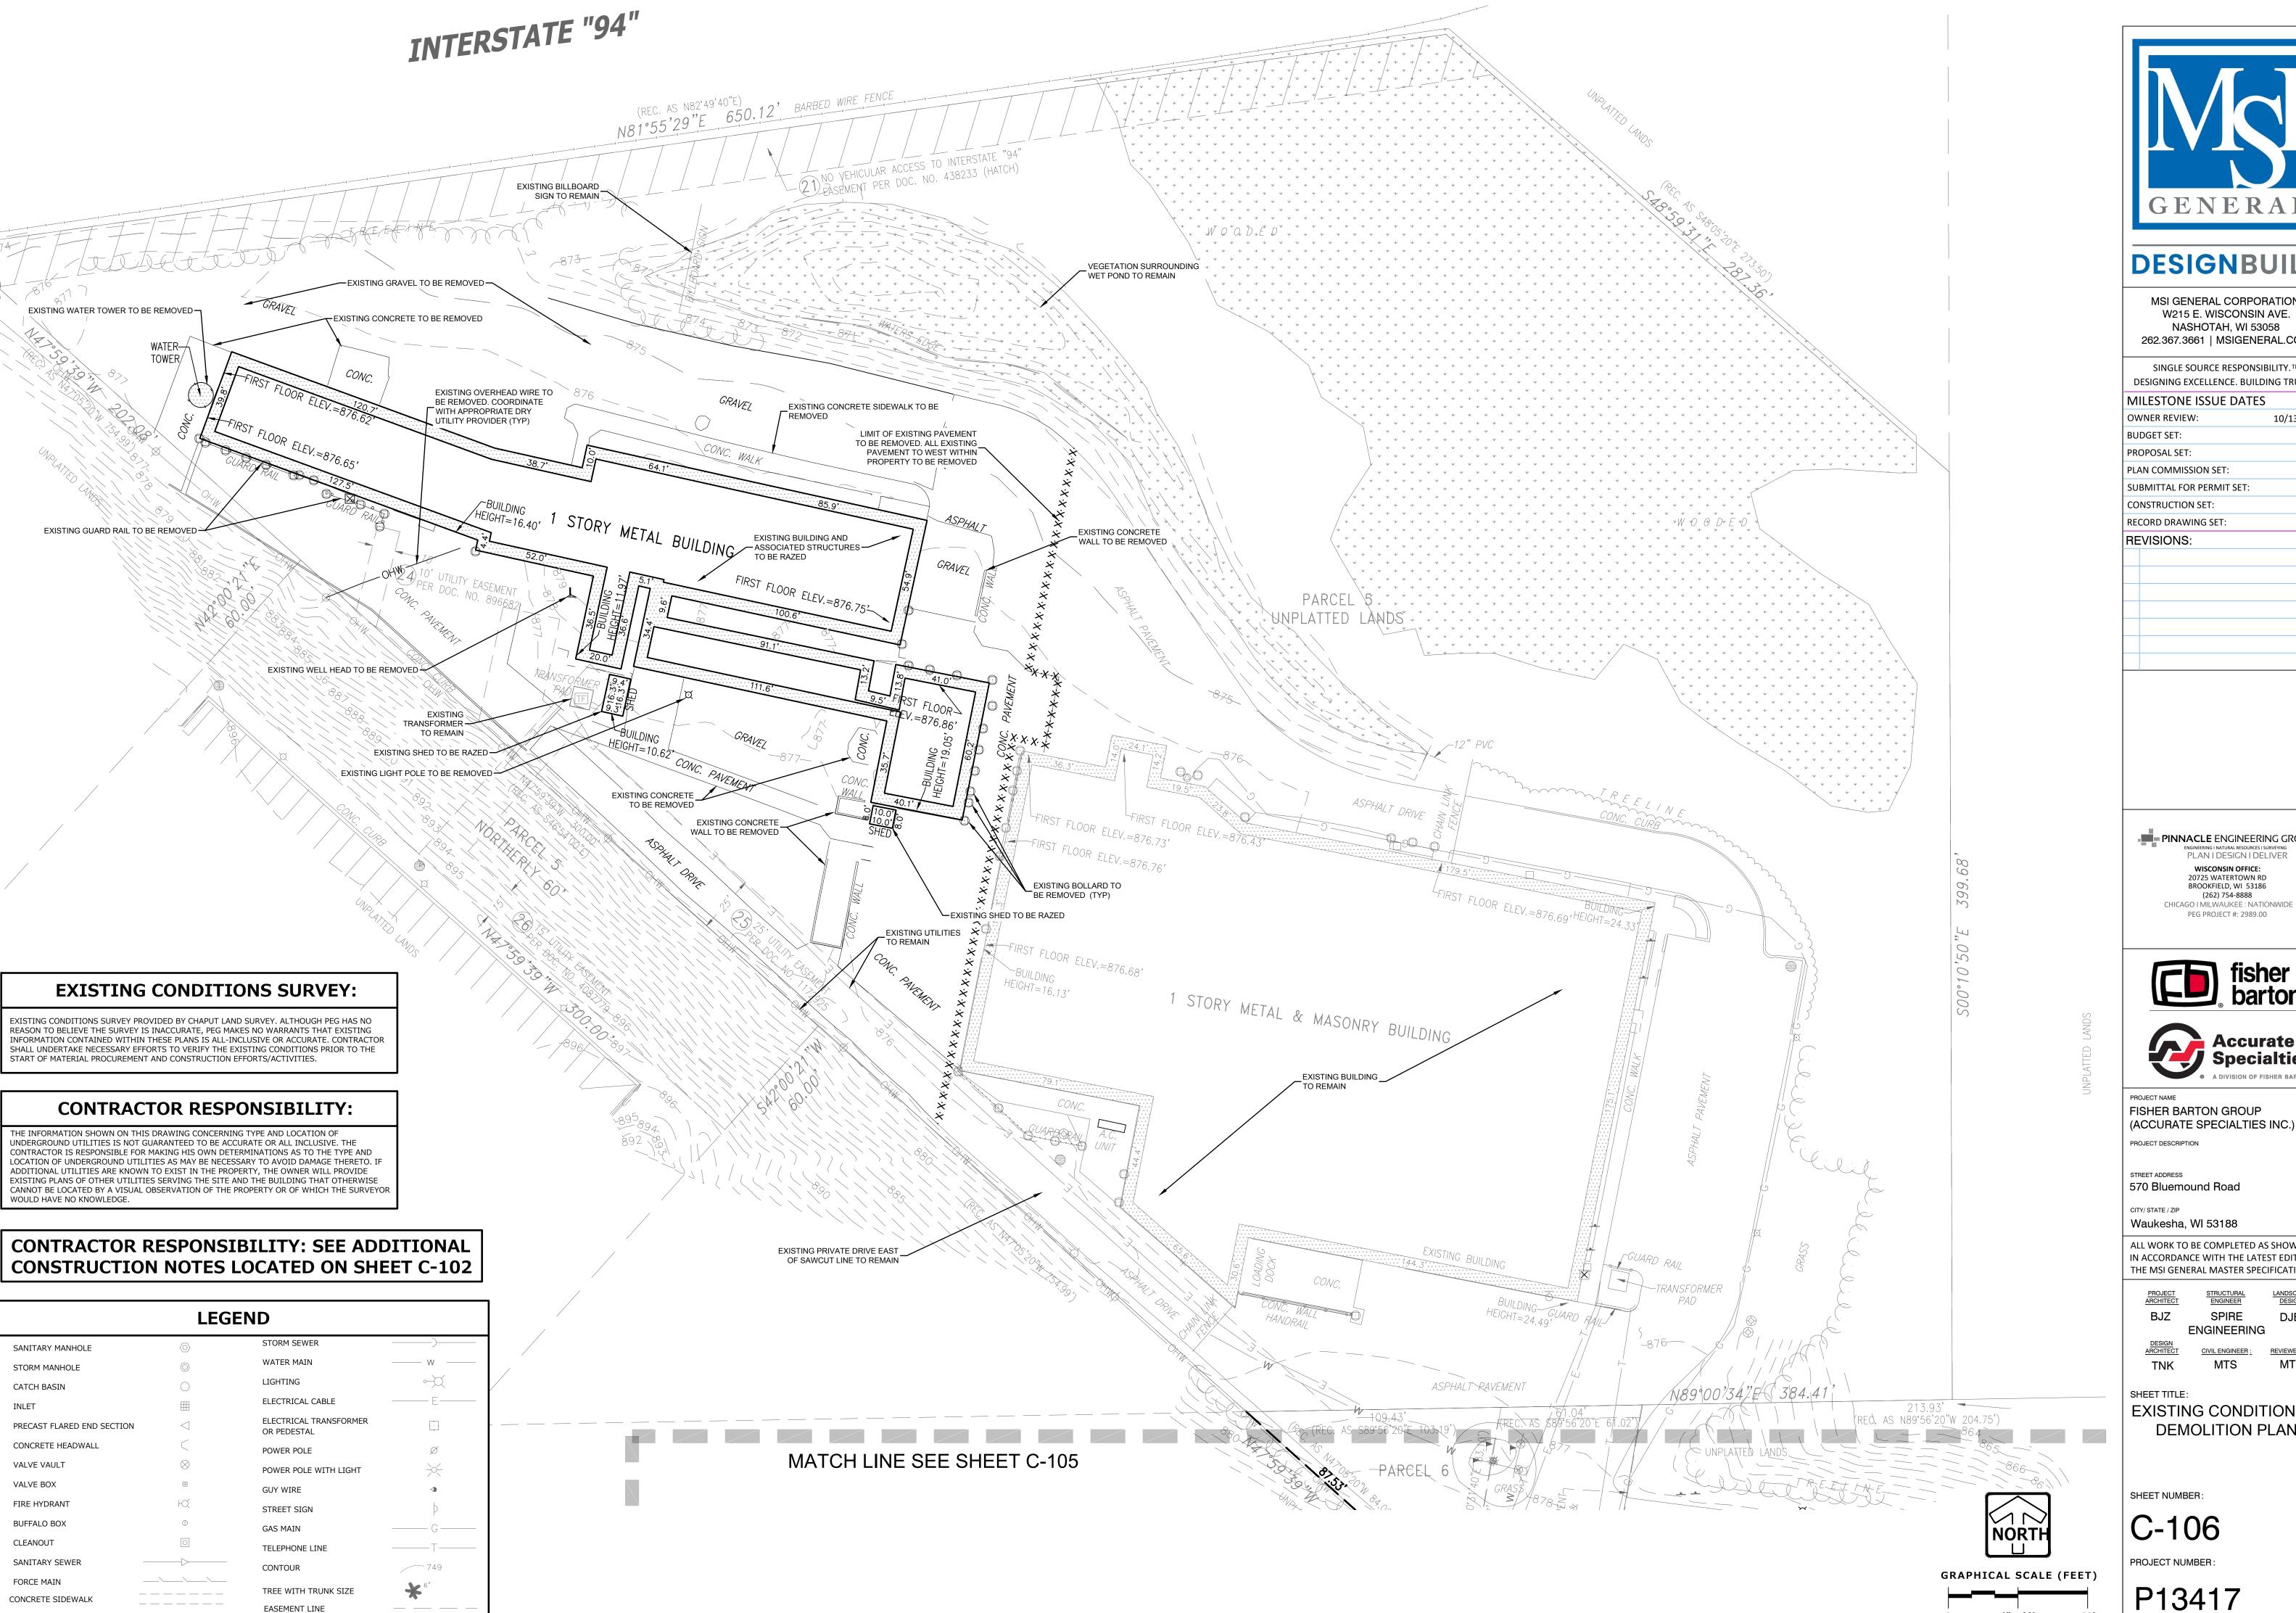
EXISTING CONDITIONS & DEMOLITION PLAN

SHEET NUMBER:

C-105

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Accurate Specialties FISHER BARTON GROUP

PROJECT DESCRIPTION

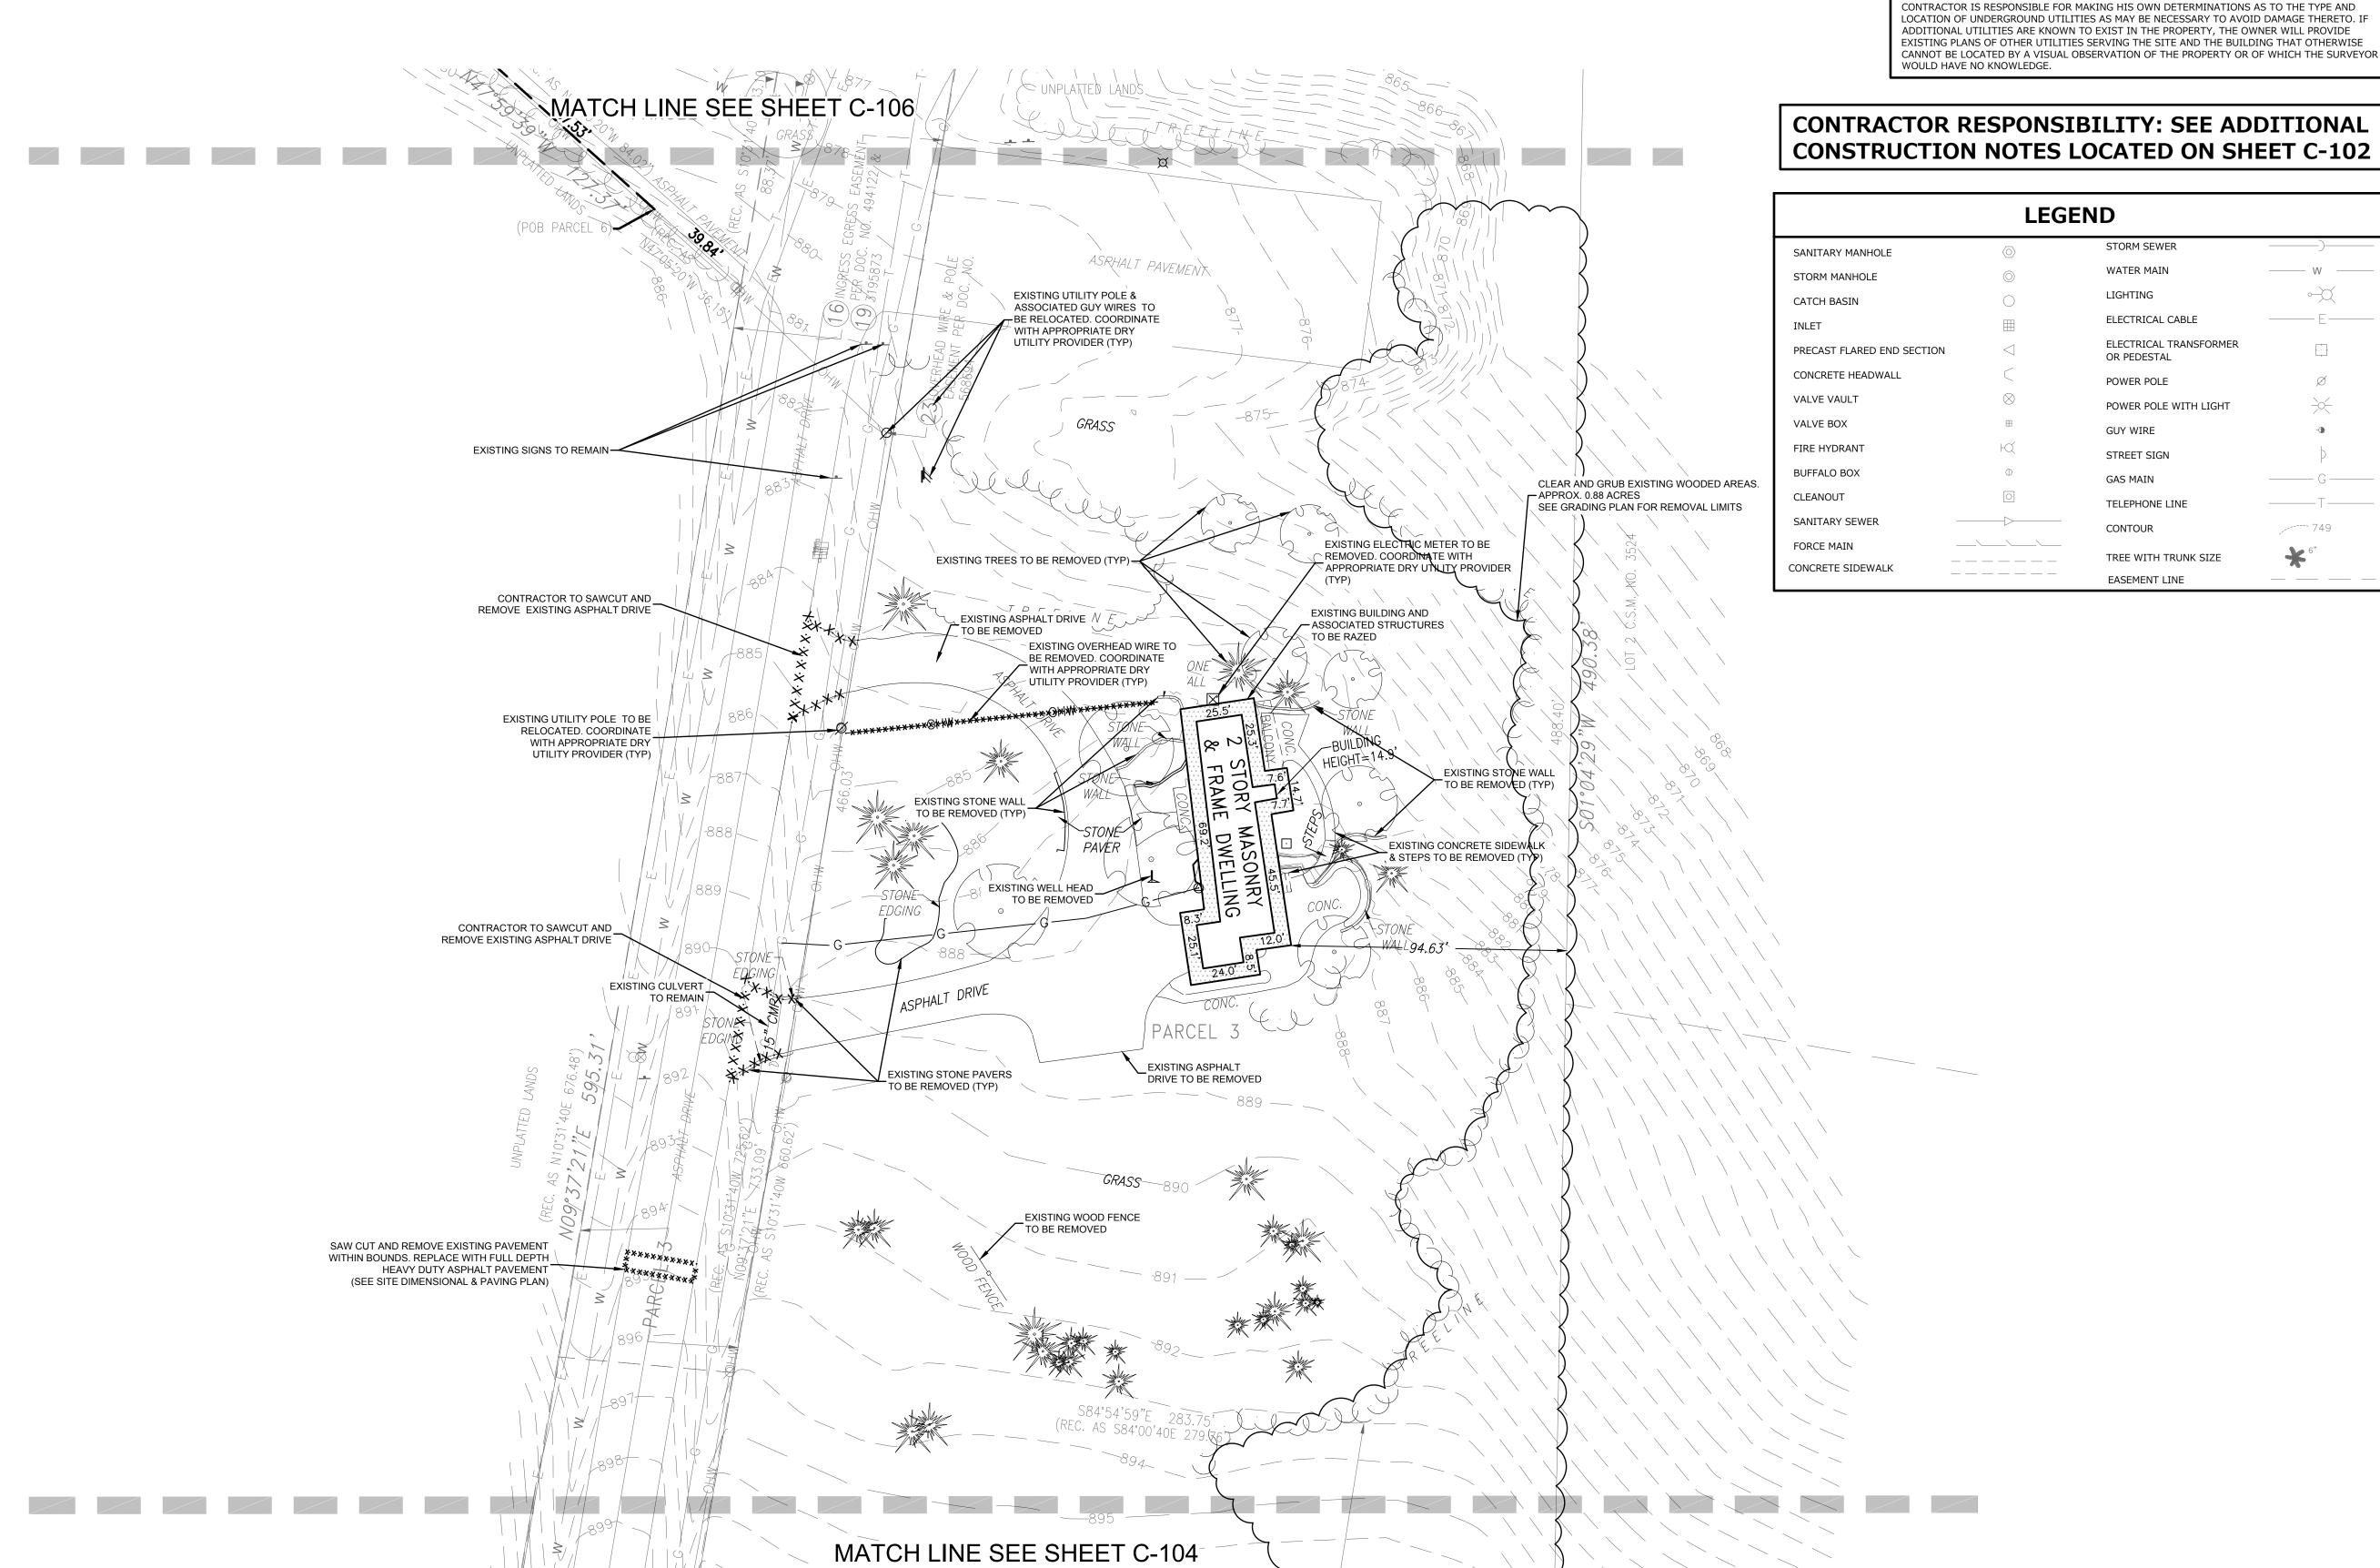570 Bluemound Road

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> SPIRE DJB **ENGINEERING** CIVIL ENGINEER:

MTS MTS

EXISTING CONDITIONS & DEMOLITION PLAN

SHEET NUMBER:

C-106

P13417

ARCHITECT

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ENGINEERS

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FISHER BARTON GROUP (ACCURATE SPECIALTIES INC.)

Waukesha, WI 53188

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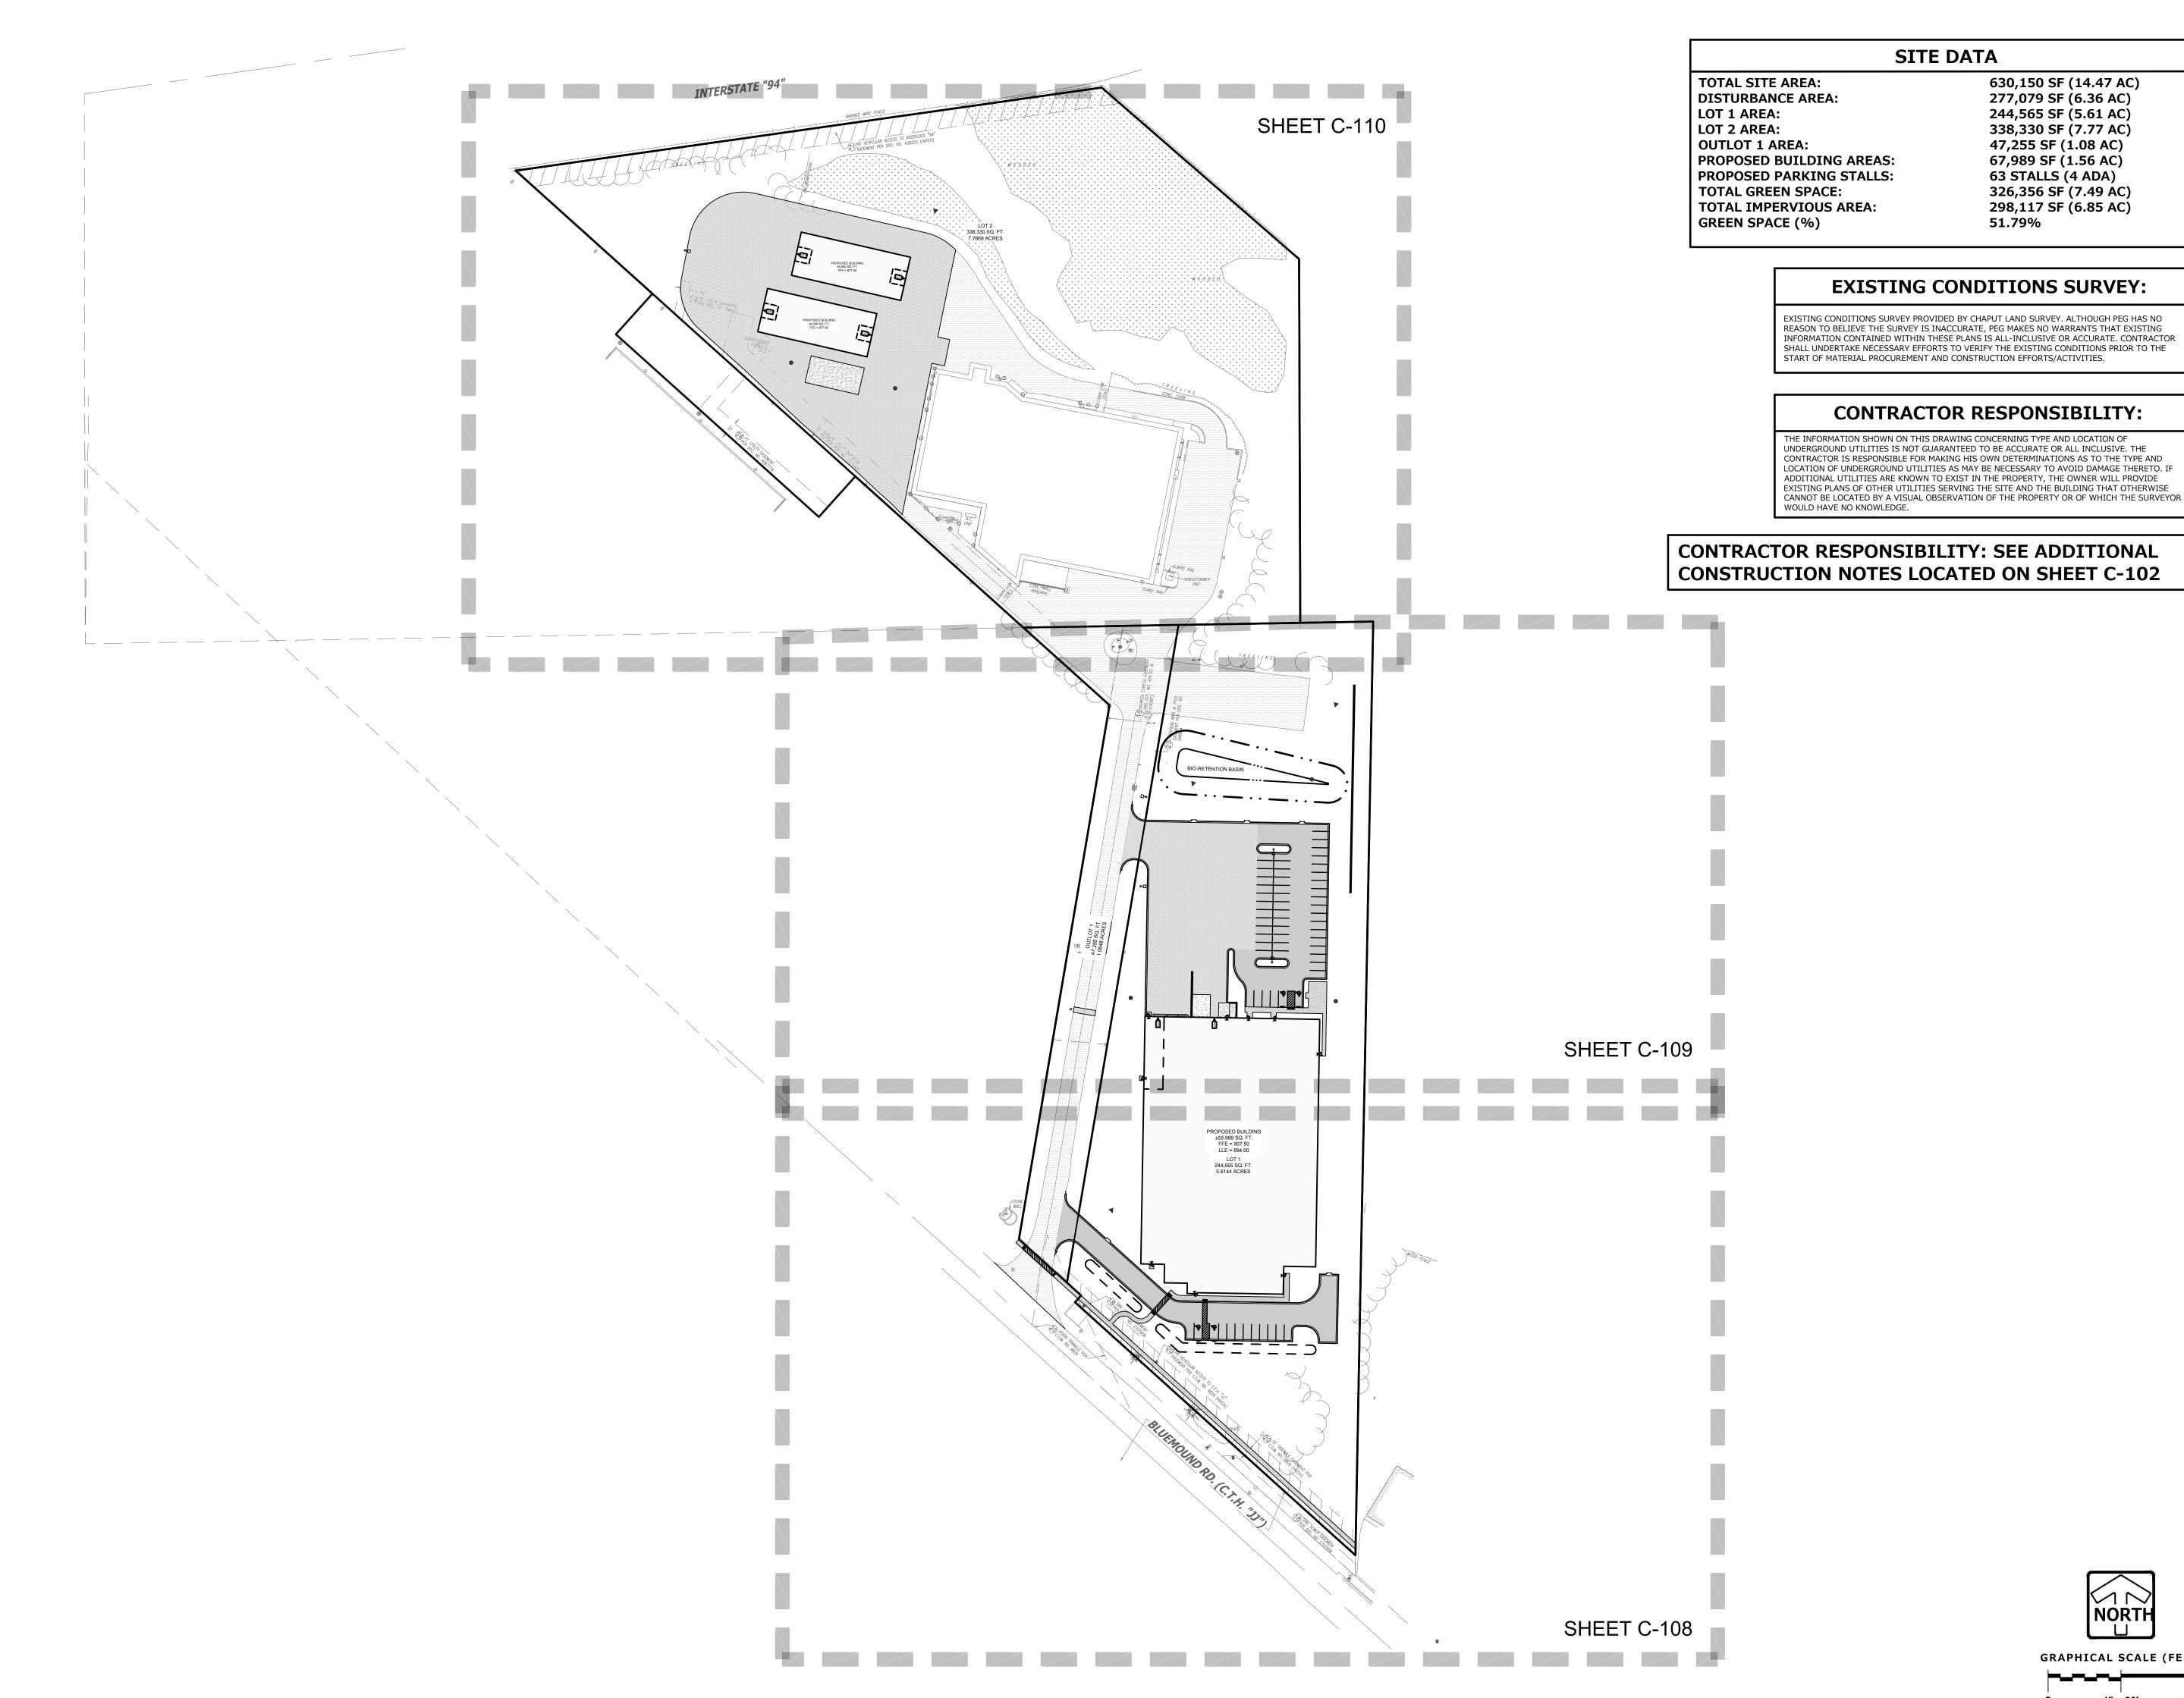
SPIRE ENGINEERING

CIVIL ENGINEER : MTS MTS

C-107

PROJECT NUMBER:

P13417



SITE DATA

630,150 SF (14.47 AC)

277,079 SF (6.36 AC) 244,565 SF (5.61 AC)

338,330 SF (7.77 AC) 47,255 SF (1.08 AC)

67,989 SF (1.56 AC)

63 STALLS (4 ADA) 326,356 SF (7.49 AC)

298,117 SF (6.85 AC)

51.79%

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STREET ADDRESS

570 Bluemound Road CITY/ STATE / ZIP

DJB

SHEET TITLE: SITE DIMENSIONAL & PAVING PLAN OVERVIEW ARCHITECT

SHEET NUMBER:

LEADERS

ENGINEERS

CONTRACTORS

ARCHITECT

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(COMPACTED; RECYCLED MATERIAL IS ACCEPTABLE WITH OWNER APPROVAL) - 4 ½" HMA PAVEMENT (2 LIFTS)
2 ½" BINDER COURSE (MT 58-28 S)
2" SURFACE COURSE (MT 58-28 S)

CONCRETE SIDEWALK

4" WHITE STRIPE

4" DIAGONAL AT 45° SPACED 2' O.C.

ADA PARKING STALL SIGNAGE WITH BOLLARD 18" CURB & GUTTER (SEE DETAIL) 18" REVERSE CURB & GUTTER (SEE DETAIL)

INTEGRAL CURB AND WALK

ADA COMPLIANT RAMP W/ TRUNCATED DOMES (SEE DETAIL). TAPER CURB HEAD AND DEPRESS WALK/CURB

PARKING COUNT (FOR INFORMATION ONLY, NOT TO BE PAINTED)

LIGHT DUTY ASPHALT PAVEMENT

LEGEND

EXISTING CONDITIONS SURVEY:

EXISTING CONDITIONS SURVEY PROVIDED BY CHAPUT LAND SURVEYS. ALTHOUGH PEG HAS NO

REASON TO BELIEVE THE SURVEY IS INACCURATE, PEG MAKES NO WARRANTS THAT EXISTING

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INFORMATION CONTAINED WITHIN THESE PLANS IS ALL-INCLUSIVE OR ACCURATE. CONTRACTOR SHALL UNDERTAKE NECESSARY EFFORTS TO VERIFY THE EXISTING CONDITIONS PRIOR TO THE

CONTRACTOR RESPONSIBILITY:

- 8" - 1 $\frac{1}{4}$ " CRUSHED AGGREGATE BASE COURSE (COMPACTED; RECYCLED MATERIAL IS ACCEPTABLE WITH OWNER APPROVAL)

WOULD HAVE NO KNOWLEDGE.

- 3 ½" HMA PAVEMENT (2 LIFTS) 2" ASPHALT BINDER COURSE - (LT 58-28 S) 1 ½" ASPHALT SURFACE COURSE - (LT 58-28 S) HEAVY DUTY ASPHALT PAVEMENT - 12" - 1 ½" CRUSHED AGGREGATE BASE COURSE

- MATCH EXISTING PAVEMENT SECTION, MINIMUM 2.5" OF ASPHALT

CONCRETE PAVEMENT - 8" CONCRETE SLAB WITH 6 x 6 - W2.9 x W2.9 W.W.M. - 6" MIN. - 1 ½" CRUSHED AGGREGATE BASE COURSE (COMPACTED; RECYCLED MATERIAL IS ACCEPTABLE WITH OWNER APPROVAL)

- 6" - 1 1/4" CRUSHED AGGREGATE BASE COURSE CONFORMING TO GRADATION REQUIREMENTS OF WISDOT STANDARD SPECIFICATIONS, SECTION 301 AND 305.

CURB AND GUTTER REVERSE PITCH CURB & GUTTER

ADA STALL INSIGNIA

TAPER CURB HEAD (SEE DETAIL)

DRIVE IN DOOR

PINNACLE ENGINEERING GROUP PLAN I DESIGN I DELIVER WISCONSIN OFFICE: 20725 WATERTOWN RD

BROOKFIELD, WI 53186 (262) 754-8888 CHICAGO I MILWAUKEE : NATIONWIDE PEG PROJECT #: 2989.00





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STREET ADDRESS 570 Bluemound Road

CITY/ STATE / ZIP Waukesha, WI 53188

ALL WORK TO BE COMPLETED AS SHOWN, AND IN ACCORDANCE WITH THE LATEST EDITION OF THE MSI GENERAL MASTER SPECIFICATION

> SPIRE DJB **ENGINEERING**

MTS MTS TNK

PAVING PLAN


SHEET TITLE: SITE DIMENSIONAL &

SHEET NUMBER:

C-107 PROJECT NUMBER:

P13417

GRAPHICAL SCALE (FEET) 1" = 30'

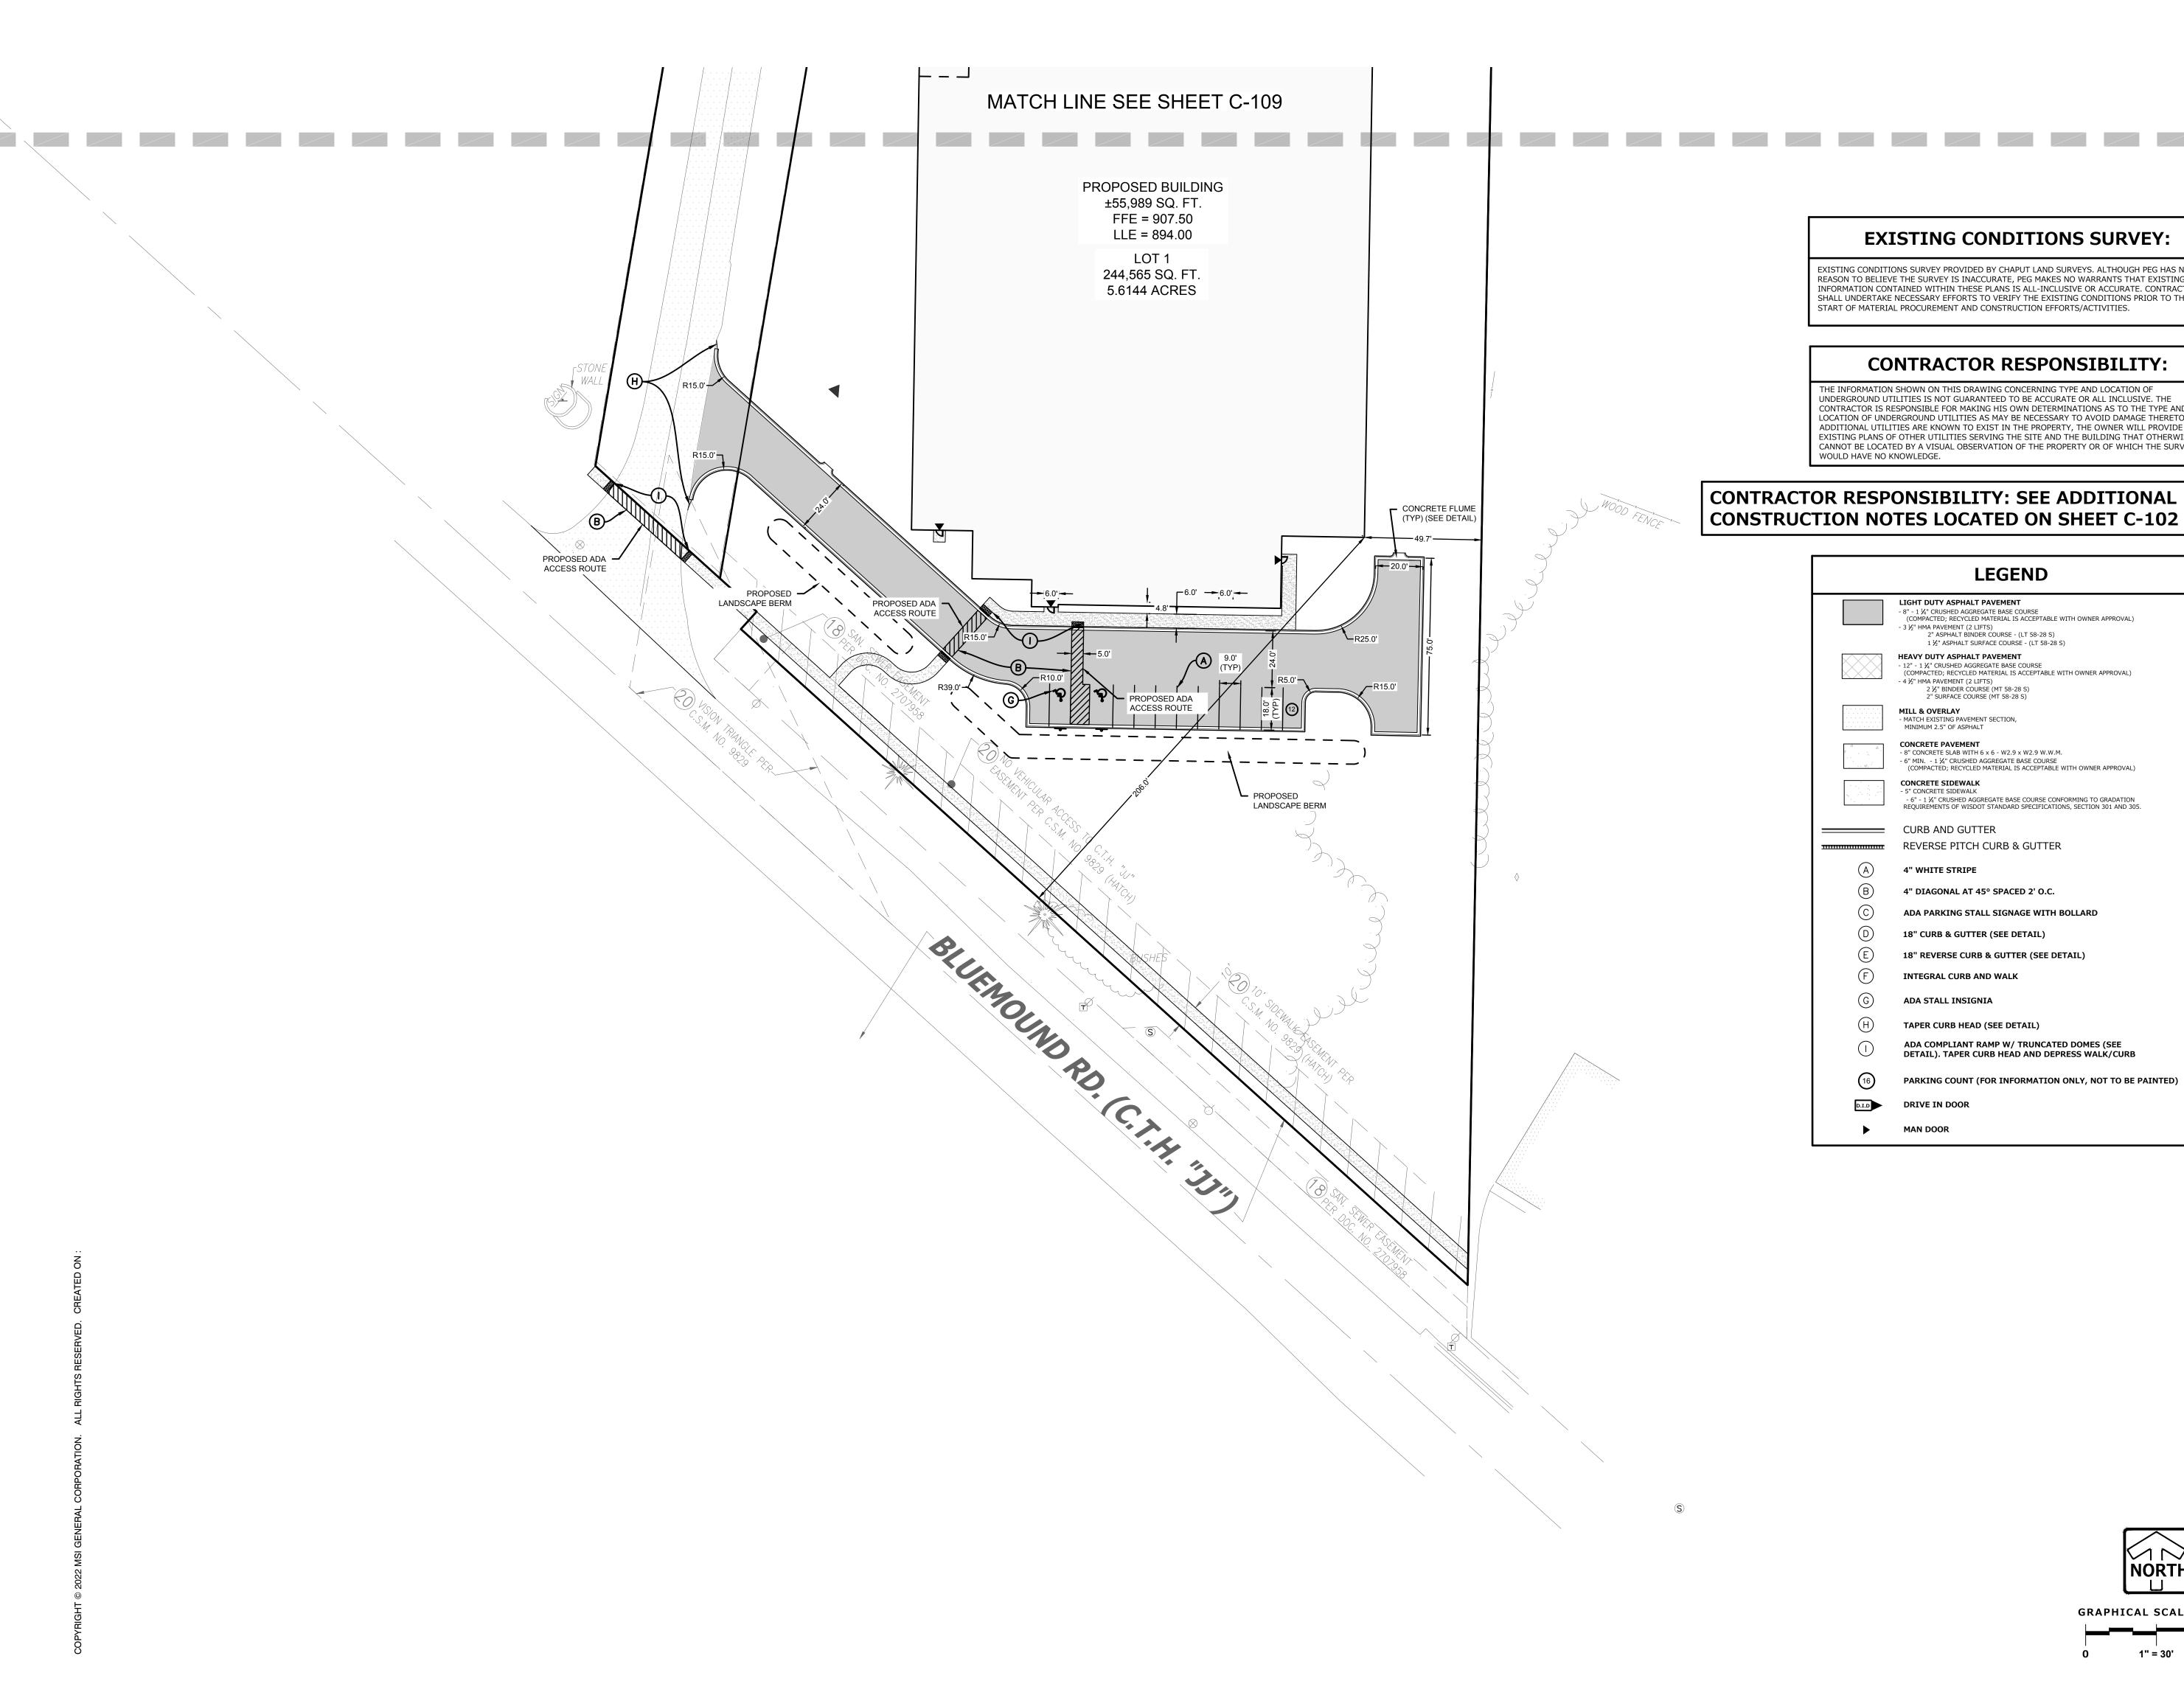

10/13/2022

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ARCHITECT

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CHICAGO I MILWAUKEE : NATIONWIDE

PEG PROJECT #: 2989.00

SPIRE DJB **ENGINEERING** MTS MTS TNK

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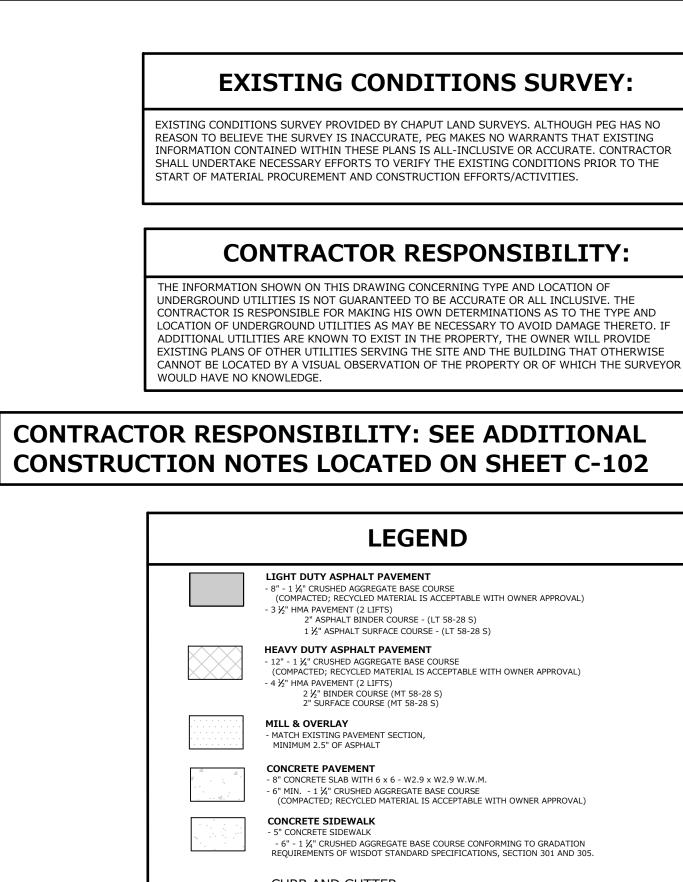
SITE DIMENSIONAL & PAVING PLAN


SHEET NUMBER:


C-109


PROJECT NUMBER:


P13417



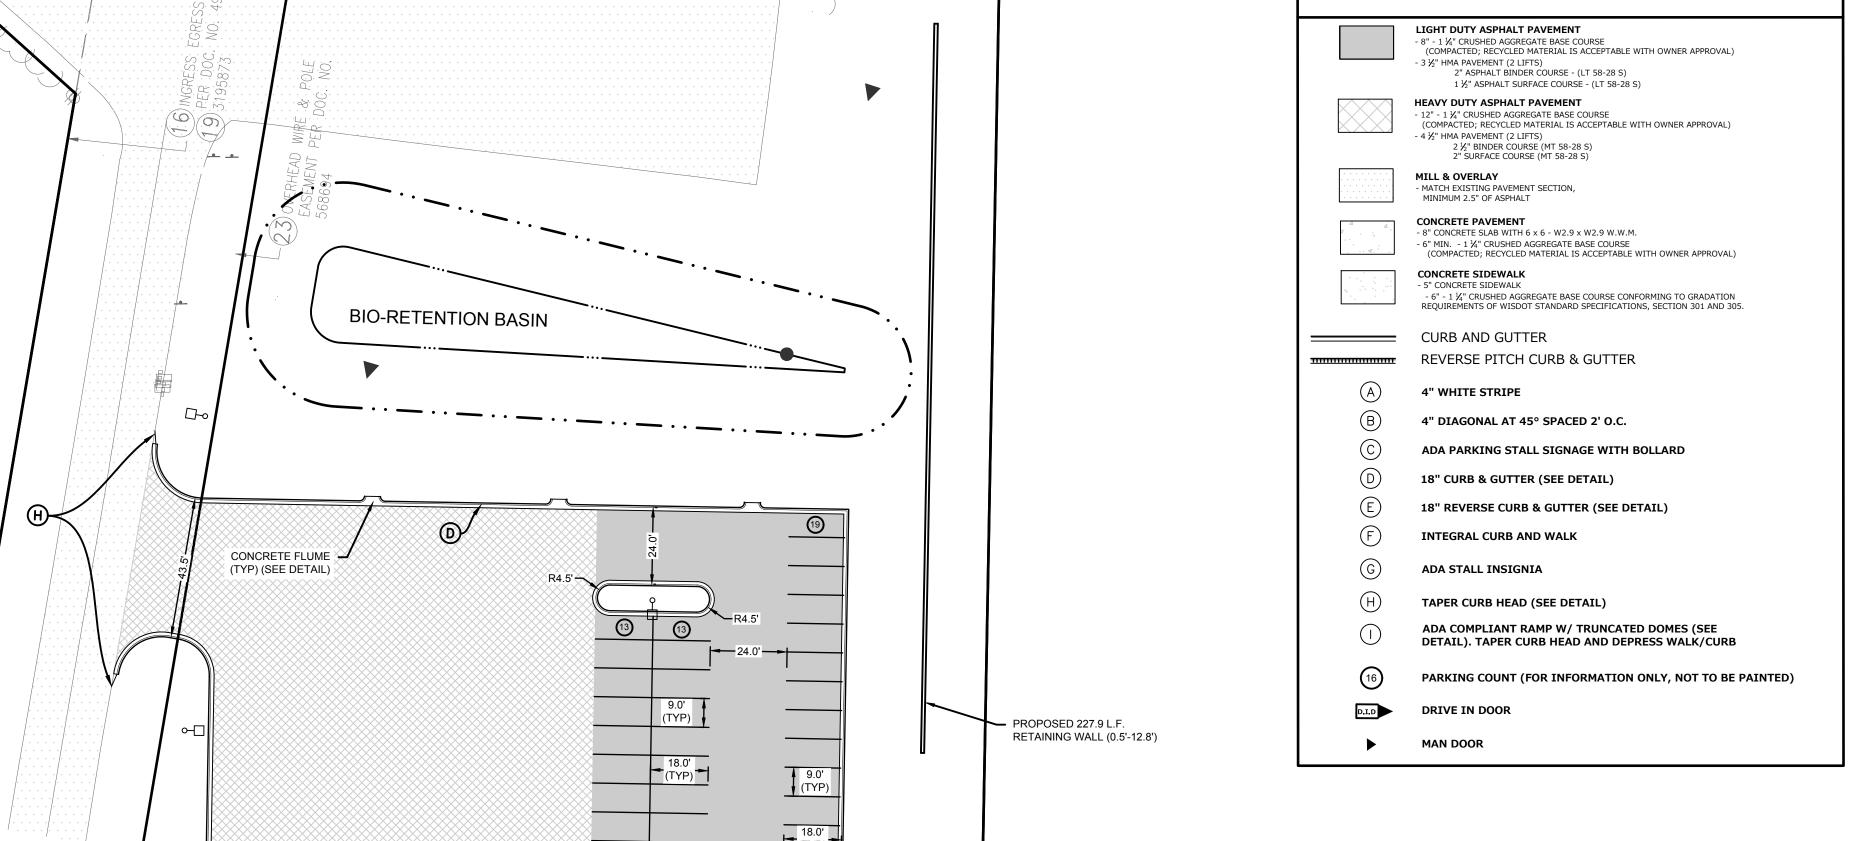

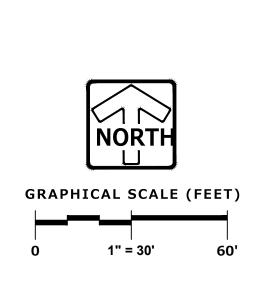


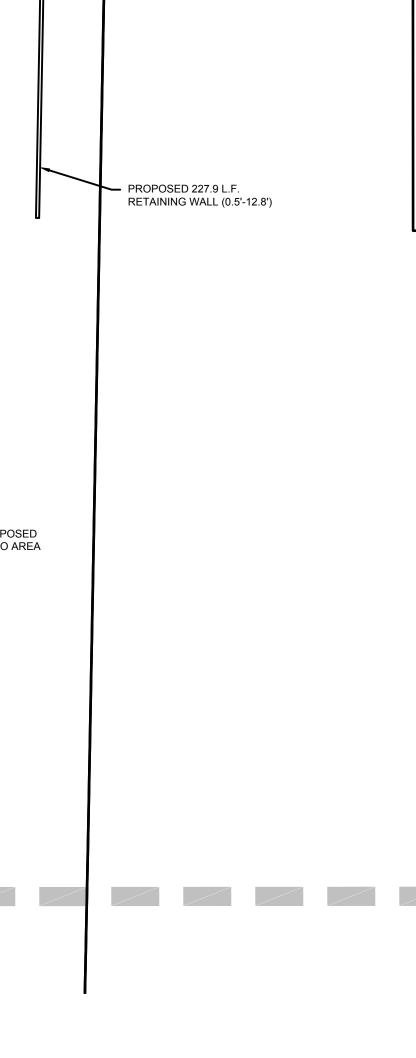

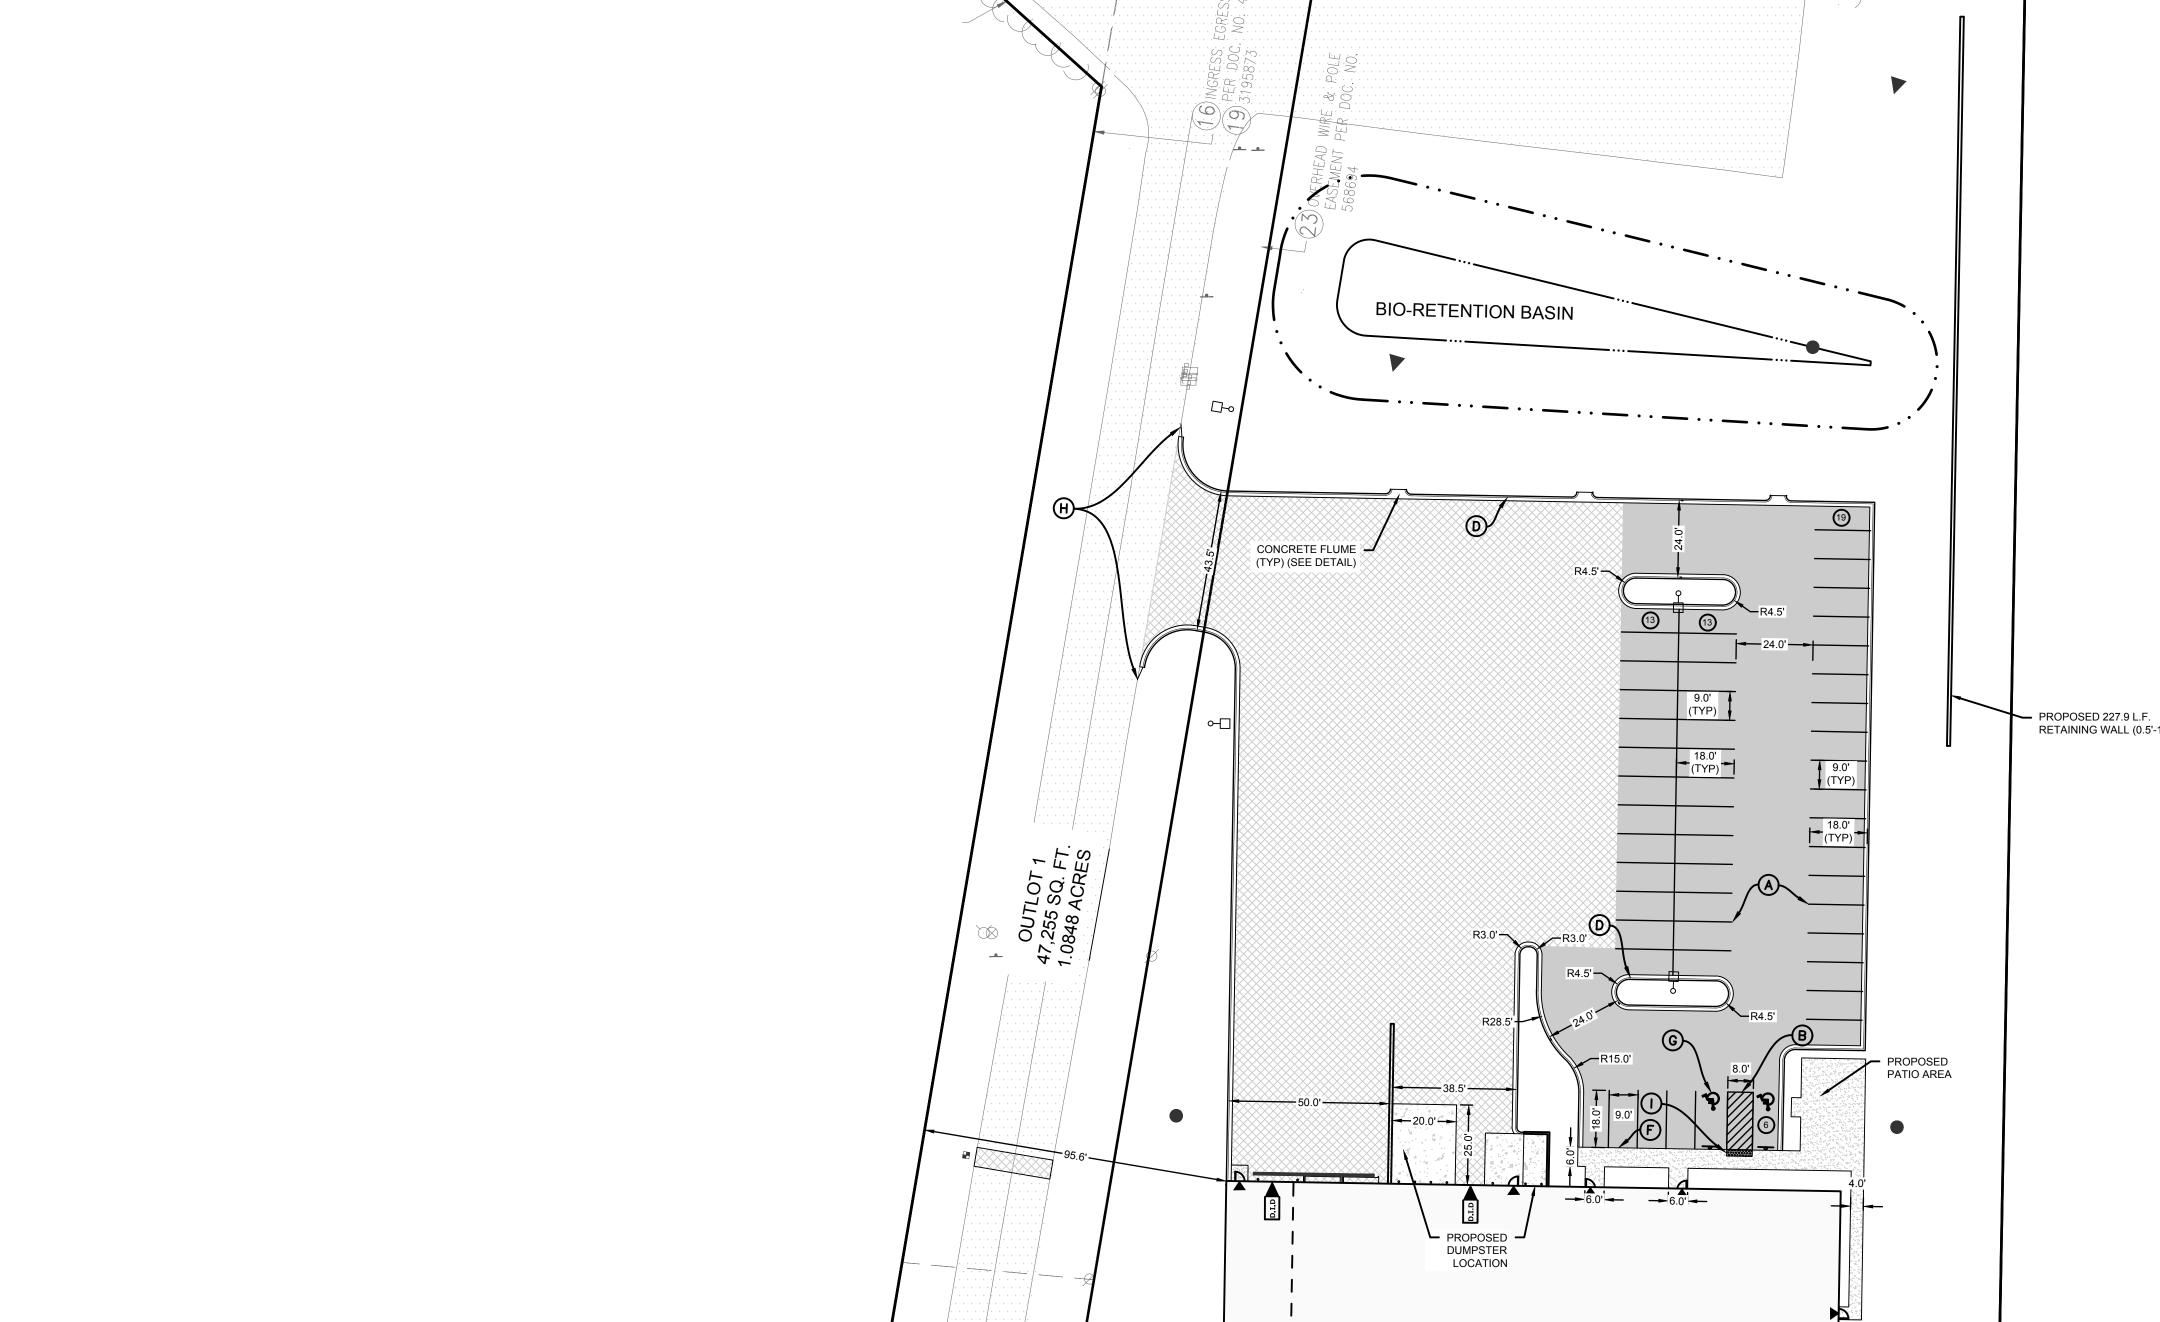

MATCH LINE SEE SHEET C-108

MATCH LINE SEE SHEET C-110

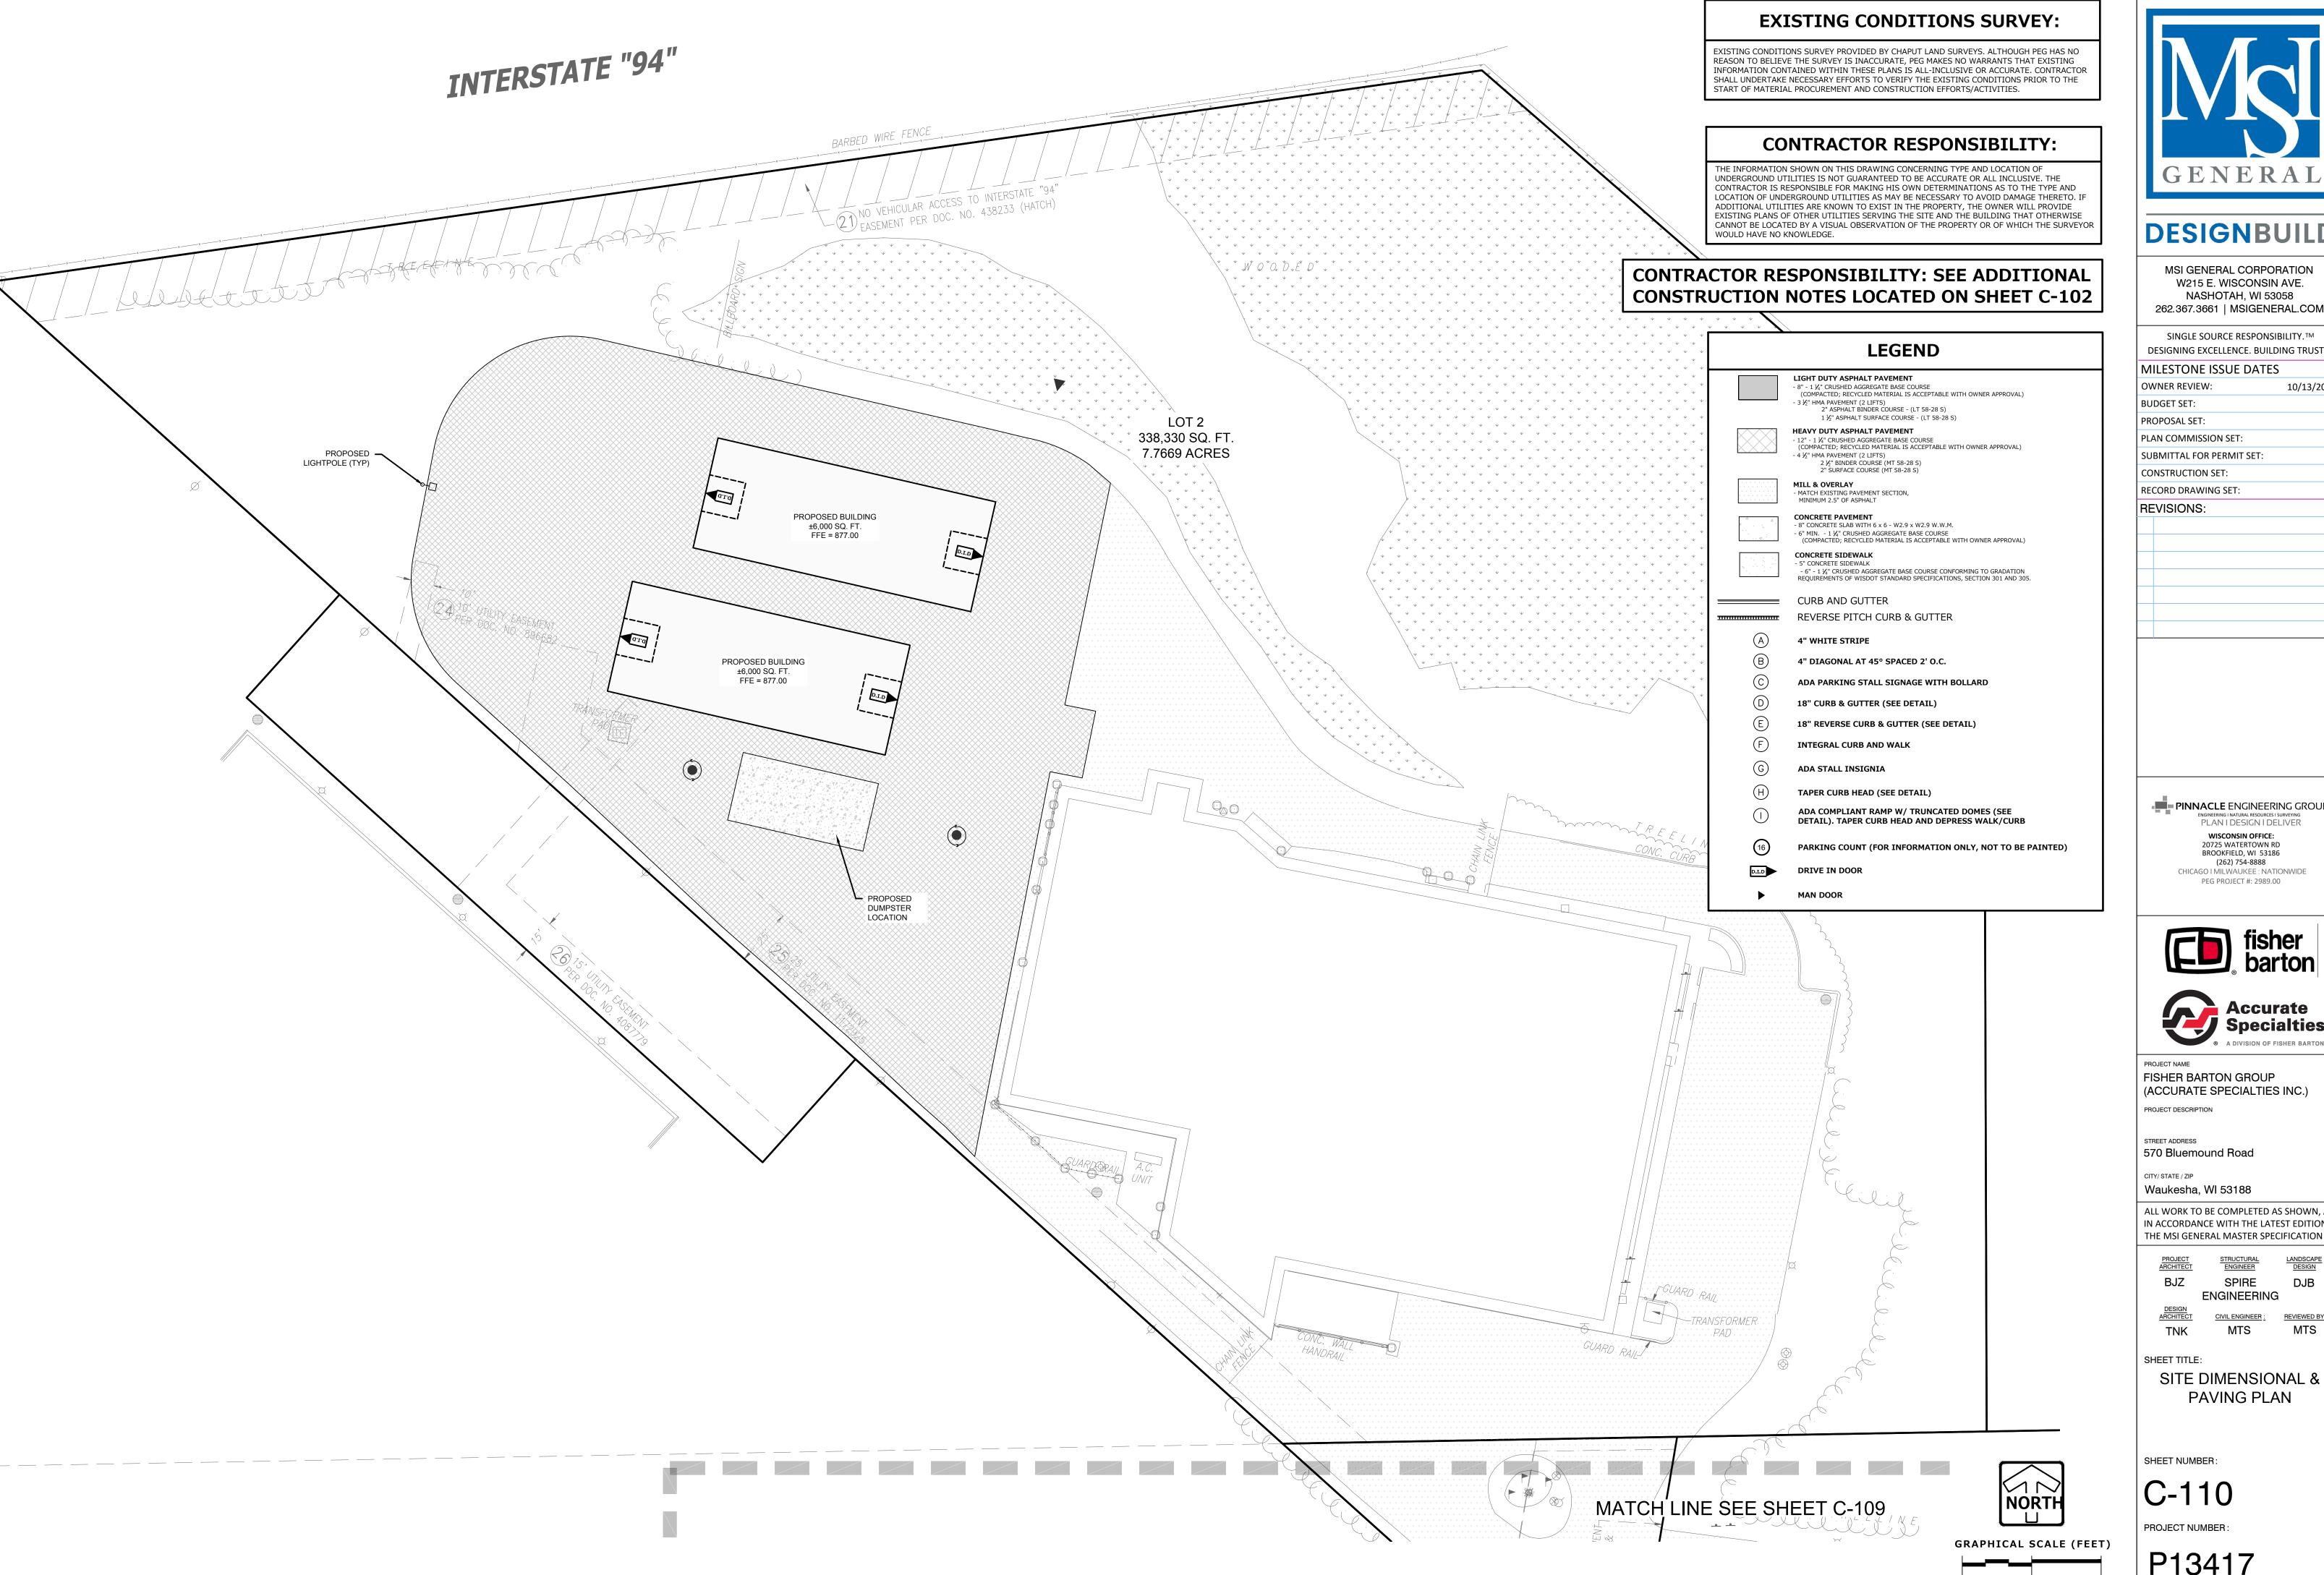



LEADERS

ENGINEERS

MSI GENERAL CORPORATION W215 E. WISCONSIN AVE. NASHOTAH, WI 53058 262.367.3661 | MSIGENERAL.COM

SINGLE SOURCE RESPONSIBILITY.™ DESIGNING EXCELLENCE. BUILDING TRUST.™ MILESTONE ISSUE DATES 10/13/2022

SUBMITTAL FOR PERMIT SET:







FISHER BARTON GROUP (ACCURATE SPECIALTIES INC.)

570 Bluemound Road

Waukesha, WI 53188

ALL WORK TO BE COMPLETED AS SHOWN, AND IN ACCORDANCE WITH THE LATEST EDITION OF THE MSI GENERAL MASTER SPECIFICATION

> SPIRE DJB **ENGINEERING**

ARCHITECT

MTS MTS

PAVING PLAN

CONTRACTORS

ARCHITECT

PROJECT DESCRIPTION

CIVIL ENGINEER: REVIEWED BY MTS MTS

SHEET TITLE:

GRADING & EROSION CONTROL PLAN OVERVIEW


SHEET NUMBER:

GRAPHICAL SCALE (FEET)

1" = 80'

C-111

PROJECT NUMBER: P13417

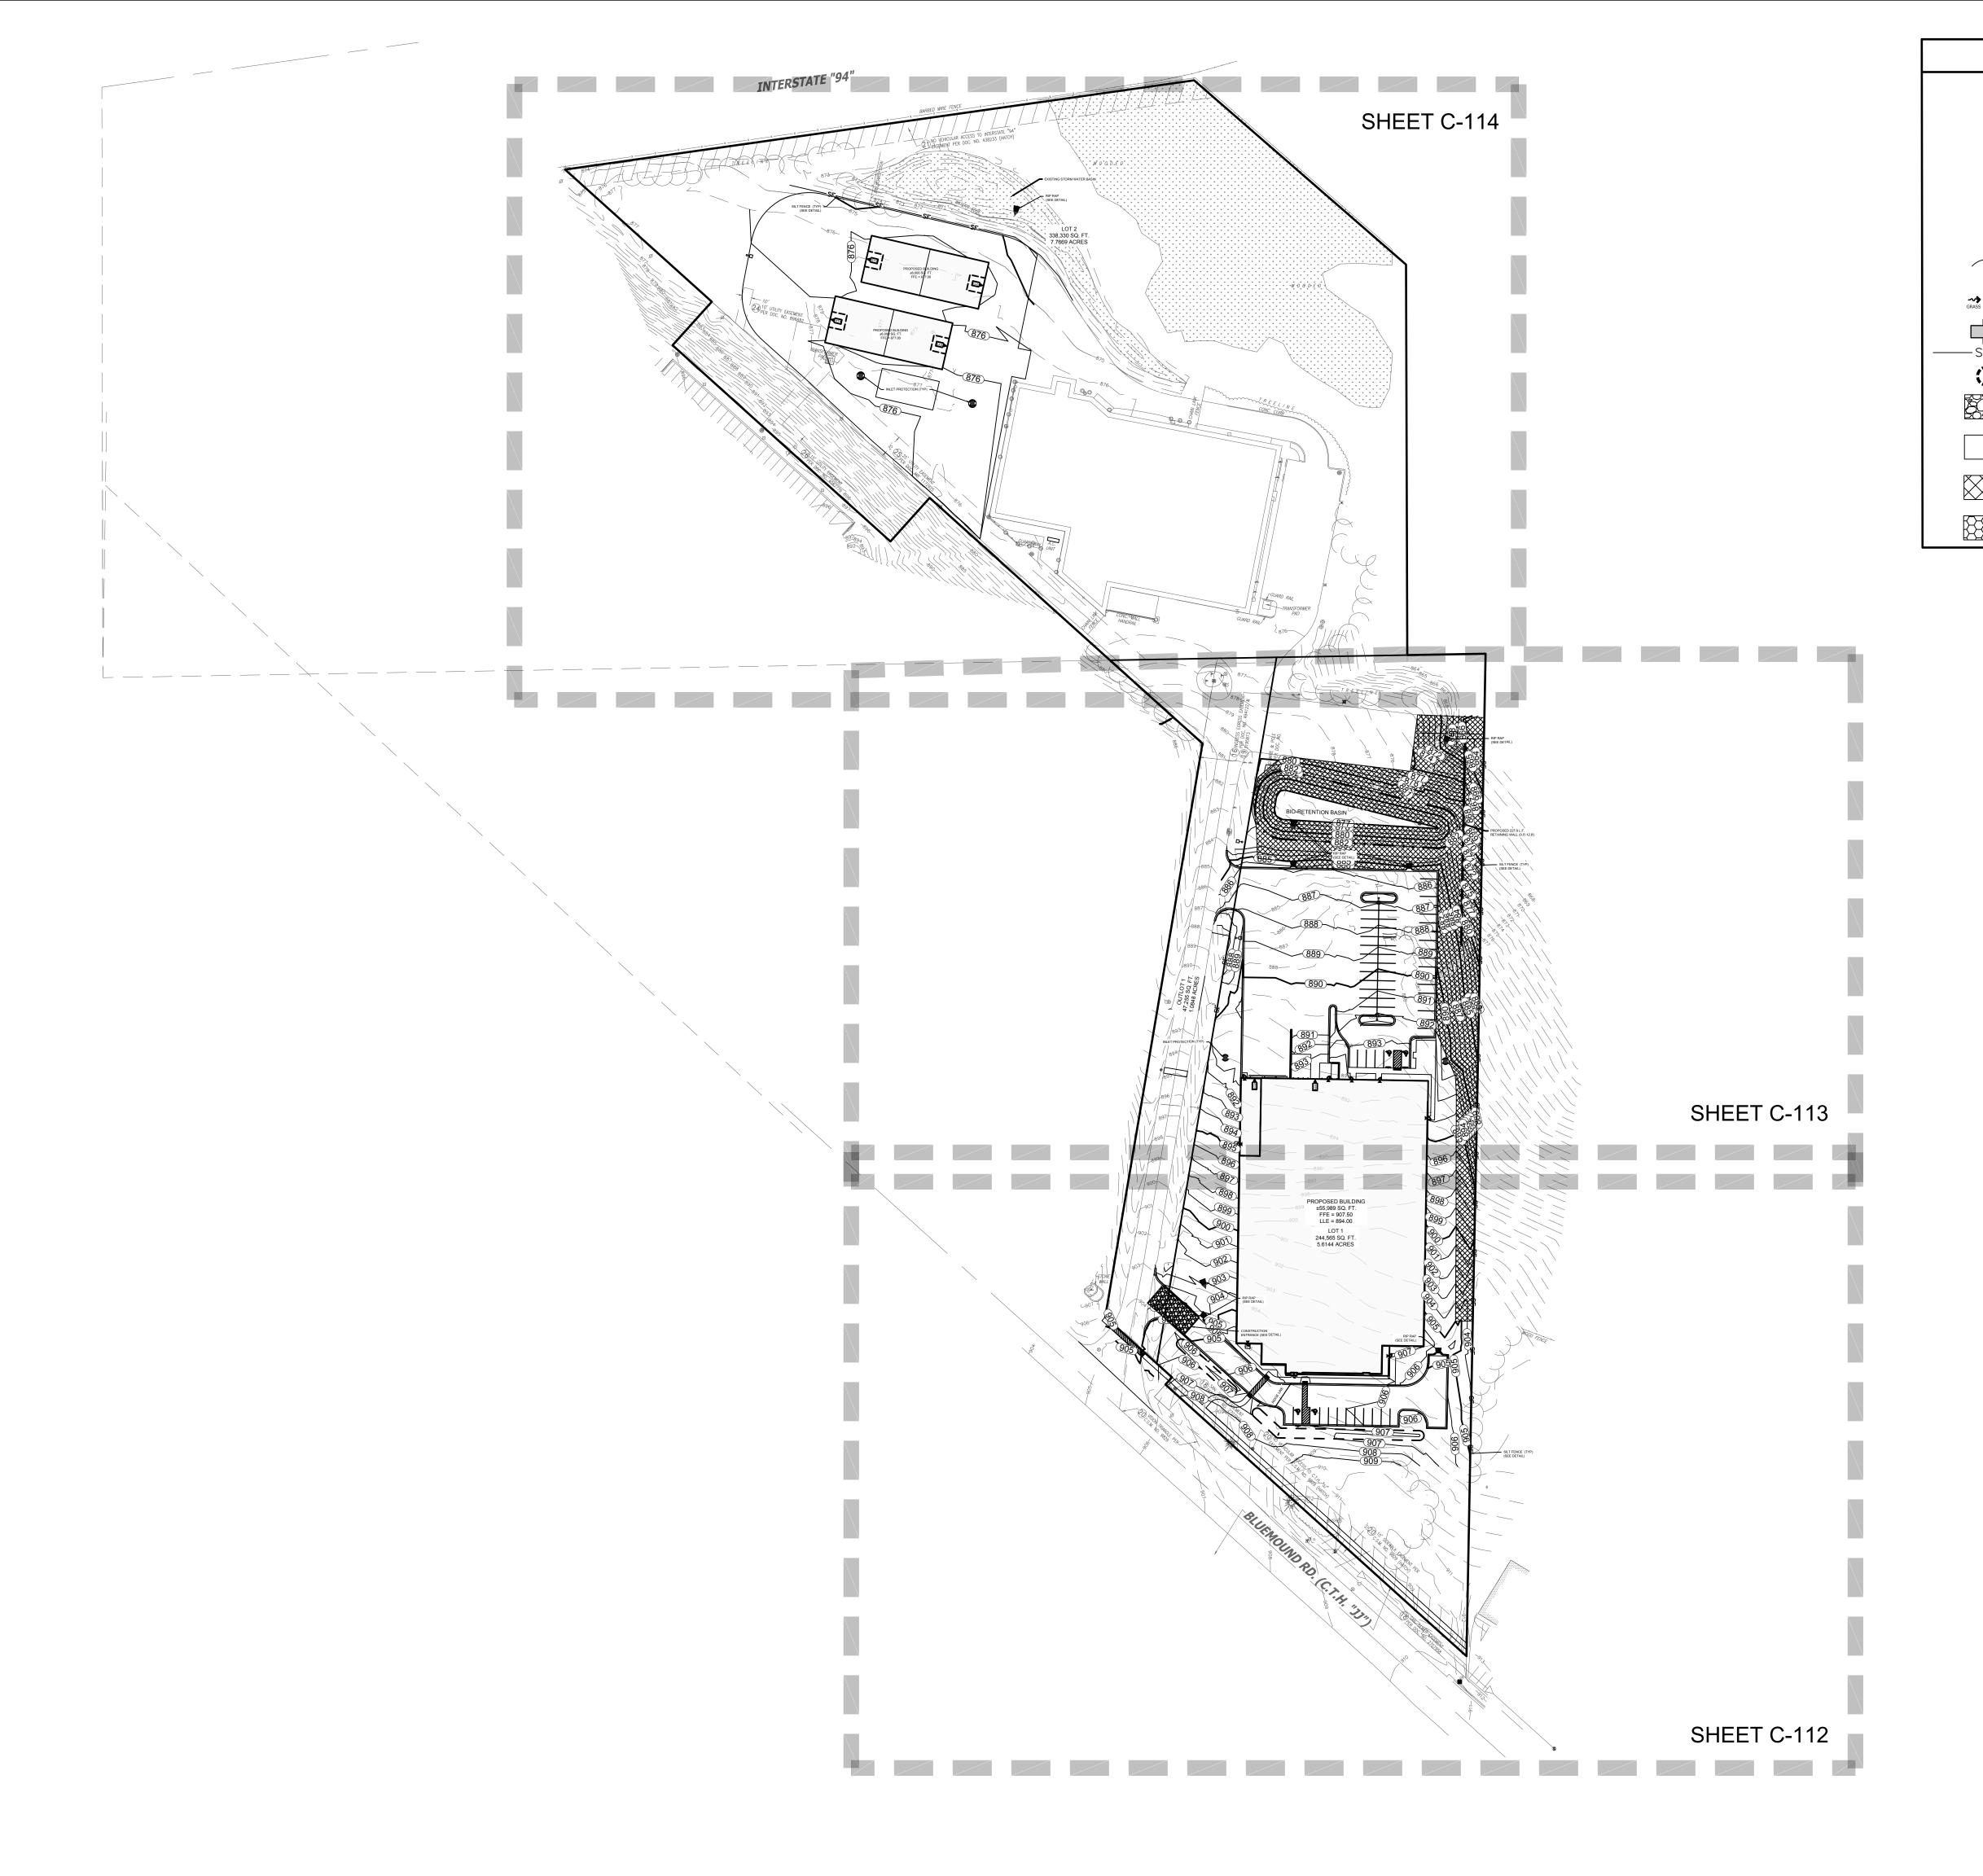



LEGEND

STORM STORM CATCH BASIN (ROUND CASTING)

STORM SEWER CATCH BASIN (RECTANGULAR CASTING)

SANITARY SEWER MANHOLE

PRECAST FLARED END SECTION

STORM SEWER MANHOLE

CLEANOUT VALVE BOX

FIRE HYDRANT

— SILT FENCE

HYDROSEED

PROPOSED CONTOUR

PROPOSED SPOT ELEVATION

DIRECTION OF SURFACE FLOW OVERFLOW RELIEF ROUTING

WISDOT TYPE D INLET PROTECTION

CONSTRUCTION ENTRANCE

EROSION CONTROL BLANKET

HEAVY DUTY RIP RAP (IN CONFORMANCE WITH THE VILLAGE STANDARD. SEE DETAIL ON SHEET ####.)





FISHER BARTON GROUP (ACCURATE SPECIALTIES INC.)

STREET ADDRESS 570 Bluemound Road

CITY/ STATE / ZIP Waukesha, WI 53188

ALL WORK TO BE COMPLETED AS SHOWN, AND IN ACCORDANCE WITH THE LATEST EDITION OF THE MSI GENERAL MASTER SPECIFICATION

> SPIRE ENGINEERING DJB

TNK

LEADERS

ENGINEERS

PROPOSAL SET: PLAN COMMISSION SET: SUBMITTAL FOR PERMIT SET:

CONSTRUCTION SET: RECORD DRAWING SET:

REVISIONS:

EXISTING CONDITIONS SURVEY:

CONSTRUCTION SITE SEQENCING

DEMOLITION AND REMOVALS OF BUILDINGS, PAVEMENTS & LANDSCAPING.

ENTRANCE AND ANY OTHER EROSION CONTROL MEASURES

2. INSTALL PERIMETER SILT FENCE, INLET PROTECTION, TEMPORARY CONSTRUCTION

PERFORM WEEKLY EROSION CONTROL INSPECTIONS AND SUBMIT INSPECTIONS TO

5. STRIP AND STOCKPILE TOPSOIL, INSTALL SILT FENCE AROUND PERIMETER OF

. CONDUCT ROUGH GRADING EFFORTS AND INSTALL CHECK DAMS AND SEDIMENT TRAP/BASINS AS NEEDED. IF SEDIMENT BASINS (BIO RETENTION BASINS) ARE TO BE USED, BOTTOM OF BASIN SHALL BE LEFT A MINIMUM OF 1' ABOVE FINAL GRADE IN

ORDER TO PRESERVE NATIVE SOIL INTERFACE. DO NOT EXCAVATE FINAL 1' UNTIL

8. INSTALL UTILITY PIPING AND STRUCTURES, IMMEDIATELY INSTALL INLET PROTECTION.

9. COMPLETE FINAL GRADING, INSTALLATION OF GRAVEL BASE COURSES, PLACEMENT OF CURBS, PAVEMENTS, WALKS, ETC.

10. INSTALL TOPSOIL, AND LANDSCAPING. IMMEDIATELY STABILIZE DISTURBED AREAS

11. EROSION CONTROL MEASURES SHALL BE REMOVED ONLY AFTER SITE CONSTRUCTION IS COMPLETE WITH ALL SOIL SURFACES HAVING AN ESTABLISHED

12. AT THE END OF PROJECT, COORDINATE PERMIT TERMINATION WITH CITY EROSION

CONTRACTOR MAY MODIFY SEQUENCING AFTER ITEM 1 AS NEEDED TO COMPLETE CONSTRUCTION IF EROSION CONTROLS ARE MAINTAINED IN ACCORDANCE WITH THE

CONSTRUCTION SITE EROSION CONTROL REQUIREMENTS.

. OBTAIN CITY STORM WATER PERMIT

MATCH LINE SEE SHEET C-113

PROPOSED BUILDING

±55,989 SQ. FT.

FFE = 907.50

LLE = 894.00

LOT 1

244,565 SQ. FT.

(SEE DETAIL)

CONSTRUCTION ENTRANCE (SEE DETAIL)

5.6144 ACRES

(SEE DETAIL)

THE CITY EROSION CONTROL INSPECTOR.

FINAL SITE STABILIZATION OCCURS.

7. CONSTRUCTION OF FOUNDATIONS AND BUILDING.

EXISTING CONDITIONS SURVEY PROVIDED BY CHAPUT LAND SURVEYS. ALTHOUGH PEG HAS NO REASON TO BELIEVE THE SURVEY IS INACCURATE, PEG MAKES NO WARRANTS THAT EXISTING INFORMATION CONTAINED WITHIN THESE PLANS IS ALL-INCLUSIVE OR ACCURATE. CONTRACTOR HALL UNDERTAKE NECESSARY EFFORTS TO VERIFY THE EXISTING CONDITIONS PRIOR TO THE START OF MATERIAL PROCUREMENT AND CONSTRUCTION EFFORTS/ACTIVITIES.

CONTRACTOR RESPONSIBILITY:

UNDERGROUND UTILITIES IS NOT GUARANTEED TO BE ACCURATE OR ALL INCLUSIVE. THE LOCATION OF UNDERGROUND UTILITIES AS MAY BE NECESSARY TO AVOID DAMAGE THERETO. IF ADDITIONAL UTILITIES ARE KNOWN TO EXIST IN THE PROPERTY, THE OWNER WILL PROVIDE EXISTING PLANS OF OTHER UTILITIES SERVING THE SITE AND THE BUILDING THAT OTHERWISE CANNOT BE LOCATED BY A VISUAL OBSERVATION OF THE PROPERTY OR OF WHICH THE SURVEYOR WOULD HAVE NO KNOWLEDGE.

CONTRACTOR RESPONSIBILITY: SEE ADDITIONAL **CONSTRUCTION NOTES LOCATED ON SHEET C-102**


- SILT FENCE (TYP)

(SEE DETAIL)

LEGEND SANITARY SEWER MANHOLE STORM SEWER MANHOLE STORM STORM CATCH BASIN (ROUND CASTING) STORM SEWER CATCH BASIN (RECTANGULAR CASTING) PRECAST FLARED END SECTION CLEANOUT VALVE BOX FIRE HYDRANT PROPOSED CONTOUR PROPOSED SPOT ELEVATION DIRECTION OF SURFACE FLOW OVERFLOW RELIEF ROUTING —— SF——— SILT FENCE WISDOT TYPE D INLET PROTECTION CONSTRUCTION ENTRANCE HYDROSEED EROSION CONTROL BLANKET HEAVY DUTY RIP RAP (IN CONFORMANCE WITH THE VILLAGE STANDARD. SEE DETAIL ON SHEET ####.)

NOTE:

REMAINING DISTURBED AREAS OF SLOPES 5:1 OR FLATTER TO BE HYDROSEEDED

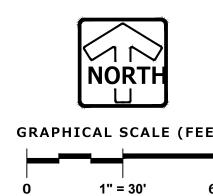

PINNACLE ENGINEERING GROUP PLAN I DESIGN I DELIVER WISCONSIN OFFICE: 20725 WATERTOWN RD BROOKFIELD, WI 53186

(262) 754-8888 CHICAGO I MILWAUKEE : NATIONWIDE PEG PROJECT #: 2989.00





FISHER BARTON GROUP (ACCURATE SPECIALTIES INC.) PROJECT DESCRIPTION

STREET ADDRESS 570 Bluemound Road

CITY/ STATE / ZIP Waukesha, WI 53188

ALL WORK TO BE COMPLETED AS SHOWN, AND IN ACCORDANCE WITH THE LATEST EDITION OF

THE MSI GENERAL MASTER SPECIFICATION SPIRE DJB **ENGINEERING**

CIVIL ENGINEER: MTS MTS TNK

SHEET TITLE:

GRADING & EROSION CONTROL PLAN

SHEET NUMBER: C-112

P13417

PROJECT NUMBER: GRAPHICAL SCALE (FEET)

10/13/2022

CONTRACTORS

ARCHITECT

10/13/2022

NASHOTAH, WI 53058

DESIGNING EXCELLENCE. BUILDING TRUST.TM

MILESTONE ISSUE DATES

OWNER REVIEW:

BUDGET SET:

PROPOSAL SET:

REVISIONS:

PLAN COMMISSION SET:

CONSTRUCTION SET:

RECORD DRAWING SET:

SUBMITTAL FOR PERMIT SET:

CONTRACTORS

ARCHITECT

PEG PROJECT #: 2989.00

STREET ADDRESS

570 Bluemound Road CITY/ STATE / ZIP

Waukesha, WI 53188 ALL WORK TO BE COMPLETED AS SHOWN, AND IN ACCORDANCE WITH THE LATEST EDITION OF

THE MSI GENERAL MASTER SPECIFICATION SPIRE DJB

ENGINEERING MTS MTS


TNK SHEET TITLE:

GRADING & EROSION CONTROL PLAN

SHEET NUMBER:

C-113 PROJECT NUMBER:

P13417

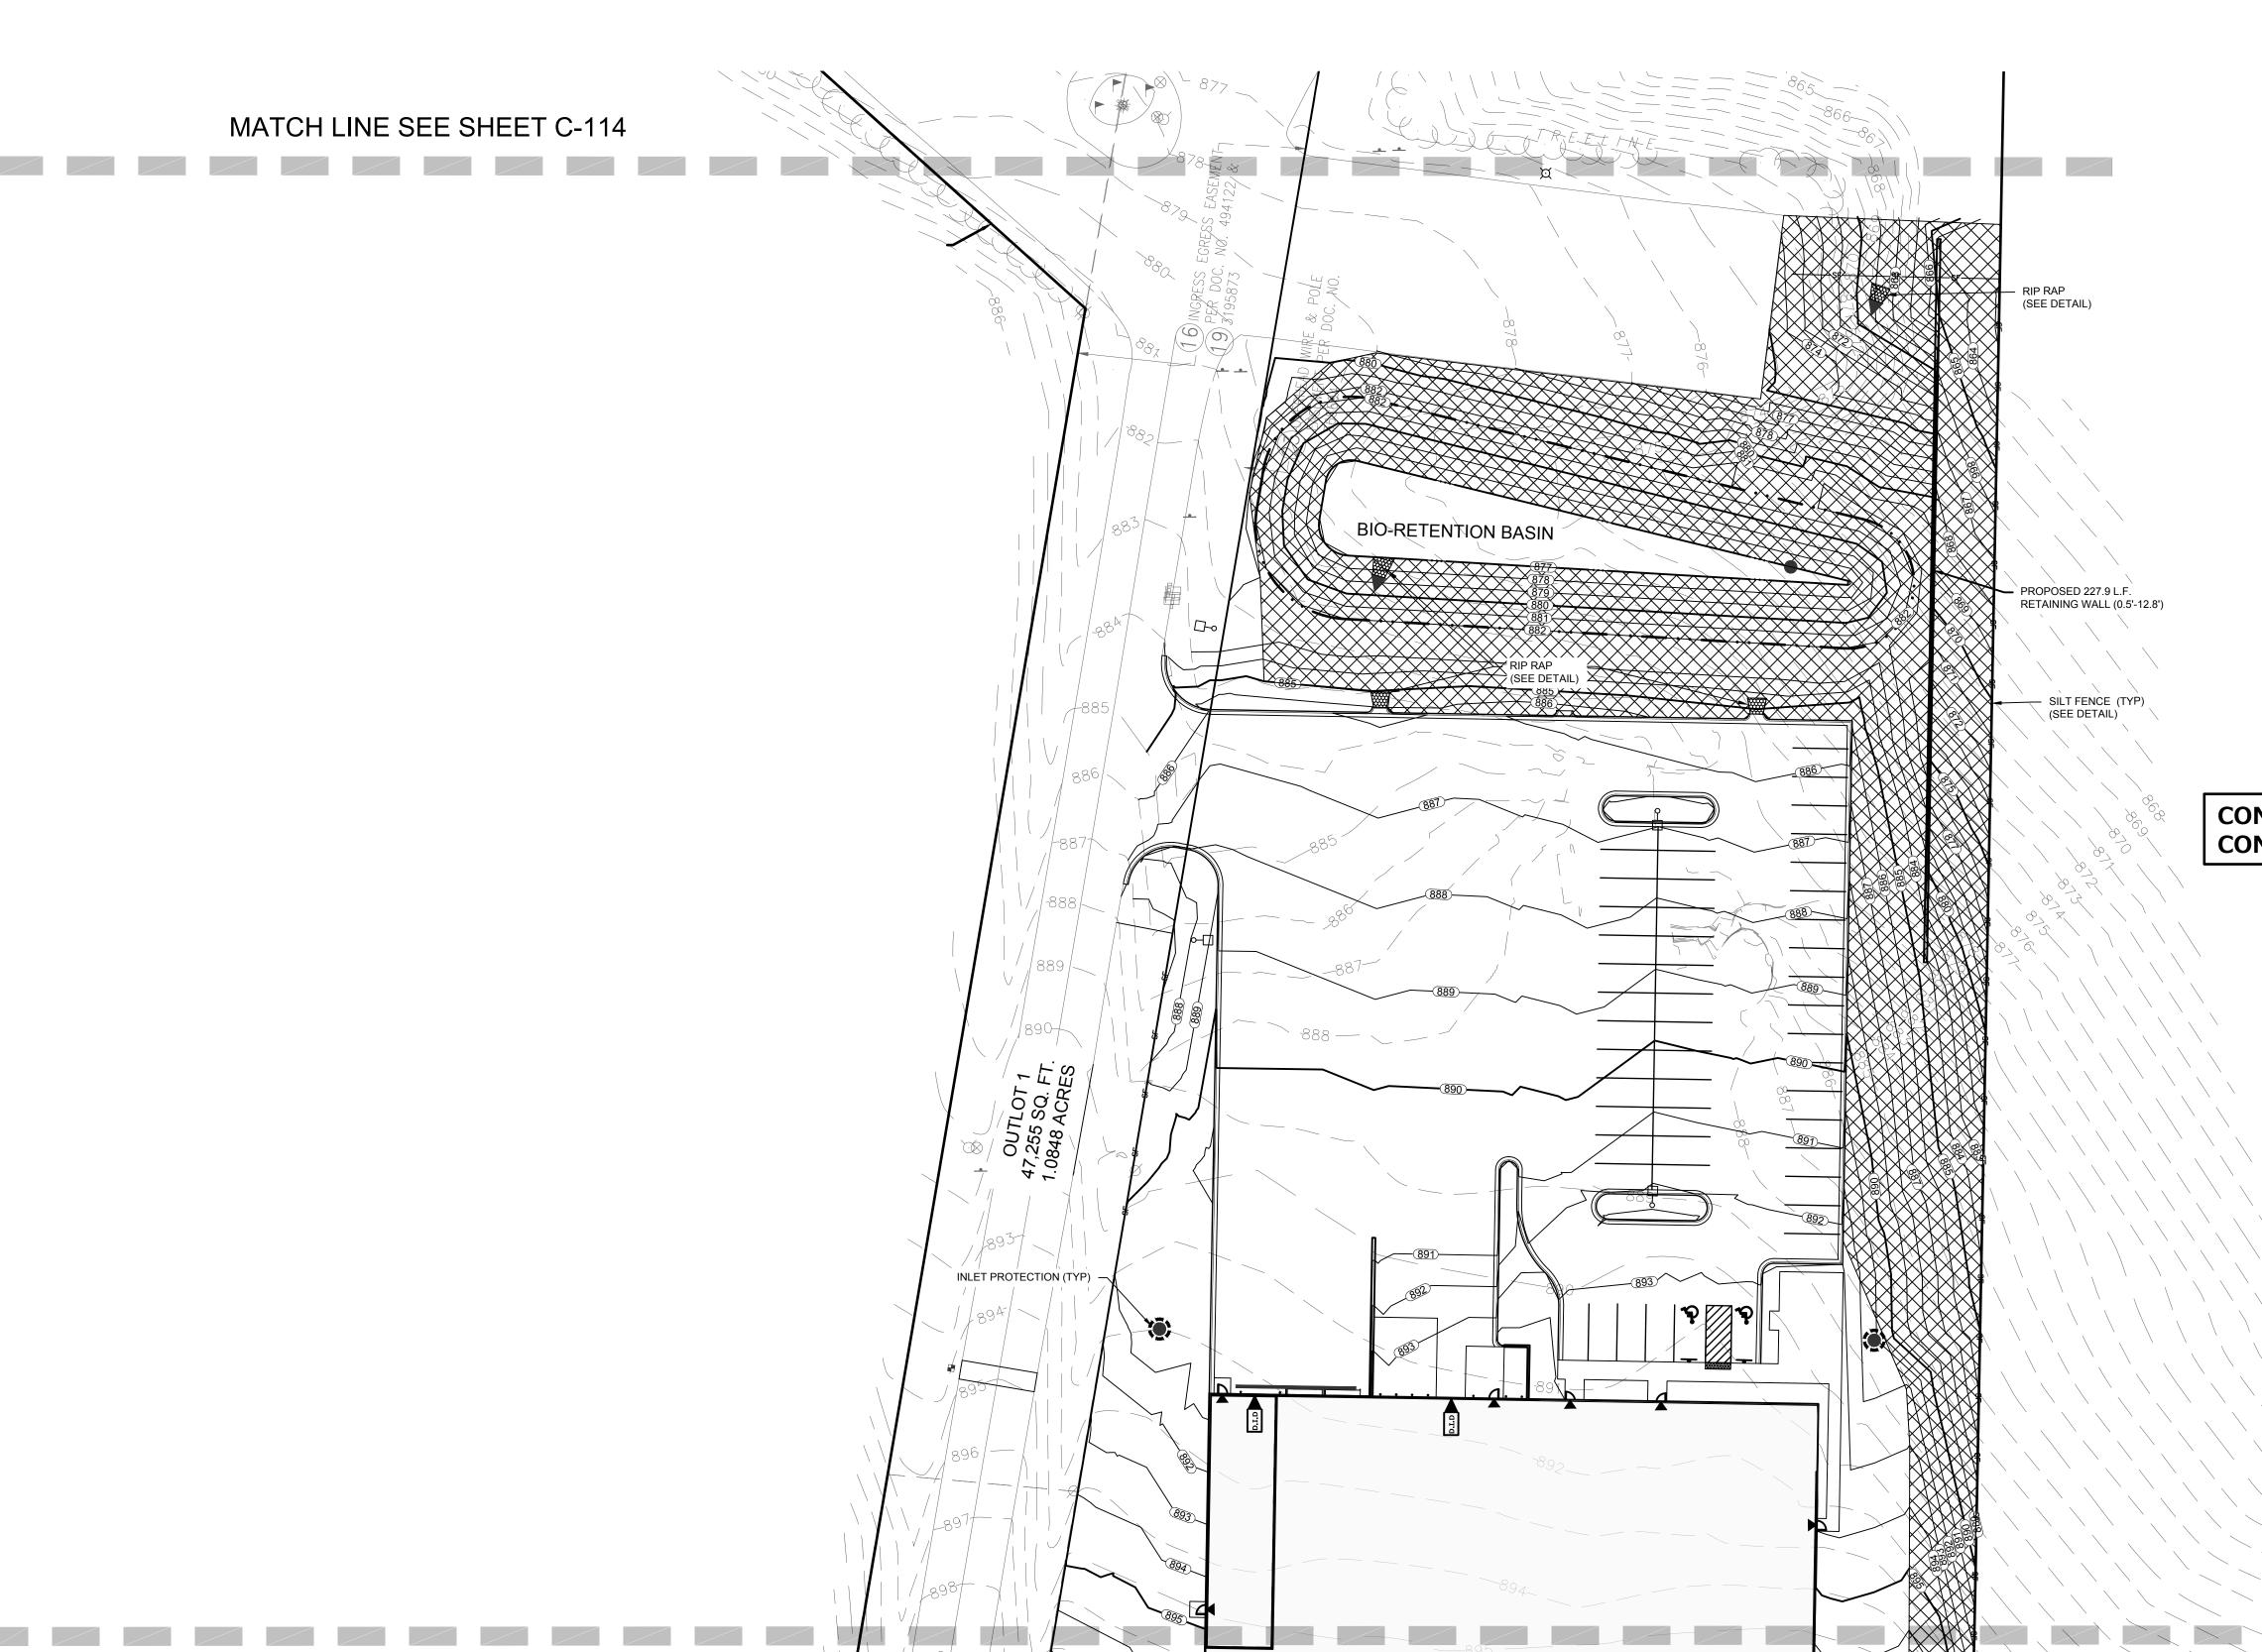

MATCH LINE SEE SHEET C-112

CONSTRUCTION SITE SEQENCING

- 1. OBTAIN CITY STORM WATER PERMIT
- 2. INSTALL PERIMETER SILT FENCE, INLET PROTECTION, TEMPORARY CONSTRUCTION ENTRANCE AND ANY OTHER EROSION CONTROL MEASURES
- 3. PERFORM WEEKLY EROSION CONTROL INSPECTIONS AND SUBMIT INSPECTIONS TO THE CITY EROSION CONTROL INSPECTOR.
- 4. DEMOLITION AND REMOVALS OF BUILDINGS, PAVEMENTS & LANDSCAPING.
- 5. STRIP AND STOCKPILE TOPSOIL, INSTALL SILT FENCE AROUND PERIMETER OF
- 6. CONDUCT ROUGH GRADING EFFORTS AND INSTALL CHECK DAMS AND SEDIMENT TRAP/BASINS AS NEEDED. IF SEDIMENT BASINS (BIO RETENTION BASINS) ARE TO BE USED, BOTTOM OF BASIN SHALL BE LEFT A MINIMUM OF 1' ABOVE FINAL GRADE IN ORDER TO PRESERVE NATIVE SOIL INTERFACE. DO NOT EXCAVATE FINAL 1' UNTIL FINAL SITE STABILIZATION OCCURS.
- 7. CONSTRUCTION OF FOUNDATIONS AND BUILDING.
- 8. INSTALL UTILITY PIPING AND STRUCTURES, IMMEDIATELY INSTALL INLET PROTECTION.
- 9. COMPLETE FINAL GRADING, INSTALLATION OF GRAVEL BASE COURSES, PLACEMENT OF CURBS, PAVEMENTS, WALKS, ETC.
- 10. INSTALL TOPSOIL, AND LANDSCAPING. IMMEDIATELY STABILIZE DISTURBED AREAS
- 11. EROSION CONTROL MEASURES SHALL BE REMOVED ONLY AFTER SITE CONSTRUCTION IS COMPLETE WITH ALL SOIL SURFACES HAVING AN ESTABLISHED
- 12. AT THE END OF PROJECT, COORDINATE PERMIT TERMINATION WITH CITY EROSION
- CONTROL INSPECTOR CONTRACTOR MAY MODIFY SEQUENCING AFTER ITEM 1 AS NEEDED TO COMPLETE

CONSTRUCTION IF EROSION CONTROLS ARE MAINTAINED IN ACCORDANCE WITH THE CONSTRUCTION SITE EROSION CONTROL REQUIREMENTS.

EXISTING CONDITIONS SURVEY:

EXISTING CONDITIONS SURVEY PROVIDED BY CHAPUT LAND SURVEYS. ALTHOUGH PEG HAS NO REASON TO BELIEVE THE SURVEY IS INACCURATE, PEG MAKES NO WARRANTS THAT EXISTING INFORMATION CONTAINED WITHIN THESE PLANS IS ALL-INCLUSIVE OR ACCURATE. CONTRACTOR SHALL UNDERTAKE NECESSARY EFFORTS TO VERIFY THE EXISTING CONDITIONS PRIOR TO THE START OF MATERIAL PROCUREMENT AND CONSTRUCTION EFFORTS/ACTIVITIES.

CONTRACTOR RESPONSIBILITY:

UNDERGROUND UTILITIES IS NOT GUARANTEED TO BE ACCURATE OR ALL INCLUSIVE. THE LOCATION OF UNDERGROUND UTILITIES AS MAY BE NECESSARY TO AVOID DAMAGE THERETO. IF ADDITIONAL UTILITIES ARE KNOWN TO EXIST IN THE PROPERTY, THE OWNER WILL PROVIDE EXISTING PLANS OF OTHER UTILITIES SERVING THE SITE AND THE BUILDING THAT OTHERWISE CANNOT BE LOCATED BY A VISUAL OBSERVATION OF THE PROPERTY OR OF WHICH THE SURVEYOR WOULD HAVE NO KNOWLEDGE.

CONTRACTOR RESPONSIBILITY: SEE ADDITIONAL CONSTRUCTION NOTES LOCATED ON SHEET C-102


	LEGEND
•	SANITARY SEWER MANHOLE
•	STORM SEWER MANHOLE
•	STORM STORM CATCH BASIN (ROUND CASTING)
	STORM SEWER CATCH BASIN (RECTANGULAR CASTING)
>	PRECAST FLARED END SECTION
	CLEANOUT
	VALVE BOX
>	FIRE HYDRANT
749	PROPOSED CONTOUR
• 750.0	PROPOSED SPOT ELEVATION
GRASS PAVEMENT	DIRECTION OF SURFACE FLOW
ightharpoons	OVERFLOW RELIEF ROUTING
SF	- SILT FENCE
\bigcirc	WISDOT TYPE D INLET PROTECTION
	CONSTRUCTION ENTRANCE
	HYDROSEED
	EROSION CONTROL BLANKET
	HEAVY DUTY RIP RAP (IN CONFORMANCE WITH THE VILLAGE STANDARD. SEE DETAIL ON SHEET ####.)

NOTE:

REMAINING DISTURBED AREAS OF SLOPES 5:1 OR FLATTER TO BE HYDROSEEDED

GRAPHICAL SCALE (FEET)

1" = 30'

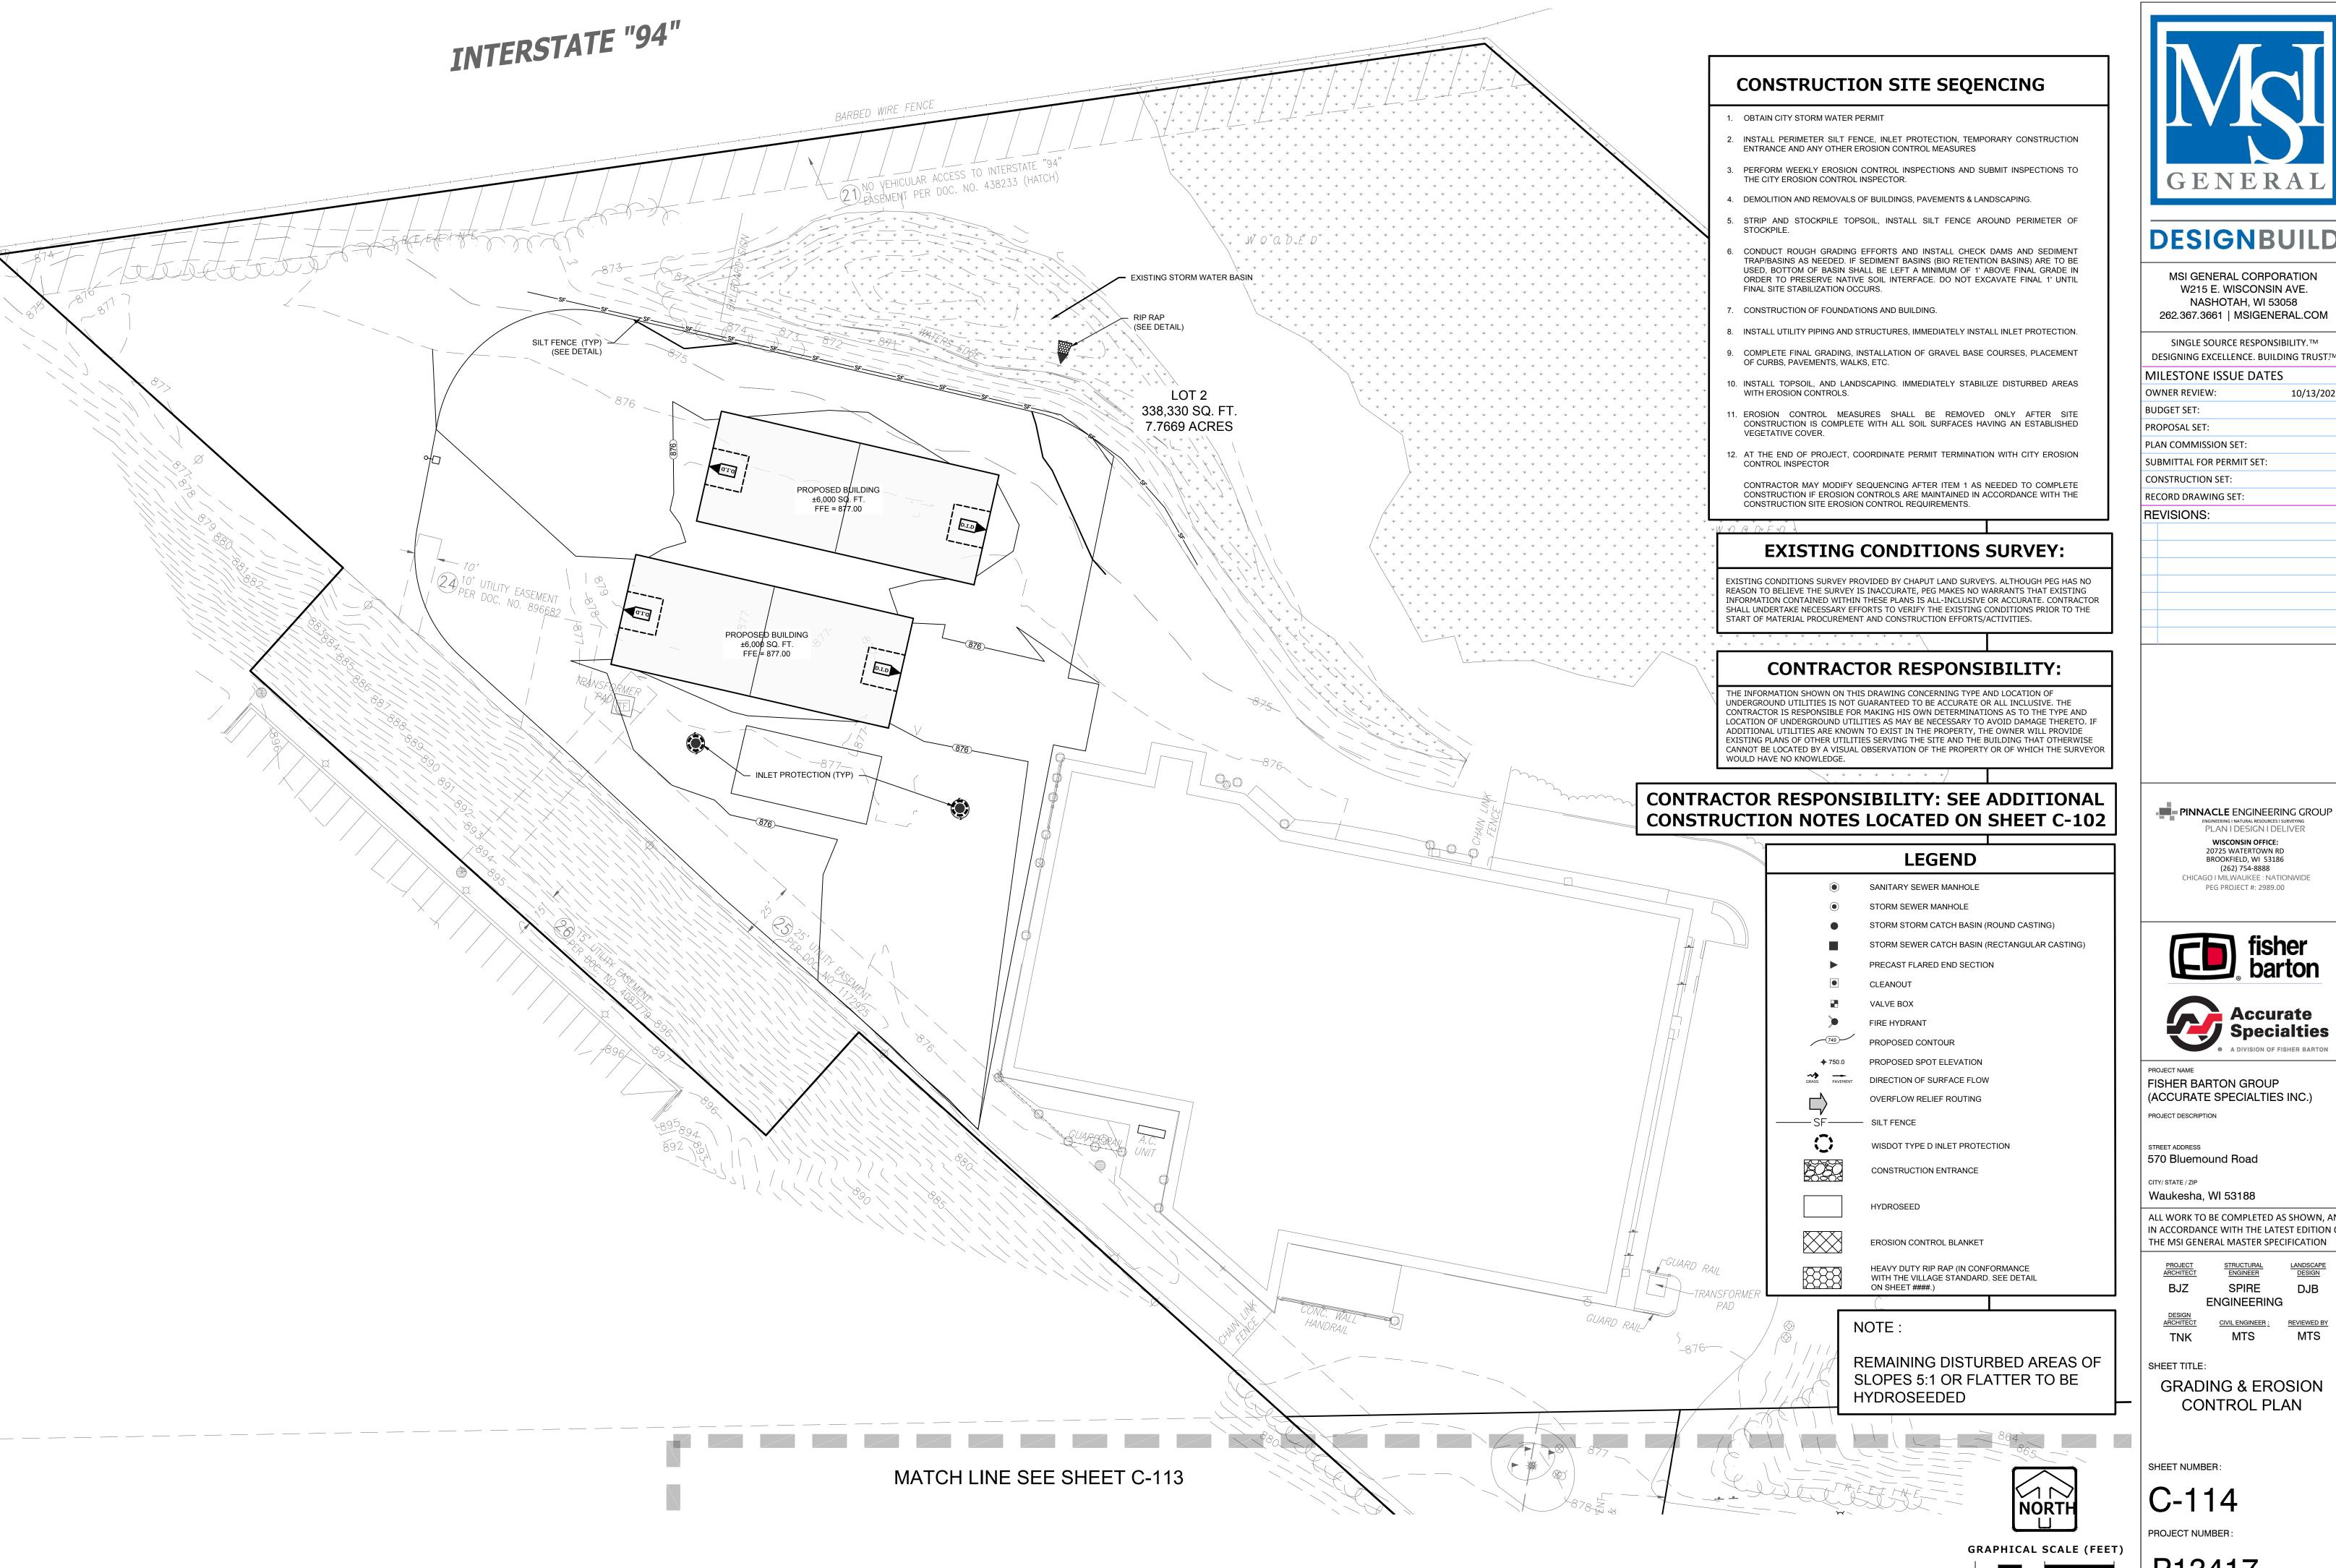



LEADERS

MSI GENERAL CORPORATION W215 E. WISCONSIN AVE. NASHOTAH, WI 53058 262.367.3661 | MSIGENERAL.COM

SINGLE SOURCE RESPONSIBILITY.™ DESIGNING EXCELLENCE. BUILDING TRUST™

MILESTONE ISSUE DATES

OWNER REVIEW: 10/13/2022 BUDGET SET:

> WISCONSIN OFFICE: 20725 WATERTOWN RD

BROOKFIELD, WI 53186 (262) 754-8888

PEG PROJECT #: 2989.00

PROPOSAL SET: PLAN COMMISSION SET:

SUBMITTAL FOR PERMIT SET: CONSTRUCTION SET:

REVISIONS:

CITY/ STATE / ZIP Waukesha, WI 53188

ALL WORK TO BE COMPLETED AS SHOWN, AND IN ACCORDANCE WITH THE LATEST EDITION OF THE MSI GENERAL MASTER SPECIFICATION

SPIRE DJB


ENGINEERING MTS MTS

GRADING & EROSION CONTROL PLAN

P13417

CONTRACTORS

ARCHITECT

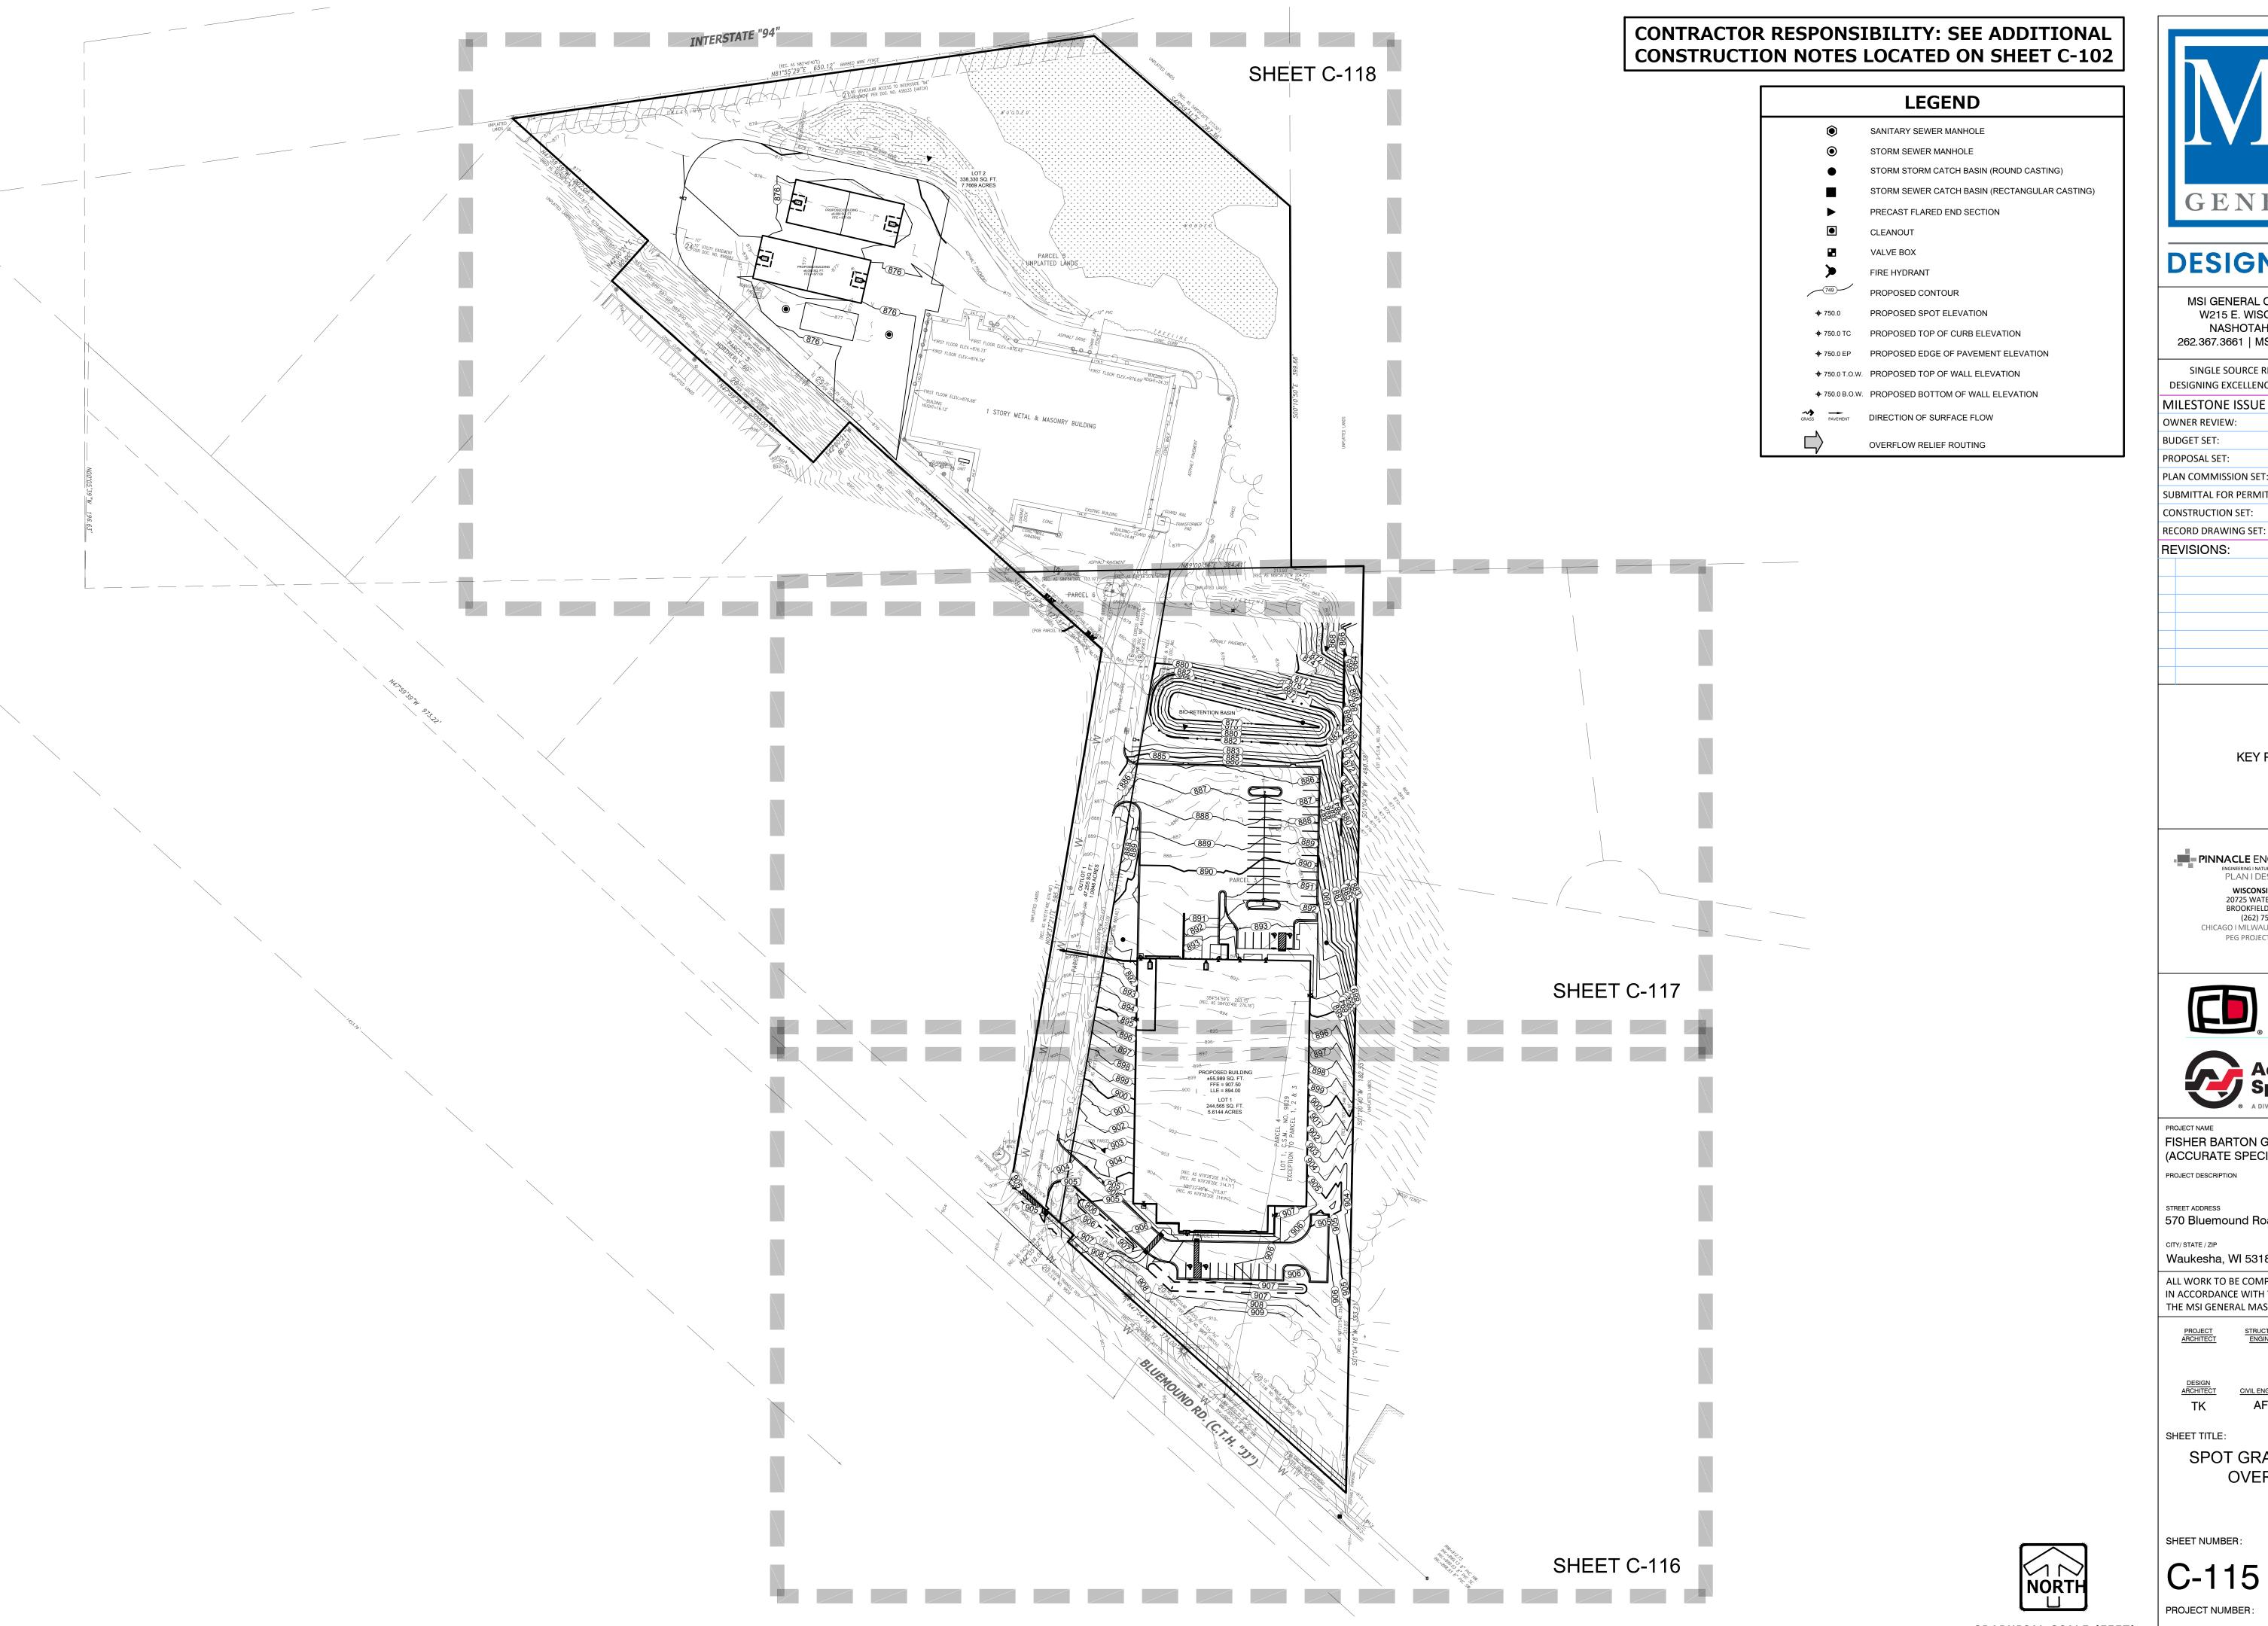



LEADERS

MSI GENERAL CORPORATION W215 E. WISCONSIN AVE. NASHOTAH, WI 53058 262.367.3661 | MSIGENERAL.COM

SINGLE SOURCE RESPONSIBILITY.™ DESIGNING EXCELLENCE. BUILDING TRUST™ MILESTONE ISSUE DATES OWNER REVIEW: 10/13/2022

BUDGET SET: PROPOSAL SET: PLAN COMMISSION SET: SUBMITTAL FOR PERMIT SET: CONSTRUCTION SET:

KEY PLAN

PINNACLE ENGINEERING GROUP ENGINEERING I NATURAL RESOURCES I SURVEYING PLAN I DESIGN I DELIVER WISCONSIN OFFICE: 20725 WATERTOWN RD BROOKFIELD, WI 53186

(262) 754-8888 CHICAGO I MILWAUKEE : NATIONWIDE PEG PROJECT #: 2989.00





(ACCURATE SPECIALTIES INC.) PROJECT DESCRIPTION

570 Bluemound Road

Waukesha, WI 53188 ALL WORK TO BE COMPLETED AS SHOWN, AND IN ACCORDANCE WITH THE LATEST EDITION OF

THE MSI GENERAL MASTER SPECIFICATION

AFH

ARCHITECT

SPOT GRADE PLAN

OVERALL

SHEET NUMBER:

C-115 PROJECT NUMBER:

LEADERS

ENGINEERS

MSI GENERAL CORPORATION W215 E. WISCONSIN AVE. NASHOTAH, WI 53058 262.367.3661 | MSIGENERAL.COM

SINGLE SOURCE RESPONSIBILITY.™

DESIGNING EXCELLENCE. BUILDING TRUST!M MILESTONE ISSUE DATES OWNER REVIEW: 10/13/2022 BUDGET SET:

PROPOSAL SET: PLAN COMMISSION SET: SUBMITTAL FOR PERMIT SET: CONSTRUCTION SET: RECORD DRAWING SET:

REVISIONS:

KEY PLAN

PINNACLE ENGINEERING GROUP ENGINEERING I NATURAL RESOURCES I SURVEYING PLAN I DESIGN I DELIVER WISCONSIN OFFICE: 20725 WATERTOWN RD BROOKFIELD, WI 53186

(262) 754-8888 CHICAGO I MILWAUKEE : NATIONWIDE PEG PROJECT #: 2989.00

ALL WORK TO BE COMPLETED AS SHOWN, AND IN ACCORDANCE WITH THE LATEST EDITION OF THE MSI GENERAL MASTER SPECIFICATION

ARCHITECT


TK

ARCHITECTS

SHEET NUMBER: C-116

PROJECT NUMBER:

P13417

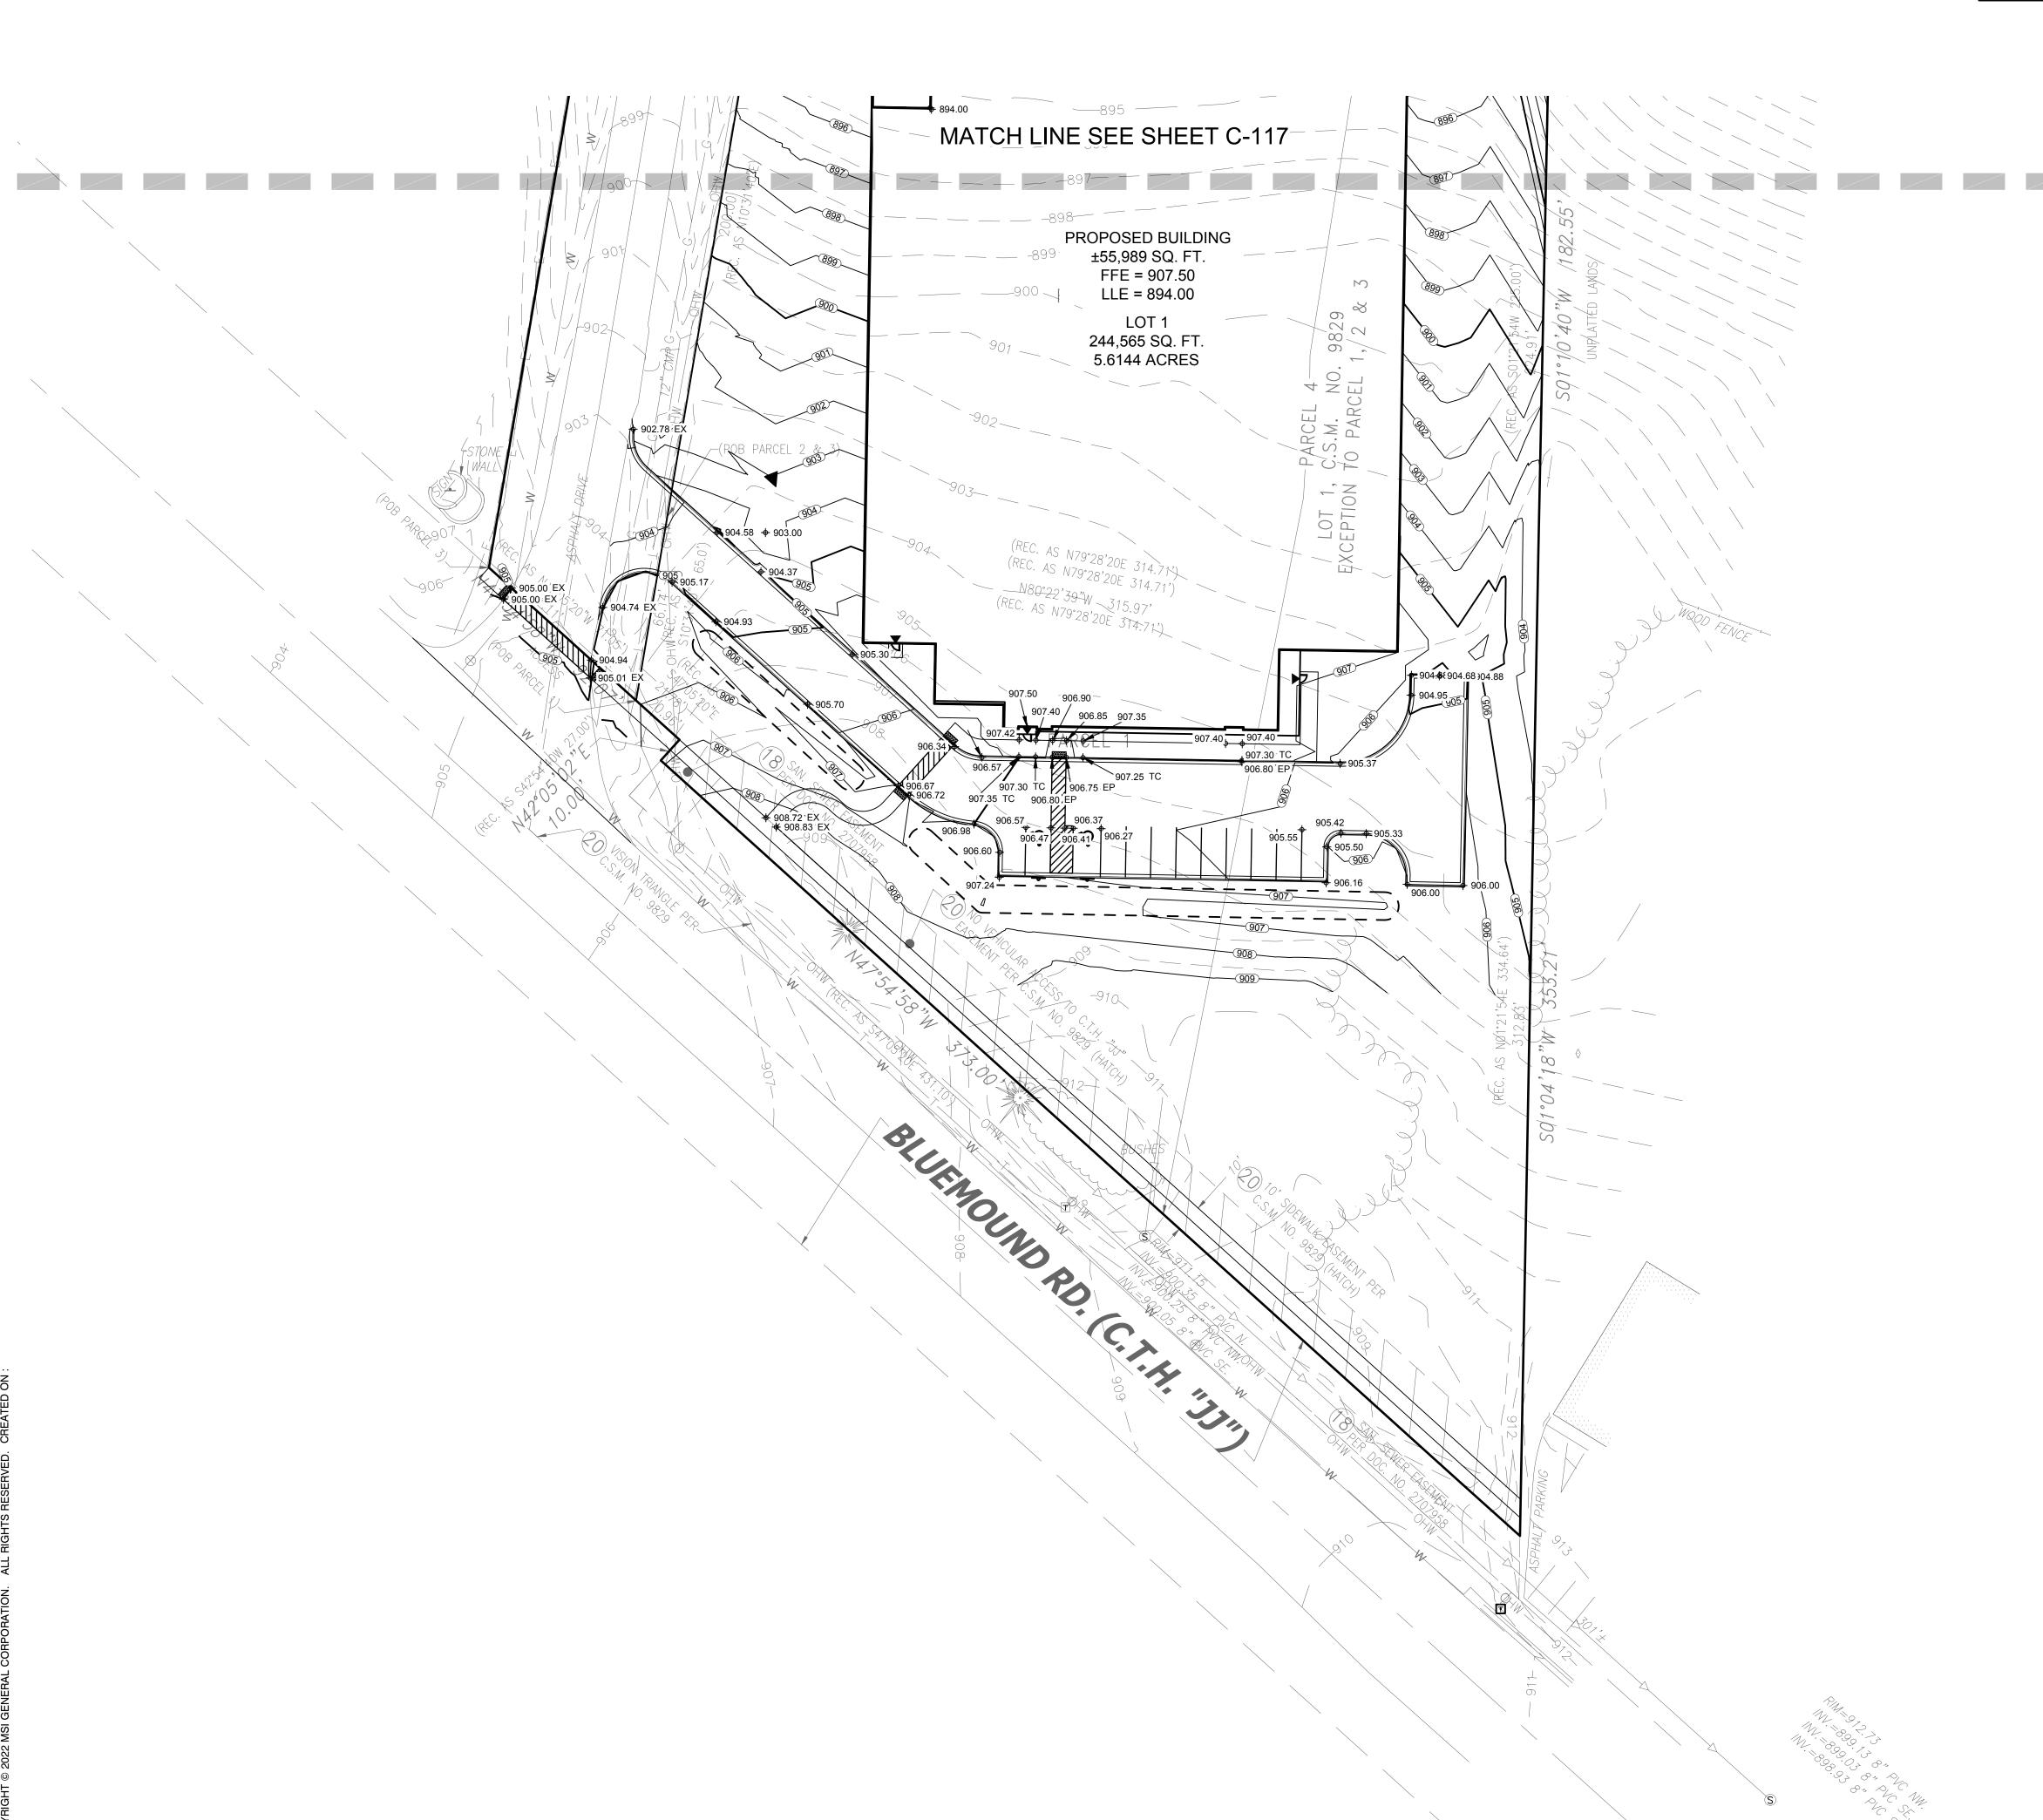

STREET ADDRESS 570 Bluemound Road

Waukesha, WI 53188

CIVIL ENGINEER :

AFH

SHEET TITLE: SPOT GRADE PLAN

STORM STORM CATCH BASIN (ROUND CASTING) STORM SEWER CATCH BASIN (RECTANGULAR CASTING)

PRECAST FLARED END SECTION

CLEANOUT

VALVE BOX

FIRE HYDRANT PROPOSED CONTOUR

PROPOSED SPOT ELEVATION

PROPOSED TOP OF CURB ELEVATION PROPOSED EDGE OF PAVEMENT ELEVATION

♦ 750.0 T.O.W. PROPOSED TOP OF WALL ELEVATION

♦ 750.0 B.O.W. PROPOSED BOTTOM OF WALL ELEVATION

DIRECTION OF SURFACE FLOW

OVERFLOW RELIEF ROUTING

KEY PLAN

DESIGNBUILD

MSI GENERAL CORPORATION

W215 E. WISCONSIN AVE. NASHOTAH, WI 53058

262.367.3661 | MSIGENERAL.COM

SINGLE SOURCE RESPONSIBILITY.™

DESIGNING EXCELLENCE. BUILDING TRUST.TM

10/13/2022

MILESTONE ISSUE DATES

OWNER REVIEW:

BUDGET SET:

PROPOSAL SET:

REVISIONS:

PLAN COMMISSION SET:

CONSTRUCTION SET: RECORD DRAWING SET:

SUBMITTAL FOR PERMIT SET:

PINNACLE ENGINEERING GROUP ENGINEERING I NATURAL RESOURCES I SURVEYING PLAN I DESIGN I DELIVER WISCONSIN OFFICE: 20725 WATERTOWN RD BROOKFIELD, WI 53186

LEADERS

ENGINEERS

(262) 754-8888 CHICAGO I MILWAUKEE : NATIONWIDE PEG PROJECT #: 2989.00





FISHER BARTON GROUP (ACCURATE SPECIALTIES INC.)

STREET ADDRESS 570 Bluemound Road

CITY/ STATE / ZIP Waukesha, WI 53188

ALL WORK TO BE COMPLETED AS SHOWN, AND IN ACCORDANCE WITH THE LATEST EDITION OF THE MSI GENERAL MASTER SPECIFICATION

MTS AFH


ARCHITECT


SHEET TITLE: SPOT GRADE PLAN

SHEET NUMBER:

C-117

PROJECT NUMBER: GRAPHICAL SCALE (FEET) P13417

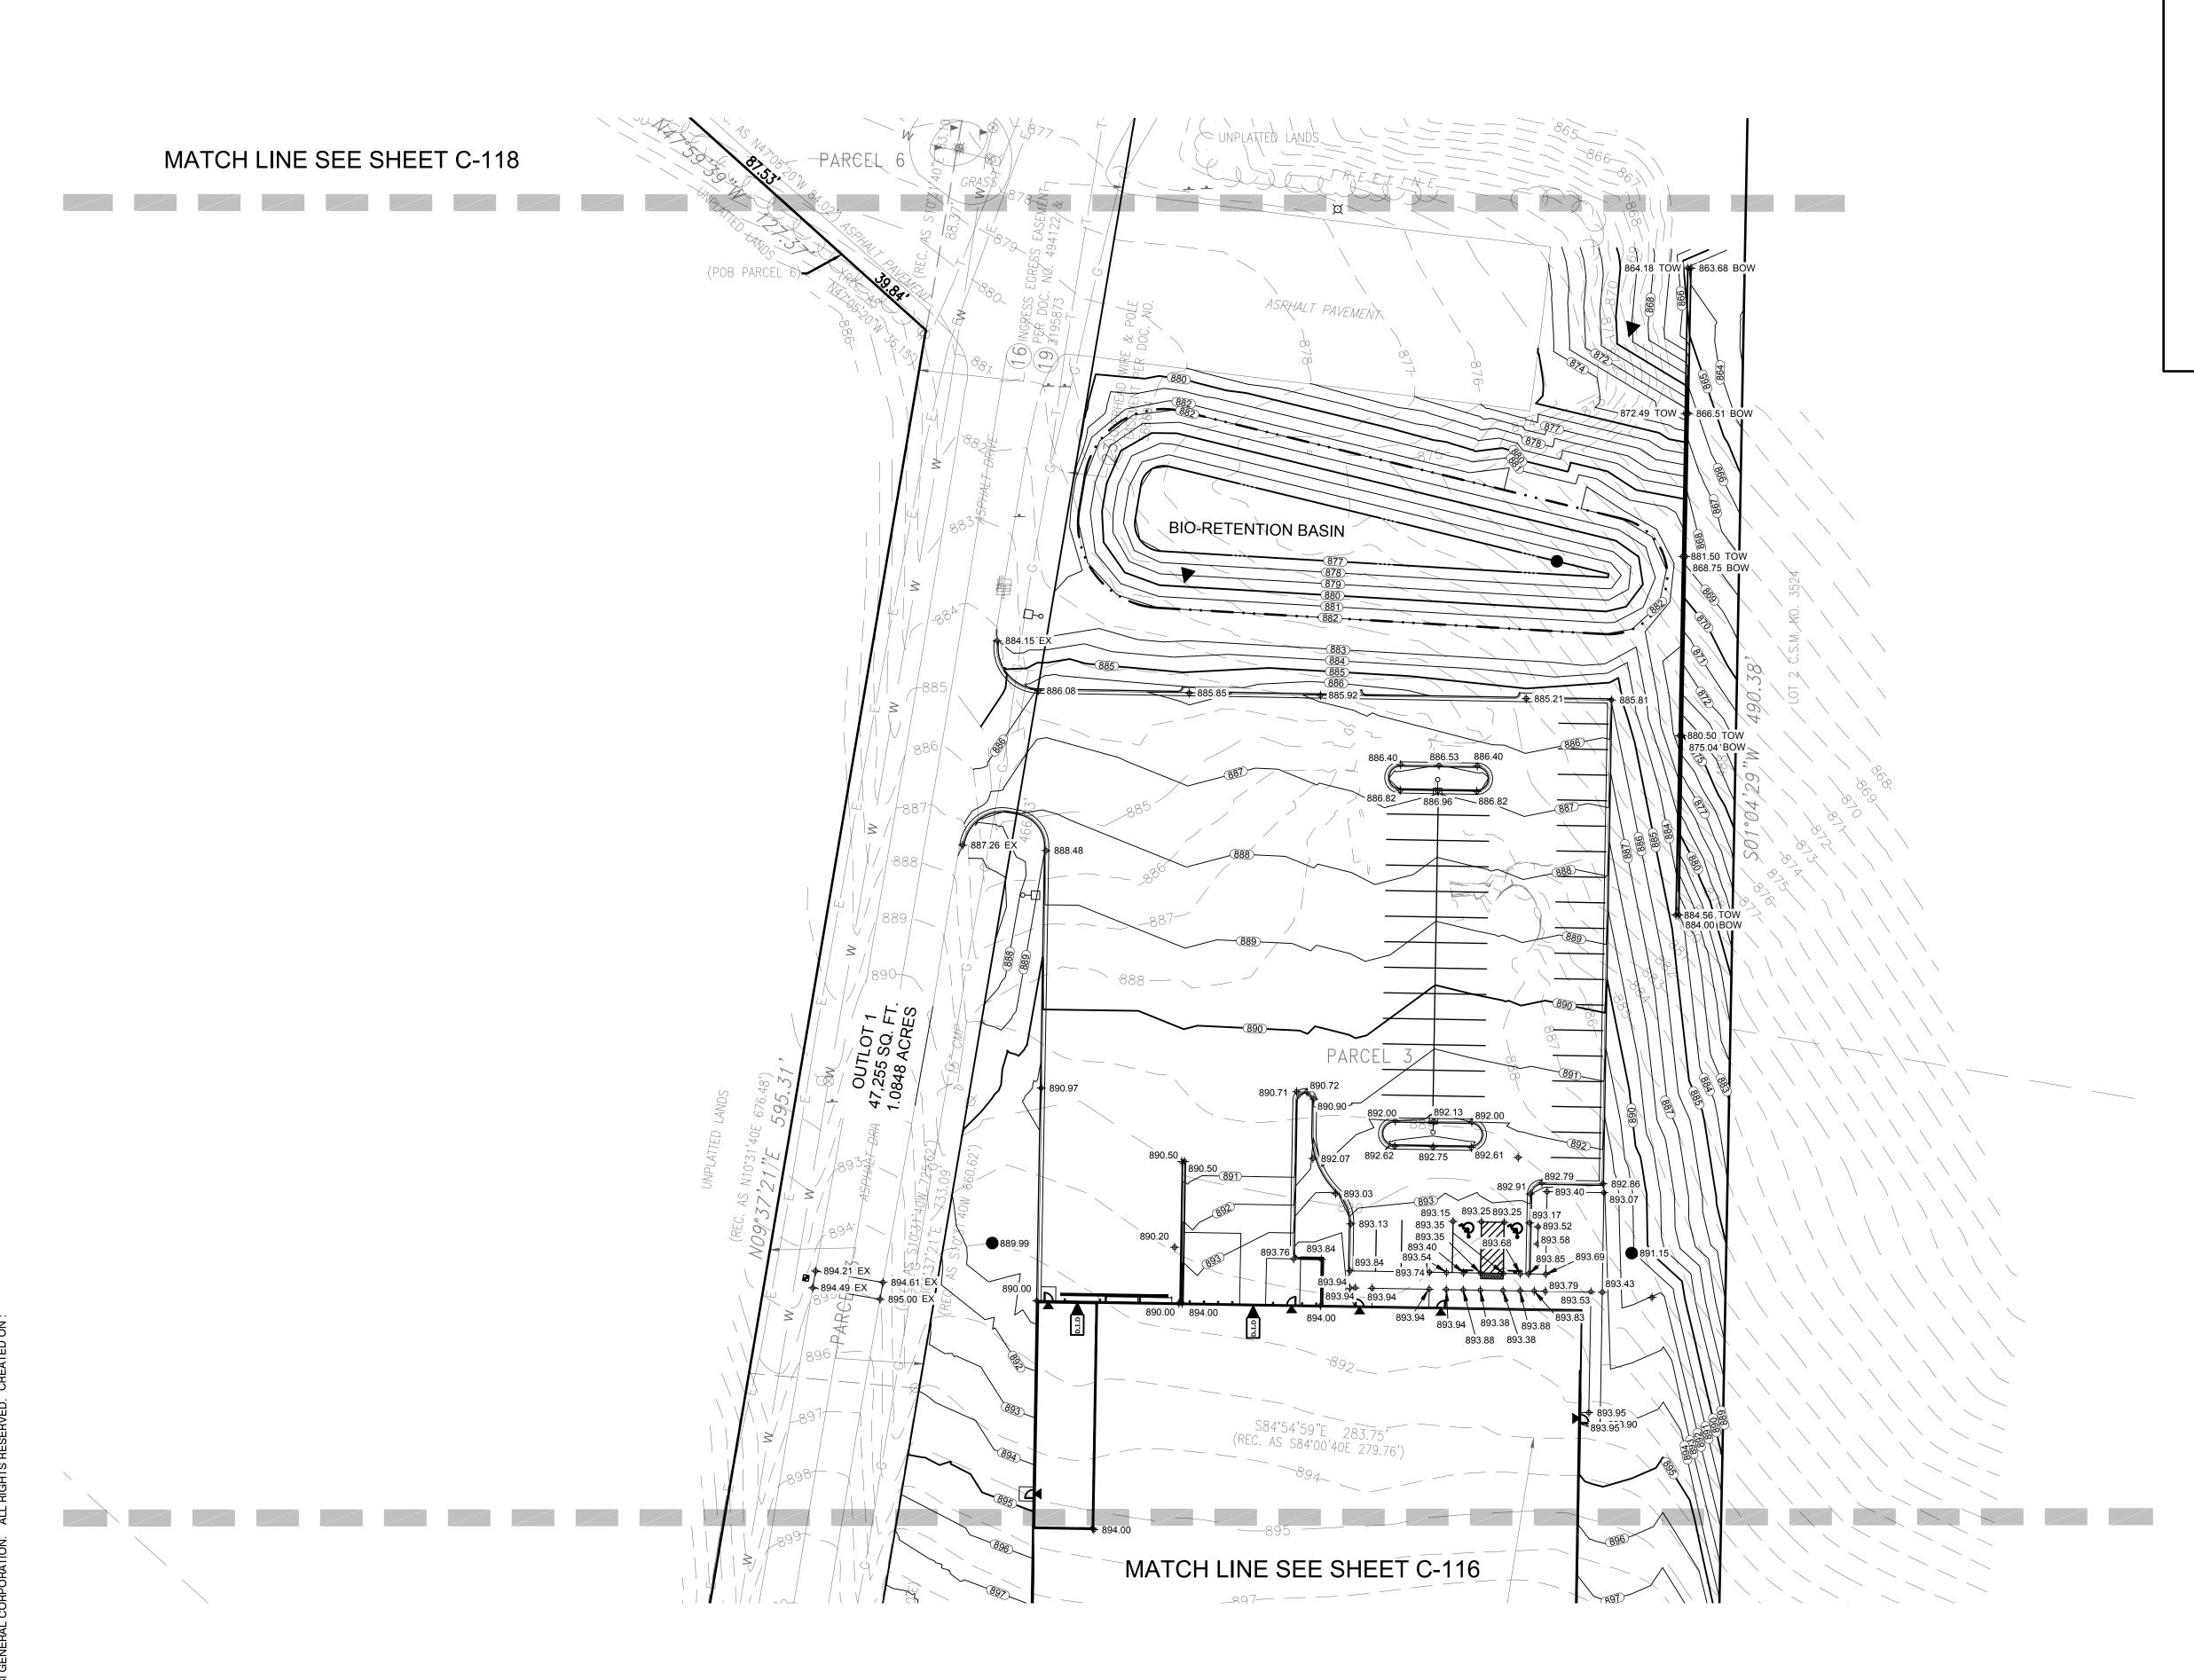

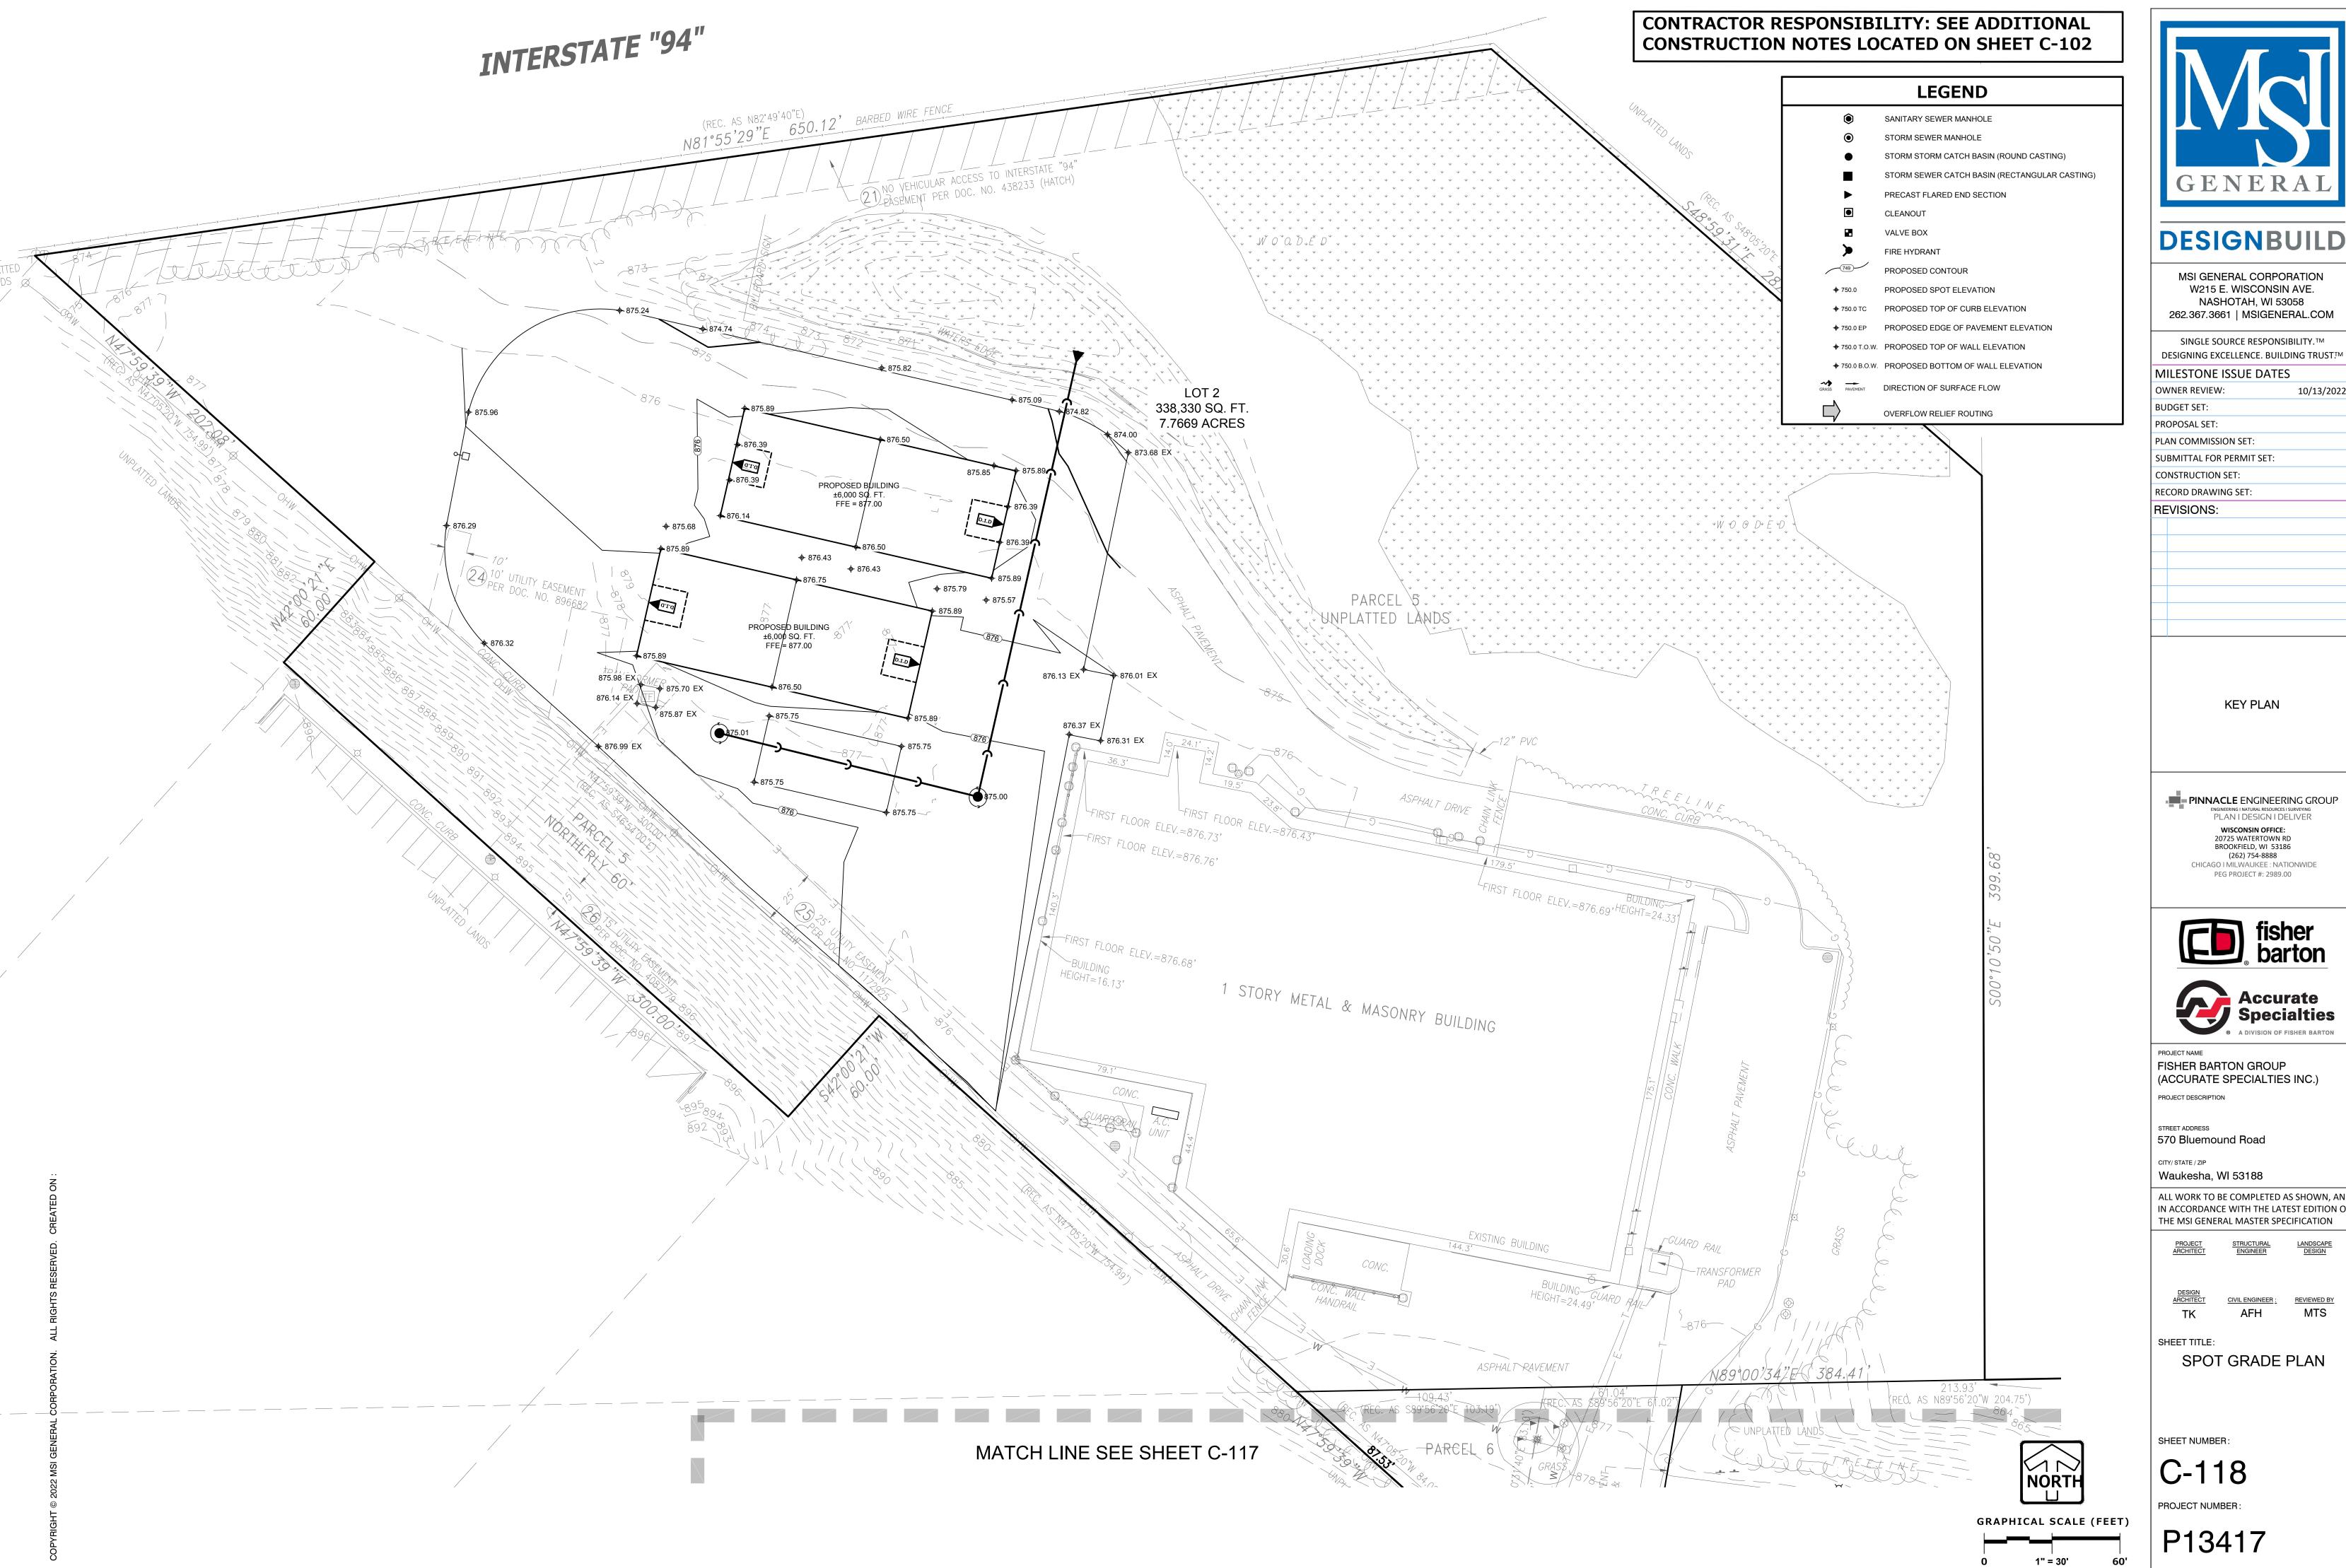



LEADERS

ENGINEERS

MSI GENERAL CORPORATION W215 E. WISCONSIN AVE. NASHOTAH, WI 53058 262.367.3661 | MSIGENERAL.COM

SINGLE SOURCE RESPONSIBILITY.™ DESIGNING EXCELLENCE. BUILDING TRUST.TM MILESTONE ISSUE DATES 10/13/2022

PLAN COMMISSION SET: SUBMITTAL FOR PERMIT SET: RECORD DRAWING SET:

PINNACLE ENGINEERING GROUP ENGINEERING I NATURAL RESOURCES I SURVEYING PLAN I DESIGN I DELIVER WISCONSIN OFFICE: 20725 WATERTOWN RD BROOKFIELD, WI 53186 (262) 754-8888



FISHER BARTON GROUP

(ACCURATE SPECIALTIES INC.)

570 Bluemound Road

Waukesha, WI 53188 ALL WORK TO BE COMPLETED AS SHOWN, AND

IN ACCORDANCE WITH THE LATEST EDITION OF THE MSI GENERAL MASTER SPECIFICATION

CIVIL ENGINEER : REVIEWED BY AFH MTS

SPOT GRADE PLAN

ARCHITECT

C-118

LEADERS

ENGINEERS

DESIGNING EXCELLENCE. BUILDING TRUST!M MILESTONE ISSUE DATES 10/13/2022

KEY PLAN

PINNACLE ENGINEERING GROUP PLAN I DESIGN I DELIVER WISCONSIN OFFICE: 20725 WATERTOWN RD BROOKFIELD, WI 53186 (262) 754-8888 CHICAGO I MILWAUKEE : NATIONWIDE PEG PROJECT #: 2989.00





(ACCURATE SPECIALTIES INC.) PROJECT DESCRIPTION

ALL WORK TO BE COMPLETED AS SHOWN, AND IN ACCORDANCE WITH THE LATEST EDITION OF THE MSI GENERAL MASTER SPECIFICATION


AFH

SHEET TITLE:

UTILITY PLAN OVERVIEW

C-119

P13417

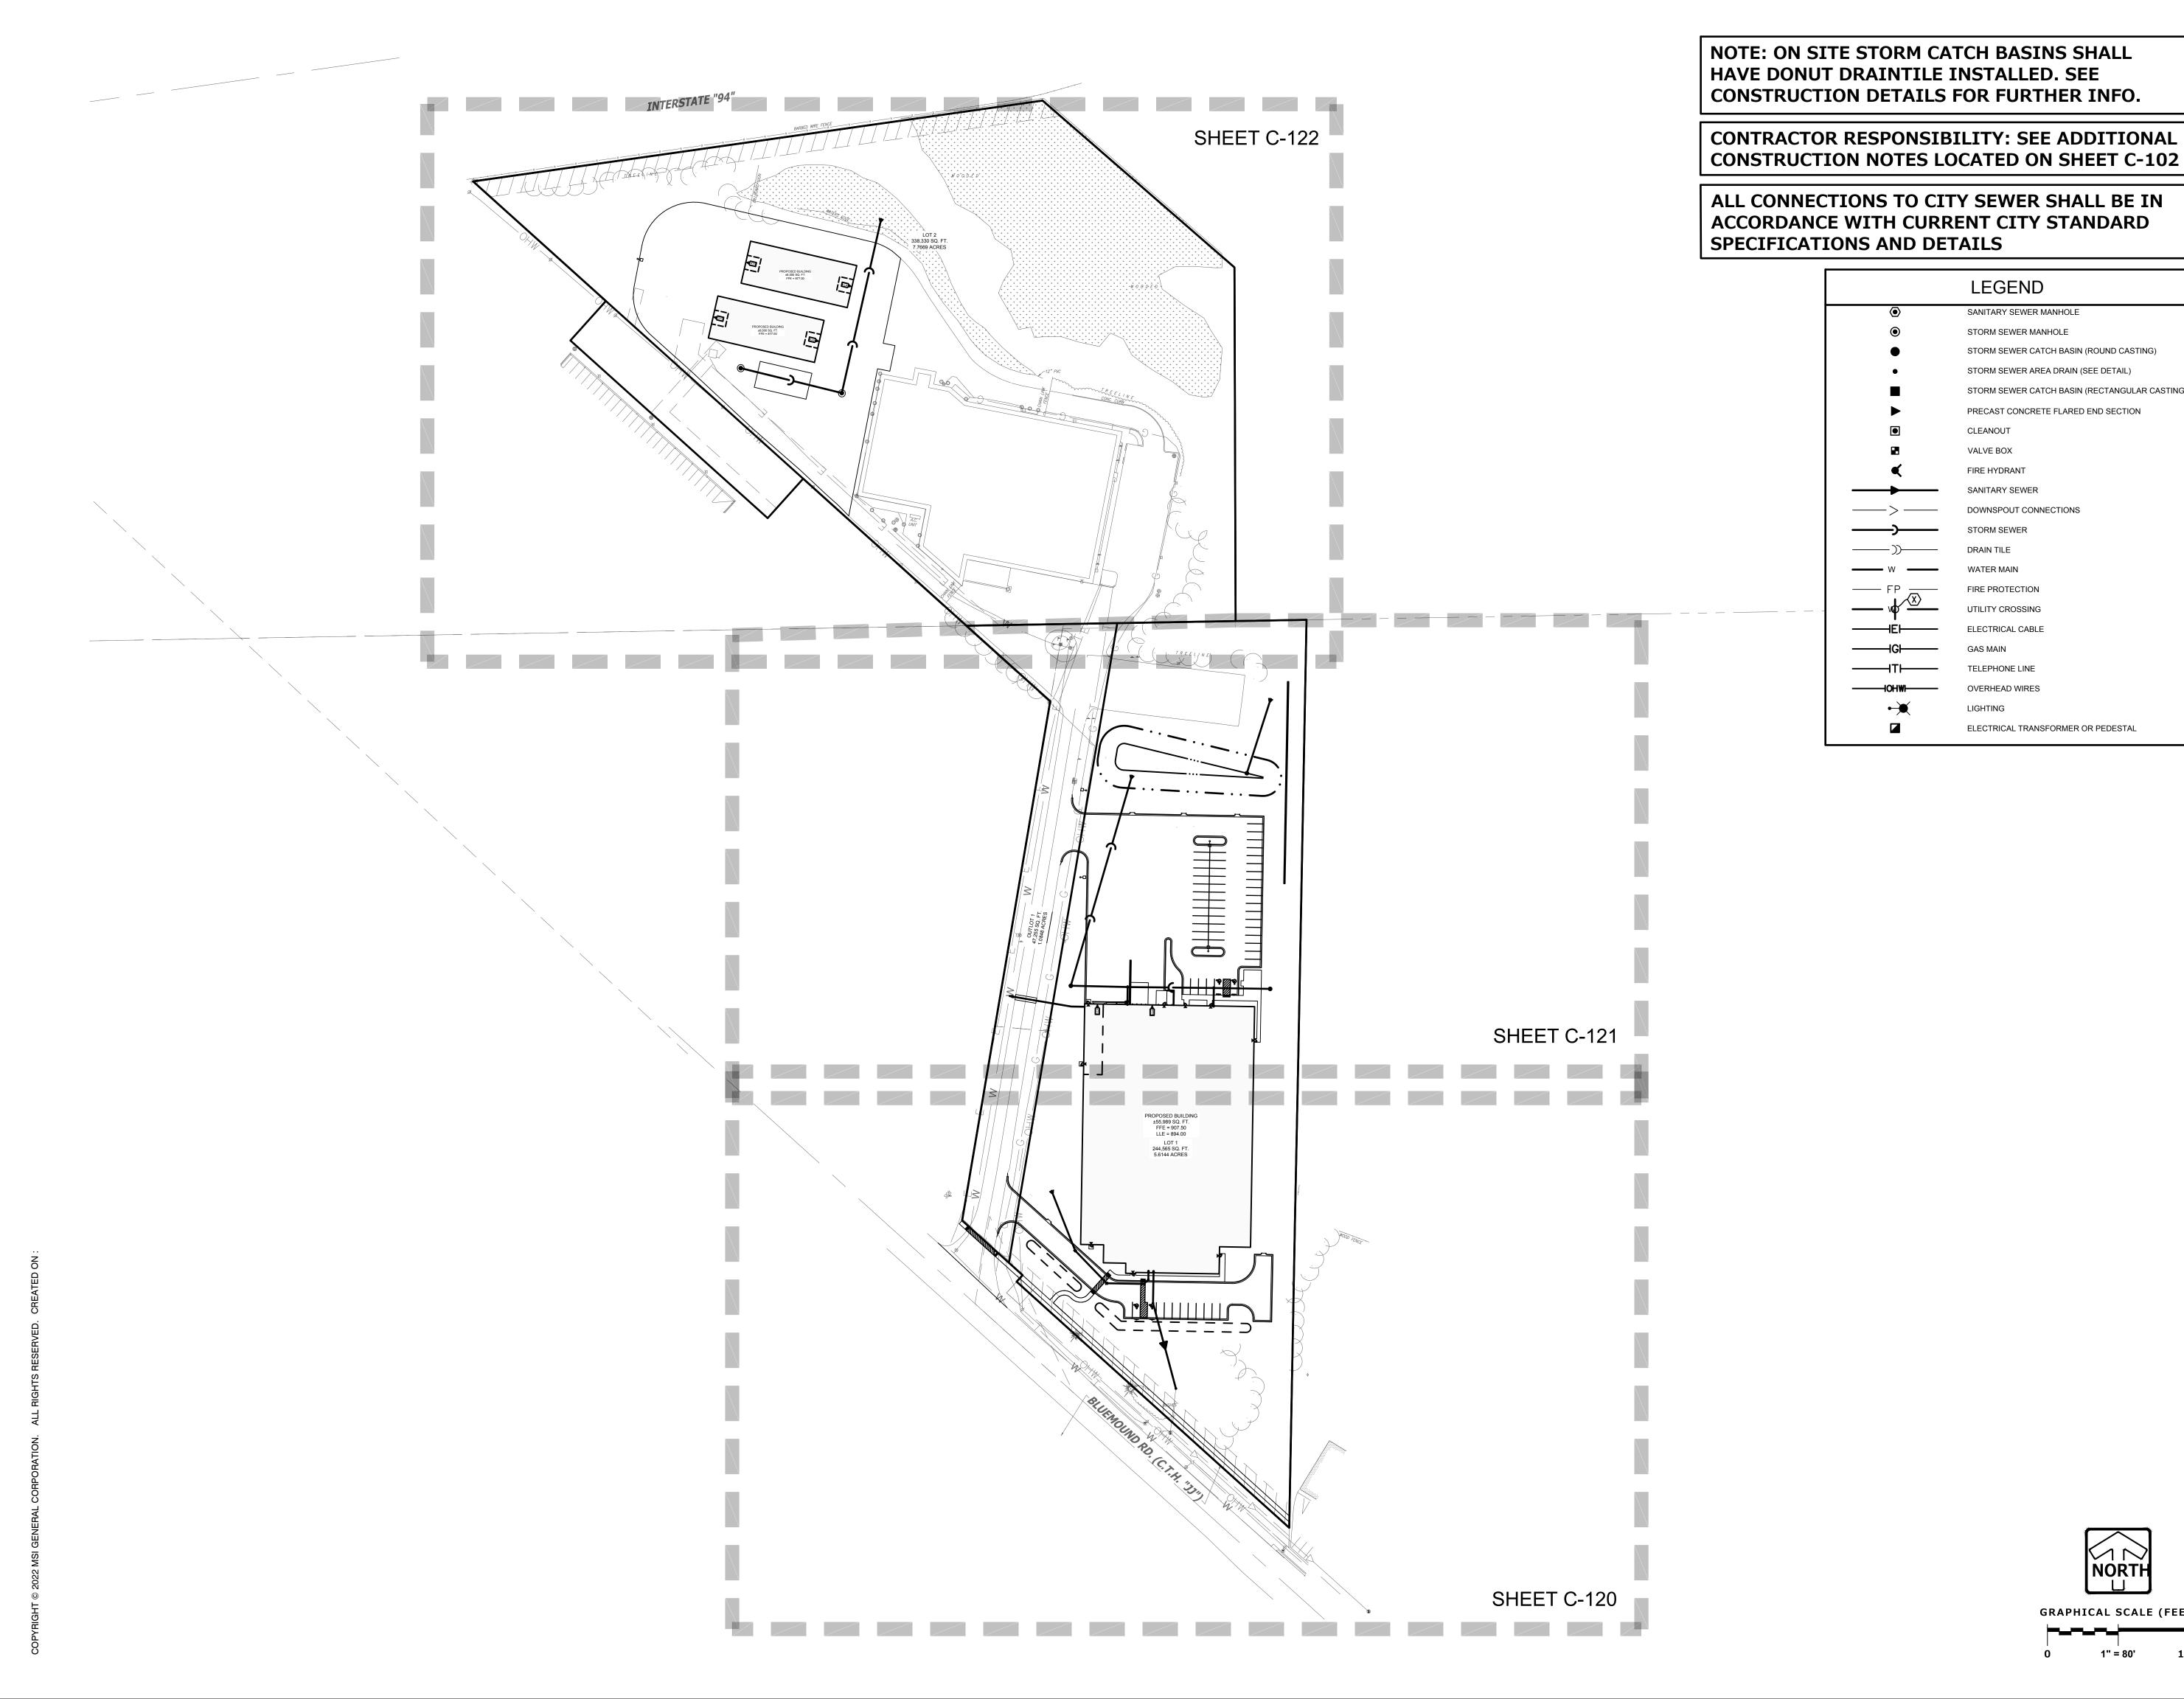

SINGLE SOURCE RESPONSIBILITY.™ STORM SEWER CATCH BASIN (RECTANGULAR CASTING) OWNER REVIEW: BUDGET SET: PROPOSAL SET: PLAN COMMISSION SET: SUBMITTAL FOR PERMIT SET: CONSTRUCTION SET: RECORD DRAWING SET: **REVISIONS:**

LEGEND

CLEANOUT

VALVE BOX

FIRE HYDRANT

STORM SEWER

DRAIN TILE

WATER MAIN

FIRE PROTECTION

UTILITY CROSSING

ELECTRICAL CABLE

TELEPHONE LINE

OVERHEAD WIRES

ELECTRICAL TRANSFORMER OR PEDESTAL

GAS MAIN

SANITARY SEWER

DOWNSPOUT CONNECTIONS

SANITARY SEWER MANHOLE

STORM SEWER CATCH BASIN (ROUND CASTING)

STORM SEWER AREA DRAIN (SEE DETAIL)

PRECAST CONCRETE FLARED END SECTION

STORM SEWER MANHOLE

Accurate Specialties FISHER BARTON GROUP

STREET ADDRESS

570 Bluemound Road CITY/ STATE / ZIP

Waukesha, WI 53188

SHEET NUMBER:

PROJECT NUMBER:

GRAPHICAL SCALE (FEET)

1" = 80'



CONTRACTORS

ARCHITECTS



(ACCURATE SPECIALTIES INC.)

STREET ADDRESS

FISHER BARTON GROUP

570 Bluemound Road

Waukesha, WI 53188

ALL WORK TO BE COMPLETED AS SHOWN, AND IN ACCORDANCE WITH THE LATEST EDITION OF THE MSI GENERAL MASTER SPECIFICATION

DESIGN ARCHITECT TK CIVIL ENGINEER : **AFH** REVIEWED BY MTS

SHEET TITLE:


UTILITY PLAN

SHEET NUMBER:

GRAPHICAL SCALE (FEET)

C-120

PROJECT NUMBER:

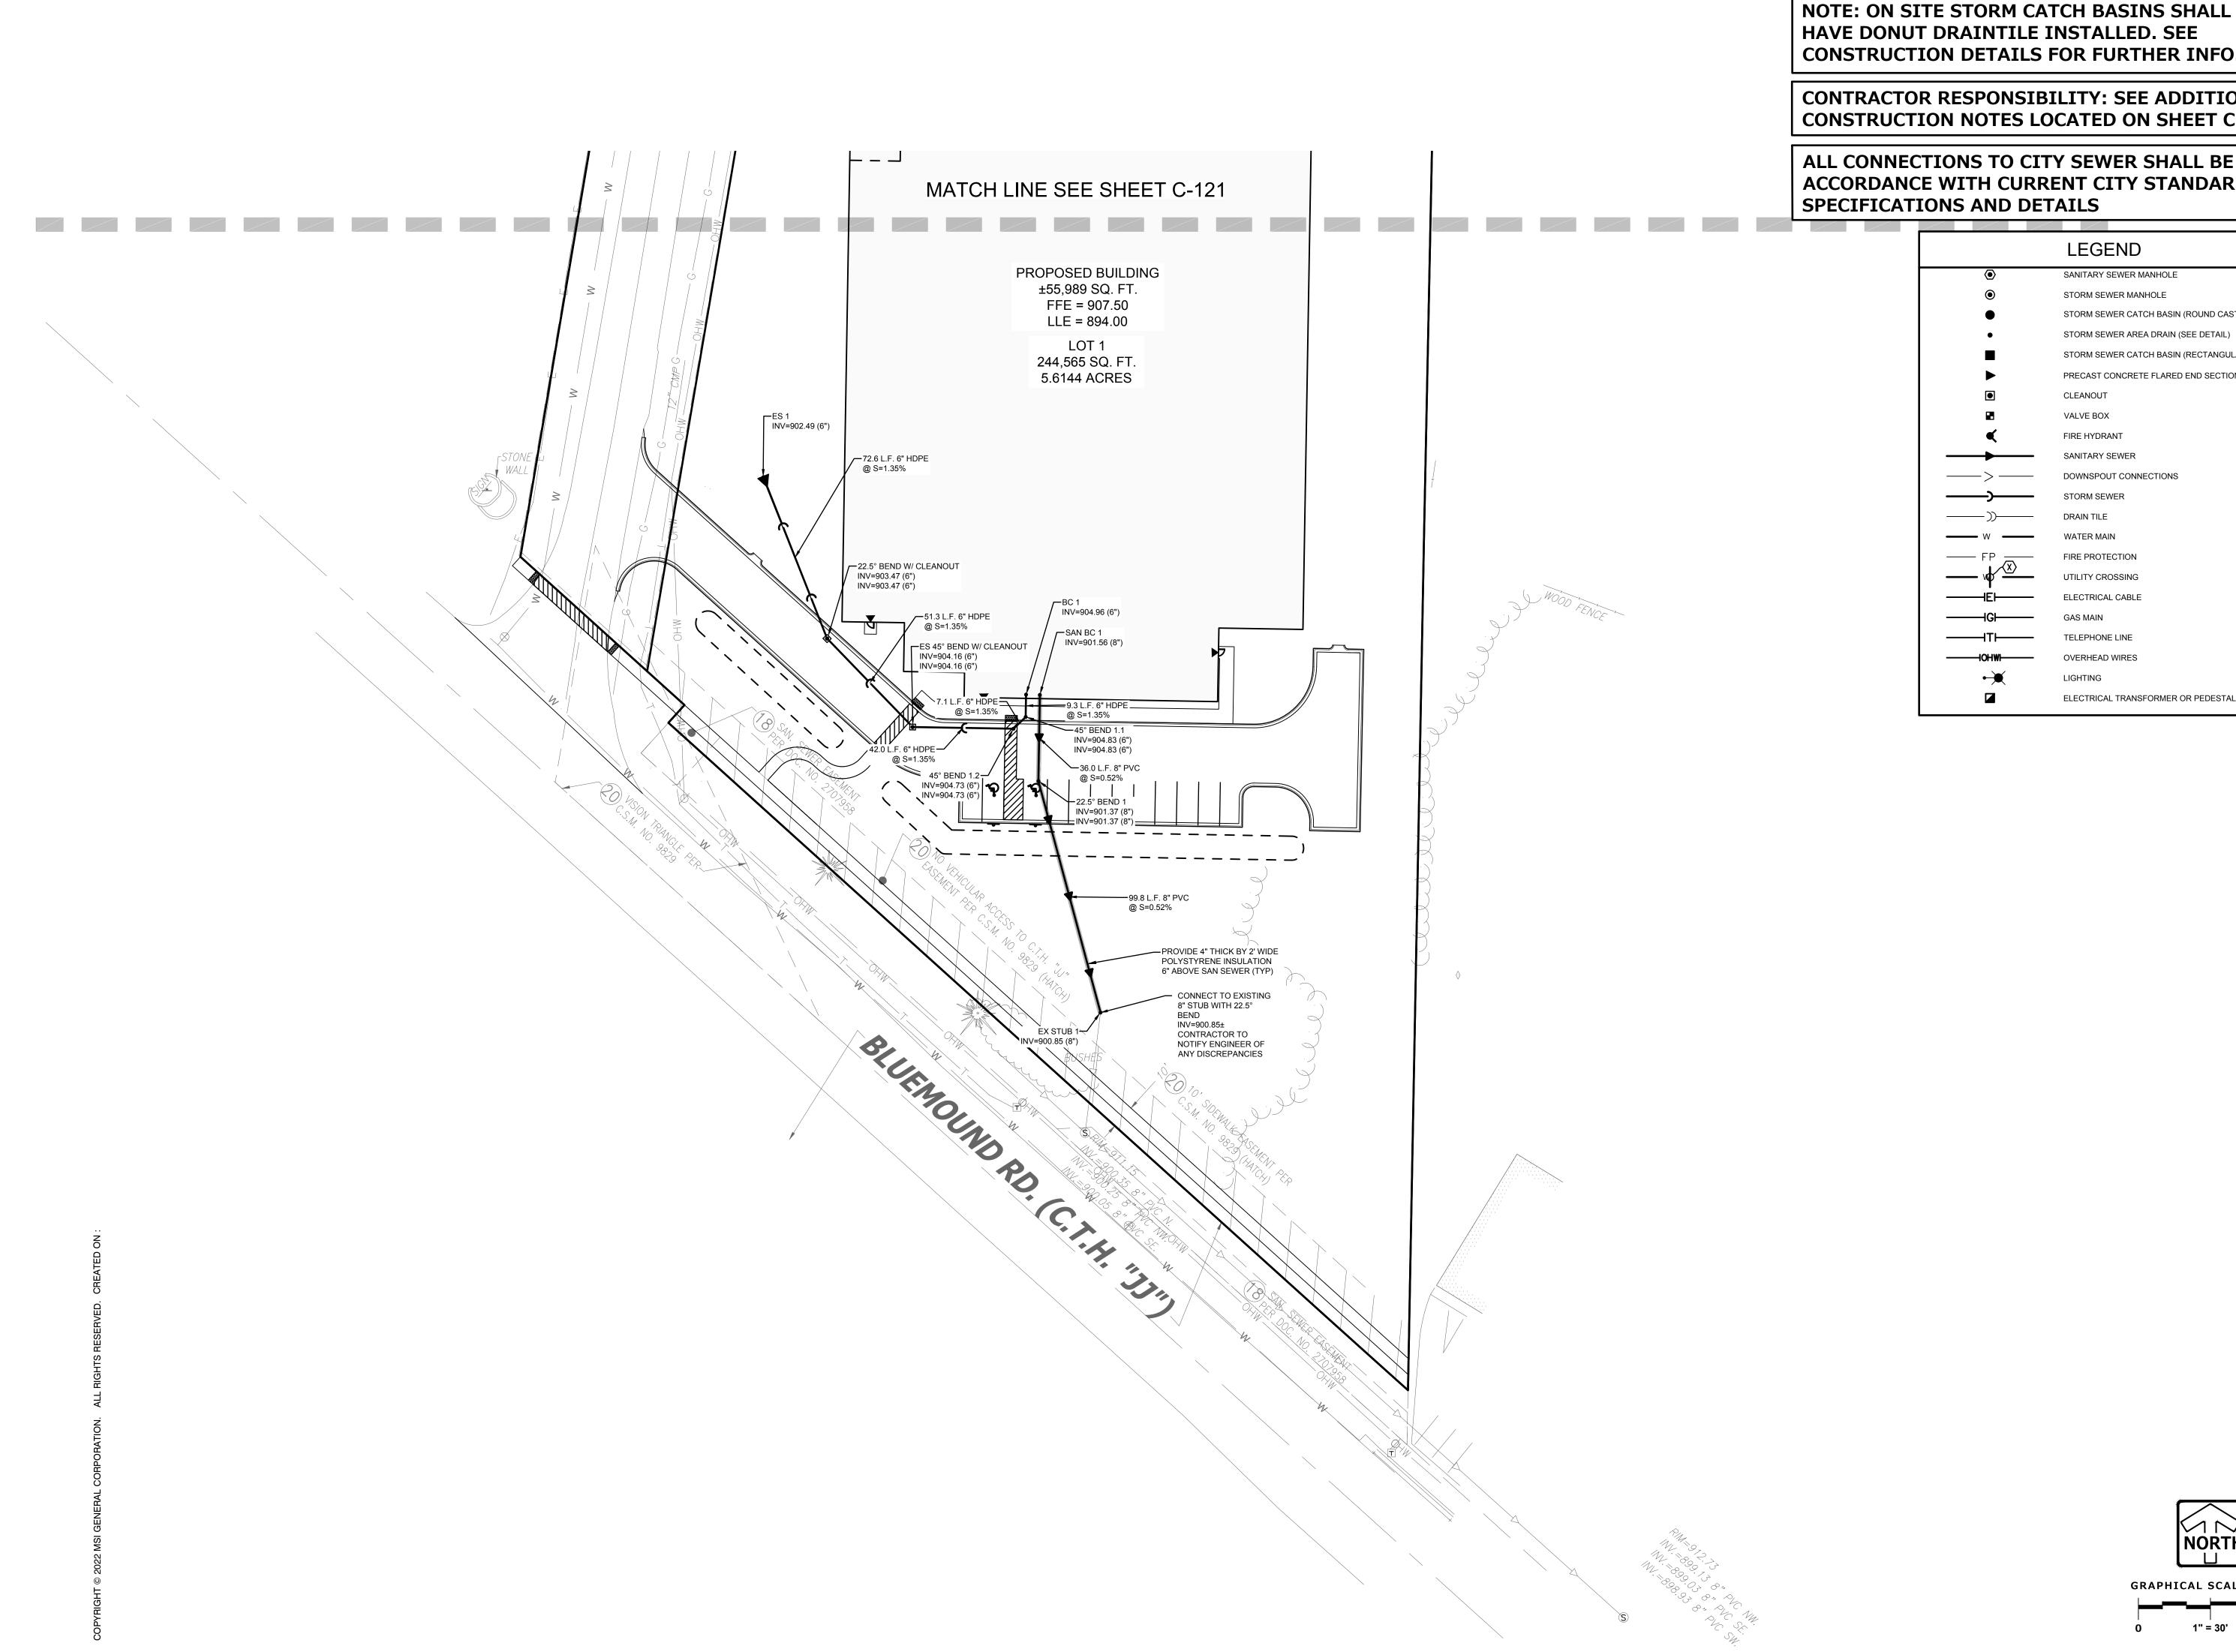



NASHOTAH, WI 53058

262.367.3661 | MSIGENERAL.COM

SINGLE SOURCE RESPONSIBILITY.™

DESIGNING EXCELLENCE. BUILDING TRUST.TM

OWNER REVIEW:

PLAN COMMISSION SET:

CONSTRUCTION SET:

REVISIONS:

RECORD DRAWING SET:

SUBMITTAL FOR PERMIT SET:

BUDGET SET: PROPOSAL SET:

ENGINEERS

KEY PLAN



PEG PROJECT #: 2989.00



FISHER BARTON GROUP (ACCURATE SPECIALTIES INC.) PROJECT DESCRIPTION

STREET ADDRESS 570 Bluemound Road

CITY/ STATE / ZIP Waukesha, WI 53188

ALL WORK TO BE COMPLETED AS SHOWN, AND IN ACCORDANCE WITH THE LATEST EDITION OF THE MSI GENERAL MASTER SPECIFICATION

CIVIL ENGINEER :

MTS AFH ΤK SHEET TITLE:


ARCHITECT


UTILITY PLAN

SHEET NUMBER:

PROJECT NUMBER:

P13417

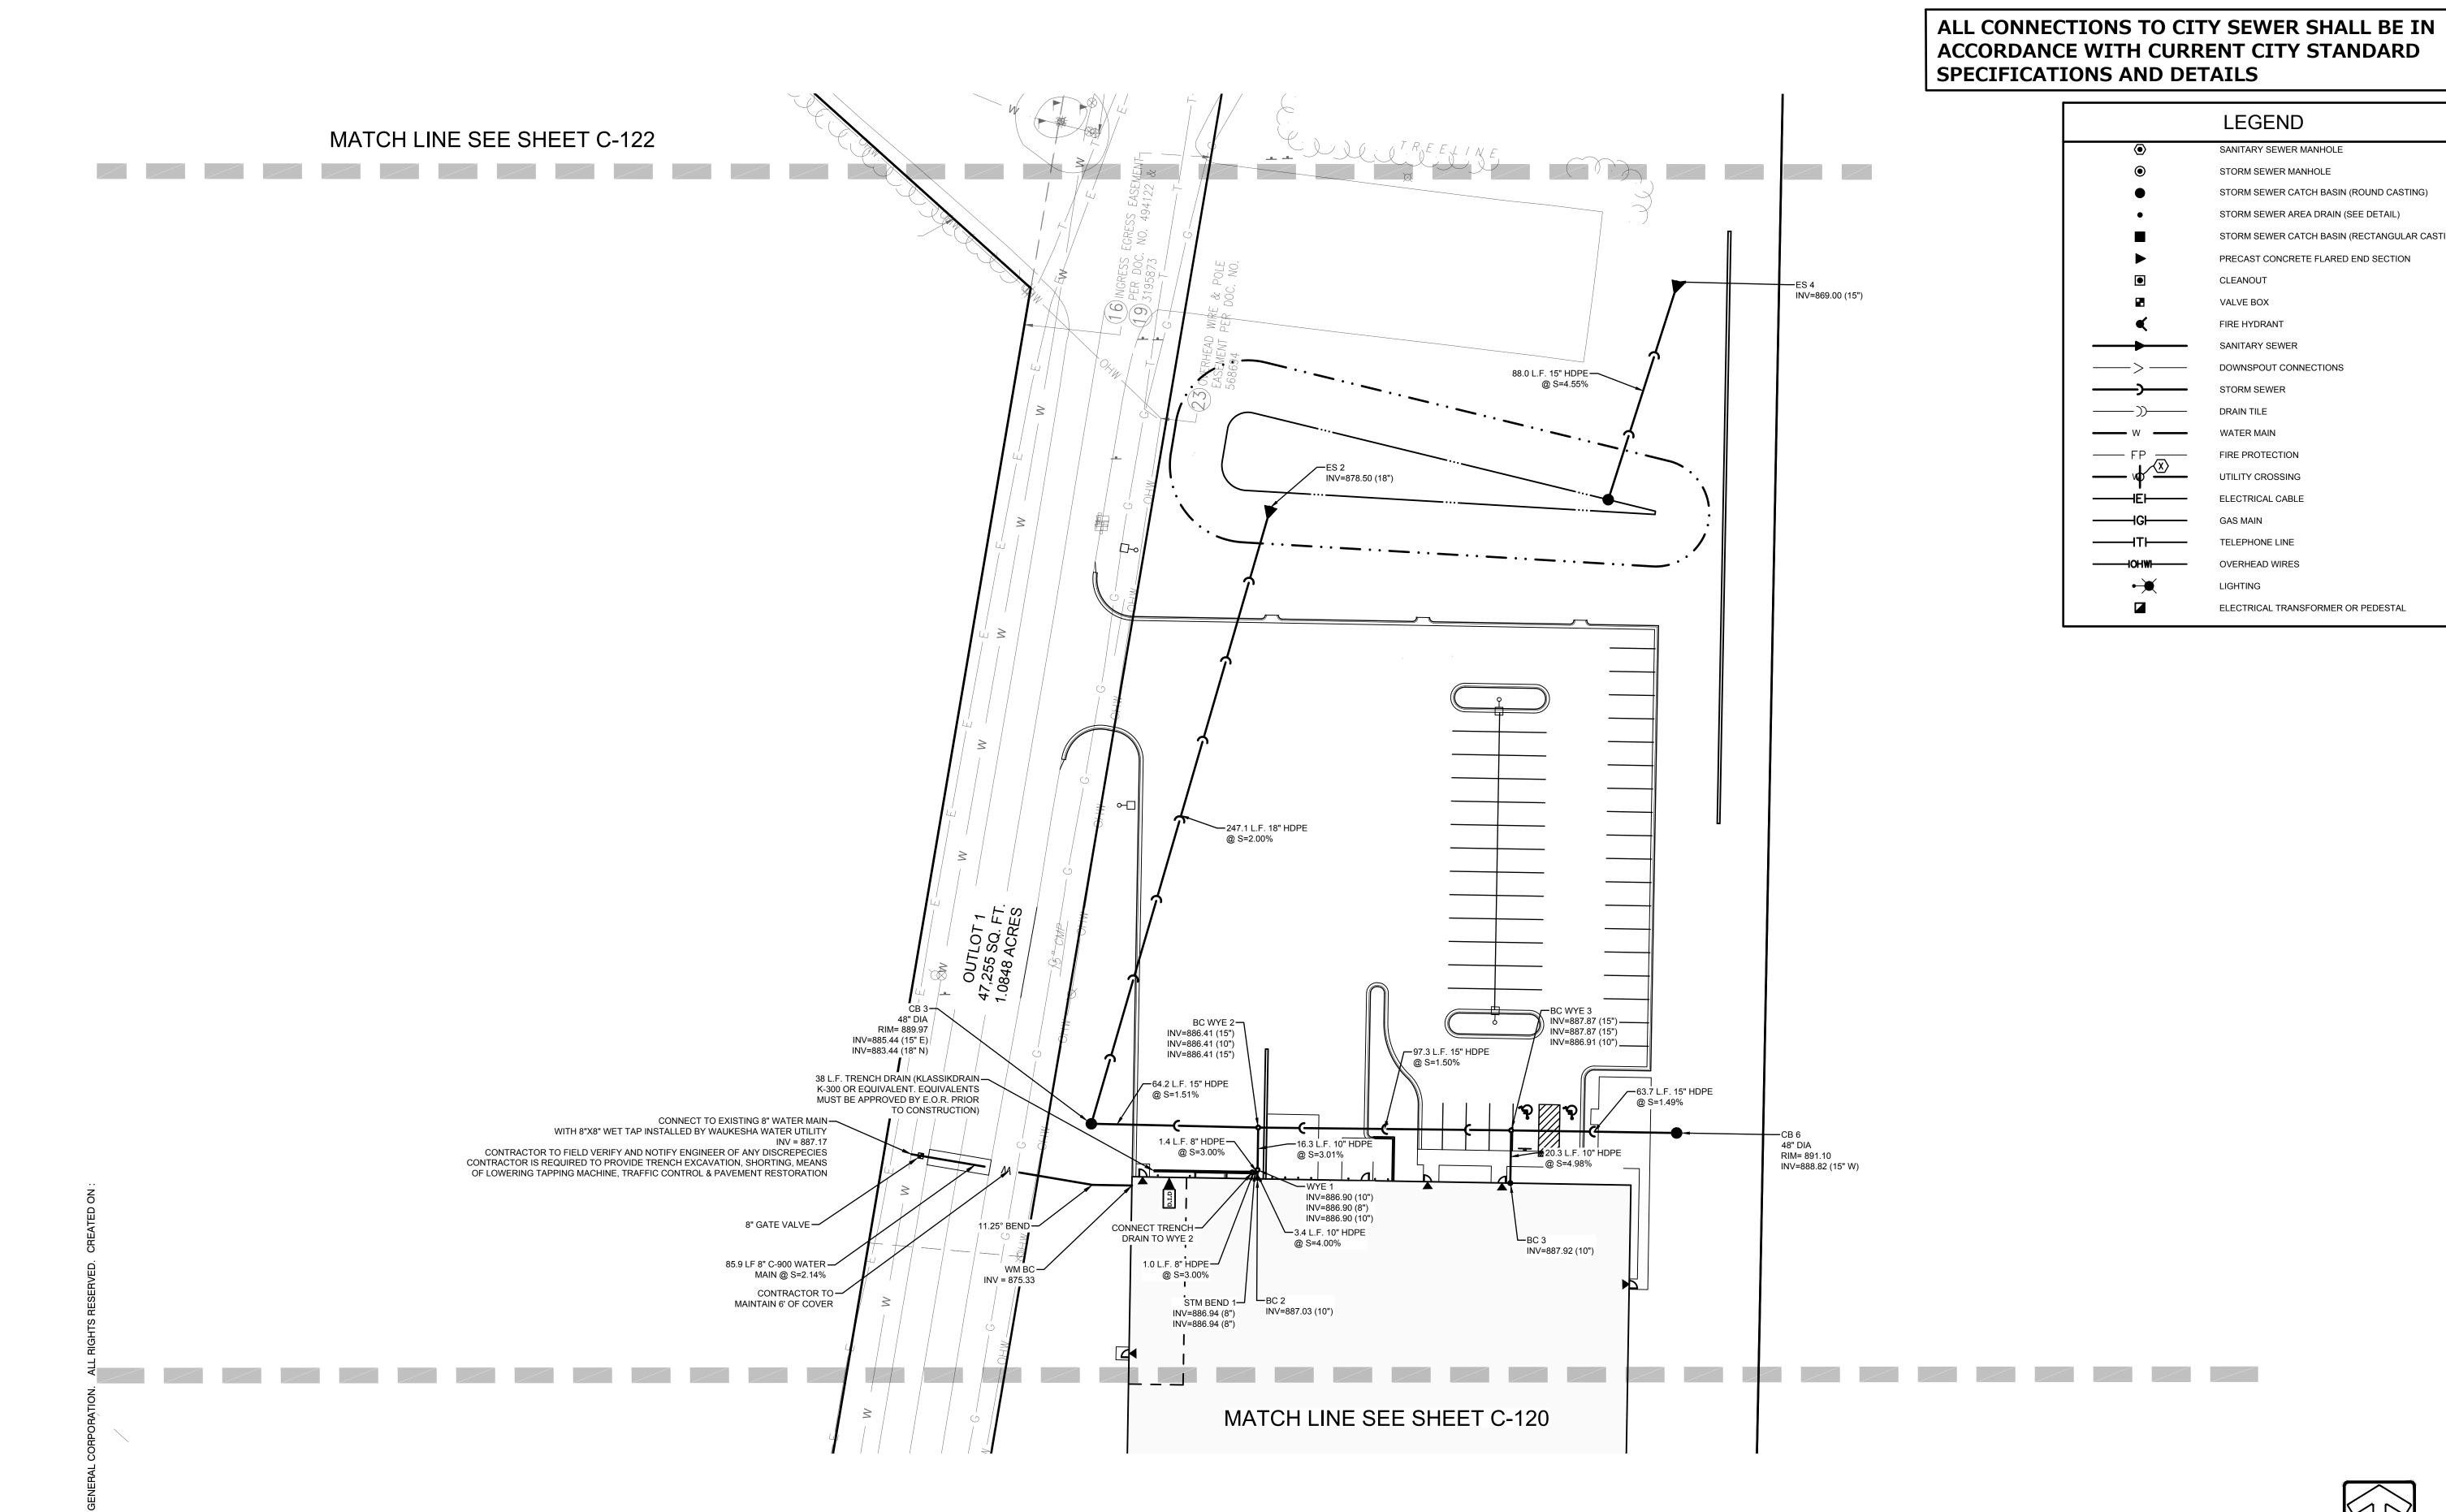

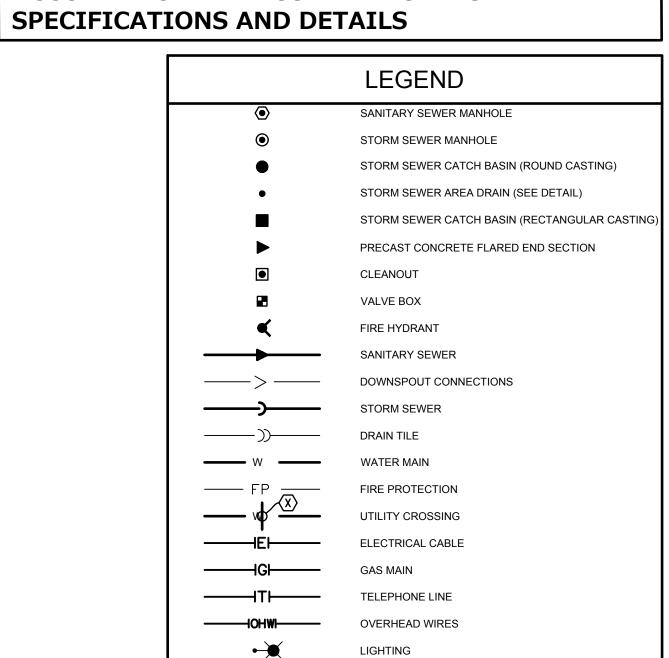

ELECTRICAL TRANSFORMER OR PEDESTAL


NOTE: ON SITE STORM CATCH BASINS SHALL


CONSTRUCTION DETAILS FOR FURTHER INFO.

CONTRACTOR RESPONSIBILITY: SEE ADDITIONAL

CONSTRUCTION NOTES LOCATED ON SHEET C-102

HAVE DONUT DRAINTILE INSTALLED. SEE

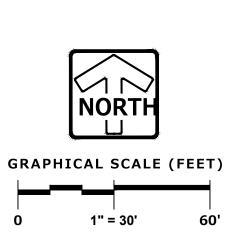

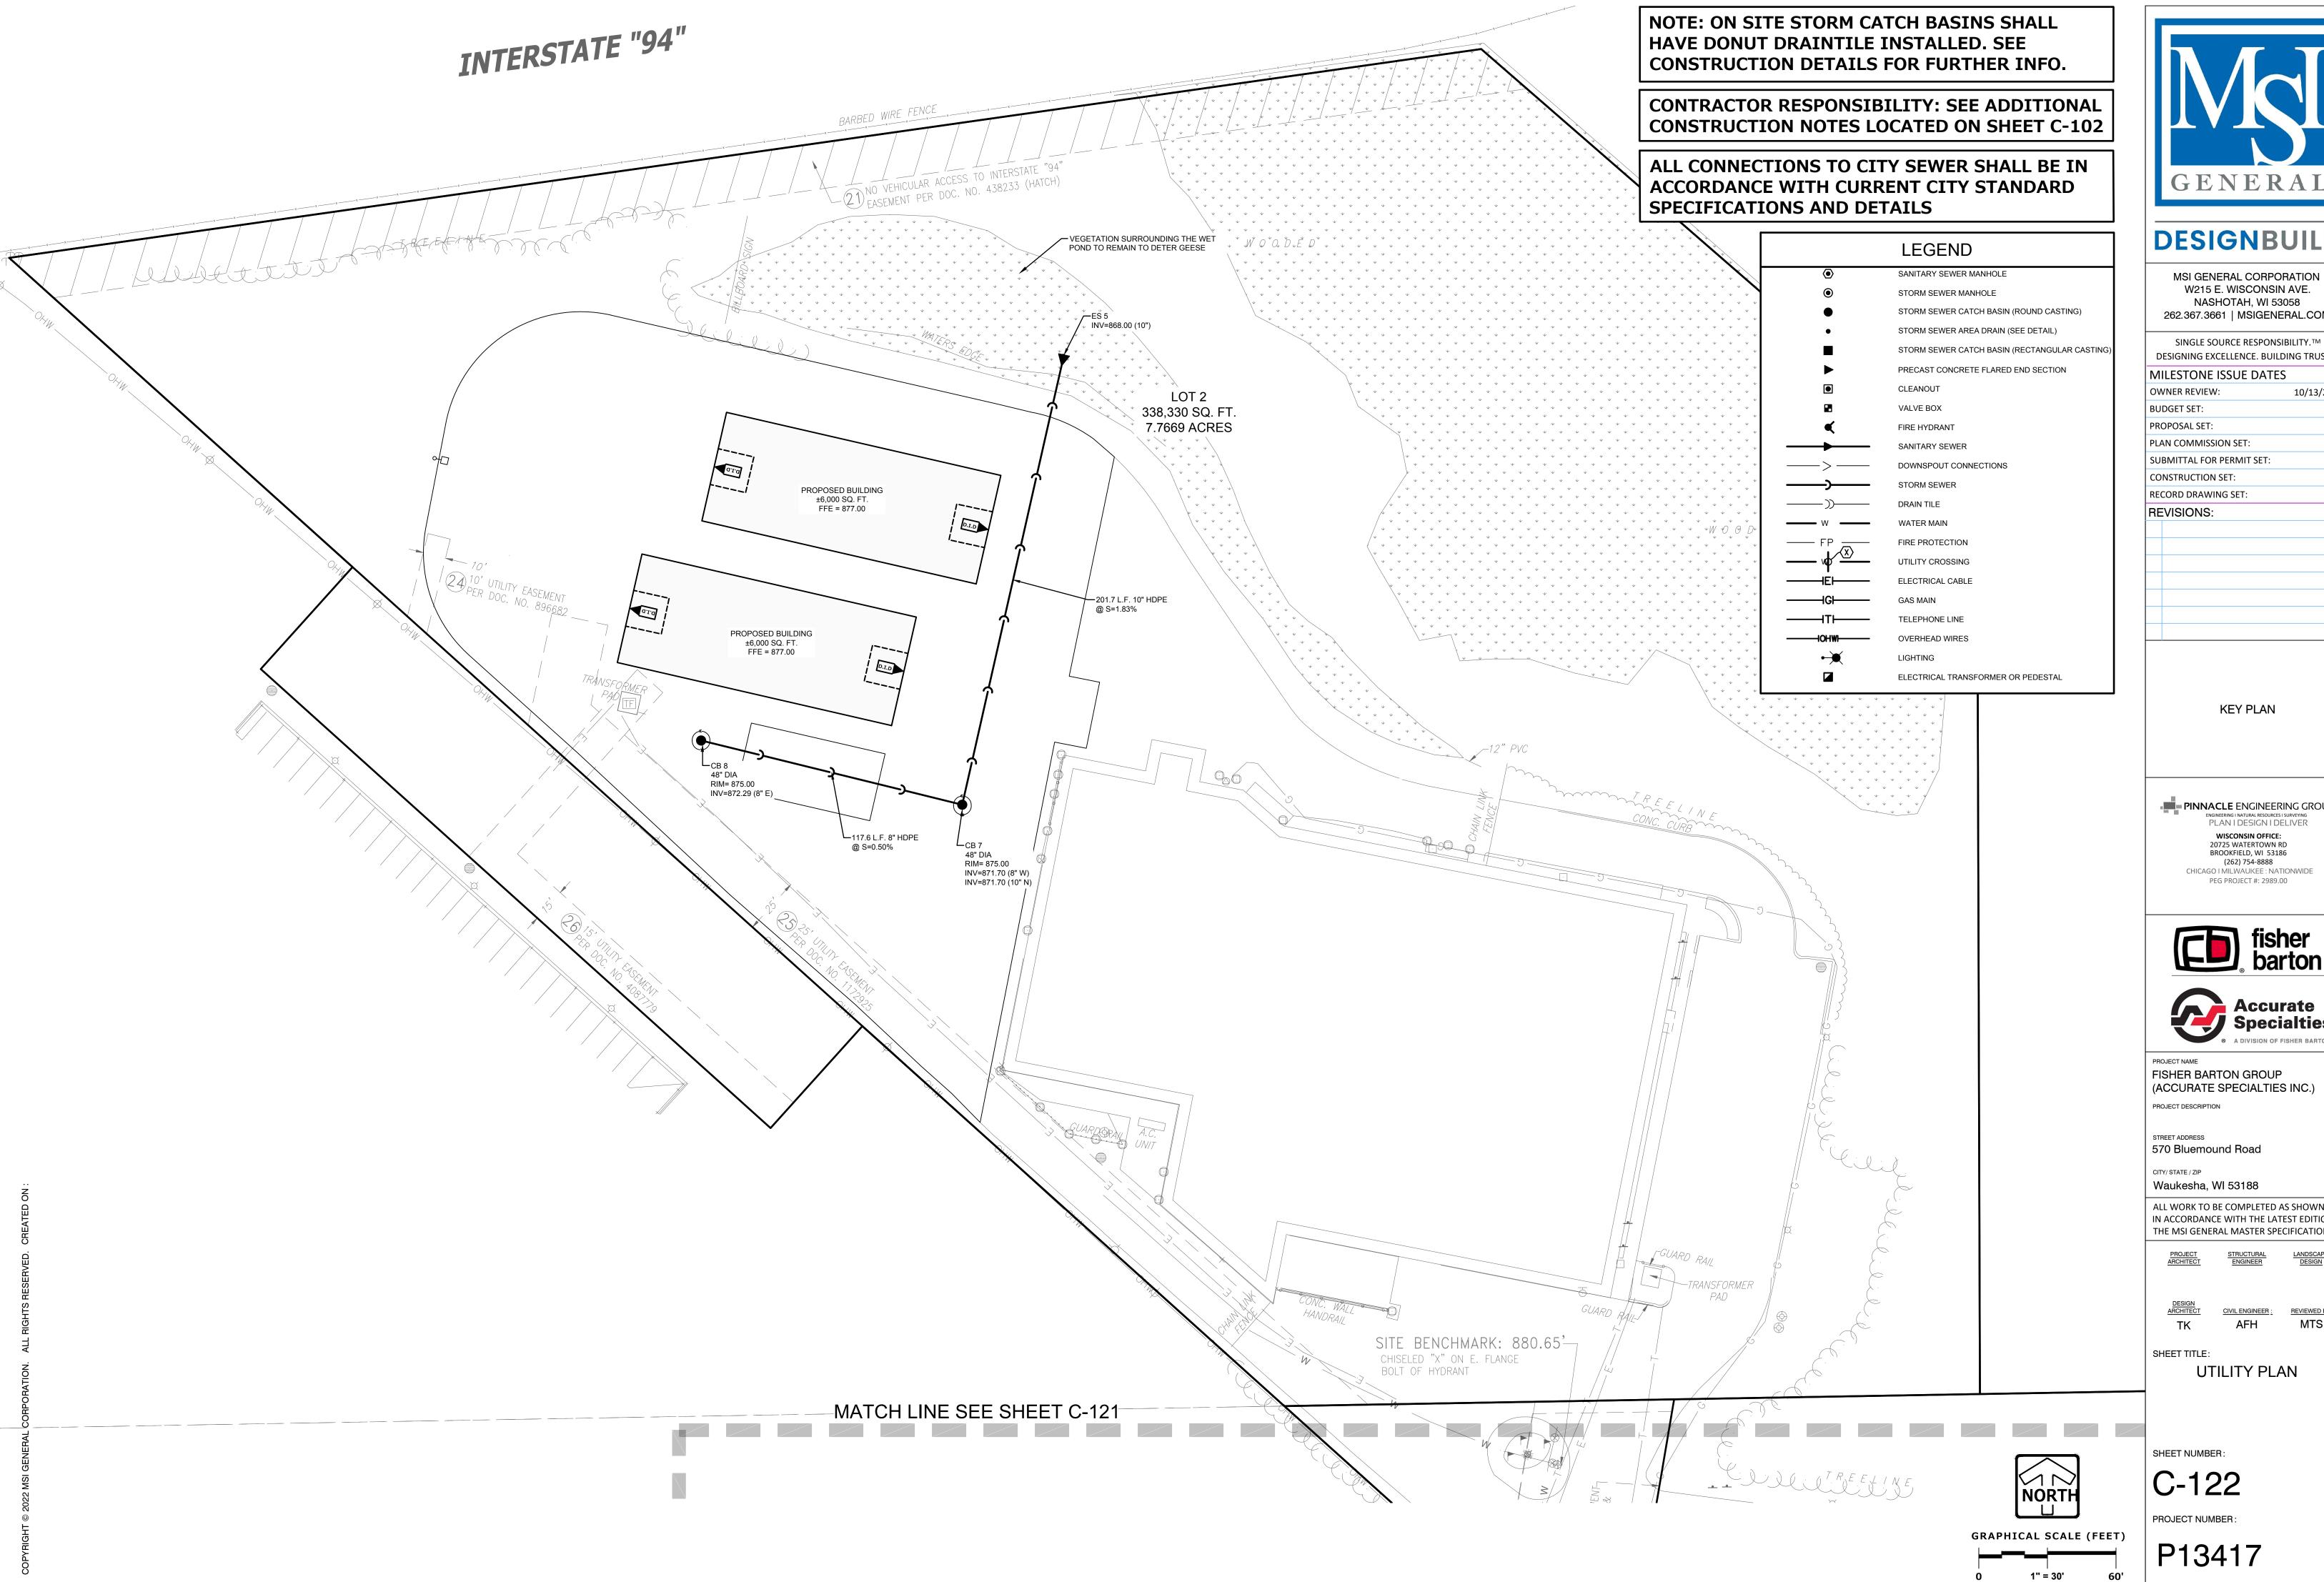



LEADERS

ENGINEERS

CONTRACTORS

ARCHITECT

MSI GENERAL CORPORATION W215 E. WISCONSIN AVE. NASHOTAH, WI 53058 262.367.3661 | MSIGENERAL.COM

DESIGNING EXCELLENCE. BUILDING TRUST.TM MILESTONE ISSUE DATES 10/13/2022

PINNACLE ENGINEERING GROUP PLAN I DESIGN I DELIVER WISCONSIN OFFICE: 20725 WATERTOWN RD BROOKFIELD, WI 53186 (262) 754-8888 CHICAGO I MILWAUKEE : NATIONWIDE





FISHER BARTON GROUP (ACCURATE SPECIALTIES INC.)

ALL WORK TO BE COMPLETED AS SHOWN, AND IN ACCORDANCE WITH THE LATEST EDITION OF THE MSI GENERAL MASTER SPECIFICATION

CIVIL ENGINEER : MTS

UTILITY PLAN

10/13/2022

DESIGNBUILD

MSI GENERAL CORPORATION

W215 E. WISCONSIN AVE.

NASHOTAH, WI 53058

262.367.3661 | MSIGENERAL.COM

SINGLE SOURCE RESPONSIBILITY.™

DESIGNING EXCELLENCE. BUILDING TRUST.TM

KEY PLAN

PINNACLE ENGINEERING GROUP

WISCONSIN OFFICE:

20725 WATERTOWN RD BROOKFIELD, WI 53186

(262) 754-8888

PEG PROJECT #: 2989.00

MILESTONE ISSUE DATES

OWNER REVIEW:

BUDGET SET:

PROPOSAL SET:

REVISIONS:

PLAN COMMISSION SET:

CONSTRUCTION SET: RECORD DRAWING SET:

SUBMITTAL FOR PERMIT SET:

L*= 3 TIMES PIPE DIAMETER (TYP.) OR 10

FOOT MIN. OR AS DIRECTED BY THI

DETECTABLE WARNING FIELD (TYPICAL)**

ELEVATION VIEW

PLAN VIEW

PREPARE SOIL BEFORE INSTALLING BLANKETS, INCLUDING ANY NECESSARY APPLICATION OF LIME, FERTILIZER, AND SEED.

NOTE: WHEN USING CELL-O-SEED DO NOT SEED PREPARED AREA. CELL-O-SEED MUST BE INSTALLED WITH PAPER SIDE DOWN.

BEGIN AT THE TOP OF THE SLOPE BY ANCHORING THE BLANKET IN A 6" (15 CM) DEEP X 6" (15 CM) WIDE TRENCH WITH APPROXIMATELY 12" (30cm) OF BLANKET EXTENDED BEYOND THE UP-SLOPE PORTION OF THE TRENCH. ANCHOR THE BLANKET WITH A ROW OF STAPLES/STAKES APPROXIMATELY 12" (30 CM) APART IN THE BOTTOM OF THE TRENCH. BACKFILL AND COMPACT THE TRENCH AFTER STAPLING. APPLY SEED TO COMPACTED SOIL AND FOLD REMAINING 12" (30 CM) PORTION OF BLANKET BACK OVER SEED AND COMPACTED SOIL. SECURE BLANKET OVER COMPACTED SOIL WITH A ROW OF STAPLES/STAKES SPACED APPROXIMATELY 12" (30 CM) APART ACROSS THE WIDTH OF THE BLANKET.

ROLL THE BLANKETS (A.) DOWN OR (B.) HORIZONTALLY ACROSS THE SLOPE. BLANKETS WILL UNROLL WITH APPROPRIATE SIDE AGAINST THE SOIL SURFACE. ALL BLANKETS MUST BE SECURELY FASTENED TO SOIL SURFACE BY PLACING STAPLES/STAKES IN APPROPRIATE LOCATIONS AS SHOWN IN THE STAPLE PATTERN GUIDE. WHEN USING THE DOT SYSTEM, STAPLES/STAKES SHOULD BE PLACED THROUGH EACH OF THE COLORED DOTS CORRESPONDING TO THE APPROPRIATE STAPLE PATTERN.

THE EDGES OF PARALLEL BLANKETS MUST BE STAPLED WITH APPROXIMATELY 2" - 5" (5 CM - 12.5 CM) OVERLAP DEPENDING ON

CONSECUTIVE BLANKETS SPLICED DOWN THE SLOPE MUST BE PLACED END OVER END (SHINGLE STYLE) WITH AN APPROXIMATE 3" (7.5 CM) OVERLAP. STAPLE THROUGH OVERLAPPED AREA, APPROXIMATELY 12" (30 CM) APART ACROSS ENTIRE BLANKET WIDTH.

NOTE: 'IN LOOSE SOIL CONDITIONS, THE USE OF STAPLE OR STAKE LENGTHS GREATER THAN 6" (15 CM) MAY BE NECESSARY TO PROPERLY SECURE THE BLANKETS.

EROSION MATTING - SLOPE INSTALLATION

570 Bluemound Road

CITY/ STATE / ZIP

Waukesha, WI 53188 ALL WORK TO BE COMPLETED AS SHOWN, AND

(ACCURATE SPECIALTIES INC.)

IN ACCORDANCE WITH THE LATEST EDITION OF THE MSI GENERAL MASTER SPECIFICATION

CIVIL ENGINEER: REVIEWED BY

MTS ΤK AFH

ARCHITECT


SHEET TITLE: CONSTRUCTION DETAILS


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PROJECT NUMBER:

SHEET NUMBER:

P13417



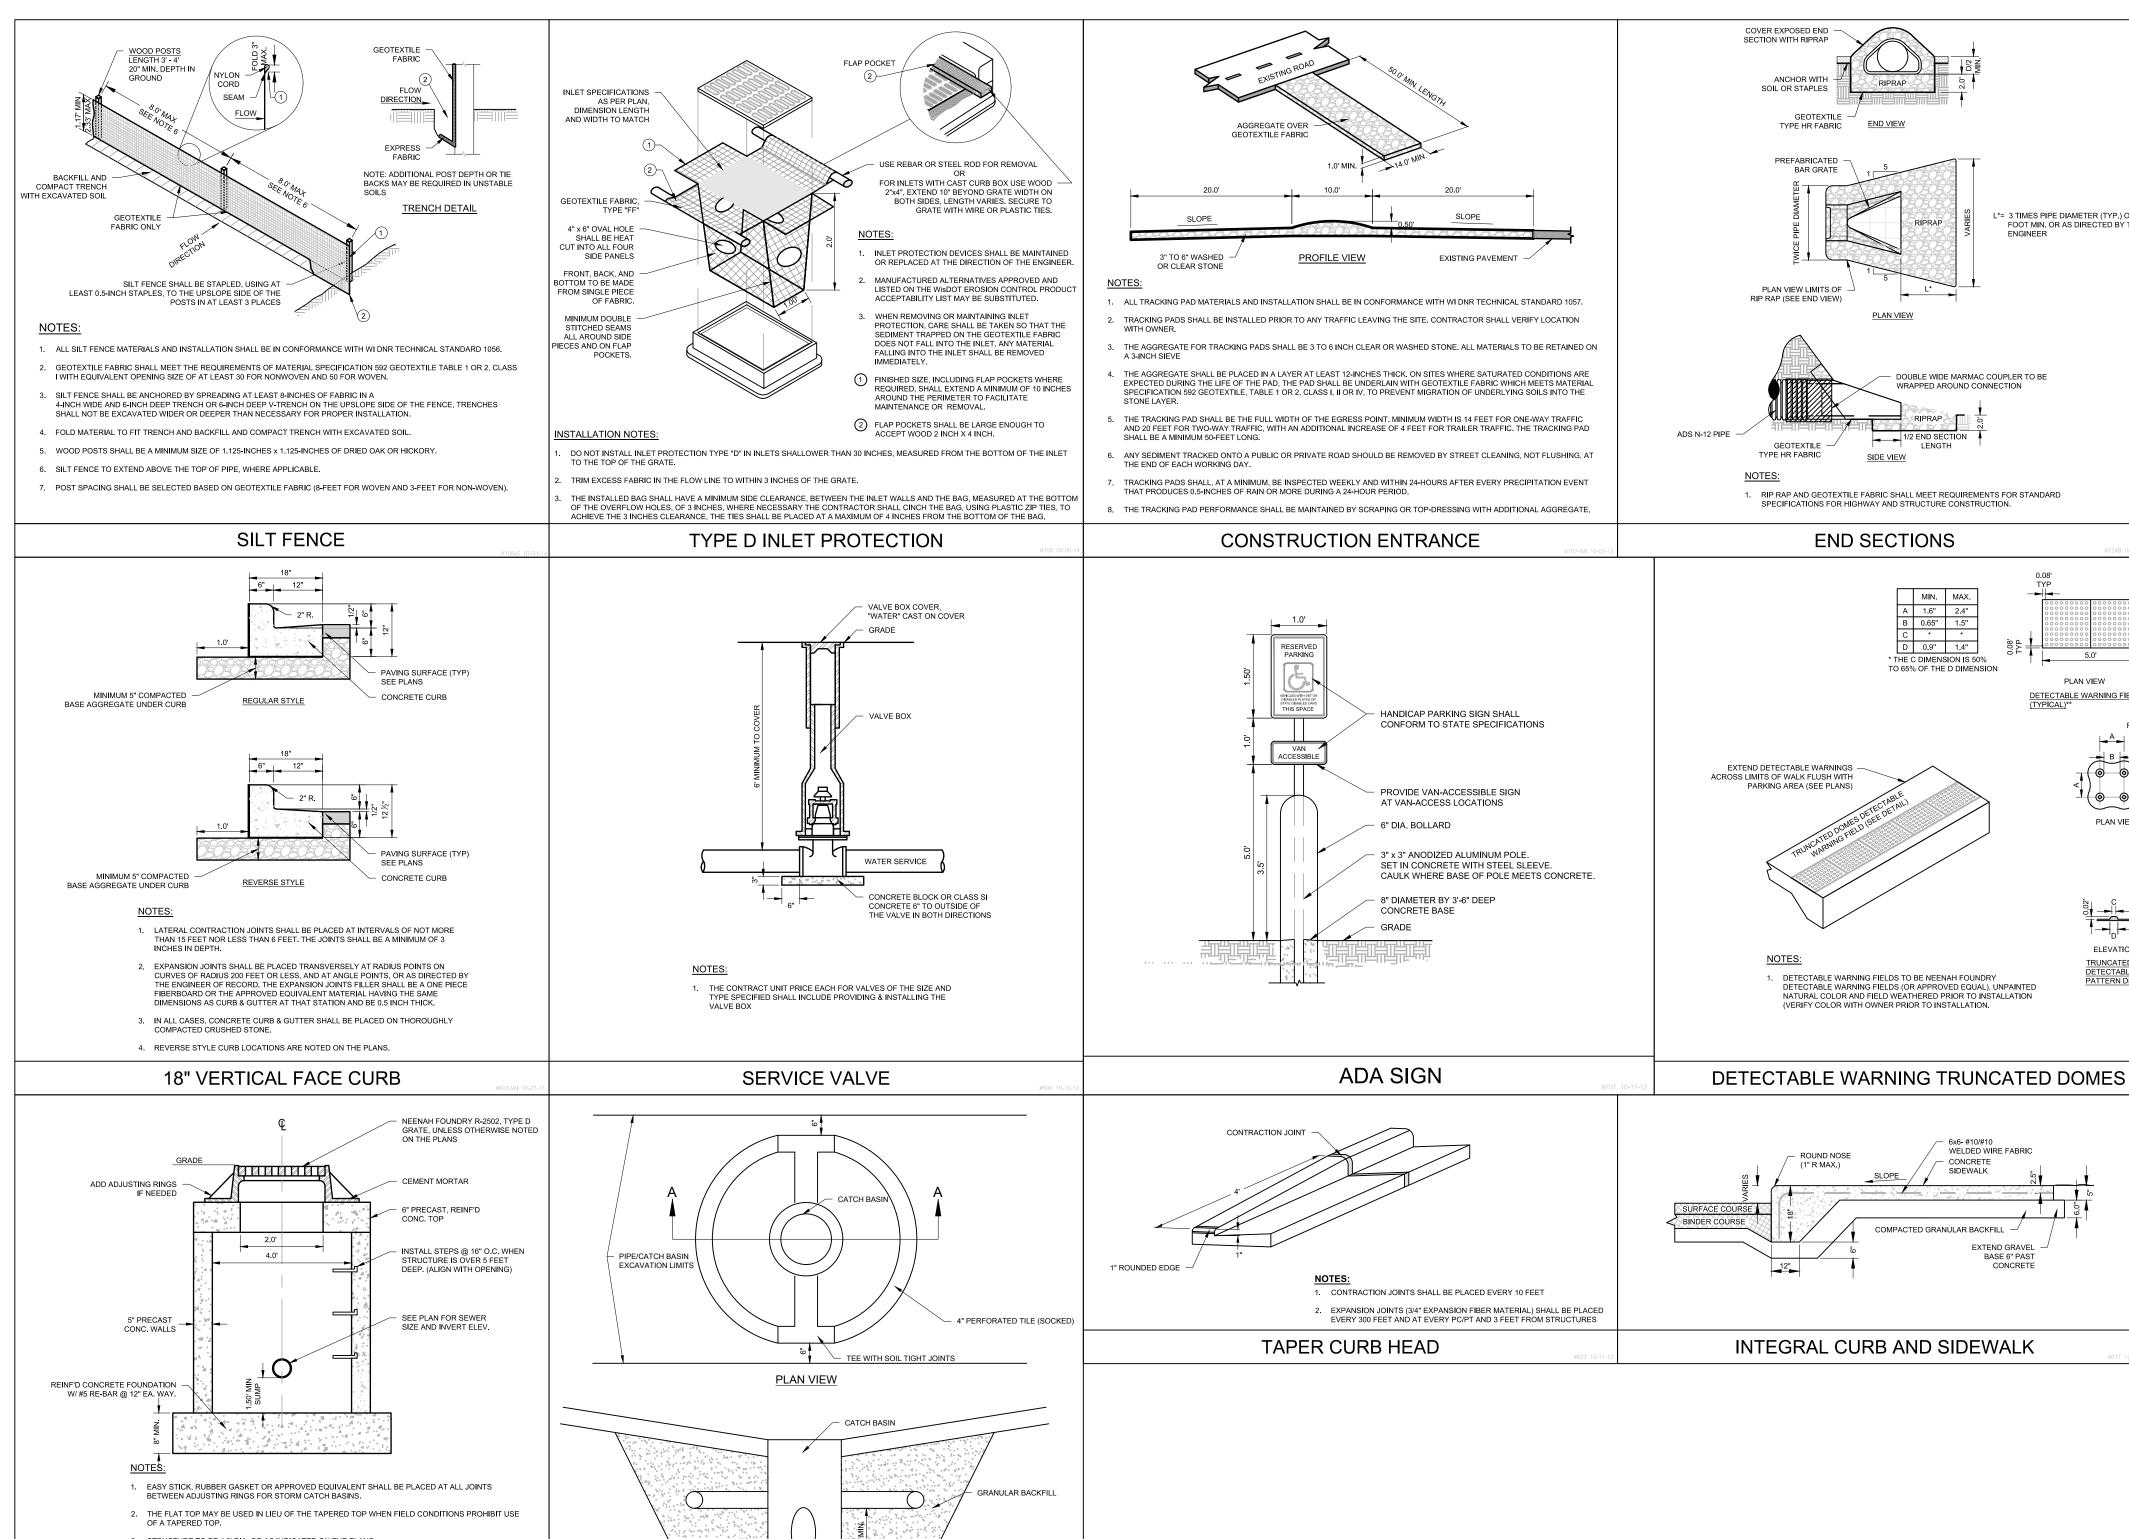

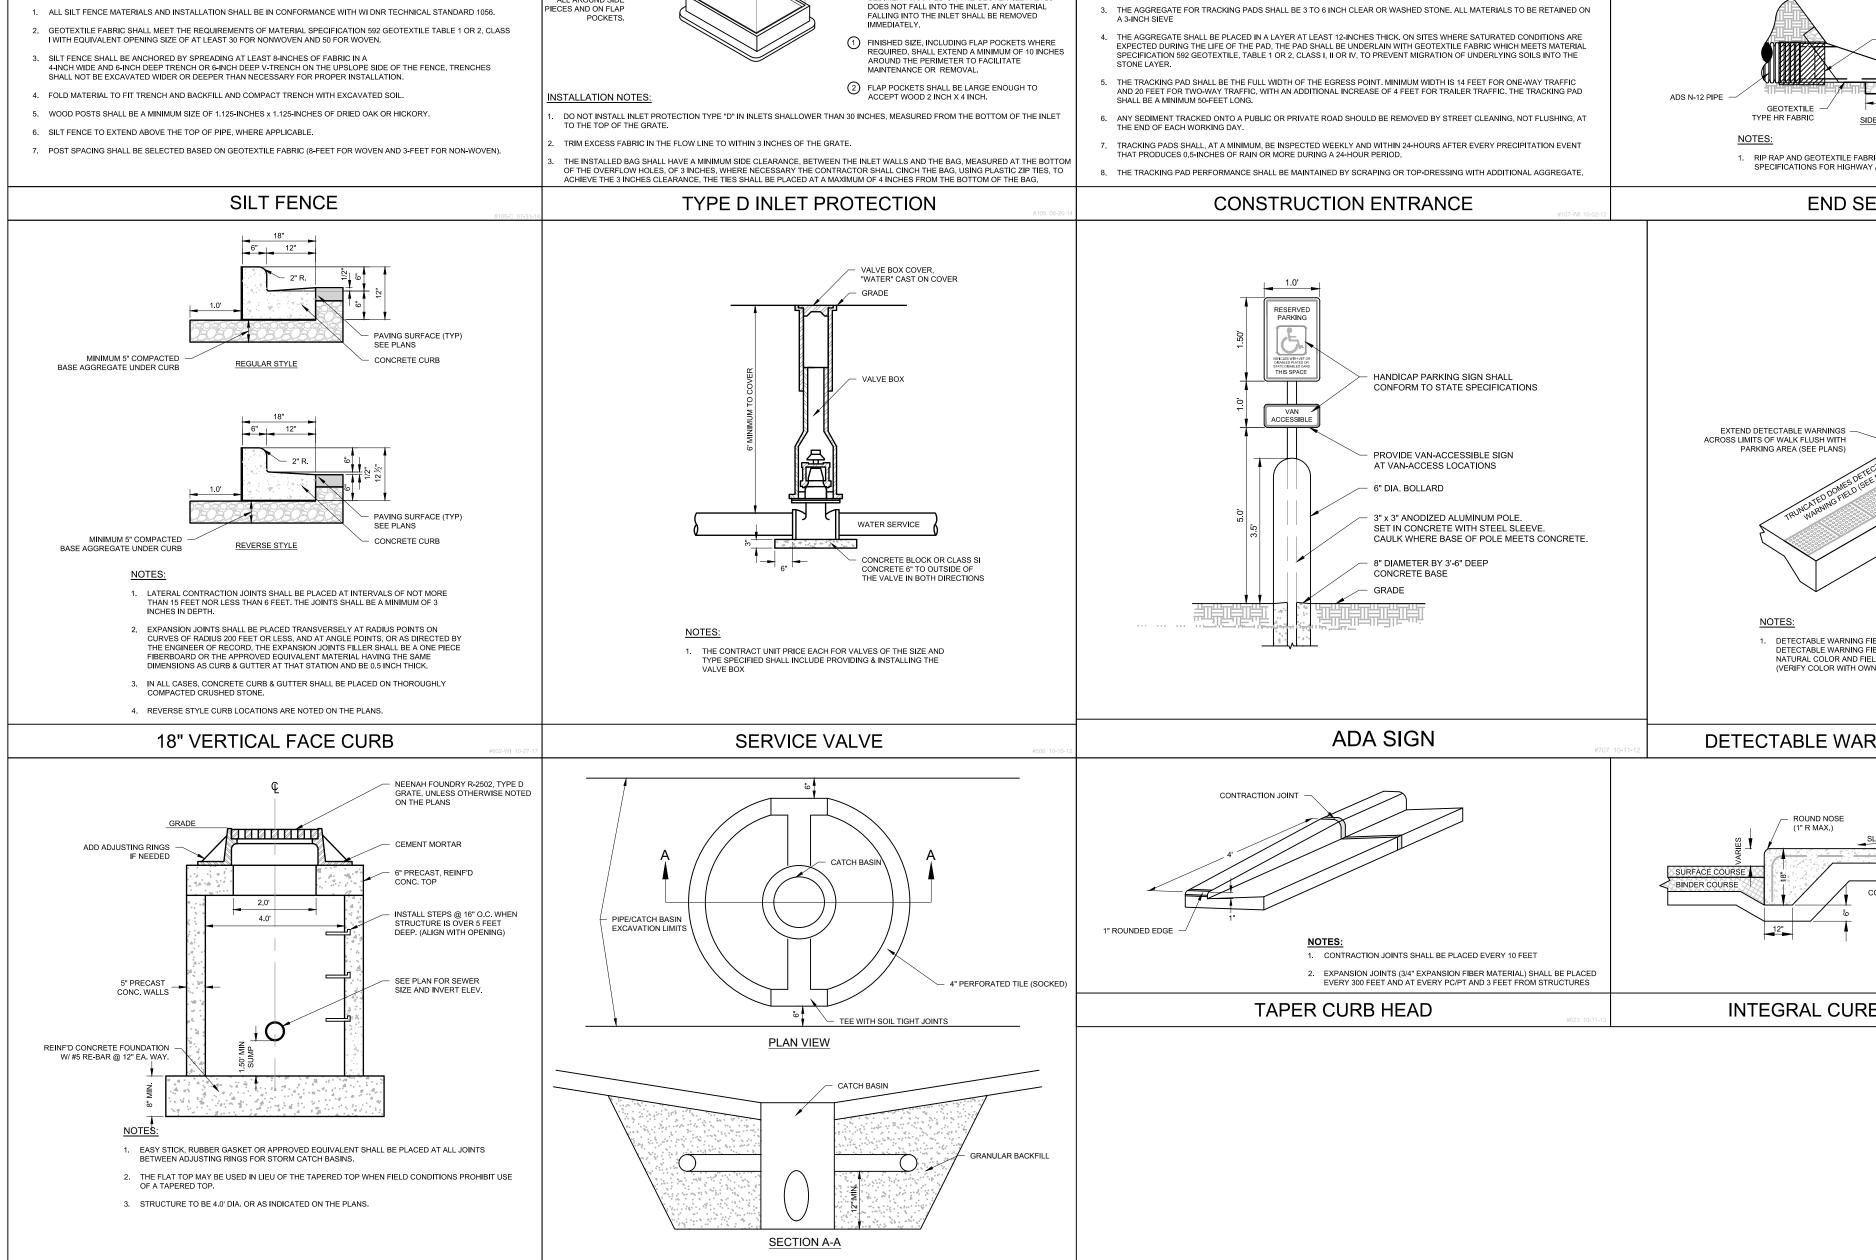CATCH BASIN - UNDERDRAIN

CATCH BASIN

ENGINEER

KEY PLAN

CITY/ STATE / ZIP Waukesha, WI 53188

ALL WORK TO BE COMPLETED AS SHOWN, AND IN ACCORDANCE WITH THE LATEST EDITION OF

THE MSI GENERAL MASTER SPECIFICATION

CIVIL ENGINEER: REVIEWED BY AFH MTS ΤK

SHEET TITLE:

CONSTRUCTION DETAILS

PROJECT NUMBER:

SPECIFICATIONS:

1. DO NOT USE HEAVY EQUIPMENT IN THE BASIN.

2. DO NOT PLACE TOPSOIL, MEDIA, MULCH, OR PLANTS UNTIL AFTER THE PAVING OPERATIONS ARE COMPLETE AND THE SITE IS STABILIZED.


3. PRIOR TO COMPLETING THE GARDEN, REMOVE ANY SEDIMENT THAT HAS ACCUMULATED AND REMOVE FINAL FOOT AND LOOSEN BOTTOM SOIL PRIOR TO PLACEMENT OF ANY FINISH MATERIALS.

4. ONCE THE ENGINEERED SOIL OR TOPSOIL IS PLACED, THE SURFACE SHALL BE COVERED WITH A VARIOUS AREAS OF PLANTINGS AND/OR SEEDING AS SPECIFIED ON THE LANDSCAPE PLAN. HARDWOOD MULCH MAY NOT BE USED WITHIN 30' OF THE OUTLET TO AVOID WASHOUTS. DECORATIVE 6" STONE SHALL BE USED INSTEAD.

5. EROSION CONTROL MATTING SHALL BE ANCHORED, OVERLAPPED, STAKED AND ENTRENCHED PER THE MANUFACTURER'S RECOMMENDATIONS.

6. CONTRACTOR TO PROVIDE A COPY OF ALL GEOTECHNICAL REPORTS AND DATA PERTAINING TO THE PONDS TO THE ENGINEER FOR APPROVAL. ENGINEER SHALL SUBMIT COPIES TO THE CITY FOR APPROVAL ALONG WITH THE RECORD

BIO-RETENTION DETAIL

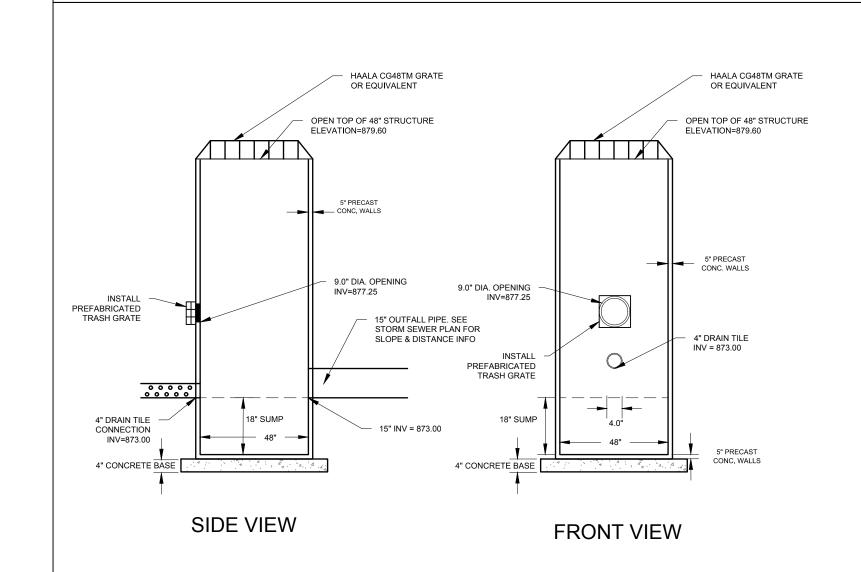

BIO-RETENTION OUTLET CONTROL STRUCTURE DETAIL

TANKS, WASTE CONTAINERS, OIL OR OTHER PETROLEUM PRODUCTS, DETERGENTS, PAINTS, CONSTRUCTION DEBRIS, SANITARY STATIONS, FERTILIZERS,

THE FOLLOWING ARE DESCRIPTIONS OF THE EROSION AND SEDIMENT CONTROL PRACTICES THAT SHALL BE IMPLEMENTED DURING CONSTRUCTION OF THIS PROJECT. IN ADDITION TO THESE MEASURES, CONTRACTOR SHALL DISTURB ONLY AREAS NECESSARY TO COMPLETE THE CONSTRUCTION PROJECT.

ACTIVITIES, CONTRACTOR MAY MODIFY SEQUENCING AFTER ITEM 6 AS NEEDED TO COMPLETE CONSTRUCTION ONLY IF EROSION CONTROLS ARE

1. INSTALL TEMPORARY CONSTRUCTION ENTRANCES, INLET PROTECTION ON EXISTING STORM SEWER AND CULVERT INLET LOCATIONS, AND

2. INSTALL SILT FENCING ALONG THE PERIMETER OF PROPOSED TOPSOIL STOCKPILE LOCATIONS. THE FIRST TOPSOIL DEPOSITED WITHIN THE

AGAINST SILT FENCING. CONTRACTOR SHALL LIMIT LAND DISTURBING ACTIVITIES ASSOCIATED WITH TEMPORARY BERMING TO A MINIMUM.

3. STRIP TOPSOIL WITHIN THE LIMITS OF THE SEDIMENT TRAPS THAT WILL BE USED FOR TEMPORARY SEDIMENT CONTROL. STRIPPED TOPSOIL

5. CONDUCT ROUGH GRADING OPERATIONS AND UTILITY PIPING INSTALLATION. DRAIN TILE SHALL NOT BE INSTALLED UNTIL UPLAND AREAS

6. FINE GRADE SUB-GRADE SOILS WITHIN PAVEMENT AND BUILDING LIMITS. PLACE STONE BASE MATERIAL AS SOON AS POSSIBLE FOLLOWING

7. FINE GRADE REMAINING DISTURBED AREAS, PLACE SALVAGED TOPSOIL, EROSION BLANKETS/MATTING, AND SEED/MULCH AS SOON AS POSSIBLE

8. EROSION CONTROLS SHALL NOT BE REMOVED UNTIL SITE IS FULLY STABILIZED OR 70% VEGETATIVE COVER IS ESTABLISHED. CONTRACTOR IS RESPONSIBLE FOR REMOVAL OF SILT FENCE, TEMPORARY FENCING/PRETECTION, DITCH CHECKS, AND OTHER TEMPORARY CONTROLS, AND

THE DATES WHEN MAJOR GRADING ACTIVITIES OCCUR. WHEN CONSTRUCTION ACTIVITIES TEMPORARILY OR PERMANENTLY CEASE ON A PORTION OF THE

STABILIZATION MEASURES SHALL BE INITIATED AS SOON AS PRACTICABLE IN PORTIONS OF THE SITE WHERE CONSTRUCTION ACTIVITIES HAVE

TEMPORARILY OR PERMANENTLY CEASED. NO MORE THAN SEVEN (7) DAYS SHALL PASS AFTER THE CONSTRUCTION ACTIVITY IN THAT PORTION OF THE

THE INITIATION OF STABILIZATION MEASURES BY THE SEVENTH (7) DAY AFTER CONSTRUCTION ACTIVITY TEMPORARILY OR PERMANENTLY CEASE IS

CONSTRUCTION ACTIVITY WILL RESUME ON A PORTION OF THE SITE WITHIN FOURTEEN (14) DAYS FROM WHEN ACTIVITIES CEASED, (I.E. THE TOTAL

TIME PERIOD THAT THE CONSTRUCTION ACTIVITY IS TEMPORARILY CEASED IS LESS THAN FOURTEEN (14) DAYS). IN THAT EVENT, STABILIZATION

MEASURES DO NOT HAVE TO BE INITIATED ON THAT PORTION OF THE SITE BY THE SEVENTH (7) DAY AFTER CONSTRUCTION ACTIVITY HAS TEMPORARIL'S

CEASED. SEE THE SOIL PROTECTION CHART PRESENTED IN THE CONSTRUCTION DOCUMENTS FOR RATES OF PERMANENT AND TEMPORARY VEGETATION.

LIMITED TO WEATHER CONDITIONS AND LENGTH OF TIME MEASURE MUST BE EFFECTIVE. THE FOLLOWING ARE ACCEPTABLE STABILIZATION MEASURES.

STABILIZATION MEASURES SHALL BE DETERMINED BASED ON SITE CONDITIONS AT THE TIME CONSTRUCTION ACTIVITY HAS CEASED, INCLUDING BUT NOT

SITE, AND WHEN STABILIZATION MEASURES ARE INITIATED. SHALL BE RECORDED ON THE STABILIZATION SCHEDULE FOR MAJOR GRADING ACTIVITIES.

CONTRIBUTING STORMWATER RUNOFF ARE STABILIZED. DITCH CHECKS SHALL BE INSTALLED WITHIN DRAINAGE DITCHES IMMEDIATELY

FOLLOWING CREATION OF DITCHES AND INLET PROTECTION SHALL BE INSTALLED TO PROTECT ANY STORM SEWER OR CULVERTS THAT WILL

STOCKPILE LIMITS SHALL BE PLACED TO CREATE TEMPORARY BERMING ALONG THE SILT FENCE TO PREVENT DIRECT STORMWATER RUNOFF

48" OUTLET CONTROL STRUCTURE

NATIVE PLANT PLUGS (SEE LANDSCAPE PLAN)

W/ EROSION CONTROL BLANKET

(WISDOT CLASS II TYPE B)

CONNECT TO OUTLET

IE = 873.00

CONTROL STRUCTURE

(SEE DETAIL)

TOP OF BERM ELEV. 882.00

TOP OF SPILLWAY ELEV.

881.00

15" RCP CULVERT PIPE

(SEE STORM SEWER

PLAN FOR DETAIL

1.0 POTENTIAL POLLUTANT SOURCES

AND DUST: REFER TO SECTION 5 OF THIS PLAN.

FUNCTION DURING CONSTRUCTION.

2.2 STABILIZATION PRACTICES

SITE HAS PERMANENTLY CEASED UNLESS:

HYDRO-MULCHING WITH A TACKIFIER

GEOTEXTILE EROSION MATTING

COMPLETION OF FINE GRADING EFFORTS.

FOLLOWING COMPLETION OF FINE GRADING EFFORTS

2.0 EROSION AND SEDIMENT CONTROL IMPLEMENTATION

2.1 CONSTRUCTION AND EROSION CONTROL SEQUENCING

ALL PRACTICES SHALL BE CONDUCTED IN ACCORDANCE WITH THE BEST MANAGEMENT PRACTICES (BMP).

MAINTAINED IN ACCORDANCE WITH THE CONSTRUCTION SITE EROSION AND SEDIMENT CONTROL REQUIREMENTS

SHALL BE PLACED TO CONSTRUCT DIVERSION BERMING OR PLACED WITHIN THE STOCKPILE LIMITS.

STRIPPING SHALL NOT OCCUR UNTIL ALL DOWNSTREAM SEDIMENT CONTROLS ARE IN PLACE.

RESTORATION PRACTICES AS NECESSARY, TO THE SATISFACTION OF THE OWNER.

PERMANENT SEEDING: IN ACCORDANCE WITH APPROVED LANDSCAPING PLAN

PRECLUDED BY SNOW COVER. IN THAT EVENT, STABILIZATION MEASURE SHALL BE INITIATED AS SOON AS PRACTICABLE.

TEMPORARY SEEDING MAY CONSIST OF SPRING OATS (100LBS/ACRE) AND/OR WHEAT OR CEREAL RYE (150LBS/ACRE)

NOTES

TOE OF SLOPE

6" TOPSOIL & NATIVE GRASS SEED

- INSTALL STRAW EROSION

CONTROL MATTING

COMING STORM SEWER

24" ENGINEERED SOIL CONSISTING OF:

-2' THICK CLAY POND LINER CONFORMING

AND DOCUMENTATION AS SPECIFIED IN NRCS WISCONSIN CONSTRUCTION

SPECIFICATION 204 IS REQUIRED

TO WDNR TECHNICAL STANDARD 1001 TYPE B LINER SPECIFICATIONS, COMPACTION

70% SAND

30% COMPOST

-24" OF COARSE

AGGREGATE #2

ENGINEERED FILL

(PER DNR STANDARD S100

(SEE STORM SEWER PLANS FOR DETAILS)

EXTEND MATTING 2' BELOW THE ELEVATION OF THE EMERGENCY SPILLWAY ON THE INSIDE OF THE POND.

EXTEND MATTING TO TOE OF SLOPE ON THE OUTSIDE OF THE POND. 8' WIDE MOWED GRASS PATH 3. MATTING SHALL BE INSTALLED IN ACCORDANCE WITH MANUFACTURERS RECOMMENDATIONS. 1' WIDE SAFETY LEDGE SPILLWAY - -ELEV =881.00 OUTSIDE OF POND

REINFORCEMENT MATTING (CLASS III, TYPE C) PERMANENT TURF 20' WIDE TOP OF BERM REINFORCEMENT MATTING ELEV.=882.00 (CLASS III, TYPE C)

QUALIFIED PERSONNEL MEANS A PERSON KNOWLEDGEABLE IN THE PRINCIPLES AND PRACTICES OF EROSION AND SEDIMENT CONTROL MEASURES, SUCH AS A LICENSED PROFESSIONAL ENGINEER, A CERTIFIED PROFESSIONAL IN EROSION AND SEDIMENT CONTROL, A CERTIFIED EROSION SEDIMENT OR

6.0 SPILL PREVENTION

6.1 GENERAL MATERIAL MANAGEMENT PRACTICES

THE GOOD HOUSEKEEPING PRACTICES LISTED BELOW SHALL BE FOLLOWED THROUGHOUT THE CONSTRUCTION PROJECT

ALL MATERIAL SHALL BE STORED IN A NEAT, ORDERLY MANNER IN THEIR ORIGINAL CONTAINERS CONTAINING MANUFACTURER'S LABEL

MANUFACTURERS' RECOMMENDATIONS FOR PROPER USE AND DISPOSAL SHALL BE FOLLOWED. 4. MATERIALS REQUIRED TO HAVE A MATERIAL SAFETY DATA SHEET (MSDS) SHALL HAVE A COPY STORED IN THE PROJECT'S MSDS DATABASE.

6.2 SPILL CONTROL PRACTICES

THE PRACTICES LISTED BELOW SHALL BE FOLLOWED FOR SPILL PREVENTION AND CLEANUP.

IMMEDIATELY UPON DISCOVERY, ALL SPILLS SHALL BE CLEANED UP ACCORDING TO THE MANUFACTURERS' RECOMMENDED METHODS.

IMMEDIATELY UPON DISCOVERY. SPILLS OF TOXIC OR HAZARDOUS MATERIALS SHALL BE REPORTED TO THE OWNER AND GENERAL CONTRACTOR. NOTIFICATION AND REPORTING TO THE APPROPRIATE FEDERAL, STATE, AND LOCAL GOVERNMENT AGENCIES SHALL BE MADE AS REQUIRED.

THIS STORMWATER POLLUTION PREVENTION PLAN (SWPPP) HAS BEEN DEVELOPED TO FULFILL ONE OF THE REQUIREMENTS OF THE GENERAL ENVIRONMENTAL PROTECTION AGENCY (EPA) NATIONAL POLLUTION DISCHARGE ELIMINATION SYSTEM (WISCONSIN POLLUTION DISCHARGE ELIMINATION SYSTEM "WPDES" PERMIT NO. WI-S067831-4) FOR THE DISCHARGE OF STORMWATER ASSOCIATED WITH CONSTRUCTION PROJECTS DISTURBING ONE ACRE

STORMWATER DISCHARGES ASSOCIATED WITH THE CONSTRUCTION ACTIVITY FROM THIS SITE ARE SUBJECT TO THE CONDITIONS AND REQUIREMENTS OF

THE EXECUTED OWNER CERTIFICATION AND THE CONTRACTOR CERTIFICATIONS SHALL BE KEPT ONSITE WITH THE APPROVED PLANS.

THE OWNER SHALL RETAIN A COPY OF THE SWPPP AT THE CONSTRUCTION SITE FROM THE DATE OF THE PROJECT INITIATION TO THE DATE OF FINAL

THE CONTRACTOR SHALL AMEND THE PLAN WHENEVER THERE IS A CHANGE IN DESIGN, CONSTRUCTION, OPERATION, OR MAINTENANCE, WHICH HAS A SIGNIFICANT EFFECT ON THE POTENTIAL FOR THE DISCHARGE OF POLLUTANTS TO THE WATERS OF THE STATE AND WHICH HAS NOT OTHERWISE BEEN ADDRESSED IN THE PLAN OR IF THE PLAN PROVES TO BE INEFFECTIVE IN ELIMINATING OR SIGNIFICANTLY CONTROLLING POLLUTANTS IN STORMWATER DISCHARGES ASSOCIATED WITH CONSTRUCTION SITE ACTIVITY. IN ADDITION, THE THE PLAN SHALL BE AMENDED TO IDENTIFY ANY NEW CONTRACTOR AND/OR SUBCONTRACTOR THAT WILL IMPLEMENT A MEASURE OF THE PLAN. AMENDMENTS TO THE PLAN MAY BE REQUIRED BY THE MUNICIPALITY.

THE OWNER SHALL RETAIN COPIES OF THIS AND ALL REPORTS AND NOTICES REQUIRED BY THIS PERMIT, AND RECORDS OF ALL DATA USED TO COMPLETE THE NOTICE OF INTENT TO BE COVERED BY THIS PERMIT. FOR A PERIOD OF AT LEAST THREE YEARS FROM THE DATE PERMIT COVERAGE EXPIRES OR IS TERMINATED. THIS PERIOD MAY BE EXTENDED BY THE REQUEST OF THE AGENCY AT ANY TIME. IN ADDITION, THE OWNER SHALL RETAIN A COPY OF THE PLAN REQUIRED BY THIS PERMIT AT THE CONSTRUCTION SITE FROM THE DATE OF PROJECT INITIATION TO THE DATE OF FINAL STABILIZATION.

WPDES NOTICE OF TERMINATION GUIDANCE:

SPILLWAY ELEV =881 00 **BIO-RETENTION EMERGENCY SPILLWAY**

<u>3/LT FENCE</u> SHALL BE PLACED DOWN SLOPE OF DISTURBED AREAS OF THE CONSTRUCTION SITE AND AROUND THE PERIMETER OF THE TOPSOIL GIVEN THE PROPOSED ACTIVITY ON THE PROJECT SITE, THE PRIMARY POTENTIAL POLLUTANT SOURCE ASSOCIATED WITH THIS CONSTRUCTION PROJECT STOCKPILE. THIS INCLUDES PROTECTION OF EXISTING WETLAND AREAS TO BE MAINTAINED. SILT FENCE MAY ALSO BE USED AS A TEMPORARY IS SOIL EROSION AND TRANSPORTATION; REFER TO SECTION 4 OF THIS PLAN. ADDITIONAL POTENTIAL SOURCES OF POLLUTION MAY INCLUDE: FUEL CONTROL DEVICE WHERE SEDIMENTATION RUNOFF IS DISCOVERED.

> ACTIVITIES. IF THE CRUSHED STONE DOES NOT ADEQUATELY REMOVE MUD FROM VEHICLE TIRES, THEY SHALL BE HOSED OFF BEFORE ENTERING A PAVED ROADWAY. ANY SOIL DEPOSITED ON THE PUBLIC PAVED ROAD WAY SHALL BE REMOVED IMMEDIATELY. <u>DITCH CHECK (STRAW BALES)</u> SHALL BE INSTALLED IN DRAINAGE CHANNELS AS NEEDED.

CONSTRUCTION ENTRANCE SHALL BE INSTALLED TO REDUCE SOIL EROSION POLLUTANTS FROM LEAVING THE SITE DURING CONSTRUCTION

EROSION CONTROL MATTING SHALL BE PLACED ON AREAS OR EMBANKMENTS HAVING SLOPES GREATER THAN OR EQUAL TO 3H:1V, BEFORE BION BERM/SWALE SHALL BE CONSTRUCTED TO DIVERT RUNOFF AROUND THE SITE AND TO DIVERT RUNOFF FROM THE DISTURBED AREA

TO A SEDIMENT TRAP OR OTHER CONTROL. BERMS/SWALES SHALL BE STABILIZED WITH EQUIPMENT TRACKING AND TEMPORARY SEEDING. CONSTRUCTION SEQUENCING WILL BE UTILIZED AS A MEANS OF CONTROLLING EROSION AND LIMITING SEDIMENT TRANSPORT. SEQUENCING AS LISTED BELOW IS GENERAL IN NATURE AND MAY VARY DEPENDING ON WEATHER CONDITIONS AND/OR PHASING OF CONSTRUCTION. THE CONTRACTOR SHALL SEDIMENT TRAPS/BASIN SHALL BE CONSTRUCTED TO COLLECT RUNOFF AND RUNOFF FROM SITE DIVERSION BERMS/SWALES. SUBMIT A DETAILED SITE SEQUENCING PLAN TO OWNER FOR APPROVAL AT LEAST 5 BUSINESS DAYS PRIOR TO COMMENCEMENT OF ANY CONSTRUCTION

INLET PROTECTION SHALL BE INSTALLED AT STORMWATER DRAINAGE INLETS TO REDUCE SEDIMENT WITHIN STORM SEWER CONVEYANCE

<u>OUTLET SCOUR PROTECTION</u> SHALL BE INSTALLED AT STORMWATER DRAINAGE OUTLETS TO DIFFUSE FLOWS.

3.0 ADDITIONAL PRACTICES

ADDITIONAL POLLUTANT CONTROL MEASURES TO BE IMPLEMENTED DURING CONSTRUCTION ACTIVITIES SHALL INCLUDE, BUT NOT BE LIMITED TO THE

CONSTRUCTION WASTE SHALL BE PROPERLY DISPOSED OF. THIS INCLUDES ALL CONSTRUCTION SITE WASTE MATERIAL, SANITARY WASTE, AND WASTE FROM VEHICLE TRACKING OF SEDIMENTS. THE CONTRACTOR SHALL ENSURE THAT NO MATERIAL WASTES OR UNUSED BUILDING MATERIALS SHALL BE BURIED, DUMPED, BURNED, OR DISCHARGED TO THE WATERS OF THE STATE. VEHICLES HAULING MATERIAL AWAY FROM THE SITE SHALL BE 4. STRIP TOPSOIL ALONG THE REMAINDER OF DIVERSION BERMING AND IMMEDIATELY PLACE TOPSOIL TO CREATE THE BERMING. MASS TOPSOIL COVERED WITH A TARPAULIN TO PREVENT BLOWING DEBRIS

 $\underline{\textit{DUST CONTROL}}$ SHALL BE ACCOMPLISHED BY ONE OR MORE OF THE FOLLOWING METHODS: COVERING 30% OR MORE OF THE SOIL SURFACE WITH A NON-ERODIBLE MATERIAL

ROUGHENING (EQUIPMENT TRACKING) THE SOIL TO PRODUCE RIDGES PERPENDICULAR TO THE PREVAILING WIND. RIDGES SHALL BE AT LEAST SIX (6) INCHES IN HEIGHT. FREQUENT WATERING OF EXCAVATION AND FILL AREAS.

PROVIDING GRAVEL OR PAVING AT ENTRANCE/EXIT DRIVES, PARKING AREAS AND TRANSIT PATHS

<u>STREET SWEEPING</u> SHALL BE PERFORMED TO IMMEDIATELY REMOVE ANY SEDIMENT TRACKED ON PAVEMENTS.

4.0 EROSION AND SEDIMENT STRUCTURAL PRACTICE MAINTENANCE

BASIN AREA TO INTENDED POST-CONSTRUCTION DESIGN GRADES.

THE FOLLOWING MAINTENANCE PRACTICES SHALL BE USED TO MAINTAIN, IN GOOD AND EFFECTIVE OPERATING CONDITIONS, VEGETATION, EROSION AND SEDIMENT CONTROL MEASURES, AND OTHER PROTECTIVE MEASURES IDENTIFIED IN THIS PLAN. UPON IDENTIFICATION, DEFICIENCIES IN STORMWATER CONTROLS SHALL BE ADDRESSED IMMEDIATELY. THE MAINTENANCE PROCEDURES FOR THIS DEVELOPMENT SHALL INCLUDE, BUT NOT BE LIMITED TO THE

<u>SILT FENCE</u> - REPAIR OR REPLACE ANY DAMAGED FILTER FABRIC AND/OR STAKES. REMOVE ACCUMULATED SEDIMENT WHEN IT HAS REACHED ONE-HALF THE ABOVE GROUND HEIGHT OF THE FENCE. <u>CONSTRUCTION ENTRANCE</u> - AS NEEDED, ADD STONE TO MAINTAIN CONSTRUCTION ENTRANCE DIMENSIONS AND EFFECTIVENESS.

DITCH CHECK (STRAW BALES) - RE-SECURE STAKES; ADJUST OR REPOSITION BALES TO ADDRESS PROPER FLOW OF STORMWATER: AND REMOVE ACCUMULATED SEDIMENT WHEN IT HAS REACHED ONE-HALF THE HEIGHT OF THE BALE. EROSION CONTROL MATTING - REPAIR MATTING IMMEDIATELY IF INSPECTION REVEALS BREACHED OR FAILED CONDITIONS. REPAIR AND

RE-GRADE SOIL WHERE CHANNELIZATION HAS OCCURRED. <u>DIVERSION BERM/SWALE</u> - REPLACE OR RE-COMPACT THE CONSTRUCTION MATERIALS AS NECESSARY.

SEDIMENT TRAP - REMOVE AND DISPOSE OF THE ACCUMULATED SEDIMENT WHEN IT HAS REACHED THE SEDIMENT STORAGE ELEVATION. <u>INLET PROTECTION</u> - CLEAN, REPAIR OR REPLACE FILTER FABRIC AND/OR STONE WHEN CONTROL MEASURE IS CLOGGED. INLET FILTER BAGS SHALL BE REPLACED ONCE ONE-HALF FULL OF SEDIMENT.

<u>DUTLET PROTECTION</u> - CLEAN, REPAIR OR REPLACE FILTER FABRIC, TURF REINFORCEMENT MATTING AND/OR STONE WHEN CONTROL MEASURE IS SEDIMENT BASIN - AT THE END OF CONSTRUCTION, CONTRACTOR SHALL REMOVE AND DISPOSE OF THE ACCUMULATED SEDIMENT AND RESTORE

NSPECTIONS SHALL BE COMPLETED WITHIN TWENTY-FOUR (24) HOURS OF THE END OF A RAINFALL EVENT THAT IS ONE-HALF INCH OR GREATER OR

2.3 STRUCTURAL PRACTICES THE FOLLOWING ARE DESCRIPTIONS OF STRUCTURAL PRACTICES TO BE IMPLEMENTED TO DIVERT FLOWS FROM EXPOSED SOILS, STORE FLOWS, OR OTHERWISE LIMIT THE DISCHARGE OF POLLUTANTS FROM EXPOSED AREAS OF THE SITE INCLUDING THE PROPOSED AND EXISTING WETLAND AREAS. SUCH PRACTICES COULD INCLUDE SILT FENCE, PROTECTION FENCE, CONSTRUCTION ENTRANCE, DITCH CHECK, EROSION CONTROL MATTING, DIVERSION 5.0 INSPECTION BERM/SWALE. SEDIMENT TRAP, LEVEL SPREADER, INLET PROTECTION, OUTLET PROTECTION, AND TEMPORARY OR PERMANENT SEDIMENT BASIN. THE FOLLOWING STRUCTURAL PRACTICES ARE TO BE UTILIZED DURING THIS PROJECT

EQUIVALENT SNOWFALL, OR AT A MINIMUM ONCE EVERY SEVEN (7) CALENDAR DAYS. INSPECTIONS SHALL BE UNDERTAKEN BY QUALIFIED PERSONNEL PROVIDED BY THE CONTRACTOR, AND SHALL INCLUDE: DISTURBED AREAS OF THE CONSTRUCTION SITE THAT HAVE NOT BEEN FINALLY STABILIZED, STRUCTURAL CONTROL MEASURES, AND LOCATIONS WHERE VEHICLES ENTER OR EXIT THE SITE, A STORMWATER POLLUTION PREVENTION PLAN INSPECTION REPORT SHALL BE COMPLETED AND ADDED TO THE SWPPP, RAINFALL SHALL BE RECORDED ON THE SWPPP RAINFALL LOG, CONTRACTOR SHALL IMMEDIATELY ARRANGE FOR REPAIR OR REPLACEMENT OF ANY DAMAGED OR DEFICIENT CONTROL MEASURES OBSERVED DURING THE

SEPARATION FABRIC

RIP RAP (SEE END VIEW)

MINIMUM 5" COMPACTED

MINIMUM 5" COMPACTE

BASE AGGREGATE UNDER CURB

PLAN VIEW

1. RIP RAP AND GEOTEXTILE FABRIC SHALL MEET REQUIREMENTS FOR STANDARD

RIP RAP AT END SECTIONS

REVERSE STYLE

4. REVERSE STYLE CURB LOCATIONS ARE NOTED ON THE PLANS.

18" DEPRESSED CURB

COMPACTED CRUSHED STONE

1. LATERAL CONTRACTION JOINTS SHALL BE PLACED AT INTERVALS OF NOT MORE HAN 15 FEET NOR LESS THAN 6 FEET. THE JOINTS SHALL BE A MINIMUM OF 3

2. EXPANSION JOINTS SHALL BE PLACED TRANSVERSELY AT RADIUS POINTS ON CURVES OF RADIUS 200 FEET OR LESS, AND AT ANGLE POINTS, OR AS DIRECTED BY THE ENGINEER OF RECORD. THE EXPANSION JOINTS FILLER SHALL BE A ONE PIECE FIBERBOARD OR THE APPROVED EQUIVALENT MATERIAL HAVING THE SAME DIMENSIONS AS CURB & GUTTER AT THAT STATION AND BE 0.5 INCH THICK.

IOINT RESTRAINTS "TIE BOI TS" REO'D

PAVING SURFACE (TYP)

CONCRETE CURB

CONCRETE CURB

PER JOINT @ MIN 60° SEPARATION

STORMWATER INSPECTOR, OR OTHER TRAINED INDIVIDUAL.

TOP OF BERM

ELEV.= 882.00

INSIDE OF POND

PERMANENT TURF

1. CONTRACTOR SHALL STORE ONLY ENOUGH PRODUCTS REQUIRED TO COMPLETE THIS PROJECT.

MATERIALS AND EQUIPMENT NECESSARY FOR SPILL CLEANUP SHALL BE MAINTAINED ONSITE.

PERSONNEL CLEANING UP A SPILL SHALL USE PERSONAL PROTECTIVE EQUIPMENT.

GENERAL INFORMATION:

OR MORE. THE OWNER AND CONTRACTORS SHALL COMPLY WITH ALL REQUIREMENTS OF THE WPDES FOR ALL SUCH CONSTRUCTION PROJECTS. THE

SWPPP AVAILABILITY:

OWNER, OR OTHER REVIEWING AGENCY. COPIES OF THE AMENDMENTS SHALL BE KEPT ONSITE AS PART OF THE SWPPF RETENTION OF RECORDS

A NOTICE OF INTENT (NOI) APPLICATION MUST BE COMPLETED AND INCORPORATED INTO THE SWPPP.

WHEN A SITE HAS BEEN FINALLY STABILIZED AND ALL STORMWATER DISCHARGES FROM CONSTRUCTION SITES THAT ARE AUTHORIZED BY THE PERMIT ARE ELIMINATED, THE OWNER OF THE FACILITY MUST SUBMIT A COMPLETED NOTICE OF TERMINATION THAT IS SIGNED IN ACCORDANCE WITH THE PERMIT CONTRACTOR SHALL SUBMIT A COMPLETED NOTICE OF TERMINATION TO OWNER FOR EXECUTION PRIOR TO THEIR FINAL PAY APPLICATION REQUEST.

CONTROL MEASURE GROUP	CONTROL MEASURE	CONTROL MEASURE CHARACTERISTICS
VEGETATIVE	TEMPORARY SEEDING	PROVIDES QUICK TEMPORARY COVER TO CONTROL EROSION WHEN PERMANENT SEEDING IS NOT DESIRED OR TIME OF YEAR IS INAPPROPRIATE.
SOIL COVER	PERMANENT SEEDING	PROVIDES PERMANENT VEGETATIVE COVER TO CONTROL EROSION, FILTERS SEDIMENT FROM WATER. MAY BE PART OF FINAL LANDSCAPE PLAN.
NON VEGETATIVE	AGGREGATE COVER	PROVIDES TEMPORARY COVER ON ROADS AND PARKING LOTS AND AREAS WHERE VEGETATION CANNOT BE ESTABLISHED. PREVENTS MUD FROM BEING PICKED UP AND TRANSPORTED OFF-SITE.
SOIL COVER	PAVING	PROVIDES PERMANENT COVER ON PARKING LOTS AND ROADS OR OTHER AREAS WHERE VEGETATION CANNOT BE ESTABLISHED.
DIVERSIONS	DIVERSION BERM / SWALE	DIVERTS RUNOFF TO A SEDIMENT TRAP OR OTHER CONTROL.
ENCLOSED DRAINAGE	STORM SEWER	CONVEYS SEDIMENT LADEN WATER TO A SEDIMENT BASIN.
OUTLETS	APRON ENDWALL OR RIPRAP	PROTECTS DOWNSTREAM CHANNEL FROM HIGH VELOCITY OF FLOW DISCHARGING FROM STRUCTURE.
SEDIMENT BASINS	TEMPORARY SEDIMENT TRAP	CONSTRUCTED TO REMOVE SILTATION FROM RUNOFF FROM SITE DIVERSION BERMS/SWALES AND IN OVERLAND FLOOD ROUTE. CAN BE CONVERTED TO PERMANENT SEDIMENT BASIN.
	SILT FENCE	PLACED DOWN SLOPE OF DISTURBED AREA TO KEEP RUNOFF CONTAINED ON-SITE.
SEDIMENT FILTERS	INLET PROTECTION	INSTALLED IN OPEN GRATE STRUCTURES TO COLLECT SEDIMENT.
FILTERO	DITCH CHECK	PLACED IN DRAINAGE CHANNELS TO FILTER SEDIMENT FROM RUNOFF.
MUD AND	CONSTRUCTION ENTRANCE	REDUCES SOIL EROSION POLLUTANTS BEING TRANSPORTED OFF-SITE.
DUST	STREET SWEEPING	REDUCES POLLUTANTS TRACKED FROM CONSTRUCTION SITE.
CONTROL	DUST CONTROL	PREVENTS DUST FROM LEAVING CONSTRUCTION SITE.

STABILIZATION EFFECTIVENESS (TIME OF YEAR)

*= 3 TIMES PIPE DIAMETER (TYP.) OR 10

FOOT MIN. OR AS DIRECTED BY THE

BLEND CURB INTO

1. PITCH CONCRETE AT 2% FROM FLOW LINE OF GUTTER SECTION TO C/L OF FLUME.

CONCRETE FLUME

	STABLEZATION ETTECTIVENESS (TIME OF TEAK)												
	STABILIZATION TYPE	STABILIZATION UTILIZATION PERIODS											
L	STABILIZATION TIPE	JAN.	FEB.	MAR.	APR.	MAY	JUNE	JULY	AUG.	SEPT.	OCT.	NOV.	DEC.
ſ	PERMANENT SEEDING			Ą	*	*	*	*	*	* \			
				•						\			
ļ	DORMANT SEEDING	В										В	
		•										•	\
	TEMPORARY SEEDING			Ç	*	*	* \	D *	*	\ *			
				•			\	•					
	SODDING			Ę	*	*	*	*	*	* \			
				-									

A. KENTUCKY BLUEGRASS 90 LBS/ACRE MIXED WITH PERENNIAL RYEGRASS 30 LBS/ACRE B. KENTUCKY BLUEGRASS 135 LBS/ACRE MIXED WITH PERENNIAL RYEGRASS 45 LBS/ACRE + 2 TONS STRAW MULCH/ACRE. C. SPRING OATS 100 LBS/ACRE.

D. WHEAT OR CEREAL RYE 150 LBS/ACRE.

F. STRAW MULCH 2 TONS/ACRE. IRRIGATION/WATERING REQUIRED TO SUPPORT ESTABLISHMENT AS NEEDED.

SHEET NUMBER

GENERA

DESIGNBUILD

OWNER REVIEW:

BUDGET SET:

PROPOSAL SET:

PLAN COMMISSION SET:

CONSTRUCTION SET:

REVISIONS:

RECORD DRAWING SET:

SUBMITTAL FOR PERMIT SET:

LEADERS

CONTRACTORS

ARCHITECT

STREET ADDRESS

PROJECT DESCRIPTION

570 Bluemound Road CITY/ STATE / ZIP

Waukesha, WI 53188 ALL WORK TO BE COMPLETED AS SHOWN, AND

IN ACCORDANCE WITH THE LATEST EDITION OF THE MSI GENERAL MASTER SPECIFICATION

SPIRE DJB **ENGINEERING** DESIGN ARCHITECT


CIVIL ENGINEER : REVIEWED BY


TNK MTS MTS


SHEET TITLE: LANDSCAPE OVERVIEW

SHEET NUMBER:

PROJECT NUMBER:

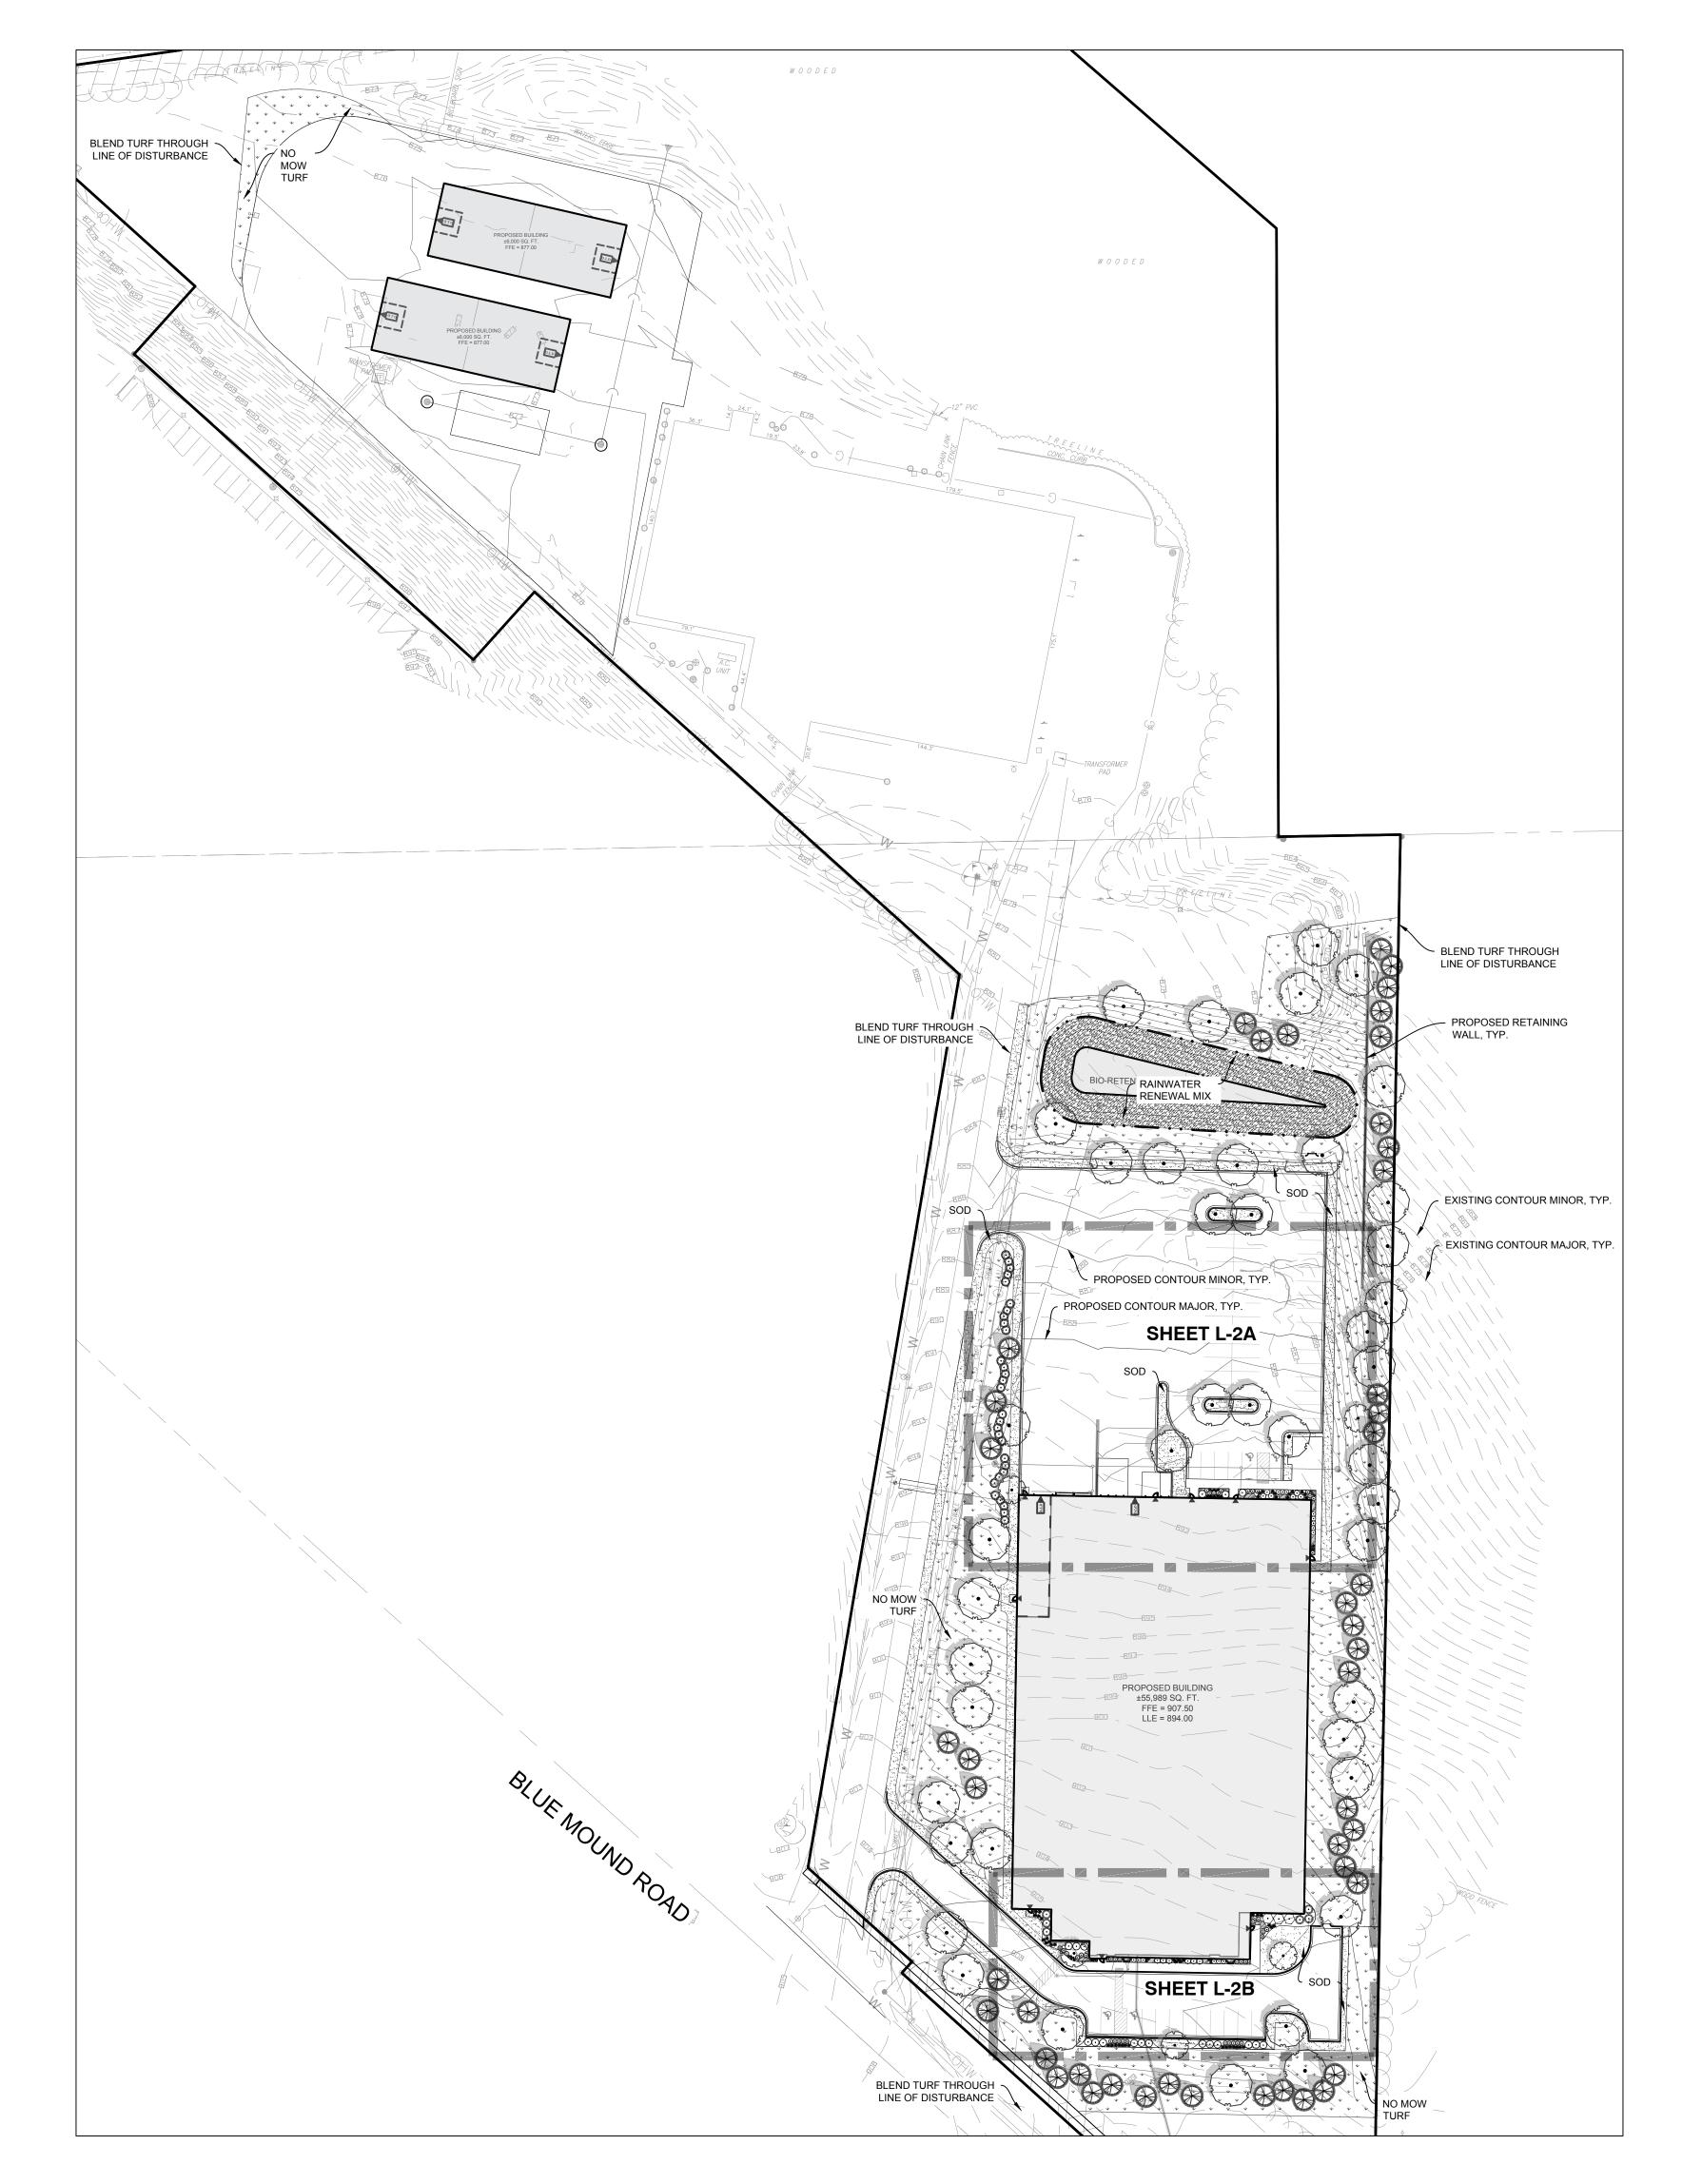

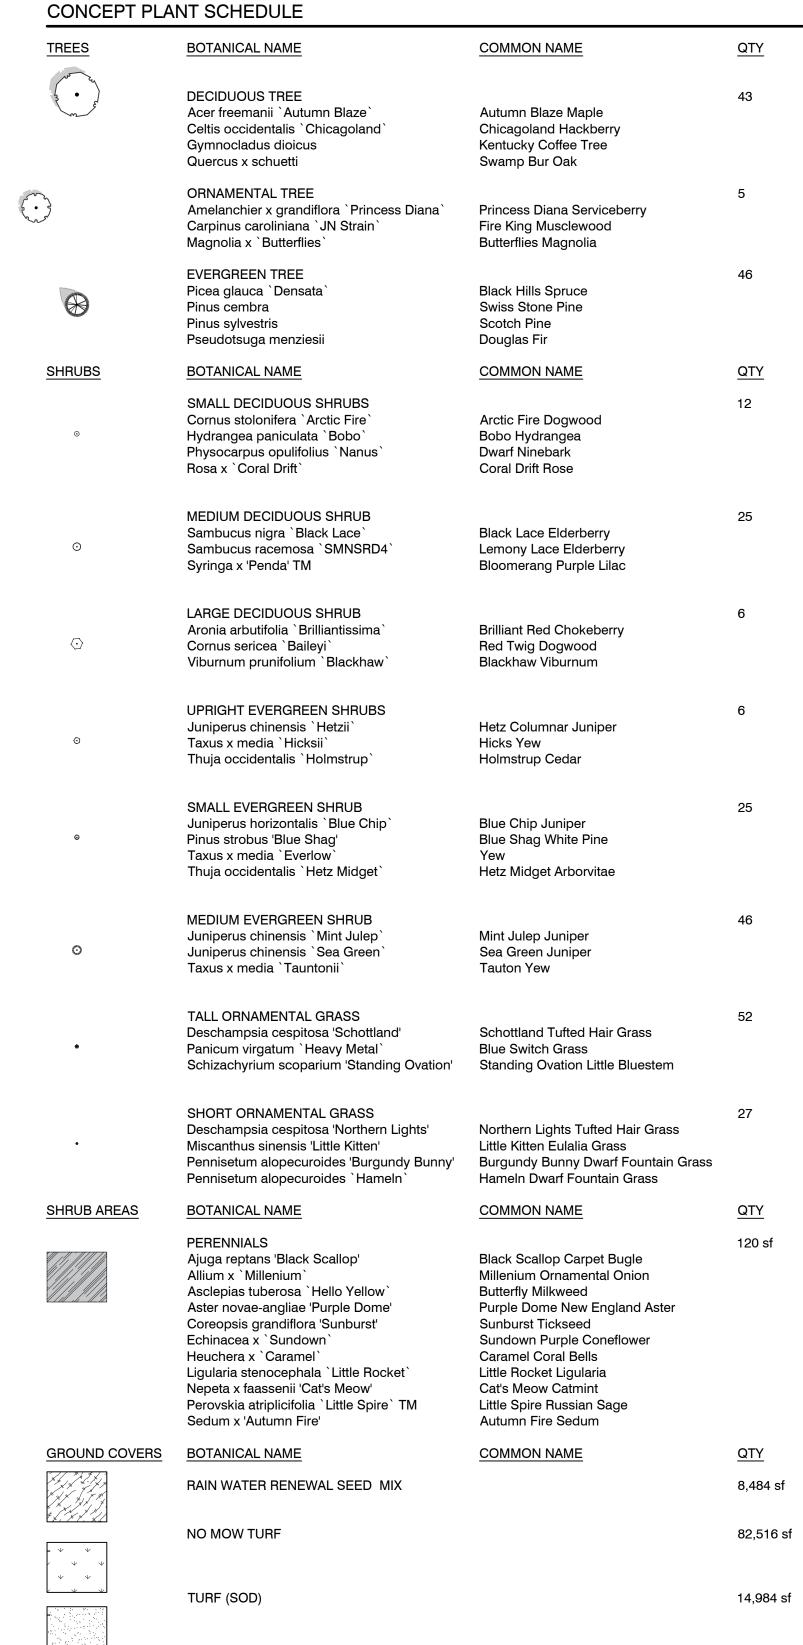

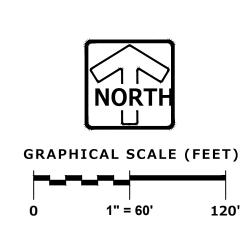

10/13/2022

ARCHITECTS

CHICAGO I MILWAUKEE : NATIONWIDE PEG PROJECT #: 2989.00

FISHER BARTON GROUP

PROJECT DESCRIPTION

570 Bluemound Road

STREET ADDRESS

CITY/ STATE / ZIP

(ACCURATE SPECIALTIES INC.)

BJZ SPIRE DJB **ENGINEERING**

<u>DESIGN</u> <u>ARCHITECT</u> CIVIL ENGINEER: REVIEWED BY MTS MTS

TNK SHEET TITLE:


LANDSCAPE

ENLARGEMENTS


SHEET NUMBER:

PROJECT NUMBER:

P13417

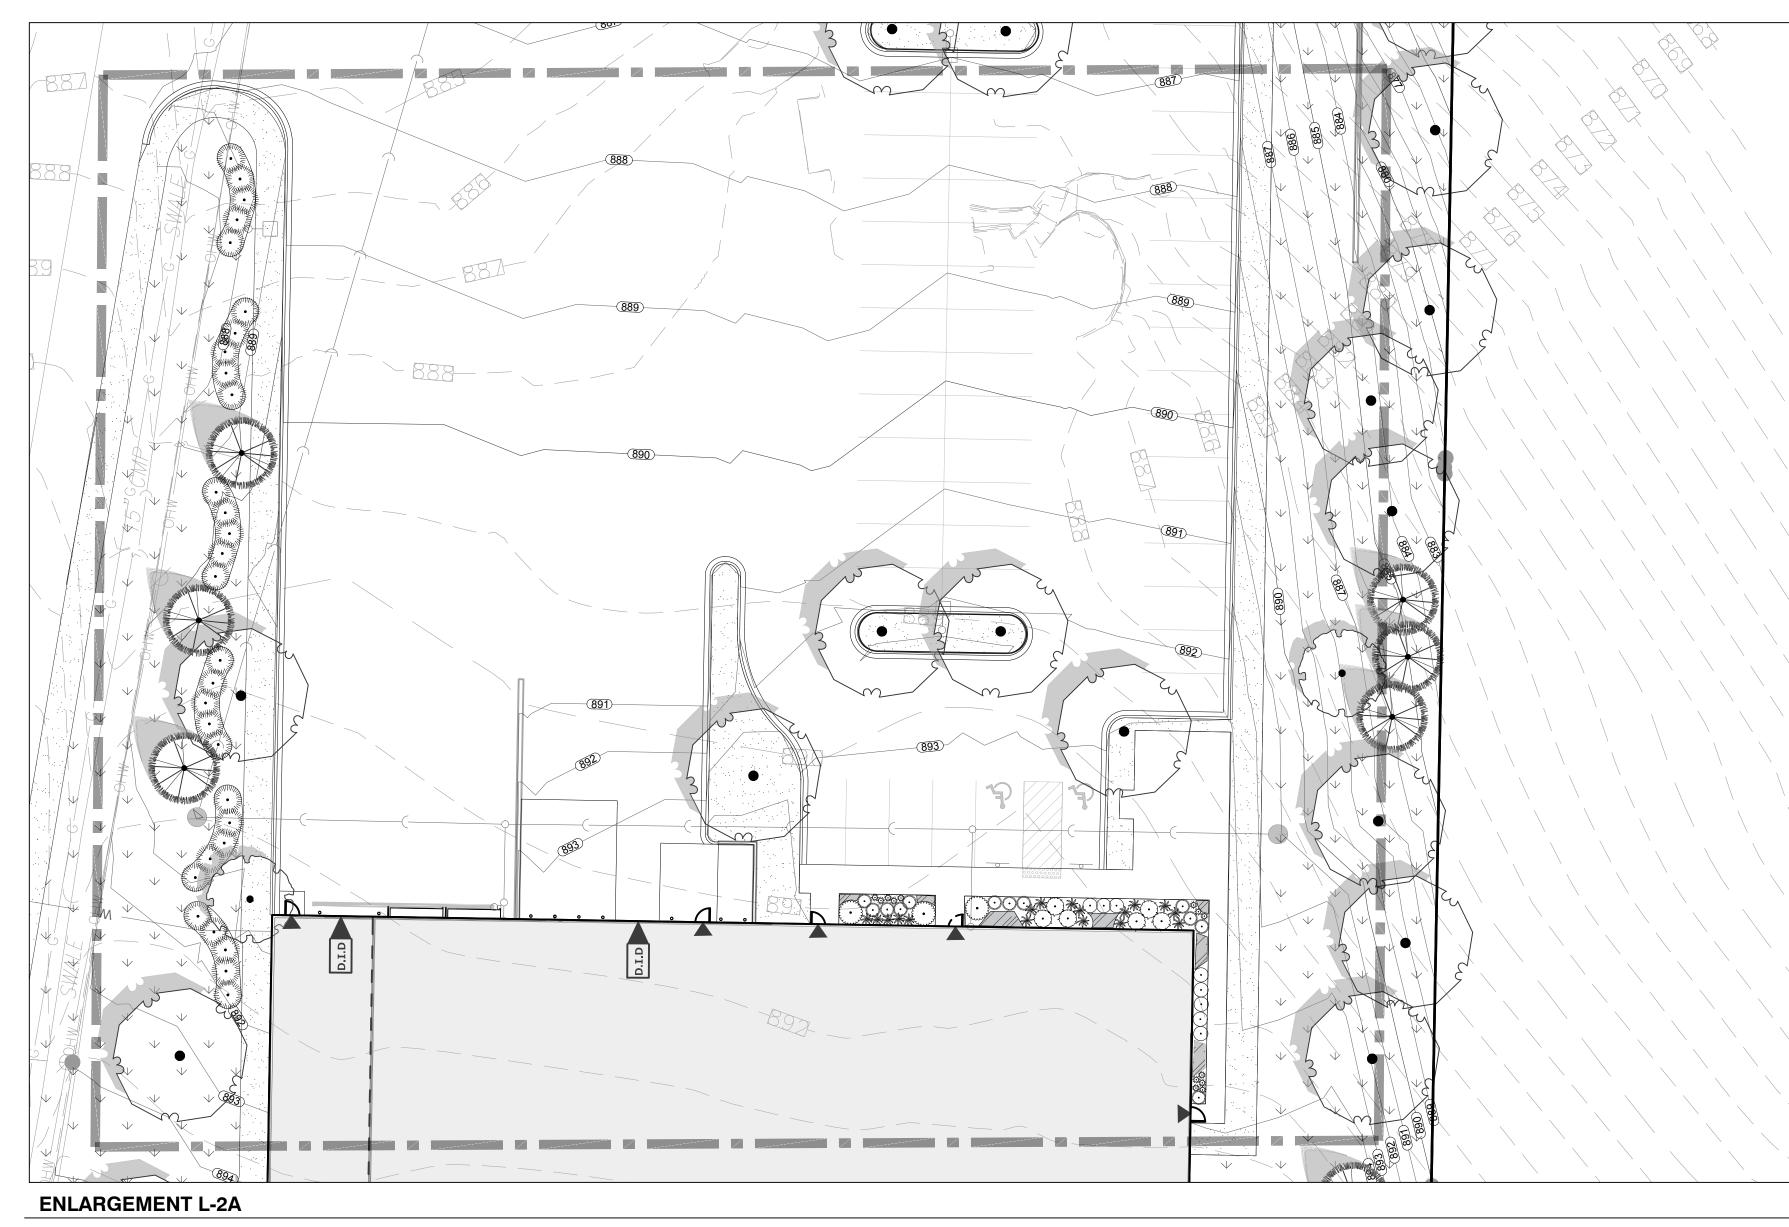


SCALE: 1"=20'

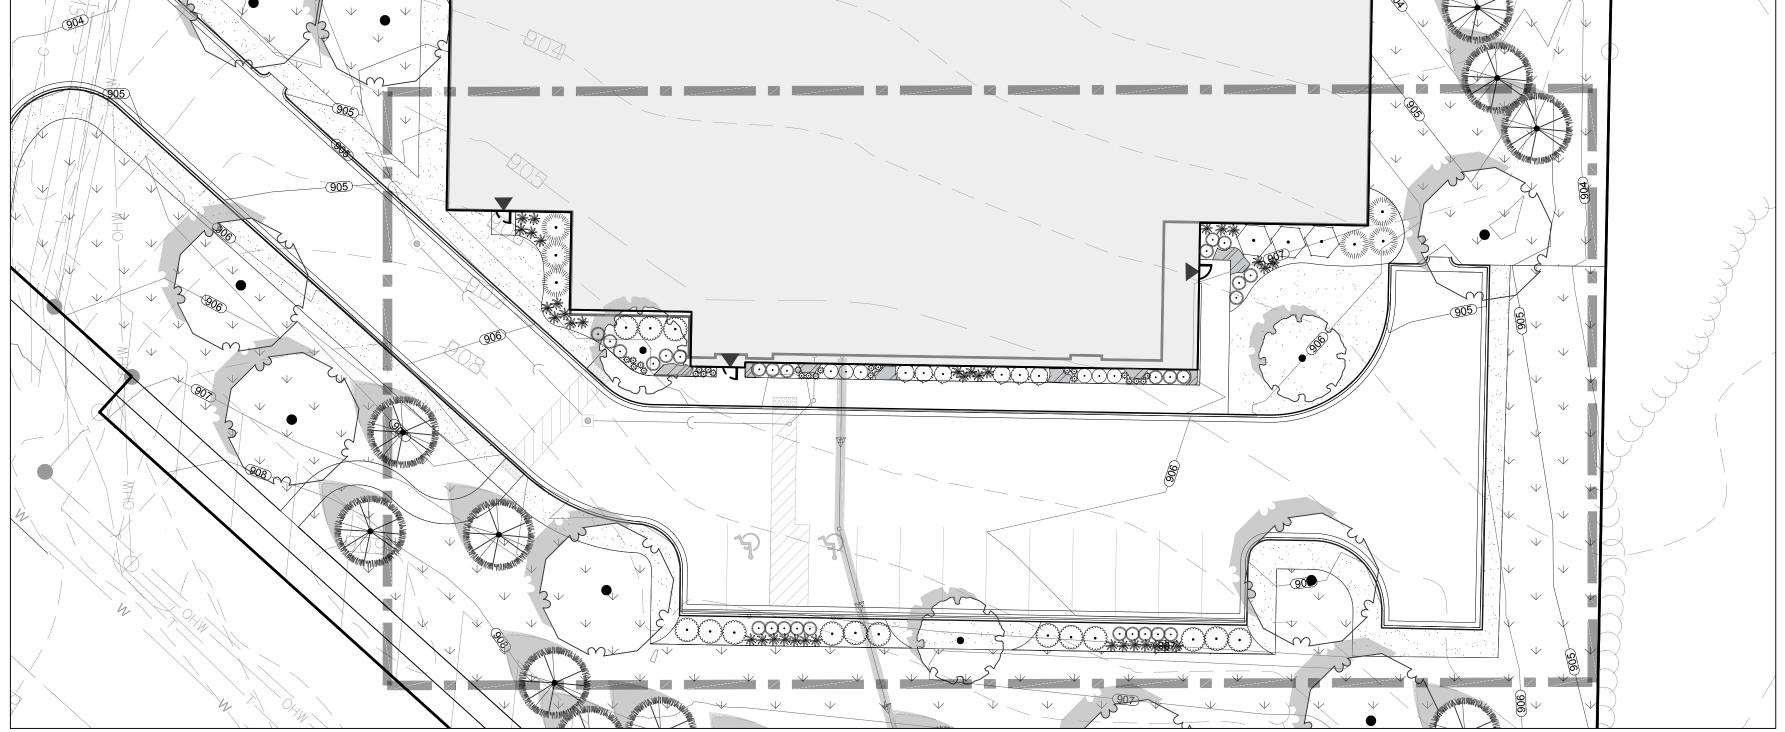

ENLARGEMENT L-2B

SCALE: 1"=20'



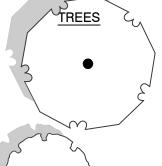

<u>SHRUBS</u>

BOTANICAL NAME

DECIDUOUS TREE Acer freemanii `Autumn Blaze` Celtis occidentalis `Chicagoland` Gymnocladus dioicus Quercus x schuetti

EVERGREEN TREE

Pinus cembra

Pinus sylvestris

Picea glauca `Densata`

Chicagoland Hackberry Kentucky Coffee Tree Swamp Bur Oak

COMMON NAME

Autumn Blaze Maple

Princess Diana Serviceberry

Fire King Musclewood

Black Lace Elderberry

Lemony Lace Elderberry

Bloomerang Purple Lilac

Brilliant Red Chokeberry Red Twig Dogwood

Blackhaw Viburnum

Hetz Columnar Juniper

Hicks Yew

Holmstrup Cedar

Mint Julep Juniper

Sea Green Juniper

Blue Switch Grass

Schottland Tufted Hair Grass

Standing Ovation Little Bluestem

Northern Lights Tufted Hair Grass

Hameln Dwarf Fountain Grass

Burgundy Bunny Dwarf Fountain Grass

Little Kitten Eulalia Grass

Tauton Yew

Butterflies Magnolia

ORNAMENTAL TREE Amelanchier x grandiflora `Princess Diana` Carpinus caroliniana `JN Strain` Magnolia x `Butterflies`

Black Hills Spruce Swiss Stone Pine Scotch Pine Douglas Fir

Pseudotsuga menziesii **COMMON NAME BOTANICAL NAME** SMALL DECIDUOUS SHRUBS

Cornus stolonifera `Arctic Fire` Arctic Fire Dogwood Hydrangea paniculata `Bobo` Bobo Hydrangea Physocarpus opulifolius `Nanus` Dwarf Ninebark Rosa x `Coral Drift` Coral Drift Rose

LARGE DECIDUOUS SHRUB Aronia arbutifolia `Brilliantissima` Cornus sericea `Baileyi` Viburnum prunifolium `Blackhaw`

MEDIUM DECIDUOUS SHRUB

Sambucus racemosa `SMNSRD4`

Sambucus nigra `Black Lace`

Syringa x 'Penda' TM

UPRIGHT EVERGREEN SHRUBS Juniperus chinensis `Hetzii` Taxus x media `Hicksii` Thuja occidentalis `Holmstrup`

SMALL EVERGREEN SHRUB Blue Chip Juniper Juniperus horizontalis `Blue Chip` Pinus strobus 'Blue Shag' Blue Shag White Pine Taxus x media `Everlow` Thuja occidentalis `Hetz Midget` Hetz Midget Arborvitae

MEDIUM EVERGREEN SHRUB Juniperus chinensis `Mint Julep` Juniperus chinensis `Sea Green Taxus x media `Tauntonii`

> TALL ORNAMENTAL GRASS Deschampsia cespitosa 'Schottland' Panicum virgatum `Heavy Metal` Schizachyrium scoparium 'Standing Ovation'


SHORT ORNAMENTAL GRASS Deschampsia cespitosa 'Northern Lights' Miscanthus sinensis 'Little Kitten' Pennisetum alopecuroides 'Burgundy Bunny'

Pennisetum alopecuroides `Hameln`

BOTANICAL NAME

PERENNIALS Ajuga reptans 'Black Scallop' Allium x `Millenium` Asclepias tuberosa `Hello Yellow` Aster novae-angliae 'Purple Dome' Coreopsis grandiflora 'Sunburst' Echinacea x `Sundown` Heuchera x `Caramel` Ligularia stenocephala `Little Rocket` Nepeta x faassenii 'Cat's Meow'


Perovskia atriplicifolia `Little Spire` TM Sedum x 'Autumn Fire' **BOTANICAL NAME**

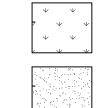

RAIN WATER RENEWAL SEED MIX

NO MOW TURF

TURF (SOD)

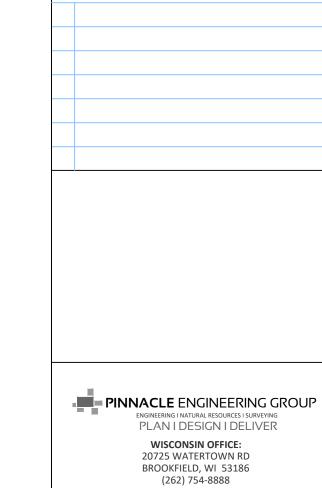

MSI GENERAL CORPORATION W215 E. WISCONSIN AVE.

NASHOTAH, WI 53058

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MILESTONE ISSUE DATES

OWNER REVIEW:

BUDGET SET:

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PLAN COMMISSION SET:

CONSTRUCTION SET:

RECORD DRAWING SET:

SUBMITTAL FOR PERMIT SET:

COMMON NAME Black Scallop Carpet Bugle Millenium Ornamental Onion Butterfly Milkweed Purple Dome New England Aster Sunburst Tickseed Sundown Purple Coneflower Caramel Coral Bells Little Rocket Ligularia Cat's Meow Catmint Little Spire Russian Sage

Autumn Fire Sedum

COMMON NAME

GRAPHICAL SCALE (FEET)

1" = 20'

- 2. THE CONTRACTOR IS RESPONSIBLE FOR INDEPENDENTLY DETERMINING THE PLANT MATERIAL QUANTITIES REQUIRED BY THE LANDSCAPE PLANS. REPORT ANY DISCREPANCIES TO THE LANDSCAPE ARCHITECT.
- 3. NO PLANT MATERIAL OR PLANT SIZE SUBSTITUTIONS WILL BE ACCEPTED WITHOUT APPROVAL BY THE LANDSCAPE ARCHITECT. ANY CHANGES SHALL BE SUBMITTED TO THE LANDSCAPE ARCHITECT IN WRITING PRIOR TO INSTALLATION
- 4. ALL BNB STOCK SHALL BE NURSERY GROWN IN A CLAY LOAM SOIL FOR A MINIMUM OF THREE GROWING SEASONS WITHIN 200 MILES OF PROJECT LOCATION, IN A ZONE COMPATIBLE WITH USDA HARDINESS ZONE 5A. SEED SHALL BE PROVIDED FROM A NURSERY (WITHIN 200 MILES) WITH A SIMILAR PLANT HARDINESS ZONE AS PROJECT LOCATION. EXISTING SOIL SHALL BE AMENDED PER SOIL ANALYSIS REPORT TO ENSURE A PROPER GROWING MEDIUM IS ACHIEVED.
- 5. ALL PLANT MATERIAL SHALL COMPLY WITH STANDARDS DESCRIBED IN AMERICAN STANDARD OF NURSERY STOCK - Z60.1 ANSI. LANDSCAPE ARCHITECT OR OWNERS AUTHORIZED REPRESENTATIVE RESERVES THE RIGHT TO INSPECT AND POTENTIALLY REJECT ANY PLANT MATERIAL DEEMED TO NOT MEET THE REQUIRED STANDARDS.
- 6. ALL STOCK SHALL BE FREE OF DISEASES AND HARMFUL INSECTS, DAMAGE, DISORDERS AND DEFORMITIES.
- 7. TREES SHALL HAVE SINGLE, STRAIGHT TRUNKS AND WELL BALANCED BRANCH SYSTEMS. MUTLI-STEM TREES SHALL HAVE 3-4 STRAIGHT TRUNKS AND WELL BALANCED BRANCH SYSTEMS. HEIGHT-TO-CALIPER RATIOS SHALL BE CONSISTENT WITH THE LATEST EDITION OF ANSI Z60.1.
- 8. ROOT SYSTEMS SHALL BE LARGE ENOUGH TO ALLOW FOR FULL RECOVERY OF THE TREE. AND SHALL CONFORM TO STANDARDS AS THEY APPEAR IN THE MOST CURRENT REVISION OF THE AMERICAN ASSOCIATION OF NURSERYMEN'S AMERICAN STANDARD OF NURSERY STOCK ANSI Z60.1.
- 9. BNB TREES SHALL BE DUG WITH A BALL OF SOIL, NOT SOFT BALLED OR POTTED AND SHALL BE FIRM IN THEIR ROOTBALL. ROOT BALL SHALL BE WRAPPED (WITH BIODEGRADABLE MATERIAL). THE TREE ROOT FLARE, OR COLLAR, SHALL BE AT OR WITHIN THE TOP THREE INCHES OF GRADE.
- 10. ALL SPRING TREES MUST BE FRESHLY DUG IN THE MOST RECENT SPRING.
- 11. ALL AUTUMN TREES MUST BE FRESHLY DUG IN THE MOST RECENT AUTUMN.
- 12. TREES SHALL BE ALIVE, HEALTHY AND APPROPRIATELY MOIST, AT TIME OF DELIVERY TREES SHALL BE SUBJECT TO INSPECTION FOR CONFORMITY TO SPECIFICATION REQUIREMENTS AND APPROVAL BY THE LANDSCAPE ARCHITECT OR OWNERS REPRESENTATIVE. THE LANDSCAPE ARCHITECT OR OWNERS REPRESENTATIVE RESERVES THE RIGHT TO REJECT ANY TREES THAT DO NOT MEET THE SPECIFICATIONS OR THAT HAVE BEEN DAMAGED DURING SHIPMENT. THE LANDSCAPE INSTALLER MUST RECEIVE APPROVAL FROM LANDSCAPE ARCHITECT FOR ANY SUBSTITUTIONS OR ALTERATIONS.
- 13. ALL PLANT MATERIAL SHALL BE INSTALLED IN ACCORDANCE WITH PLANTING DETAILS.
- 14. ALL PLANTING BEDS SHALL HAVE A MINIMUM 10" DEPTH OF PREPARED SOIL. WITH APPROVAL, EXISTING SOIL MAY BE UTILIZED PROVIDED THE PROPER SOIL AMENDMENTS ARE TILLED THOROUGHLY INTO THE TOP 10" OF SOIL. REFER TO SOIL PLACEMENT NOTES.
- 15. WHILE PLANTING TREES AND SHRUBS, BACKFILL 2 OF PLANTING HOLE AND WATER TREE THOROUGHLY BEFORE INSTALLING THE REMAINDER OF SOIL MIXTURE. AFTER ALL SOIL HAS BEEN PLACED INTO THE PLANTING HOLE WATER THOROUGHLY AGAIN.
- 16. THE CONTRACTOR MUST LABEL ALL TREES WITH THE COMMON AND BOTANICAL NAMES. PRIOR TO FINAL INSPECTION.
- 17. OAK TREES SHALL BE TREATED FOR TWO-LINE CHESTNUT BORER BOTH AT THE TIME OF INSTALLATION AND DURING THE SECOND GROWING SEASON.
- 18. ALL PLANTING BEDS SHALL BE MULCHED WITH 3" DEEP SHREDDED HARDWOOD MULCH, AND ALL TREES PLANTED IN TURF AREAS SHALL RECEIVE A 3" DEEP SHREDDED HARDWOOD MULCHED RING AS SHOWN IN PLANTING DETAILS.
- 19. ALL PLANTING BEDS AND TREE RINGS SHALL HAVE A 4" DEEP TRENCHED BED EDGE CREATED BY EITHER A FLAT LANDSCAPE SPADE OR MECHANICAL EDGER. BED EDGES ARE TO BE CUT CLEAN AND SMOOTH AS SHOWN ON LANDSCAPE PLANS WITH A CLEAN DEFINITION BETWEEN TURF AND PLANTING AREAS.
- 20. ALL TURF SEED AREAS SHALL RECEIVE A MINIMUM OF 6" DEPTH OF TOPSOIL. WITH APPROVAL, EXISTING SOIL MAY BE UTILIZED PROVIDED THE PROPER SOIL AMENDMENTS ARE TILLED THOROUGHLY INTO THE TOP 6" OF SOIL AS INDICATED IN THE SOIL PLACEMENT NOTES. REQUIRED AMENDMENTS SHALL BE DETERMINED BASED ON A SOIL ANALYSIS TO BE PERFORMED. ALL TOPSOIL AMENDMENT SHALL BE AGED WEED FREE MANURE OR CLASS 1 ORGANIC MATTER.
- 21. FOR LAWN SEEDING, APPLY A STARTER FERTILIZER AND SEED UNIFORMLY AT THE RATE RECOMMENDED BY MANUFACTURER, AND PROVIDE A MULCH COVERING THAT IS SUITABLE TO PROMOTE SEED GERMINATION AND TURF ESTABLISHMENT. CONTRACTOR TO PROVIDE FERTILIZER, SEED, AND MULCH SPECIFICATIONS TO THE LANDSCAPE ARCHITECT FOR APPROVAL PRIOR TO INSTALLATION. EROSION CONTROL MEASURES ARE TO BE INSTALLED IN THOSE AREAS REQUIRING STABILIZATION (SWALES, SLOPES EXCEEDING 1:3, AND THOSE LOCATIONS INDICATED IN CIVIL DRAWINGS).
- 22. THE CONTRACTOR TO ENSURE A SMOOTH, UNIFORM QUALITY TURF IS ACHIEVED WITH NO BARE SPOTS LARGER THAN 6" X 6". ANY BARE SPOTS LARGER THAN 6" X6" AT THE END OF ESTABLISHMENT PERIOD SHALL BE RESEEDED AT THE CONTRACTORS EXPENSE TO OBTAIN A DENSE, UNIFORM LAWN.
- 23. ALL SODDED AREAS SHALL RECEIVE A MINIMUM OF 2" DEPTH OF TOPSOIL. WITH APPROVAL, EXISTING SOIL MAY BE UTILIZED PROVIDED THE PROPER SOIL AMENDMENTS ARE TILLED THOROUGHLY INTO THE TOP 6" OF SOIL AS INDICATED IN THE SOIL PLACEMENT NOTES. APPLY A 10-10-10 STARTER FERTILIZER UNIFORMLY AT RECOMMENDED RATES PRIOR TO INSTALLATION OF SOD. INSTALL SOD UNIFORMLY WITH STAGGERED JOINTS, LAID TIGHTLY END TO END AND SIDE TO SIDE. ROLL SOD WITH A WALK BEHIND ROLLER AND WATER IMMEDIATELY TO A DEPTH OF 3". SOD INSTALLED IN SWALES AND ON SLOPES EXCEEDING 1:3 SHALL BE STAKED. CONTRACTOR IS RESPONSIBLE TO PROVIDE A SMOOTH, UNIFORM, HEALTHY LAWN. CONTRACTOR SHALL BE RESPONSIBLE FOR THE FIRST 2 MOWINGS AND WATERING DURING THIS ESTABLISHMENT PERIOD.
- 24. ALL FINISH GRADING AND LAWN AREAS TO BE INSTALLED BY LANDSCAPE CONTRACTOR.
- 25. ALL DISTURBED AREAS WITHIN THE PROJECT SHALL BE RESTORED TO ORIGINAL OR BETTER CONDITION.
- 26. ALL DISTURBED AREAS OUTSIDE THE LIMITS OF WORK SHALL BE RESTORED TO ORIGINAL OR BETTER CONDITION AT NO ADDITIONAL COST TO THE OWNER.
- 27. THE CONTRACTOR SHALL VERIFY ALL EXISTING UTILITIES, INCLUDING ANY IRRIGATION LINES, PRIOR TO DIGGING. CONSULT DIGGERS HOTLINE. TREES SHALL BE INSTALLED NO

CLOSER THAN:

- -10 FEET FROM ANY FIRE HYDRANT
- 7 FEET FROM STORM SEWER, SANITARY SEWER LATERALS, DRIVEWAYS, AND WATER SERVICE
- 28. THE CONTRACTOR SHALL ENSURE THAT SOIL CONDITIONS AND COMPACTION ARE ADEQUATE TO ALLOW FOR PROPER DRAINAGE AROUND THE CONSTRUCTION SITE UNDESIRABLE CONDITIONS SHALL BE BROUGHT TO THE ATTENTION OF THE LANDSCAPE ARCHITECT PRIOR TO BEGINNING OF WORK. IT SHALL BE THE CONTRACTOR'S RESPONSIBILITY TO ENSURE PROPER SURFACE AND SUBSURFACE DRAINAGE IN ALL
- 29. RETAINING WALL TO BE CONSTRUCTED UTILIZING A MODULAR BLOCK SYSTEM SPECIFIED BY OWNER. MODULAR BLOCK WALL SHALL BE DESIGNED BY A STRUCTURAL ENGINEER AND INSTALLED PER MANUFACTURER'S RECOMMENDATIONS. CONTRACTOR SHALL SUBMIT SHOP DRAWINGS AND PRODUCT DATA FOR APPROVAL BY OWNER OR OWNERS REPRESENTATIVE.
- 30. THE CONTRACTOR IS RESPONSIBLE FOR ALL PERMITS, FEES, AND LICENSES NECESSARY FOR THE INSTALLATION OF THIS PLAN.
- 31. THE CONTRACTOR IS TO REVIEW ALL SITE ENGINEERING DOCUMENTS PRIOR TO INSTALLATION. ANY CONFLICTS MUST BE REPORTED TO THE LANDSCAPE ARCHITECT THESE LANDSCAPE DRAWINGS ARE FOR THE INSTALLATION OF PLANT MATERIALS ONLY UNLESS OTHERWISE STATED.
- 32. THE CONTRACTOR SHALL PROVIDE WATERING AND MAINTENANCE SERVICES FOR A PERIOD OF 60 DAYS TO ENSURE VEGETATIVE ESTABLISHMENT. UPON COMPLETION OF THE PROJECT, CONTRACTOR SHALL SUPPLY THE OWNER IN WRITING WITH ONGOING WATERING AND MAINTENANCE INSTRUCTIONS.
- 33. PLANT MATERIALS SHALL BE GUARANTEED FOR A PERIOD OF ONE (1) YEAR FROM TIME OF OWNER ACCEPTANCE. ONLY ONE REPLACEMENT PER PLANT WILL BE REQUIRED DURING THE WARRANTY PERIOD EXCEPT IN THE EVENT OF FAILURE TO COMPLY WITH THE SPECIFIED REQUIREMENTS.
- 34. THE CONTRACTOR IS RESPONSIBLE TO CONDUCT A FINAL WALK THROUGH WITH THE LANDSCAPE ARCHITECT AND OR OWNERS REPRESENTATIVE TO ANSWER QUESTIONS PROVIDE INSTRUCTIONS, AND ENSURE THAT PROJECT REQUIREMENTS HAVE BEEN MET.

SOIL PLACEMENT NOTES

- LOOSEN SUBGRADE TO A MINIMUM DEPTH INDICATED IN PLANTING NOTES USING A CULTI-MULCHER OR SIMILAR EQUIPMENT, AND REMOVE STONES MEASURING OVER 1-1/2 INCHES IN ANY DIMENSION, STICKS, RUBBISH AND OTHER EXTRANEOUS MATTER. AREAS ADJACENT TO WALKS AND PAVEMENT SHALL BE FREE OF EXCESS STONE AND PAVING MATERIALS SO AS TO PROVIDE AN UNINTERRUPTED CROSS SECTION OF SOIL. INTERNAL PARKING ISLANDS SHALL BE LOOSENED TO A DEPTH OF 30".
- 2. THOROUGHLY BLEND PLANTING SOIL MIX FOR PLANTING BED AREAS. (1 PART EXISTING SOIL, 1 PART TOPSOIL, 1 PART ORGANIC SOIL AMENDMENT, 2.9 POUNDS PER CUBIC YARD OF 4-4-4 ANALYSIS SLOW-RELEASE FERTILIZER)
- 3. TREE AND SHRUB HOLES SHALL BE FILLED WITH A PREPARED PLANTING MIXTURE OF 1 PART TOPSOIL, 2 PARTS PLANTING SOIL MIX.
- 4. SPREAD SOIL AND SOIL AMENDMENTS TO DEPTH INDICATED ON DRAWINGS, BUT NOT LESS THAN REQUIRED TO MEET FINISH GRADES AFTER NATURAL SETTLEMENT. (FINISH GRADE OF PLANTING BEDS SHALL BE 3" BELOW ALL ADJACENT SURFACES. FINISH GRADE OF TURF SEEDING AREAS SHALL BE 1" BELOW ALL ADJACENT HARD SURFACES, WALKS, AND CURBS.
- 5. PLACE APPROXIMATELY 1/2 OF TOTAL AMOUNT OF SOIL REQUIRED. WORK INTO TOP OF LOOSENED SUBGRADE TO CREATE A TRANSITION LAYER, THEN PLACE REMAINDER OF THE SOIL. SOIL TRANSITION LAYER SHALL BE TILLED TO A MINIMUM DEPTH OF 6" BELOW THE DEPTH OF NEWLY PLACED SOIL. PARKING LOT ISLANDS SHALL BE CROWNED TO A HEIGHT OF 6" TO PROVIDE PROPER DRAINAGE UNLESS OTHERWISE NOTED.
- DO NOT SPREAD IF PLANTING SOIL OR SUBGRADE IS FROZEN, MUDDY, OR EXCESSIVELY
- 7. FINISH GRADING: GRADE SOIL TO A SMOOTH, UNIFORM SURFACE PLANE WITH A LOOSE, UNIFORMLY FINE TEXTURE.
- ROLL AND RAKE, REMOVE RIDGES, AND FILL DEPRESSIONS TO MEET FINISH GRADES.
- RESTORE PLANTING BEDS IF ERODED OR OTHERWISE DISTURBED AFTER FINISH GRADING AND BEFORE PLANTING.

NATIVE PLANTINGS (RAINWATER RENEWAL MIX)

SPECIFICATIONS FOR HAND BROADCASTING:

SEEDING SHALL BE CONDUCTED IN LATE FALL (SEPTEMBER 1- SOIL FREEZE) SO THAT SEEDS MAY LIE DORMANT DURING THE WINTER, ALLOWING FOR STRATIFICATION, OR SPRING (MARCH 1-JUNE 1) TO ALLOW A COMPLETE GROWING SEASON TO BECOME ESTABLISHED.

ESTABLISHMENT OF A VIABLE VEGETATION COMMUNITY WITHIN THE BIO INFILTRATION BASINS WILL BE COMPLETED BY HAND-BROADCASTING OF PRE-DESIGNED SEED MIXES AND PLANTING OF PERENNIALS TO CREATE A DYNAMIC PLANTING.

PRIOR TO SEEDING/PLUG PLANTING:

ALL WEEDS AND EXISTING VEGETATION SHALL BE REMOVED. EXISTING VEGETATION SHALL BE TREATED WITH GLYPHOSATE OR SIMILAR HERBICIDE BY A LICENSED PROFESSIONAL. TREATMENT SHALL OCCUR A MINIMUM OF 10 DAYS PRIOR TO SEEDING/PLANTING. VEGETATION STILL ALIVE AFTER INITIAL HERBICIDE TREATMENT SHALL BE TREATED A SECOND TIME PRIOR TO TILLING INTO THE SOIL.TREATED VEGETATION SHALL BE TILLED INTO THE SOIL NO EARLIER THAN 1 DAY PRIOR TO SEEDING.

A. PREPARATION OF SOIL PRIOR TO SEEDING

- 1. REFER TO CIVIL PLANS FOR SOIL MIX
- 2. ALL FOREIGN MATERIALS LARGER THAN 1-INCH SHALL BE REMOVED FROM THE SOIL PRIOR TO SEEDING OR PLANTING.
- AREA SHOULD BE FREE FROM UNSIGHTLY VARIATIONS, RIDGES, AND DEPRESSIONS.
- 4. AVOID DRIVING OVER THE SPECIFIED AREA WITH MACHINERY

B. COVER CROP

- 1. ANNUAL RYE SHALL BE SPREAD AT A DENSITY OF 20 POUNDS PER ACRE DURING THE PLANTING OR SEEDING OF THE NATIVE PLANT SPECIES TO STABILIZE THE SOIL AND REDUCE THE GROWTH OF UNWANTED VEGETATION. THIS ANNUAL GRASS GROWS RAPIDLY WITHOUT COMPETING WITH THE WILDFLOWERS AND GRASSES THAT ARE PLANTED IN THE TARGET AREAS
- 2. WINTER WHEAT OR PERENNIAL RYE SHALL NOT BE USED AS A COVER CROP. THESE GRASSES MAY OUT COMPETE PRAIRIE SEEDLINGS, LEADING TO A REDUCTION IN THE SUCCESS OF THE PLANTINGS.

SEED MIX: MIX ALL PRAIRIE SEED WITH VERMICULITE ACCORDING TO AGRECOL

- RECOMMENDATIONS AND INSTALLATION GUIDELINES. 1. BROADCAST HALF THE SEED OVER THE ENTIRE SITE OR TARGET AREA.
- 2. BROADCAST THE OTHER HALF OF SEED PERPENDICULAR TO THE DIRECTION THAT THE FIRST HALF OF THE SEED WAS BROADCAST.
- 3. COVER SEED WITH $\frac{1}{4}$ -INCH TO $\frac{1}{2}$ -INCH OF SOIL (USE ANY EXCESS SOIL FROM THE SITE) WITH RAKE
- 4. ROLL SITE TO ENSURE FIRM SEED-TO-GROUND CONTACT.
- 5. KEEP SEED CONSTANTLY WET THROUGH GERMINATION PERIOD. GENERALLY 3 WEEKS.

ALL SEEDING SHALL BE COVERED WITH 1-INCH OF CLEAN, NON-INVASIVE STRAW (NO MARSH HAY, OR REED CANARY GRASS) WITHOUT SEEDS, WITHIN SEVEN DAYS. WHEAT, RYE, OATS, OR BARLEY ARE ACCEPTABLE FORMS OF STRAW. THOSE AREAS OF SLOPES STEEPER THAN 8:1 (EIGHT FEET HORIZONTAL TO ONE FOOT VERTICAL) SHALL BE PLANTED NO LATER THAN OCTOBER 1 AND STAKED WITH AN EROSION CONTROL BLANKET TO PREVENT EROSION.

NATIVE PLANTINGS:

WEED SUPPRESSION MEASURES:

1st YEAR - PERFORM SPOT SPRAY WITH HERBICIDE TO SUPPRESS WEEDS. THIS SHOULD OCCUR APPROXIMATELY EVERY MONTH OF THE GROWING SEASON AFTER NATIVE PLANTINGS HAVE BEEN ROUGH GRADED.

2nd YEAR - IN MAY/JUNE MOW NATIVE PLANTINGS AT 6" HEIGHT TO SUPPRESS THE WEEDS. PERFORM SPOT SPRAY WITH HERBICIDE TO SUPPRESS WEEDS. HAVE PROFESSIONAL ASSESS PLANTINGS. REPEAT MOWING NATIVE PLANTINGS AND SPOT-SPRAY IN EARLY JULY.

3rd YEAR - IN MAY/JUNE MOW NATIVE PLANTINGS AT 8" HEIGHT TO SUPPRESS THE WEEDS. PERFORM SPOT SPRAY WITH HERBICIDE TO SUPPRESS WEEDS.

4th YEAR - IN MAY PERFORM A PRESCRIBED BURN. IN JUNE HAVE A QUALIFIED PROFESSIONAL ASSESS PLANTINGS. IF A PRESCRIBED BURN CAN NOT BE UTILIZED. NATIVE PLANTINGS SHALL BE CUT TO THE GROUND AND ALL CUT MATERIAL SHALL BE REMOVED AND DISPOSED OF OFF SITE.



DESIGNBUILD

MSI GENERAL CORPORATION W215 E. WISCONSIN AVE. NASHOTAH, WI 53058 262.367.3661 | MSIGENERAL.COM

SINGLE SOURCE RESPONSIBILITY.™ DESIGNING EXCELLENCE. BUILDING TRUST.TM MILESTONE ISSUE DATES OWNER REVIEW: 10/13/2022 **BUDGET SET:** PROPOSAL SET: PLAN COMMISSION SET SUBMITTAL FOR PERMIT SET CONSTRUCTION SET **RECORD DRAWING SET REVISIONS:**

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RCHI

PINNACLE ENGINEERING GROUP PLAN I DESIGN I DELIVER WISCONSIN OFFICE: 20725 WATERTOWN RD BROOKFIELD, WI 53186 (262) 754-8888 CHICAGO I MILWAUKEE : NATIONWIDE PEG PROJECT #: 2989.00



(ACCURATE SPECIALTIES INC.) PROJECT DESCRIPTION

FISHER BARTON GROUP

570 Bluemound Road CITY/ STATE / ZIP

STREET ADDRESS

ALL WORK TO BE COMPLETED AS SHOWN, AND IN ACCORDANCE WITH THE LATEST EDITION OF THE MSI GENERAL MASTER SPECIFICATION

ARCHITECT

MTS TNK

SHEET NUMBER:

P13417

Waukesha, WI 53188

DJB

SPIRE ENGINEERING CIVIL ENGINEER : REVIEWED BY MTS

SHEET TITLE: LANDSCAPE NOTES

PROJECT NUMBER:

EER

ENGINI

CONTRACTORS

ARCHITECT

20725 WATERTOWN RD (262) 754-8888





FISHER BARTON GROUP (ACCURATE SPECIALTIES INC.)

> ALL WORK TO BE COMPLETED AS SHOWN, AND IN ACCORDANCE WITH THE LATEST EDITION OF THE MSI GENERAL MASTER SPECIFICATION

> > SPIRE **ENGINEERING**


CIVIL ENGINEER: REVIEWED BY MTS MTS

SHEET TITLE:

LANDSCAPE DETAILS

PROJECT NUMBER:

P13417

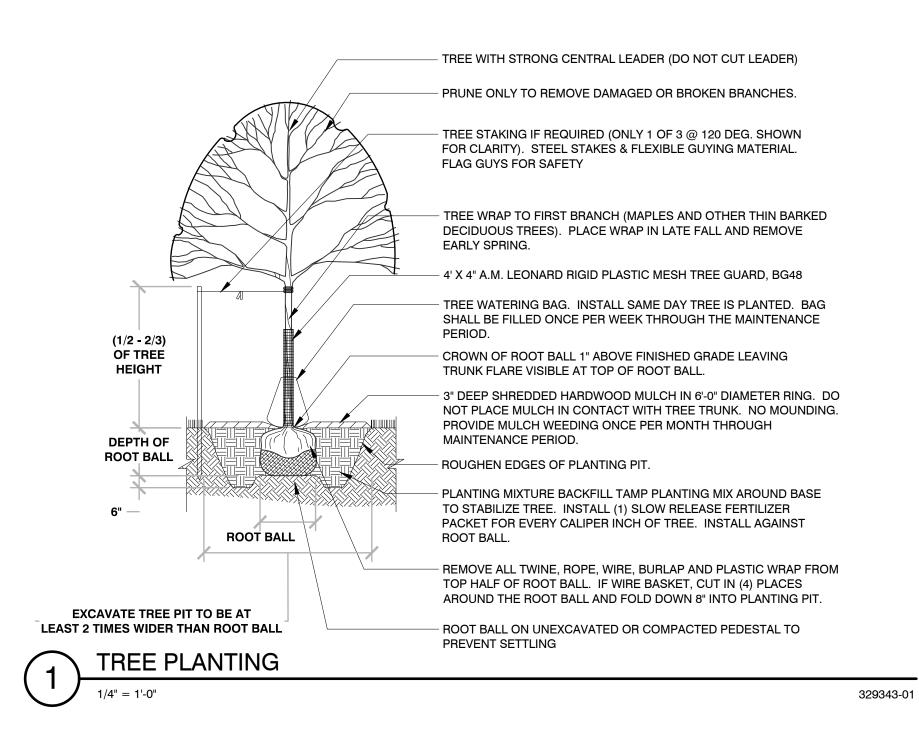

FIF NEEDED, PRUNE TO REMOVE DAMAGED, BROKEN, OR OVERLAPPING BRANCHES ONLY AFTER PLANTING. PRUNING IS SUBJECT TO TIME OF YEAR FOR EACH INDIVIDUAL SPECIES. TREE STAKING (ONLY 1 OF 3 @ 120 DEG. SHOWN FOR CLARITY). 3" DIAMETER CEDAR WOOD STAKES & FLEXIBLE GUYING MATERIAL. FLAG GUYS FOR SAFETY. STAKES SHALL NOT TOUCH THE SIDES OF ROOT BALL WHEN INSTALLED. CROWN OF ROOT BALL 2" ABOVE FINISHED GRADE LEAVING TRUNK FLARE VISIBLE AT TOP OF ROOT BALL. (1/2) OF TREE - 3" DEEP SHREDDED HARDWOOD MULCH IN 6'-0" DIAMETER RING. DO HEIGHT NOT PLACE MULCH IN CONTACT WITH TREE TRUNK. NO MOUNDING. PROVIDE MULCH WEEDING ONCE PER MONTH THROUGH MAINTENANCE PERIOD. - ROUGHEN EDGES OF PLANTING PIT. DEPTH OF ROOT BALL PLANTING MIXTURE BACKFILL. TAMP PLANTING MIX AROUND BASE TO STABILIZE TREE. INSTALL (1) SLOW RELEASE FERTILIZER PACKET FOR EVERY 24" OF TREE HEIGHT. INSTALL PACKET ROOT BALL REMOVE ALL TWINE, ROPE, WIRE, BURLAP AND PLASTIC WRAP FROM TOP HALF OF ROOT BALL. IF WIRE BASKET, CUT IN (4) PLACES AROUND THE ROOT BALL AND FOLD DOWN 8" INTO ROOT BALL ON UNEXCAVATED OR COMPACTED PEDESTAL TO EXCAVATE TREE PIT TO BE AT PREVENT SETTLING **LEAST 2 TIMES WIDER THAN ROOT BALL**

329343-03

EVERGREEN TREE PLANTING

- PERENNIAL PLANTING

ROOT BOUND

PLANTING MIX

- SUBGRADE

FINISHED GRADE TOP OF MULCH

- HAND LOOSEN AND PULL ROOTS

OUT OF CONTAINER MATERIAL TO PREVENT PLANT FROM BECOMING

3293-03

SHRUB PLANTING PRUNE ONLY TO REMOVE DEAD PER PLANT SPACING -OR BROKEN BRANCHES BOTTOM OF ROOT FLARE FLUSH WITH FINISHED GRADE 3" MULCH HAND LOOSEN AND PULL ROOTS OUT OF CONTAINER MATERIAL TO PREVENT PLANT FROM BECOMING ROOT BOUND REMOVE ALL TWINE, ROPE, WIRE, BURLAP AND PLASTIC WRAP FROM TOP HALF OF ROOT BALL BALLED BARE ROOT

BAREROOT PLANTING NOTES: SOAK ROOTS IN WATER FOR AT LEAST ONE HOUR BUT NOT MORE THAN 24 HOURS PRIOR TO PLANTING.

SCARIFY 4" AND RECOMPACT

SUBGRADE

2. SCARIFY SIDES AND BOTTOMS OF HOLE. 3. PROCEED WITH CORRECTIVE PRUNING OF THE TOP AND BOTTOM ROOTS.

4. TRANSFER PLANT DIRECTLY FROM WATER TO HOLE. SET PLANT SO THE ROOT FLARE IS

APPROXIMATELY AT THE FINISHED SOIL ELEVATION. SPREAD ROOTS OUT EVENLY. PLUMB AND IMMEDIATELY BACKFILL WITH PLANTING SOIL MIX.

5. WATER THOROUGHLY WITHIN 2 HOURS TO SETTLE PLANTS AND FILL VOIDS.

6. BACKFILL VOIDS AND WATER SECOND TIME. 7. PLACE MULCH WITHIN 48 HOURS OF THE SECOND WATERING UNLESS SOIL MOISTURE IS EXCESSIVE.

SHRUB PLANTING

CONTAINER

BURLAPPED

PERENNIAL PLANTING

PER PLANT SPACING

SHRUB OR PERENNIAL

- FINISHED GRADE - STRAIGHT, CLEAN CUT THROUGH GRASS - MULCH BED - 45° ANGLE CUT BACK TO FINISHED GRADE OF MULCH BED

(*) = SPECIFIED PLANT SPACING PER PLANTING LIST

PLANT SPACING

TRENCHED BED EDGE

OWNER REVIEW: BUDGET SET:

PROPOSAL SET: PLAN COMMISSION SET: SUBMITTAL FOR PERMIT SET:

DESIGNBUILD

MSI GENERAL CORPORATION

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NASHOTAH, WI 53058

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BROOKFIELD, WI 53186



PROJECT DESCRIPTION

STREET ADDRESS 570 Bluemound Road

CITY/ STATE / ZIP Waukesha, WI 53188

DJB

TNK

SHEET NUMBER:

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MILESTONE ISSUE DATES

OWNER REVIEW:

BUDGET SET:

PROPOSAL SET:

PLAN COMMISSION SET:

CONSTRUCTION SET:

REVISIONS:

RECORD DRAWING SET:

SUBMITTAL FOR PERMIT SET:

Single Stem

Multi-Stem

Single Stem

Single Stem

Single Stem

Single Stem

Single Stem

Multi-Stem

Single Stem

Single Stem

Single Stem

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10/13/2022

CONTRACTORS

ARCHITECTS

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(262) 754-8888

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DJB

SPIRE ENGINEERING DESIGN ARCHITECT

CIVIL ENGINEER: REVIEWED BY MTS MTS TNK


SHEET TITLE:

EXISTING TREE INVENTORY

PROJECT NUMBER:

SHEET NUMBER:

P13417

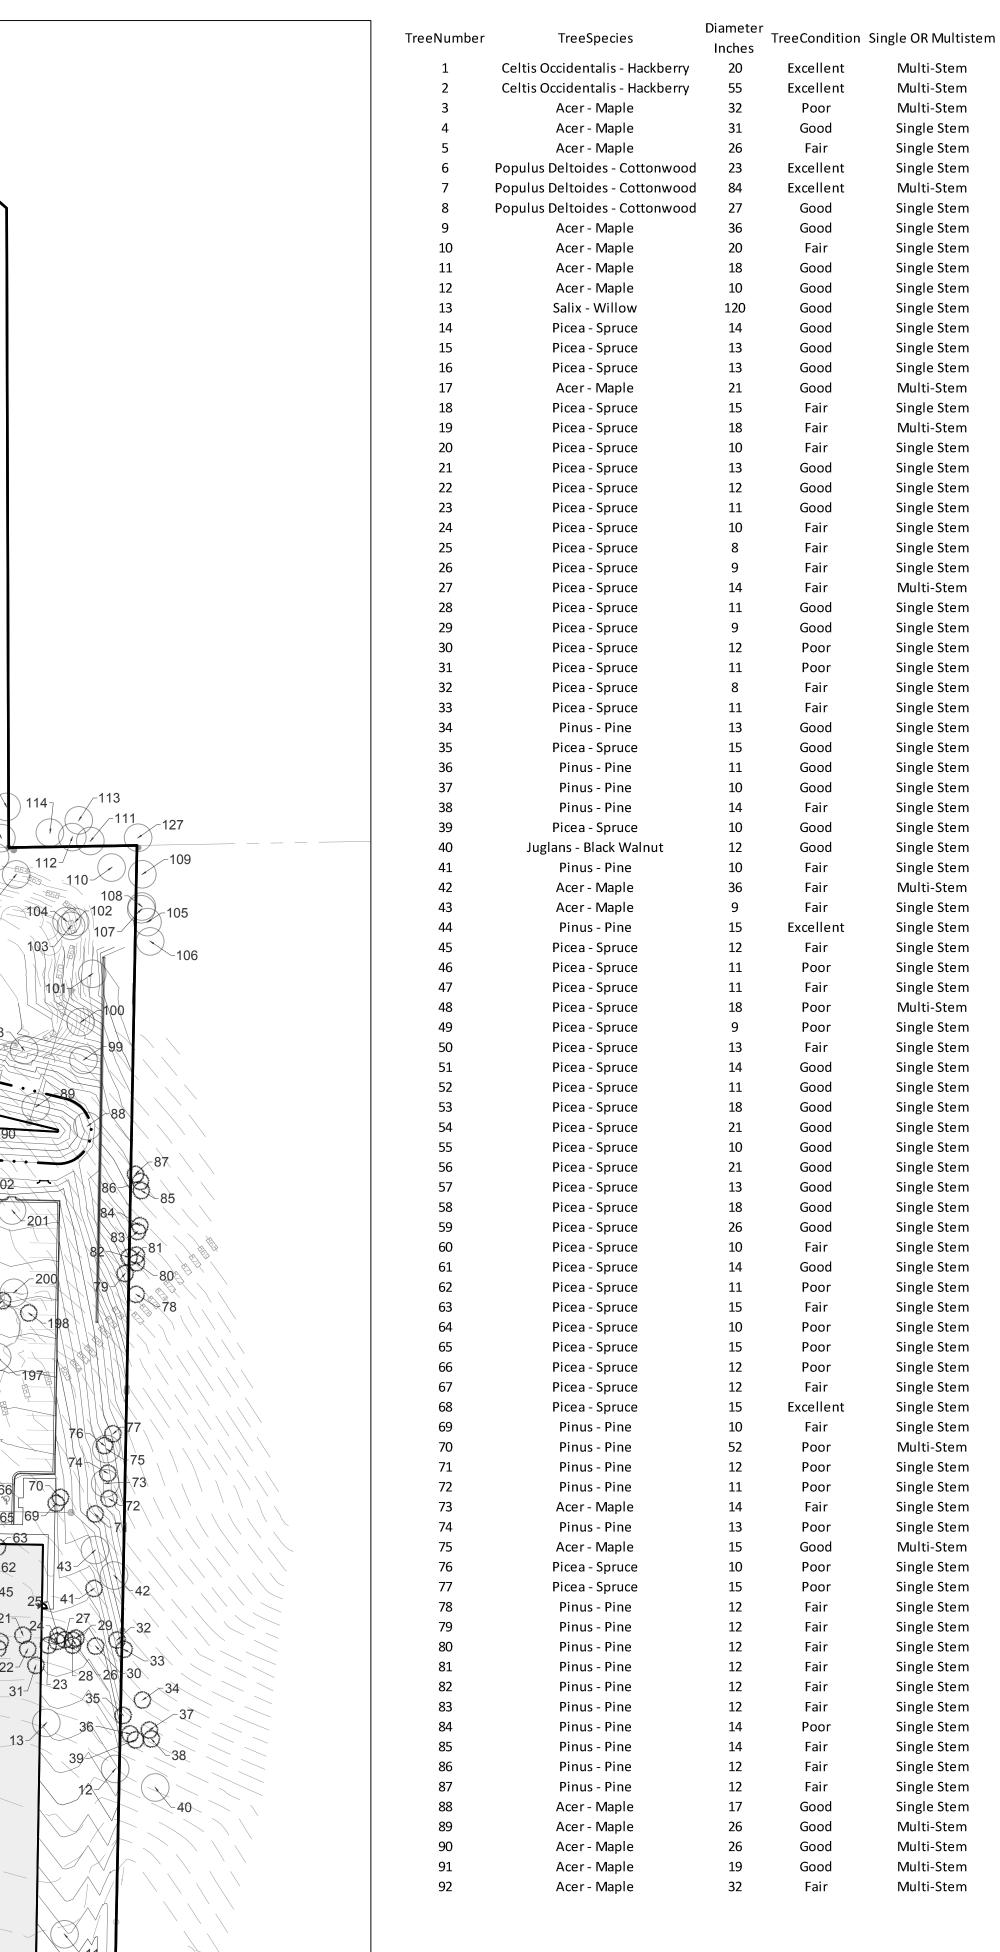

WOODED

PROPOSED BUILDING ±6,000 SQ. FT. FFE = 877.00


WOODED


117

PROPOSED BUILDING

±55,989 SQ. FT.

LLE = 894.00

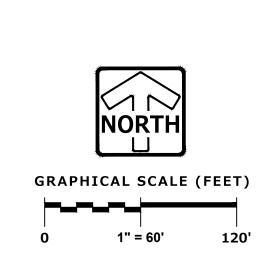

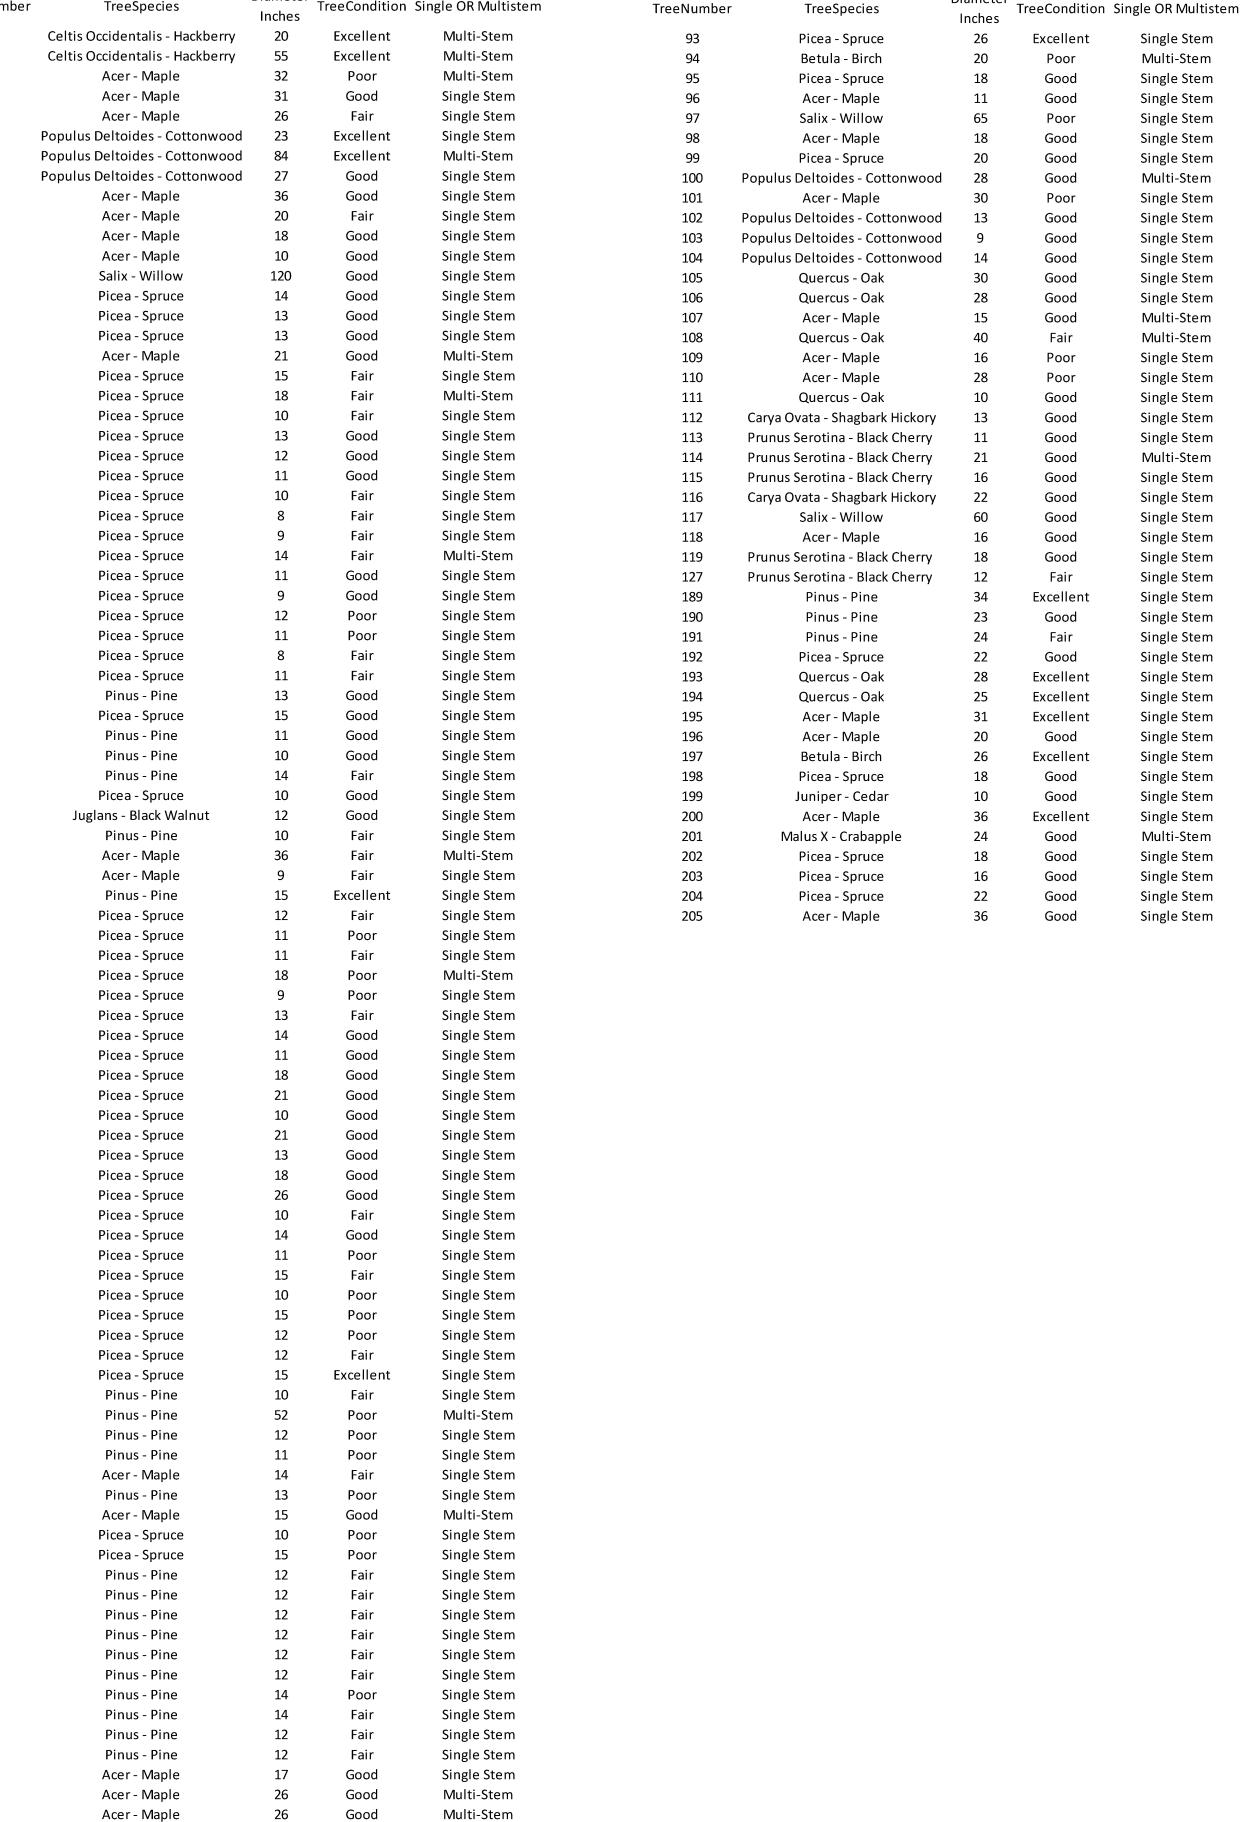

Multi-Stem

Multi-Stem