
SUNSET CROSSING OUTLOT


for LOCKARD CONSTRUCTION Waukesha, Wisconsin

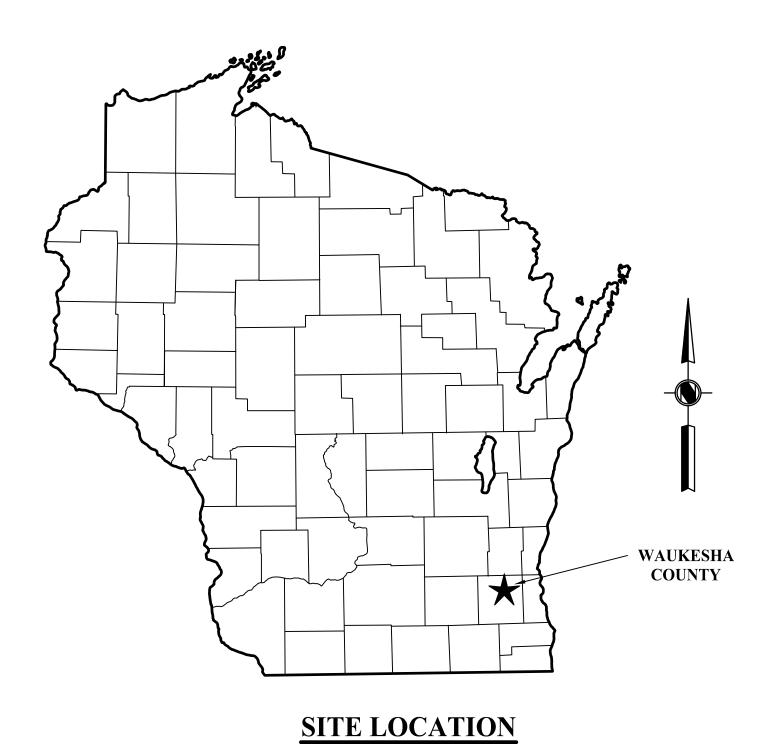

NOT TO SCALE

SHEET INDEX

	SHEET IT (DEAT
SHEET NO.	TITLE
C-1	SITE PLAN
C-2	GRADING AND EROSION CONTROL PLAN
C-3	PAVING AND UTILITY PLAN
C-4	STANDARD DETAILS
TM-1	TURNING MANEUVER SEMI TRAILER
TM-2	TURNING MANEUVER FIRE TRUCK
REVIEW LSP1-1 LSP1-2	LANDSCAPE DETAILS PHOTOMETRIC PLAN FLOOR PLAN

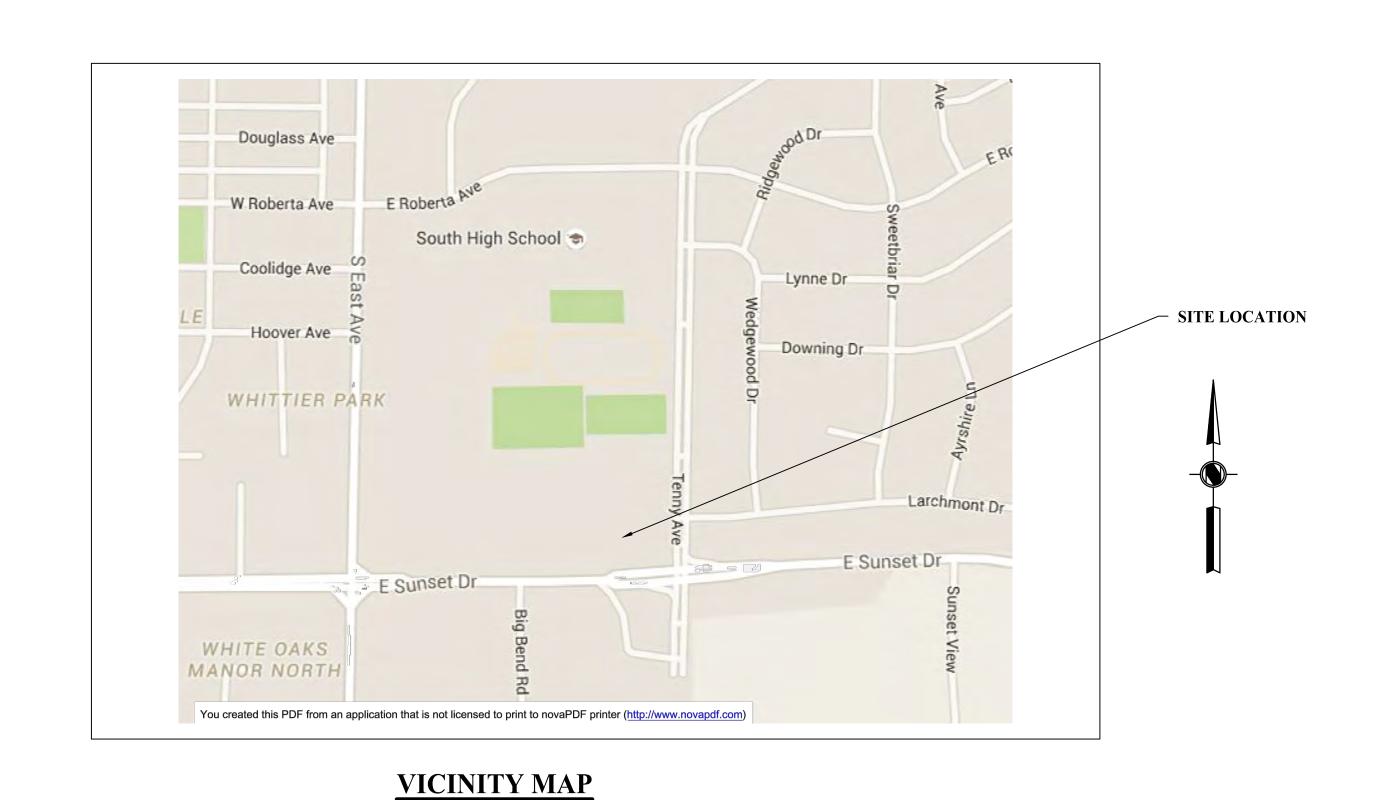





1.) ALL EROSION CONTROL DEVICES SHALL BE IN PLACE PRIOR TO ANY LAND DISTURBANCE ACTIVITIES. DEVICES SHALL BE INSTALLED AND MAINTAINED PER WISCONSIN DEPARTMENT OF NATURAL RESOURCES BEST MANAGEMENT PRACTICES (BMPs), TECHNICAL STANDARDS.

2.) ALL DIMENSIONS ARE TO FACE OF CURB OR EDGE OF PAVEMENT UNLESS OTHERWISE NOTED.

3.) CONTRACTOR SHALL COORDINATE ALL UTILITY WORK WITH APPROPRIATE PUBLIC UTILITY COMPANIES.

STORM SEWER MANHOLE

STORM SEWER INLET

SANITARY SEWER MANHOLE

LIGHT POLE

HYDRANT

WV
WATER VALVE

POWER POLE

TO OBTAIN LOCATIONS OF PARTICIPANTS UNDERGROUND FACILITIES BEFORE YOU DIG IN WISCONSIN

MEMBER


CALL DIGGERS HOTLINE


1-800-242-8511 TOLL FREE

WIS STATUTE 182.0175(1974) REQUIRES MIN. 3 WORK DAYS NOTICE BEFORE YOU EXCAVATE

MILW. AREA 259-1181

<u>LEGEND</u>

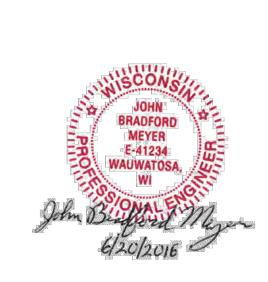

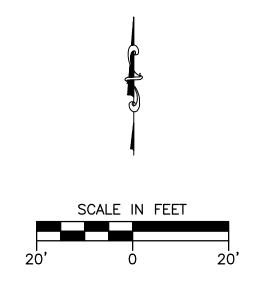

SITE PLAN
SUNSET CROSSING OUTLOT
LOCKARD CONSTRUCTION
WAUKESHA, WISCONSIN

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NECESSARY TO AVOID DAMAGE THERETO."

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MILWAUKEE, WI 53202
414.224.8300 (tel) - 414.2.




PROJECT NUMBER
2604012

PROJECT SCALE
1" = 20'

SHEET NUMBER

SHEET NUMBER


C-1

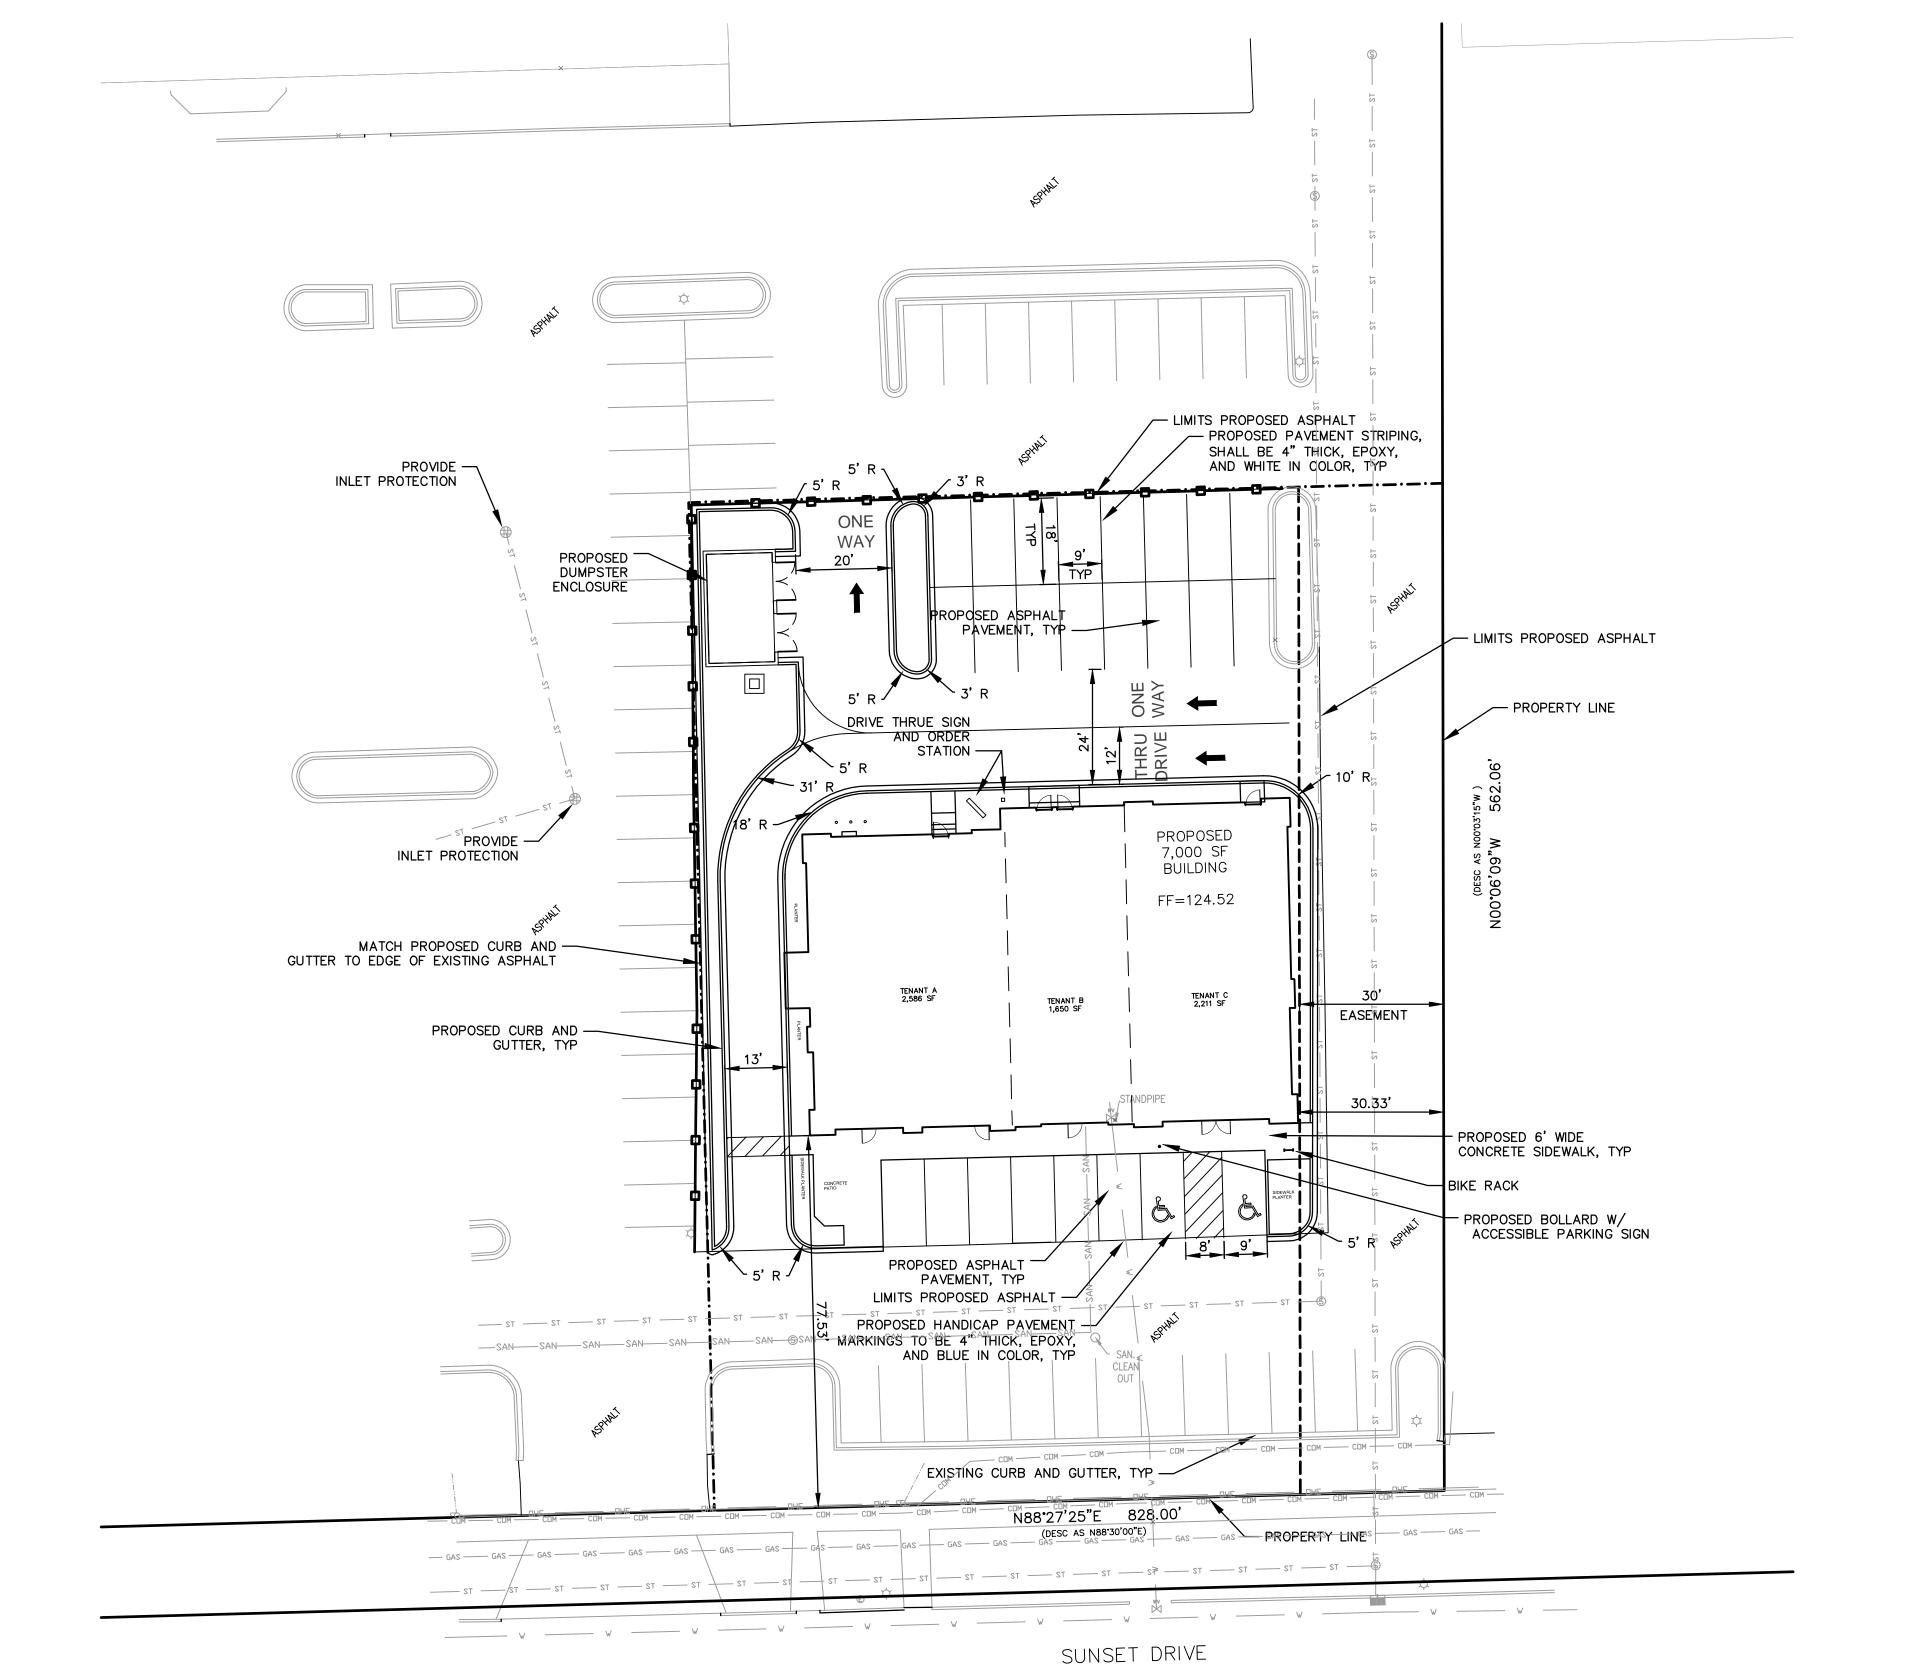

| DESCRIPTION | DATE | BY | DESIGNED BY | JBM | DATE | DAT

CONSTRUCTION SEQUENCE:

- 1.) INSTALL ALL EROSION CONTROL DEVICES.
- 2.) DEMOLITION AND REMOVAL OF ASPHALT AND CONCRETE.
- 3.) ABANDON EXISTING UTILITIES.
- 4.) ROUGH GRADING.
- 5.) INSTALLATION OF UNDERGROUND UTILITIES.
- 6.) CONSTRUCTION OF FOUNDATIONS AND BUILDING.
- 7.) FINAL GRADING OF SITE.
- 8.) CONSTRUCT CURB AND GUTTER.
- 9.) INSTALL ASPHALT PAVING AND STRIPING.
- 10.) INSTALL LANDSCAPING.
- 11.) REMOVAL OF EROSION CONTROL DEVICES UPON SITE STABILIZATION.

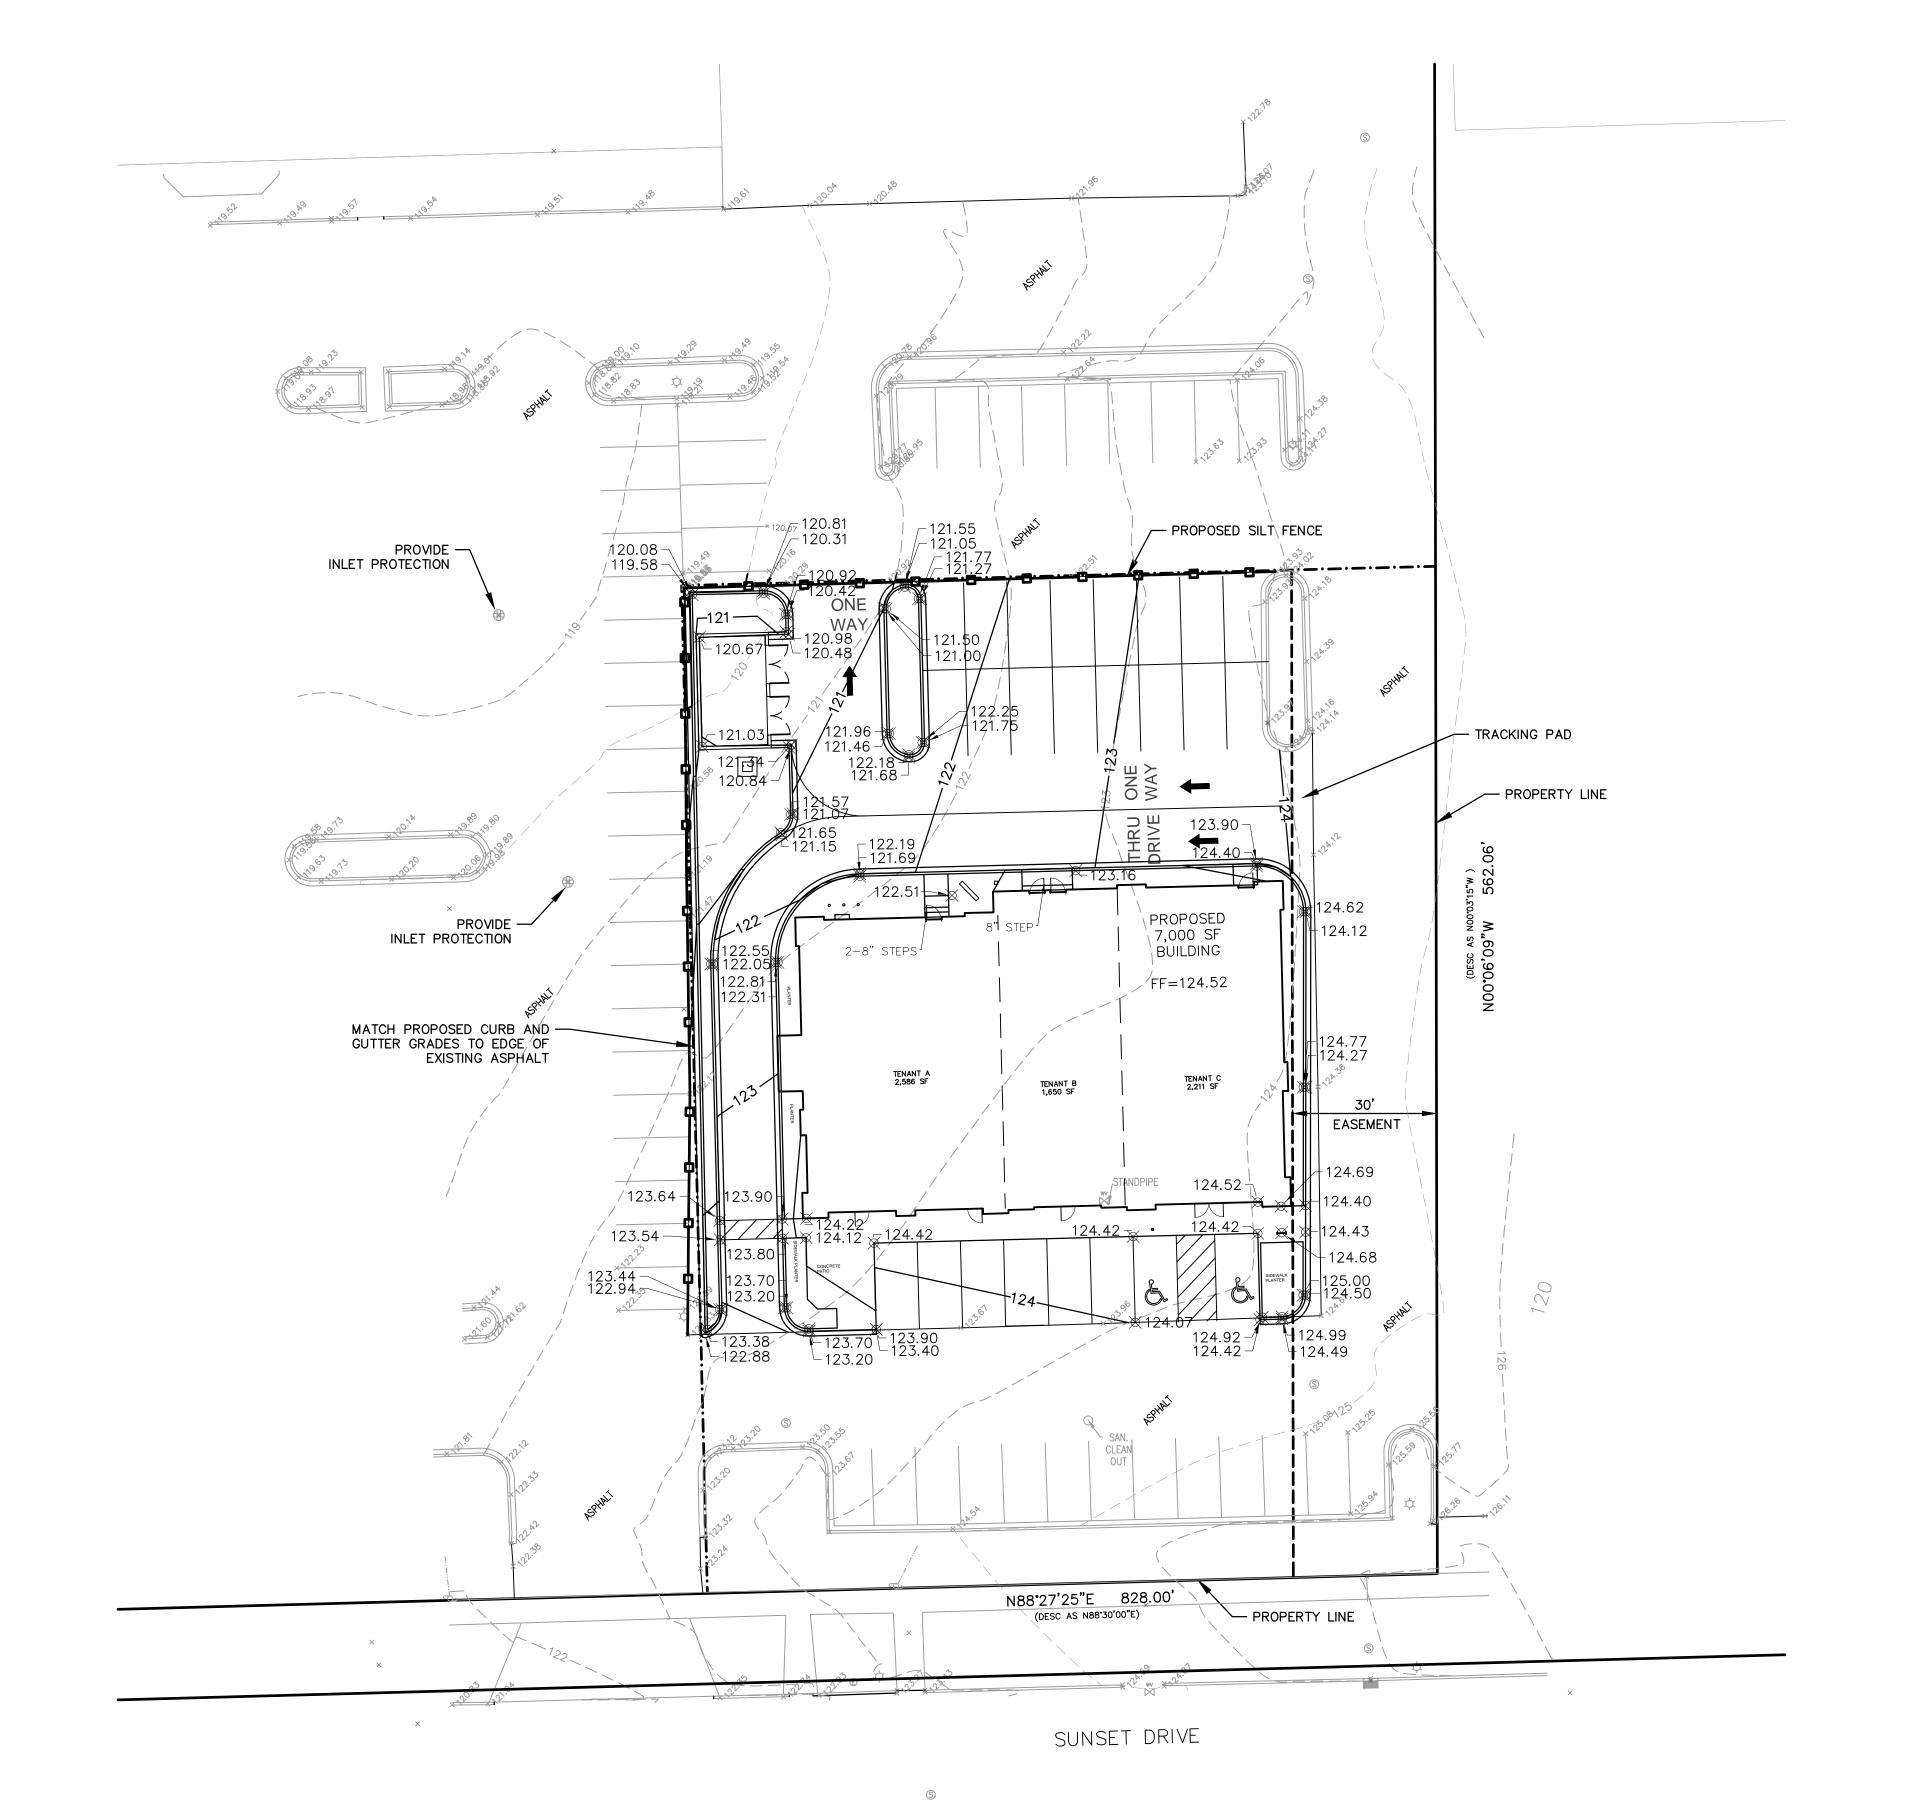

NOTES:

1.) ALL EROSION CONTROL DEVICES SHALL BE IN PLACE PRIOR TO ANY LAND DISTURBANCE ACTIVITIES. DEVICES SHALL BE INSTALLED AND MAINTAINED PER WISCONSIN DEPARTMENT OF NATURAL RESOURCES BEST MANAGEMENT PRACTICES (BMPs), TECHNICAL STANDARDS.

2.) ALL DIMENSIONS ARE TO FACE OF CURB OR EDGE OF PAVEMENT UNLESS OTHERWISE NOTED.

3.) CONTRACTOR SHALL COORDINATE ALL UTILITY WORK WITH APPROPRIATE PUBLIC UTILITY

4.) INLET PROTECTION. PROTECT INLETS TO STORM DRAINS, CULVERTS AND OTHER STORM WATER CONVEYANCE SYSTEMS FROM SILTATION UNTIL THE SITE IS STABLEIZED.


5.) SITE DEWATERING. TREAT PUMPED WATER TO REMOVE SEDIMENT PRIOR TO DISCHARGE FROM SITE, USING BMPs SUCH AS SEDIMENT BASINS AND PORTABLE SEDIMENT TANKS.


6.) SEDIMENT CLEANUP. BY THE END OF EACH WORKDAY, CLEAN UP ALL OFF—SITE SEDIMENT DEPOSITS OR TRACKED SOIL THAT ORIGINATED FROM THE PERMITED SITE. FLUSHING SHALL NOT BE ALLOWED UNLESS RUNOFF IS TREATED BEFOR DISCHARGE FROM SITE.

7.) FINAL SITE STABILIZATION. ALL PREVIOUS CROPLAND AREAS WHERE LAND DISTURBING ACTIVITIES WILL NOT BE OCCURRING UNDER THE PROPOSEDGRADING PLANS SHALL BE STABLEIZED UPON PERMIT ISSUANCE. STABLEIZE ALL OTHER DISTURBED AREAS WITHIN 7 DAYS OF FINAL GRADING AND TOPSOIL APPLICATION. LARGE SITES SHALL BE TREATED IN STAGES AS FINAL GRADING IS COMPLETED IN EACH STAGE. ANY SOIL EROSION THAT OCCURS AFTER FINAL GRADING OR THE APPLICATION OF STABILIZATION MEASURES MUST BE REPAIRED AND THE STABILIZATION WORK


8.) TEMPORARY SITE STABILIZATION. ANY DISTURBED SITE THAT REMAINS INACTIVE FOR GREATER THAN 7 DAYS SHALL BE STABILIZED WITH TEMPORARY STABILIZATION MEASURES SUCH AS SOIL TREATMENT, TEMPORARY SEEDING OR MULCHING. FOR PURPOSES OF THIS SUBSECTION, "INACTIVE" MMEANS THAT NO SITE GRADING, LANDSCAPING OR UTILITY WORK IS OCCURING ON THE SITE AND THAT PRECIPITATION EVENTS ARE NOT LIMITING THESE ACTIVITIES. FROZEN SOILS DO NOT EXCLUDE THE SITE FROM THIS REQUIREMENT.

<u>LEGEND</u>

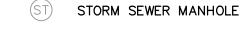

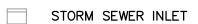



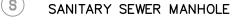

UGHT POLE

HYDRANT

WATER VALVE

---- 656--- PROPOSED CONTOUR


-656-EXISTING CONTOUR

EXISTING SPOT GRADE







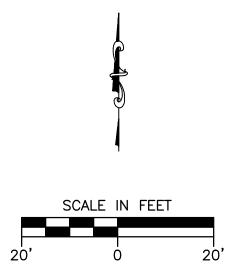

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GRADING AND EROSION CONTROL PLAN SUNSET CROSSING OUTLOT LOCKARD CONSTRUCTION WAUKESHA, WISCONSIN


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key project number 2604012
PROJECT SCALE 1" = 20'
SHEET NUMBER

C-2



NOTES:

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2.) CONTRACTOR SHALL VERIFY ALL ELEVATIONS IN FIELD PRIOR TO START OF CONSTRUCTION.

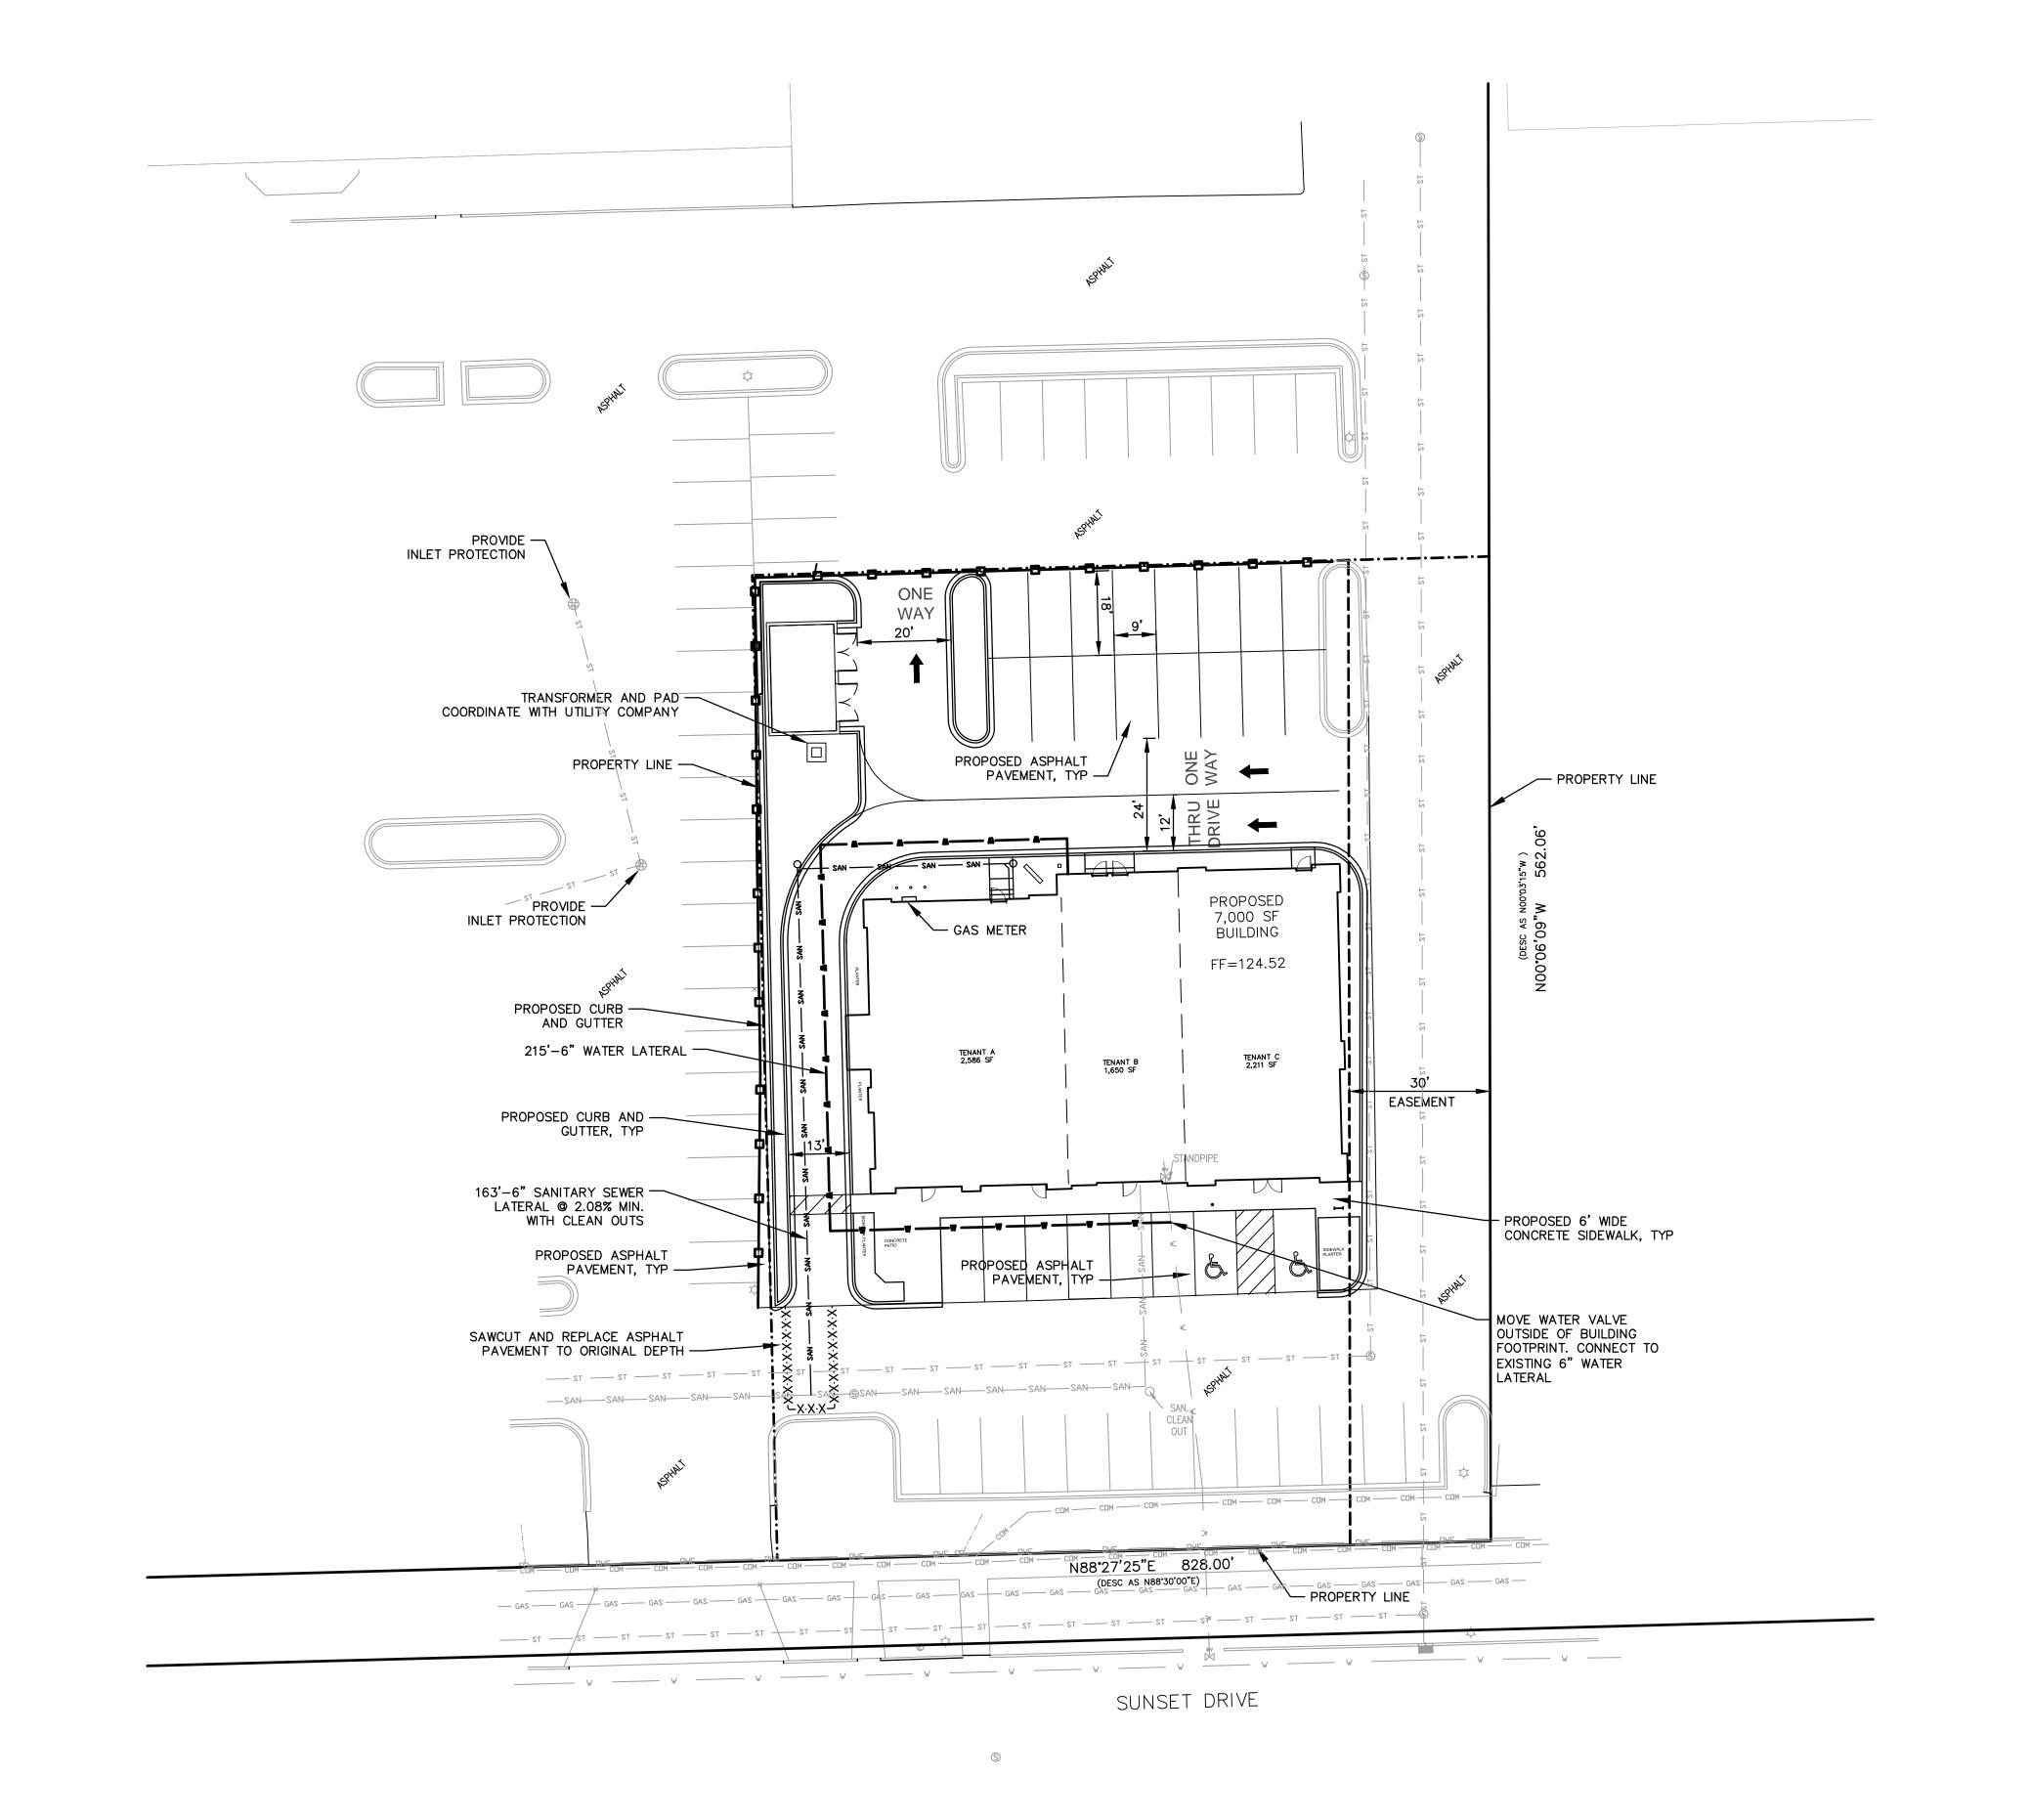3.) ALL WORK WITHIN PUBLIC RIGHT OF WAY SHALL BE COORDINATED WITH THE CITY OF WAUKESHA.

4.) CONTRACTOR SHALL COORDINATE ALL UTILITY WORK WITH APPROPRIATE PUBLIC UTILITY COMPANIES.

<u>LEGEND</u>

ST) STORM SEWER MANHOLE

STORM SEWER INLET

S SANITARY SEWER MANHOLE

LIGHT POLE

HYDRANT

WATER VALVE

---- 656 --- PROPOSED CONTOUR

--656-- EXISTING CONTOUR

EXISTING SPOT GRADE

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—— GAS —— GAS —— EXISTING GAS MAIN

PROPOSED 6" WATER LATERAL


---- OHE ---- EXISTING OVERHEAD ELECTRIC LINE

PROPOSED TRANSFORMER AND BASE



MILW. AREA 259-1181



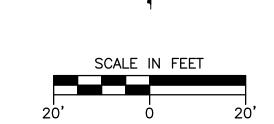

REVISION NO.	DESCRIPTION	DATE	BY	DESIGNED BY	DATE
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				DRAWN BY	DATE
				JBM	06/15/16
				APPROVED BY	DATE
				JBM	06/15/16
				CADFILE	
				XREF	

PAVING AND UTILITY PLAN SUNSET CROSSING OUTLOT LOCKARD CONSTRUCTION WAUKESHA, WISCONSIN

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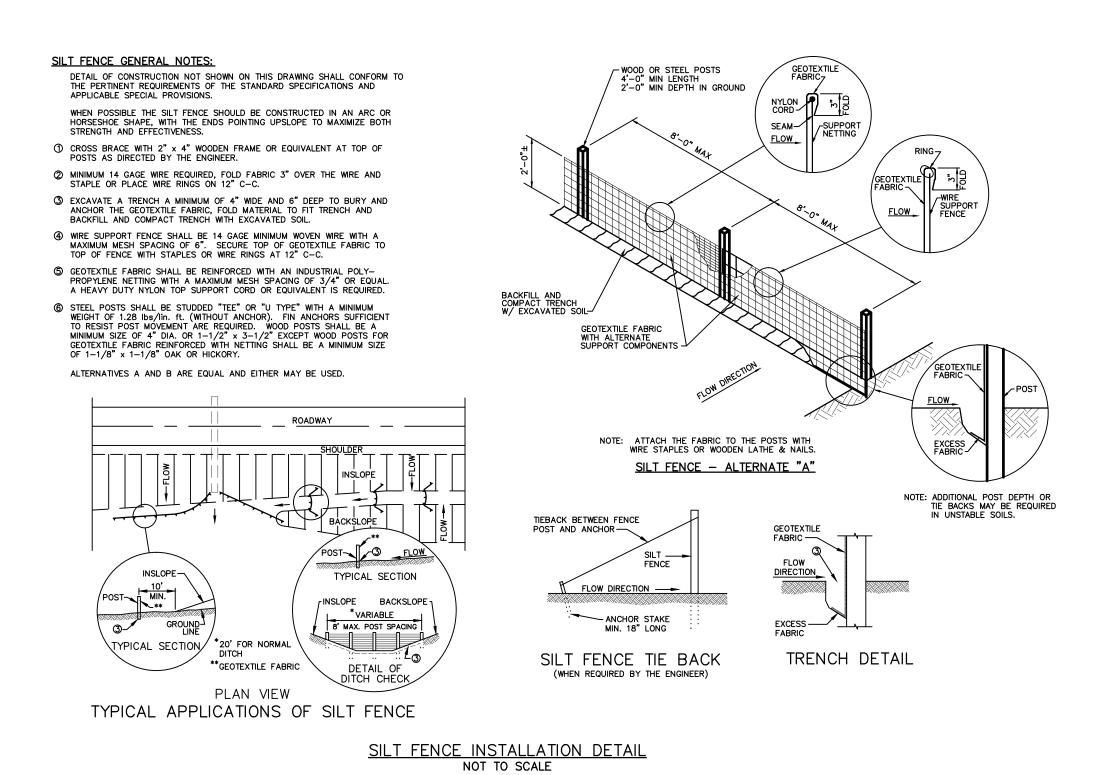
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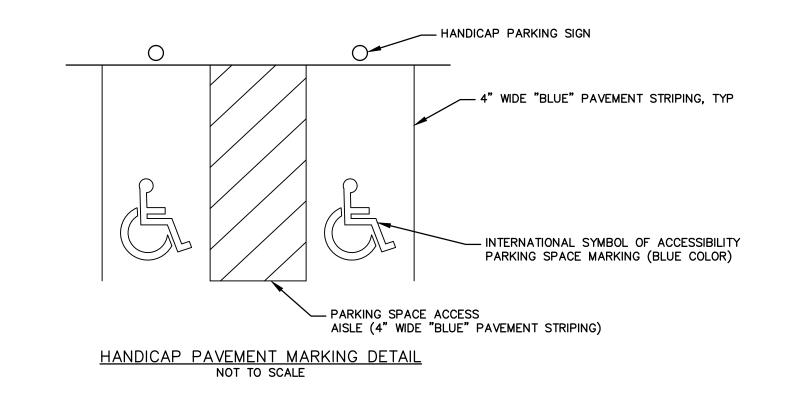
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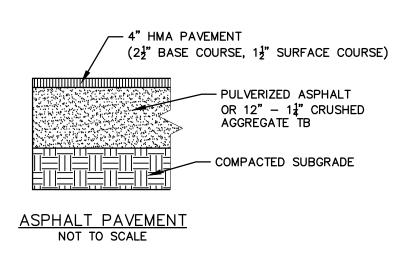
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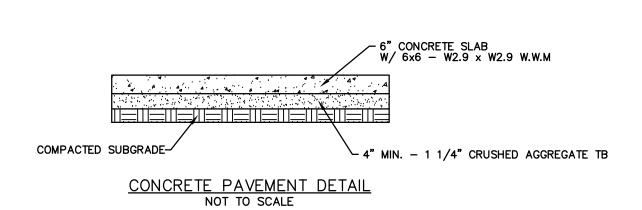
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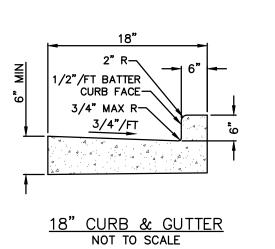
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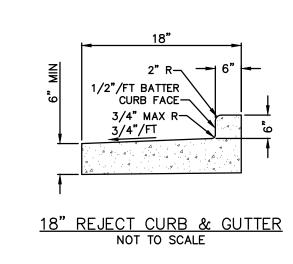















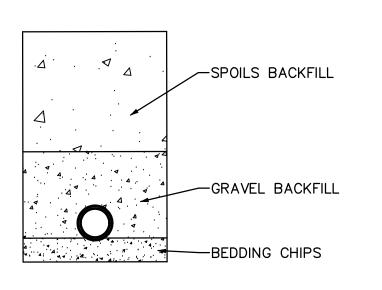

WATER LATERAL TRENCH DETAIL

NOT TO SCALE

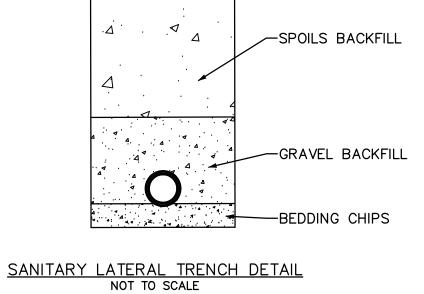

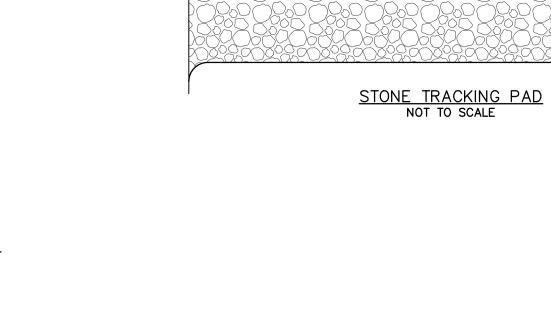

STRIP TOPSOIL AND SET— TO PLAN SUBGRADE



EXISTING PAVEMENT

└─ 3" CLEAR STONE

REVISION NO.	DESCRIPTION	DATE	BY	DESIGNED BY JBM	DATE 05/09/16	
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STANDARD DETAILS
SUNSET CROSSING OUTLOT
LOCKARD CONSTRUCTION
WAUKESHA, WISCONSIN


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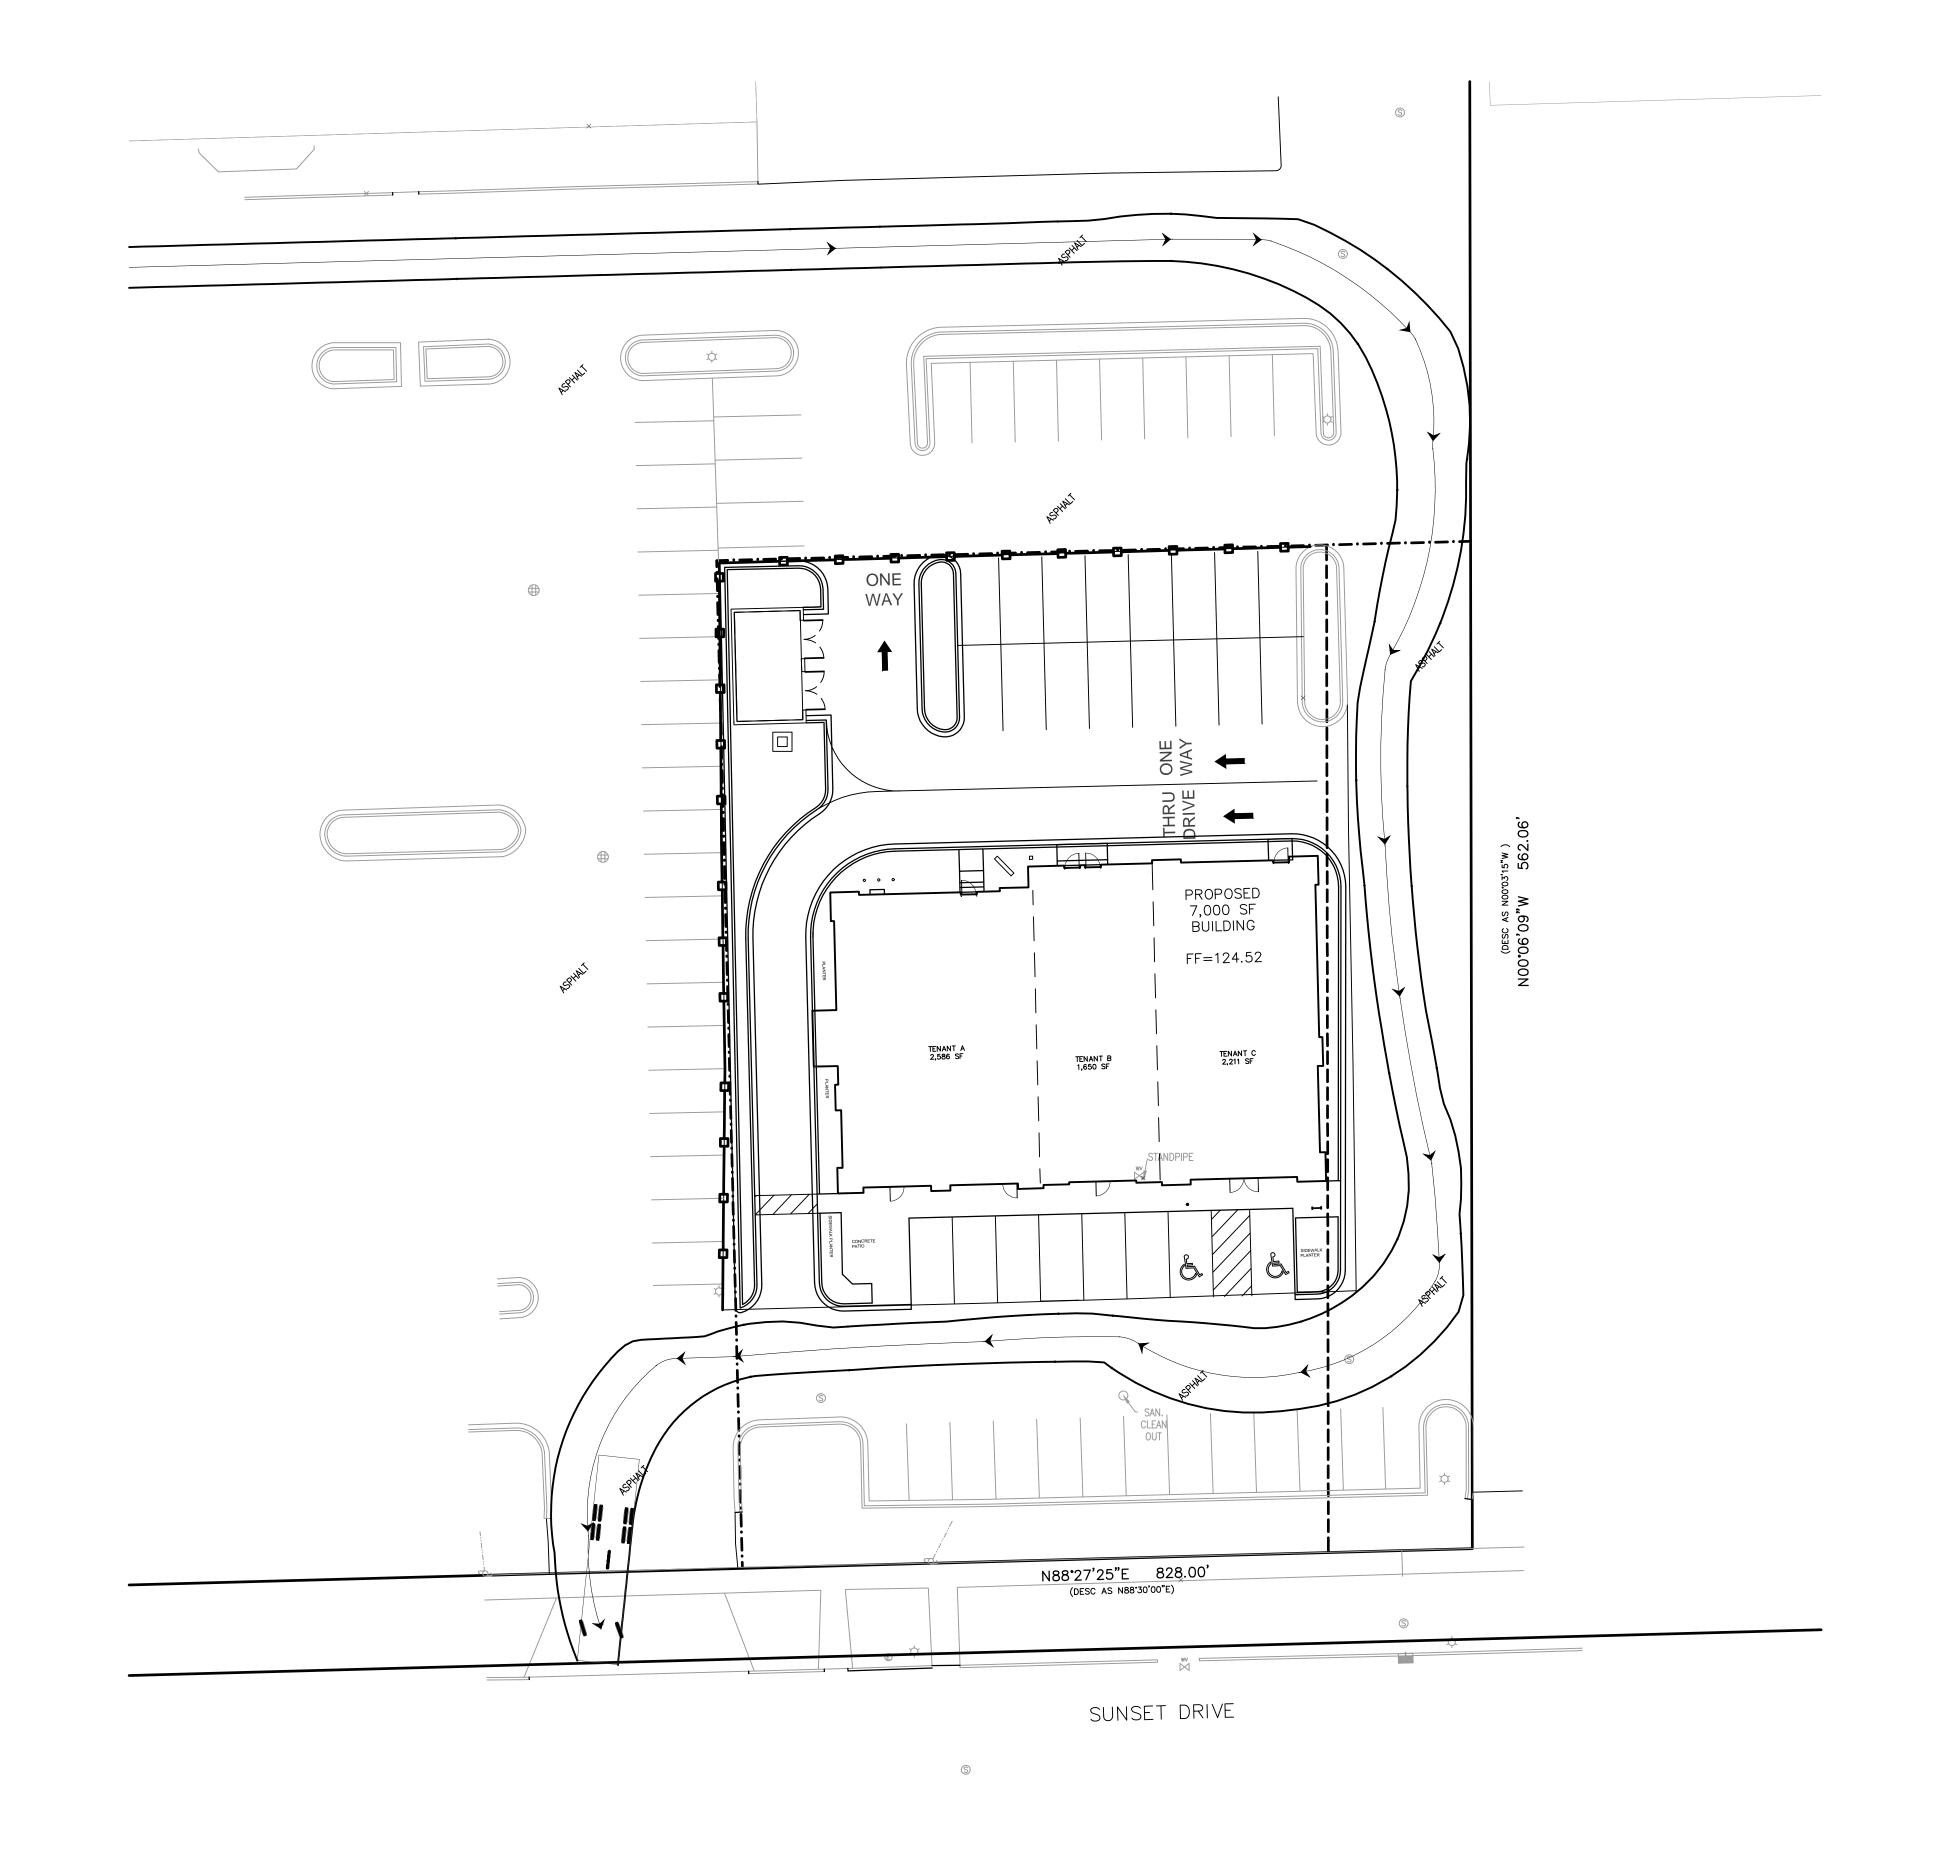
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STONE TRACKING PAD



key project number 2604012				
PROJECT SCALE NOT TO SCALE				
SHEET NUMBER				
C-4				





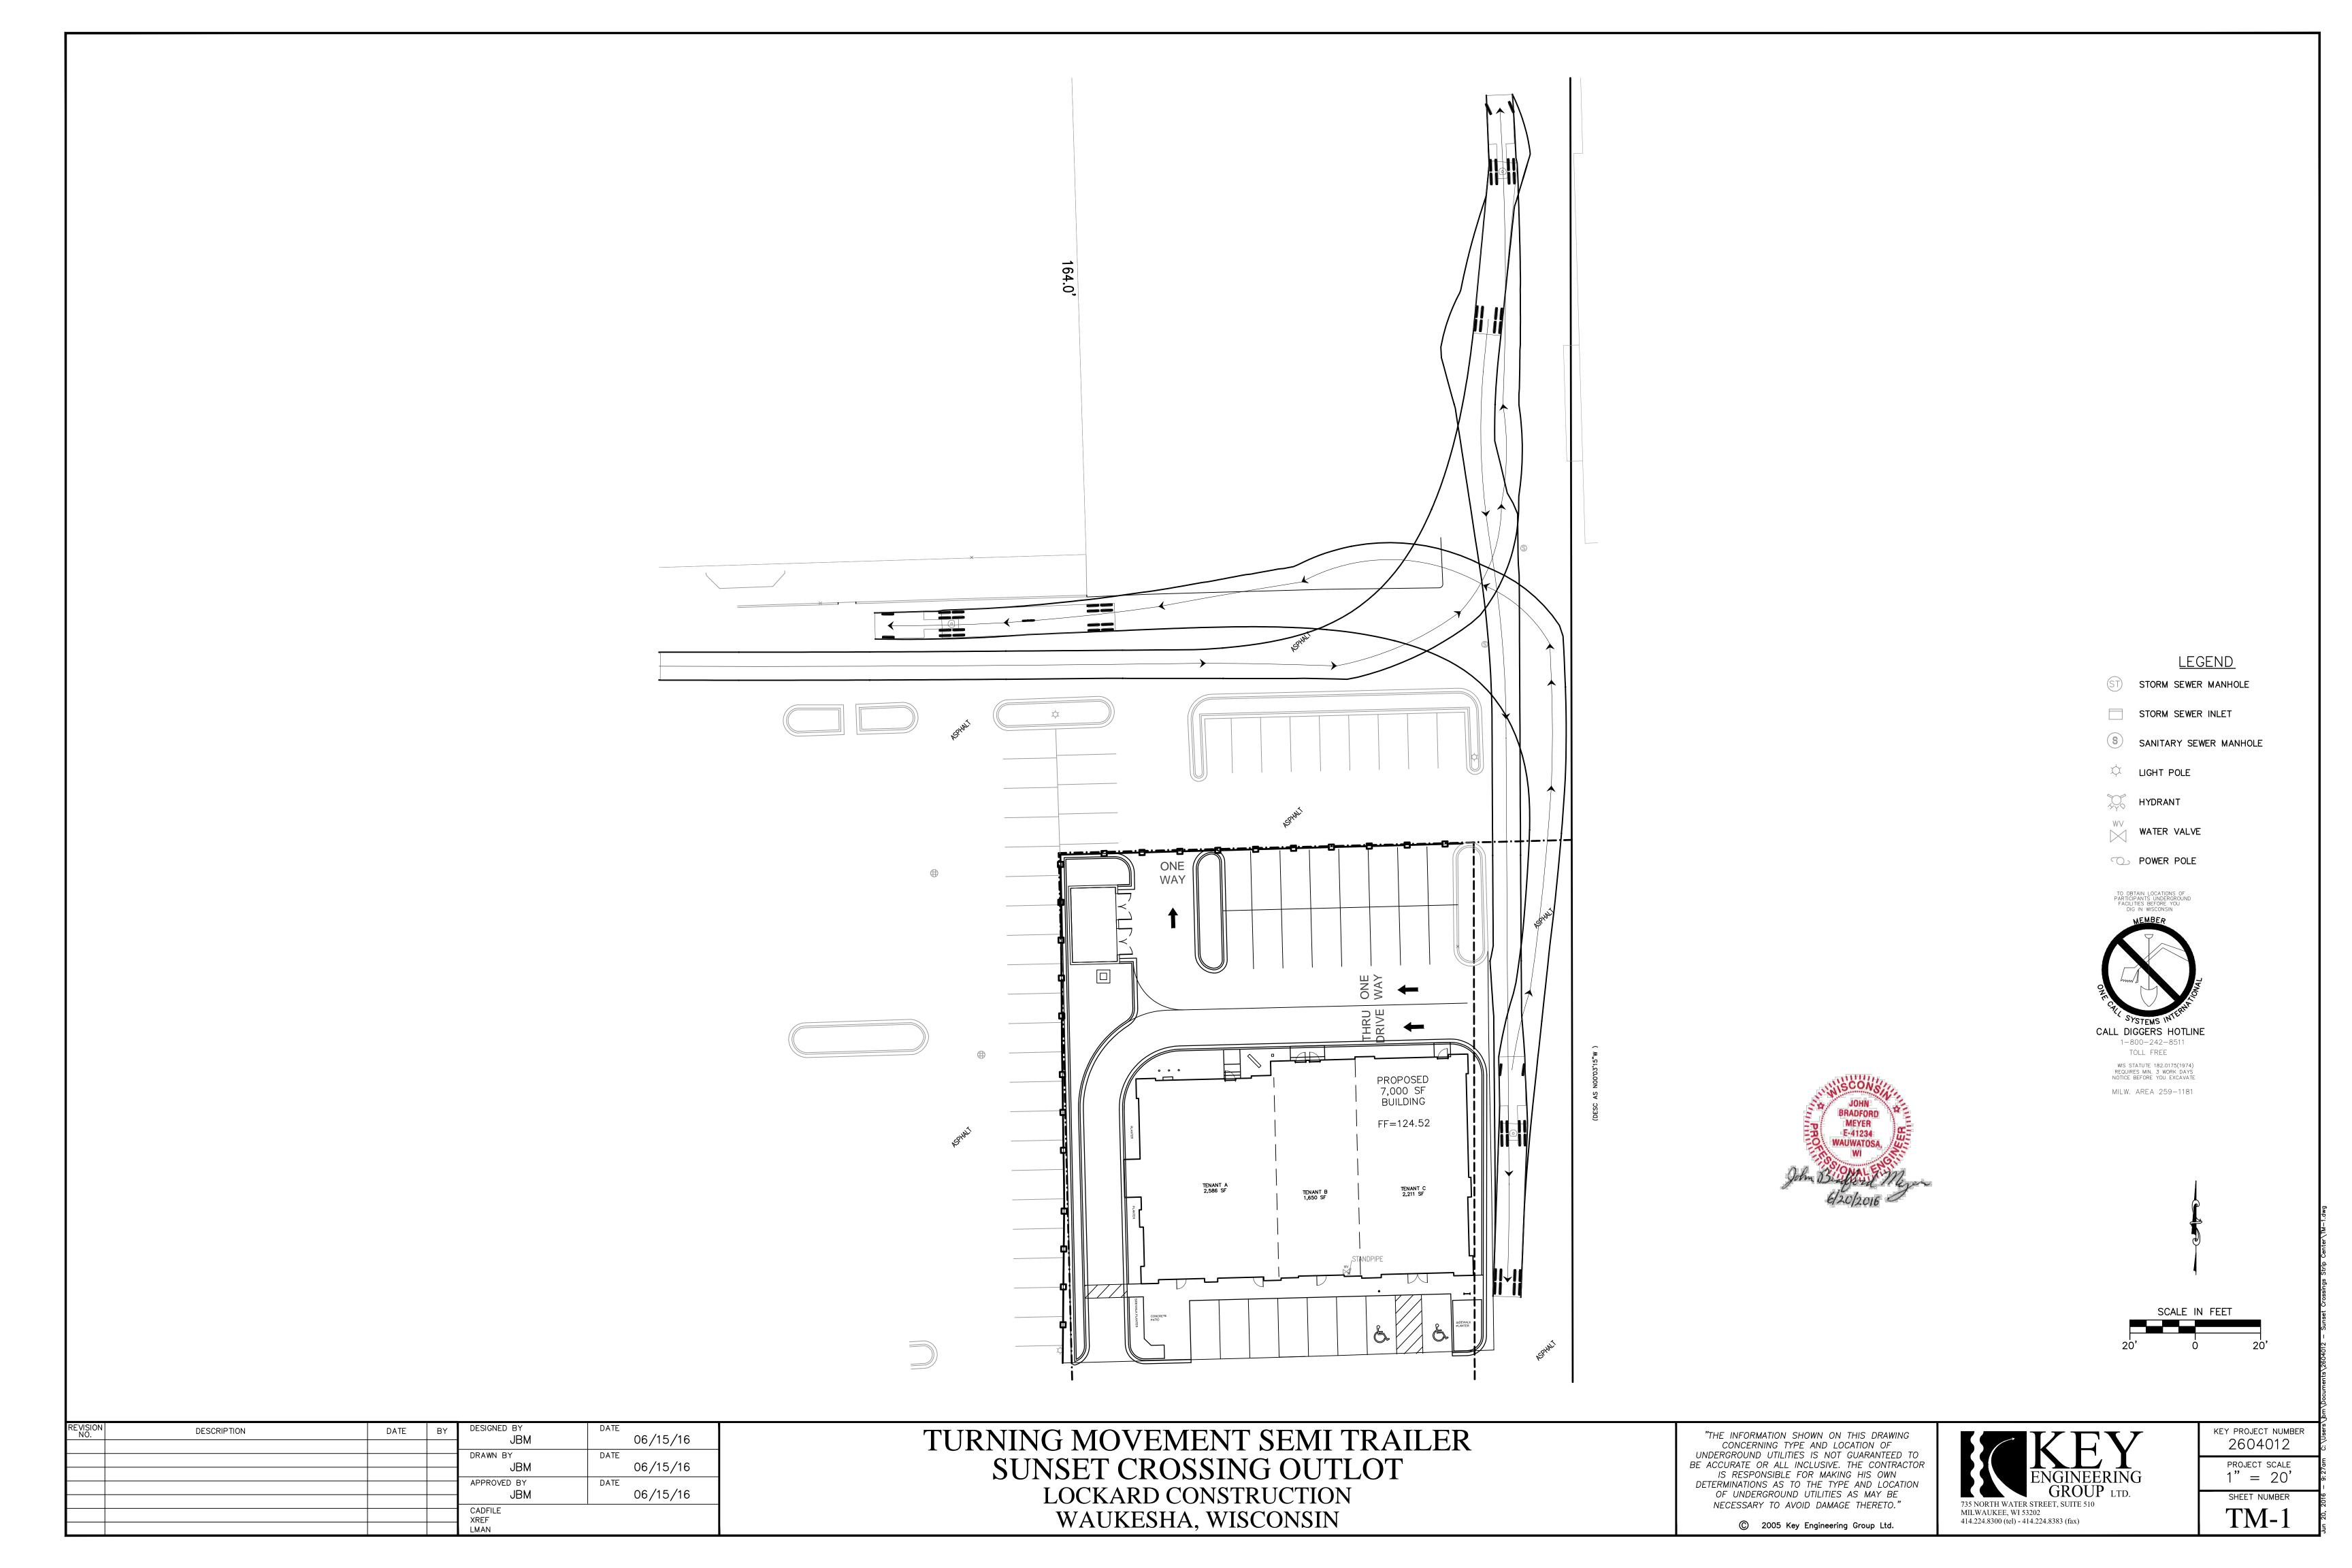

- ST STORM SEWER MANHOLE
- STORM SEWER INLET
- S SANITARY SEWER MANHOLE
- LIGHT POLE
- HYDRANT
- WATER VALVE
- O POWER POLE


TO OBTAIN LOCATIONS OF PARTICIPANTS UNDERGROUND FACILITIES BEFORE YOU



1-800-242-8511 TOLL FREE WIS STATUTE 182.0175(1974 REQUIRES MIN. 3 WORK DAYS NOTICE BEFORE YOU EXCAVAT

MILW. AREA 259-1181



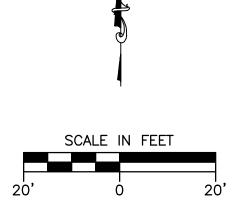

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REVISION NO.	DESCRIPTION	DATE	BY	DESIGNED BY JBM	DATE 06/15/16
				drawn by JBM	DATE 06/15/16
				APPROVED BY JBM	DATE 06/15/16
				CADFILE XREF LMAN	

TURNING MOVEMENT FIRE TRUCK SUNSET CROSSING OUTLOT LOCKARD CONSTRUCTION WAUKESHA, WISCONSIN

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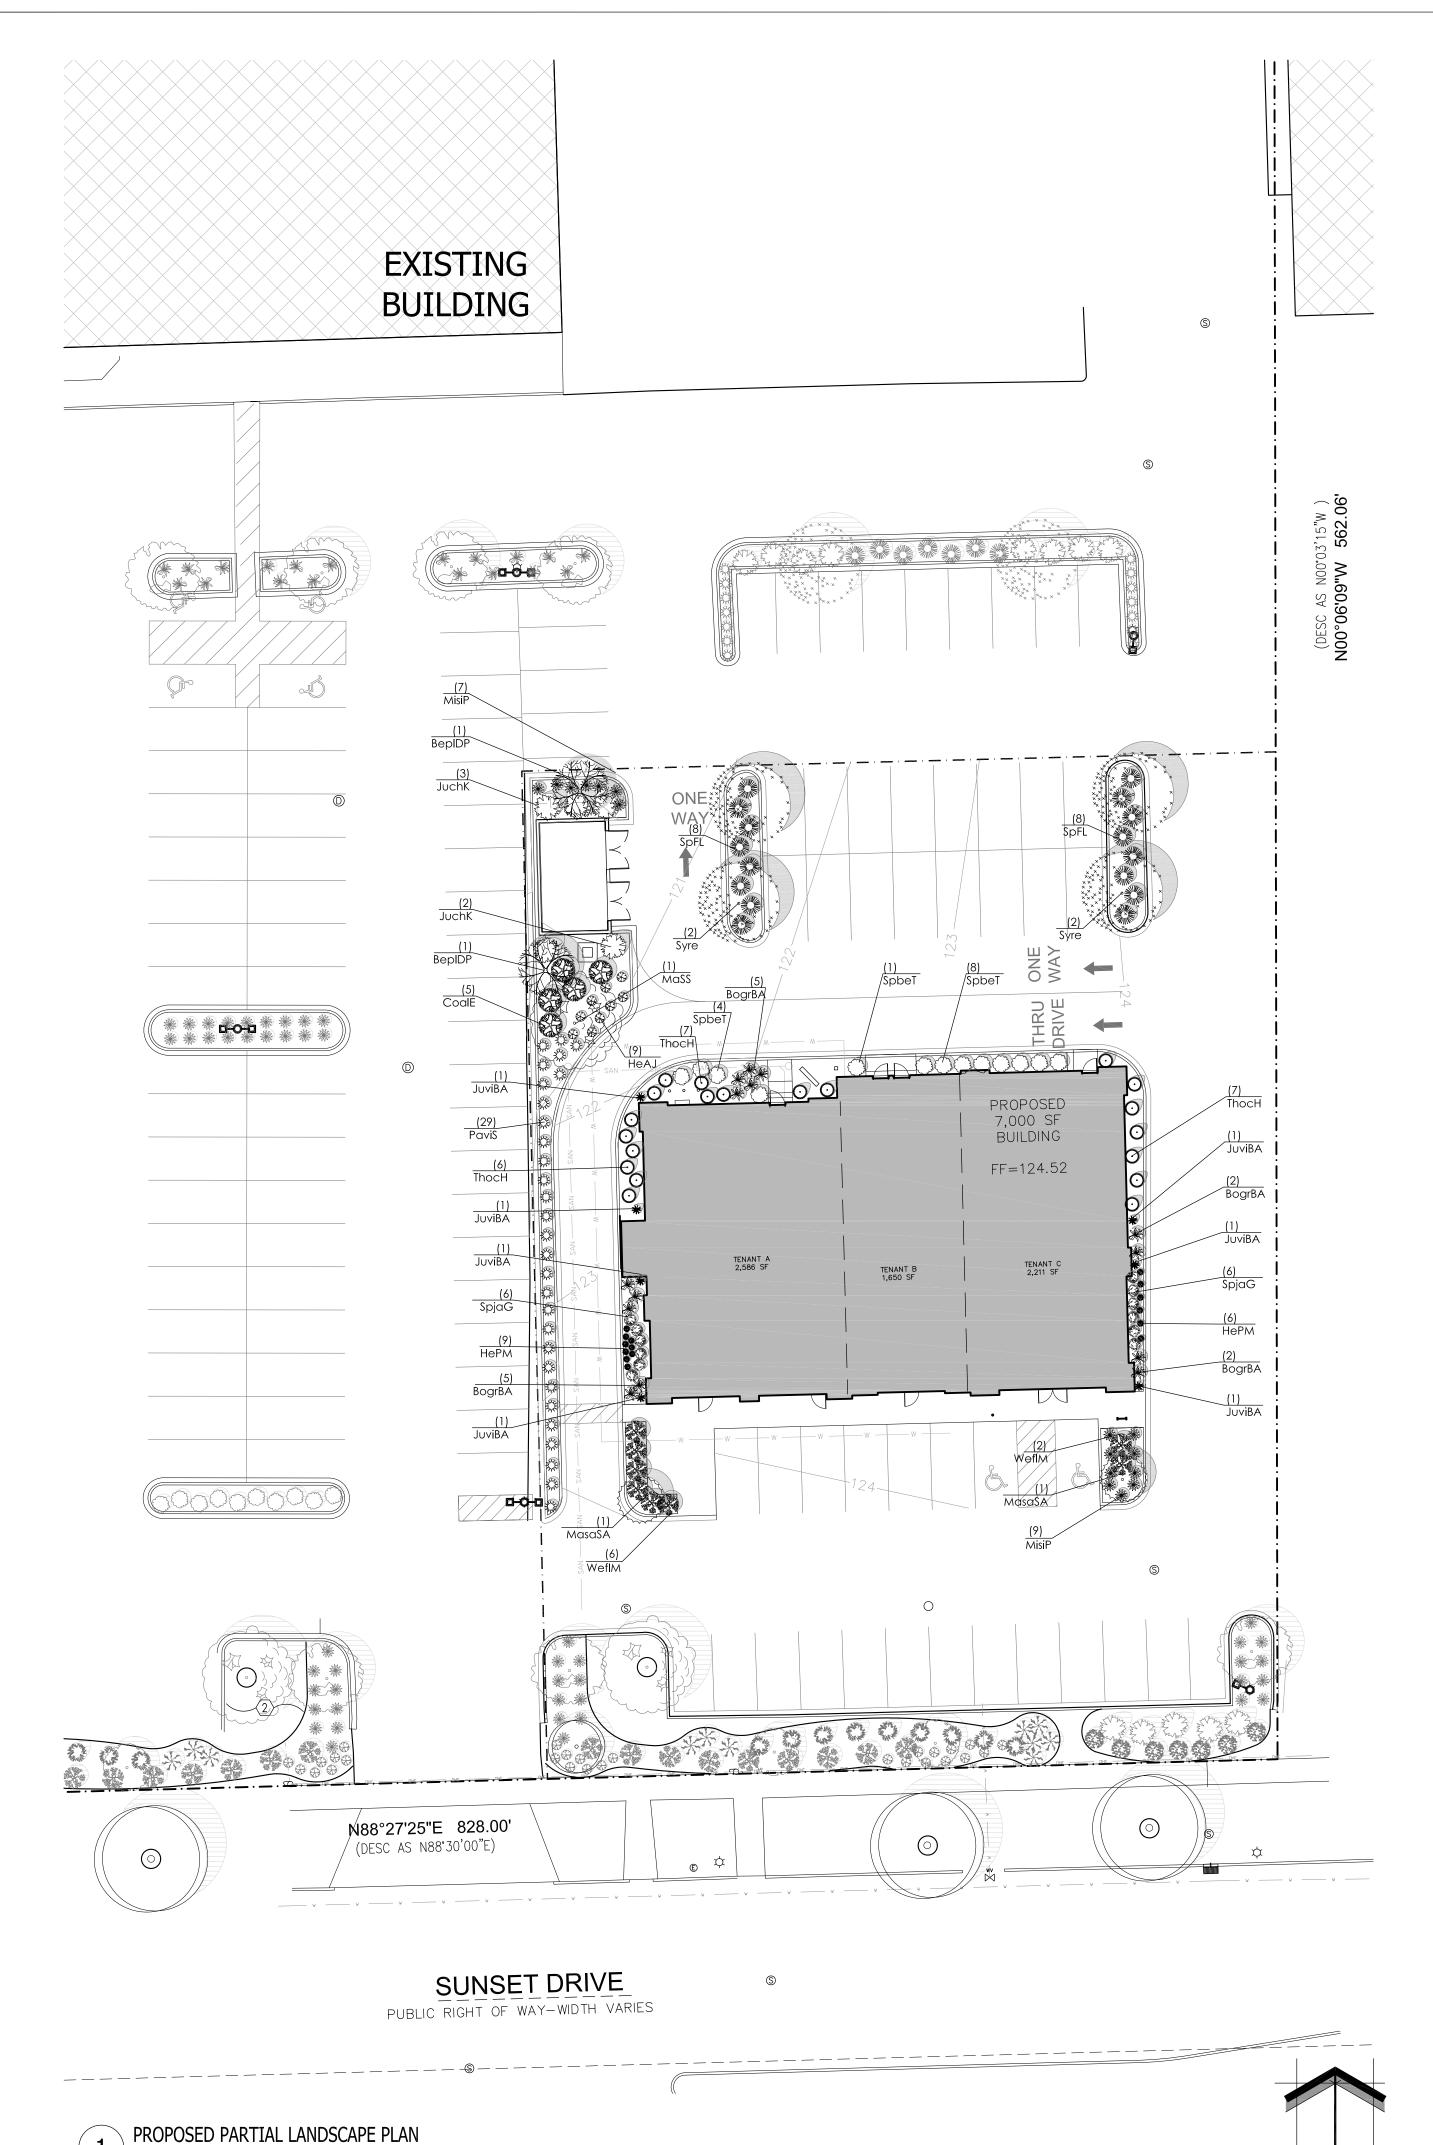
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 $\begin{array}{c} \textbf{2604012} \\ \textbf{PROJECT SCALE} \\ \textbf{1"} = \textbf{20'} \\ \textbf{SHEET NUMBER} \\ \textbf{TM-2} \end{array}$

KEY PROJECT NUMBER



<u>Proposed Plant Material Table - Out Lot</u>

Quantity	Code Name	Symbol	Scientific Name	Common Name	Planting Size
2	BepIDP	₩	Betula platyphylla 'Dakota Pinnacle'	Dakota Pinnacle Birch	2 1/2"-Cal - B&B
1	Mass		Malus 'Spring Snow'	Spring Snow Flowering Crab	2 1/2"-Cal - B&B
2	MasaSA	0	Malus sargentii 'Select A'	Firebird Crabapple	1 1/2" Cal - B&B
4	Syre	a	Syringa reticulata	Ivory Silk tree lilac	2 1/2"-Cal - B&B
Conifer Ever	green Tree				
Quantity	Code Name	Symbol	Scientific Name	Common Name	Planting Size
7	JuviBA	*	Juniperus virginiana 'Blue Arrow'	Blue Arrow Juniper	5' - 6' - B&B
sroadleaf De	eciduous Shrub				•
Quantity	Code Name	Symbol	Scientific Name	Common Name	Planting Size
5	CoalE	\$	Cornus alba 'Elegantissima'	Variegated red twig dogwood	18" - 24"- Cont
13	SpbeT		Spiraea betulifolia 'Tor'	Tor Birchleaf Spirea	18" - Cont
12	SpjaG	777	Spiraea japonica 'Galen'	Double Play Artist Spirea	18" - Cont
16	SpFL		Spiraea x 'Fire Light'	Fire Light Spirea	18" - Cont
8	WeflM	*	Weigela florida 'Minuet'	Minuet Weigela	18" - 24"- Cont
Conifer Ever	green Shrub	•			
Quantity	Code Name	Symbol	Scientific Name	Common Name	Planting Size
5	JuchK	2 4 1 1 1 1 1 1 1 1 1 1 1 1 1 1 1 1 1 1	Juniperus chinensis 'Kallay's Comapact'	Kallay's Compact Juniper	18" - 24" - B&B
20	ThocH	0	Thuja occidentalis 'Holmstrup'	Holmstrup Dwarf Arborvitae	3' - 4' - B&B
erennial Gr	ass				
Quantity	Code Name	Symbol	Scientific Name	Common Name	Planting Size
14	BogrBA	*	Bouteloua gracilis 'Blonde Ambition'	Blonde Ambition Blue Grama Grass	1-Gal - Cont
16	MisiP	*	Miscanthus sinensis 'Purpuracens'	Purple Silver Grass	1-Gal - Cont
			· · · · · · · · · · · · · · · · · · ·		I

Shenandoah Switch Grass

Alabama Jubilee Daylily

Pardon Me Dwarf Daylily

Common Name

1-Gal - Cont

Planting Size

4 1/2" - pot

4 1/2" - pot

Panicum virgatum 'Shenandoah'

Hemerocallis x 'Alabama Jubilee'

Hemerocallis x 'Pardon Me'

Code Name | Symbol | Scientific Name

PaviS

HePM

Perennial

SCALE: 1" = 20'-0"

Quantity

LANDSCAPE PLAN GENERAL NOTES

- * * PLANT MATERIAL SHOWN ON LANDSCAPE PLAN IS DEPICTED AT MATURE GROWTH. * * 1. AT LEAST SEVENTY-TWO HOURS PRIOR TO ANY EXCAVATION, CONTRACTOR SHALL VERIFY UTILITY LOCATIONS AS GIVEN BY THE ELECTRIC, GAS, TELEPHONE, WATER, SEWER, AND CABLE TELEVISION COMPANIES, UTILITIES OR ENTITIES. REVIEW WITH OWNER'S REPRESENTATIVE SITE MECHANICAL, SITE ELECTRICAL AND LIGHTING, SITE GRADING AND DRAINAGE, SITE IRRIGATION AND ALL OTHER DRAWINGS PERTAINING TO UNDERGROUND UTILITY LOCATIONS. RECORD SET OF INFORMATION THE SAME AS IN POSSESSION OF OWNER'S REPRESENTATIVE. ALSO REVIEW OWNER'S "MARK SETS" OF ALL OF THESE DRAWINGS IN POSSESSION OF THE CONTRACTOR OR OWNER. MARK ALL SUCH UTILITIES ON THE SITE PRIOR TO COMMENCING. COORDINATE WITH OWNER BEFORE AND DURING CONSTRUCTION. REPAIR ANY DAMAGE TO ANY SYSTEM THAT IS CAUSED BY LANDSCAPE CONTRACTOR AT NO COST TO OWNER.
- ALL PLANTINGS SPECIFIED FOR THE FOREST RIDGE PROJECT PLANTING TABLES (SHEET LSP1.2) SHALL COMPLY WITH STANDARDS AS DESCRIBED IN AMERICAN STANDARD OF NURSERY STOCK ANSI Z60.1 2014 AND ANSI STANDARDS FOR PLANTING 2012
- DEVIATIONS FROM THE APPROVED THE SUNSET REDEVELOPEMENT PROJECT PLANS SHALL BE NOTED ON THE RECORD DRAWING BY THE CONTRACTOR AND ONLY WITH PRIOR APPROVAL OF THE LANDSCAPE ARCHITECT AND OWNER'S REPRESENTATIVE. VERBAL AGREEMENTS OR REVISIONS WITHOUT A CHANGE ORDER WILL NOT BE RECOGNIZED BY LANDSCAPE ARCHITECT AND OWNER.
- ALL PLANTS MUST BE BID AND SELECTED PER THE SPECIES SPECIFIED ON THE PLANS. THE SIZES OF PLANT MATERIAL LISTED HEREIN IS A MINIMUM ACCEPTABLE SIZE. ADDITIONALLY, IF EXCESSIVE PRUNING REDUCES THE CROWN THE PLANT SHALL BE REPLACED.
- PROTECT PUBLIC FROM CONSTRUCTION WITH BARRIERS AND BARRICADES.
- ALL AREAS THAT WERE DISTURBED DURING CONSTRUCTION AND AREAS NOT COVERED WITH PAVEMENT, BUILDING, PLANTING BEDS, OR TREE PITS ARE TO BE TOPSOILED 3" DEEP (MIN.) AND SHALL BE SODDED/SEEDED WITH SPECIFIED LAWN GRASS. LANDSCAPE CONTRACTOR SHALL INCLUDE COST PER SQUARE YARD FOR ADDITIONAL SEED OPERATIONS AS MAY BE POSSIBLY REQUIRED TO REESTABLISH ADJACENT TURF GRASS AREAS WHICH MAY BECOME DAMAGED DURING THE CONSTRUCTION PROCESS OR TO REPAIR DAMAGE DONE BY OTHERS.
- CONTRACTOR IS RESPONSIBLE FOR FURNISHING ALL MATERIALS, TOOLS, EQUIPMENT, LABOR, AND PLANTS NECESSARY FOR PROPER PLANTING AND INSTALLATION OF ALL LANDSCAPE MATERIAL.
- QUANTITIES ON PLANT MATERIALS LIST ARE FOR CONVENIENCE OF BIDDING ONLY. CONTRACTOR IS RESPONSIBLE FOR ALL PLANTS SHOWN ON LANDSCAPE PLANS AND COVERAGE OF ALL AREAS DELINEATED. THE PLANS ARE TO SUPERSEDE THE PLANT LIST IN ALL CASES.
- CONTRACTOR IS RESPONSIBLE FOR ALL ESTIMATING AND BIDDING, ALL AREAS, QUANTITIES MATERIALS SHOULD BE FIELD VERIFIED WITH SITE CONDITIONS.
- WHERE DISCREPANCIES OCCUR BETWEEN THE LANDSCAPE PLANS AND/OR ARCHITECTURAL AND/OR THE CIVIL DRAWINGS (AND ANY OTHER SITE DRAWINGS) THE DISCREPANCIES MUST BE BROUGHT TO THE LANDSCAPE ARCHITECTS ATTENTION FOR COORDINATION AND RESOLUTION.
- 11. ALL DISEASED, NOXIOUS OR INAPPROPRIATE MATERIALS SHALL BE REMOVED FROM THE PROPOSED SITE PRIOR TO THE START OF CONSTRUCTION AND DURING THE MAINTENANCE PERIOD.
- 12. GENERAL CONTRACTOR SHALL LEAVE THE SITE FREE OF CONSTRUCTION DEBRIS.
- 1.3 ALL LAWN AND PLANTING AREAS SHALL SLOPE TO DRAIN A MINIMUM OF 2% UNLESS NOTED OTHERWISE AND REVIEWED WITH OWNER'S REPRESENTATIVE FOR FINAL APPROVAL.
- 14. FINISH GRADES FOR SHRUB AND GROUND COVER AREAS SHALL BE HELD 1" BELOW TOP OF ADJACENT PAVEMENTS AND CURBS, UNLESS NOTED OTHERWISE ON THE PLANS. REFER TO LSP1.2 FOR FURTHER INFORMATION.
- 15. ALL PERENNIAL, ANNUAL AND GROUND COVER AREAS TO RECEIVE A BLEND OF ORGANIC SOIL AMENDMENTS PRIOR TO PLANTING. TILL THE FOLLOWING MATERIALS INTO EXISTING TOPSOIL TO A DEPTH OF APPROXIMATELY 8". A DEPTH OF 12" IN TREE PITS. PROPORTIONS AND QUANTITIES MAY REQUIRE ADJUSTMENT DEPENDING ON THE CONDITION OF EXISTING SOIL. REFER TO LSP1.2 FOR FURTHER INFORMATION.

PER EVERY 100 SQUARE FEET ADD: ONE - 2 CUBIC FOOT BALE OF PEAT MOSS, 2 POUNDS OF 5 - 10 - 5 GARDEN FERTILIZER, 1/4

- CUBIC YARD OF COMPOSTED MANURE OR OTHER COMPOSTED, ORGANIC MATERIAL 16. ALL SHRUBS TO BE POCKET PLANTED WITH A 50/50 MIX OF COMPOSTED, ORGANIC MATERIAL AND EXISTING SOIL. INSTALL TOPSOIL INTO ALL BEDS AS NEEDED TO ACHIEVE PROPER GRADE. REMOVE ALL EXCESSIVE GRAVEL, CLAY AND STONES. REFER TO LSP1.2 FOR FURTHER INFORMATION.
- 17. PLANT ALL TREES SLIGHTLY HIGHER THAN FINISHED GRADE AT ROOT FLARE. BACK FILL HOLE WITH 2/3 EXISTING TOPSOIL AND ORGANIC SOIL AMENDMENTS SPECIFIED IN NOTE 15. AVOID ANY AIR POCKETS. DISCARD ANY GRAVEL CLAY OR STONES. REFER TO LSP1.2 FOR FURTHER INFORMATION.
- 18. ALL TREES TO BE INSTALLED, STAKED AND GUYED ACCORDING TO DETAILS. REFER TO ANSI STANDARDS
- FOR PLANTING 2012 AND DETAILS ON LSP1.2 FOR FURTHER INFORMATION. 19. PROVIDE A 4'-0" - 5'-0" DIAMETER MULCH RING ALL LAWN TREES.

TO DAMAGE OR COVER PLANTS. REFER TO LSP1.2 FOR FURTHER INFORMATION.

- 20. ALL PLANTINGS TO BE WATERED AT THE TIME OF PLANTING, THROUGHOUT CONSTRUCTION AND UPON
- COMPLETION OF PROJECT AS REQUIRED. WHERE SPECIFIED, ALL PLANT BEDS, PITS AND TREE RINGS ARE TO RECEIVE A MINIMUM OF 2'-3" DRESSING OF SHREDDED HARDWOOD OAK BARK MULCH SHAVINGS FREE OF GROWTH, WEEDS, FOREIGN MATTER DETRIMENTAL TO PLANT LIFE OR GERMINATION INHIBITING INGREDIENTS. LANDSCAPE CONTRACTOR TO PROVIDE A SAMPLE TO OWNER FOR APPROVAL. CONTRACTOR TO TAKE CARE WITH INSTALLATION NOT
- 22. LAWN INSTALLATION: CONTRACTOR TO FURNISH AND PREPARE TOPSOIL (3" MIN) AND SEED BED (REMOVE ALL STONES 1" OR LARGER), APPLY STARTER FERTILIZER AND SEED UNIFORMLY. PROVIDE A MULCH COVERING SUITABLE TO GERMINATE AND ESTABLISH TURF. EROSION CONTROL MESH SHOULD BE USED IN SWALES AND STEEP GRADES WHERE APPLICABLE. METHODS OF INSTALLATION MAY VARY AT THE DISCRETION OF CONTRACTOR. IT IS HIS/HER RESPONSIBILITY TO ESTABLISH AND GUARANTEE A SMOOTH, UNIFORM, QUALITY TURF. IF STRAW MULCH IS USED AS A COVERING, A TACKIFIER MAY BE NECESSARY TO AVOID WIND DAMAGE.

23. REQUIRED SEED MIXES: PREMIUM 60 GRASS SEED MIX REINDER'S (262) 786-3300

20% AMERICAN KENTUCKY BLUE GRASS 20% ALPINE KENTUCKY BLUE GRASS 20% LANGARA KENTUCKY BLUE GRASS

20% VICTORY CHEWINGS FESCUE

10% FIESTA III PERENNIAL RYE GRASS

10% CUTTER PERENNIAL RYE GRASS APPLY AT A RATE OF 175 POUNDS PER ACRE.

REFER TO SUPPLIERS SPECIFICATIONS AND INSTALLATION CUT SHEETS FOR FURTHER INFORMATION

24. DURING THE INITIAL "30 DAY MAINTENANCE PERIOD" THE LANDSCAPE CONTRACTOR IS REQUIRED TO PROVIDE AND ON-GOING PLEASANT VISUAL ENVIRONMENT WHEREAS ANY PLANT WHICH IS NOT RESPONDING TO TRANSPLANTING OR THRIVING SHALL IMMEDIATELY BE REPLACED. NEW LAWNS SHALL WATERED AND REPAIRED AND WEEDS MUST CONSTANTLY BE REMOVED, NO EXCEPTIONS WILL BE

- 25. MAINTENANCE. THE OWNER SHALL TEND AND MAINTAIN ALL PLANT MATERIALS IN A HEALTHY GROWING CONDITION AS PER THE APPROVED PLAN. PLANTINGS SHALL BE REPLACED WHEN NECESSARY AND KEPT FREE FROM REFUSE & DEBRIS. ALL PLANTING MATERIAL WHICH IS DYING OR DAMAGED BEYOND RECOVERY SHALL BE REPLACED WITHIN SIX (6) MONTHS OR BY THE NEXT PLANTING SEASON, WHICHEVER COMES FIRST.
- 26. LANDSCAPE / SITE DEMOLITION CONTRACTOR TO VERIFY LOCATIONS OF EXISTING TREES AND SHRUBS BE SALVAGED AND CLEARLY TAG THEM WITH MARKING TAPE AND CONSTRUCTION FENCE.

TO OBTAIN LOCATION OF

PARTICIPANT'S UNDERGROUND

FACILITIES BEFORE YOU DIG IN

WISCONSIN STATUTE 182.0175 (1974) REQUIRES A MINIMUM OF 3 DAYS NOTICE BEFORE YOU EXCAVATE (NOT INCLUDING SATURDAY, SUNDAY OR LEGAL HOLIDAYS)

UNDERGROUND SEWER AND UTILITY INFORMATION AS SHOWN IS OBTAINED FROM THE RECORDS OF MUNICIPALITY AND LOCAL UTILITY COMPANIES. THE ACCURACY OF WHICH CAN NOT BE GUARANTEED OR WISCONIN CALL THE MILWAUKEE

UTILITY ALERT NETWORK THE LOCATIONS OF EXISTING UTILITY INSTALLATIONS AS (800)-242-8511, (262) 432-7910 SHOWN ON THIS SURVEY ARE APPROXIMATE. THERE (877) 500-9592 MAY BE OTHER UNDERGROUND UTILITY INSTALLATIONS www.Diggershotline.com WITHIN THE PROJECT AREA THAT ARE NOT SHOWN.



LANDSCAPE

Landscape Architecture and Master Planning Design Consulting

11525 W. North Avenue Suite 1B Wauwatosa, WI 53226 Tel (414) 476-1204 www.insitelandscape.com mdavis@insitelandscape.com

SUNSET REDEVELOPMENT

120 E. Sunset Drive Waukesha, WI

Issuance and Revisions:

| Number | Description

05/11/16

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OF THE DRAWINGS OR DATA WITHOUT THE

PRIOR WRITTEN CONSENT OF THE LANDSCAPE

ARCHITECT.

Sheet Title:

PROPOSED PARTIAL LANDSCAPE PLAN, GENERAL NOTES, AND PLANT MATERIAL TABLE

Date of Drawing:	06/17/
Scale:	1" = 20'
Drawn By:	МС
Job Number:	L16-0

Sheet Number:



<u>Project:</u>

ORANGE SNOW FENCING ZIP

TIED AT 12" O.C. VERTICALLY TO EVERY STEEL POST TO

PROTECTION. MUST BE FULLY

DISTURBING ACTIVITY ON SITE.

(THIS INCLUDES THE REMOVAL

SCALE: NONE

SCALE: NONE

INSTALLED PRIOR TO ANY

PROVIDE PERIMETER

AND ALL GROUND

OF OTHER TREES.)

SUNSET REDEVELOPMENT

120 E. Sunset Drive Waukesha, WI

Issuance and Revisions:

| Number | Description

05/11/16 Plan Commission Submittal

06/17/16

Revisions Based on Site Changes

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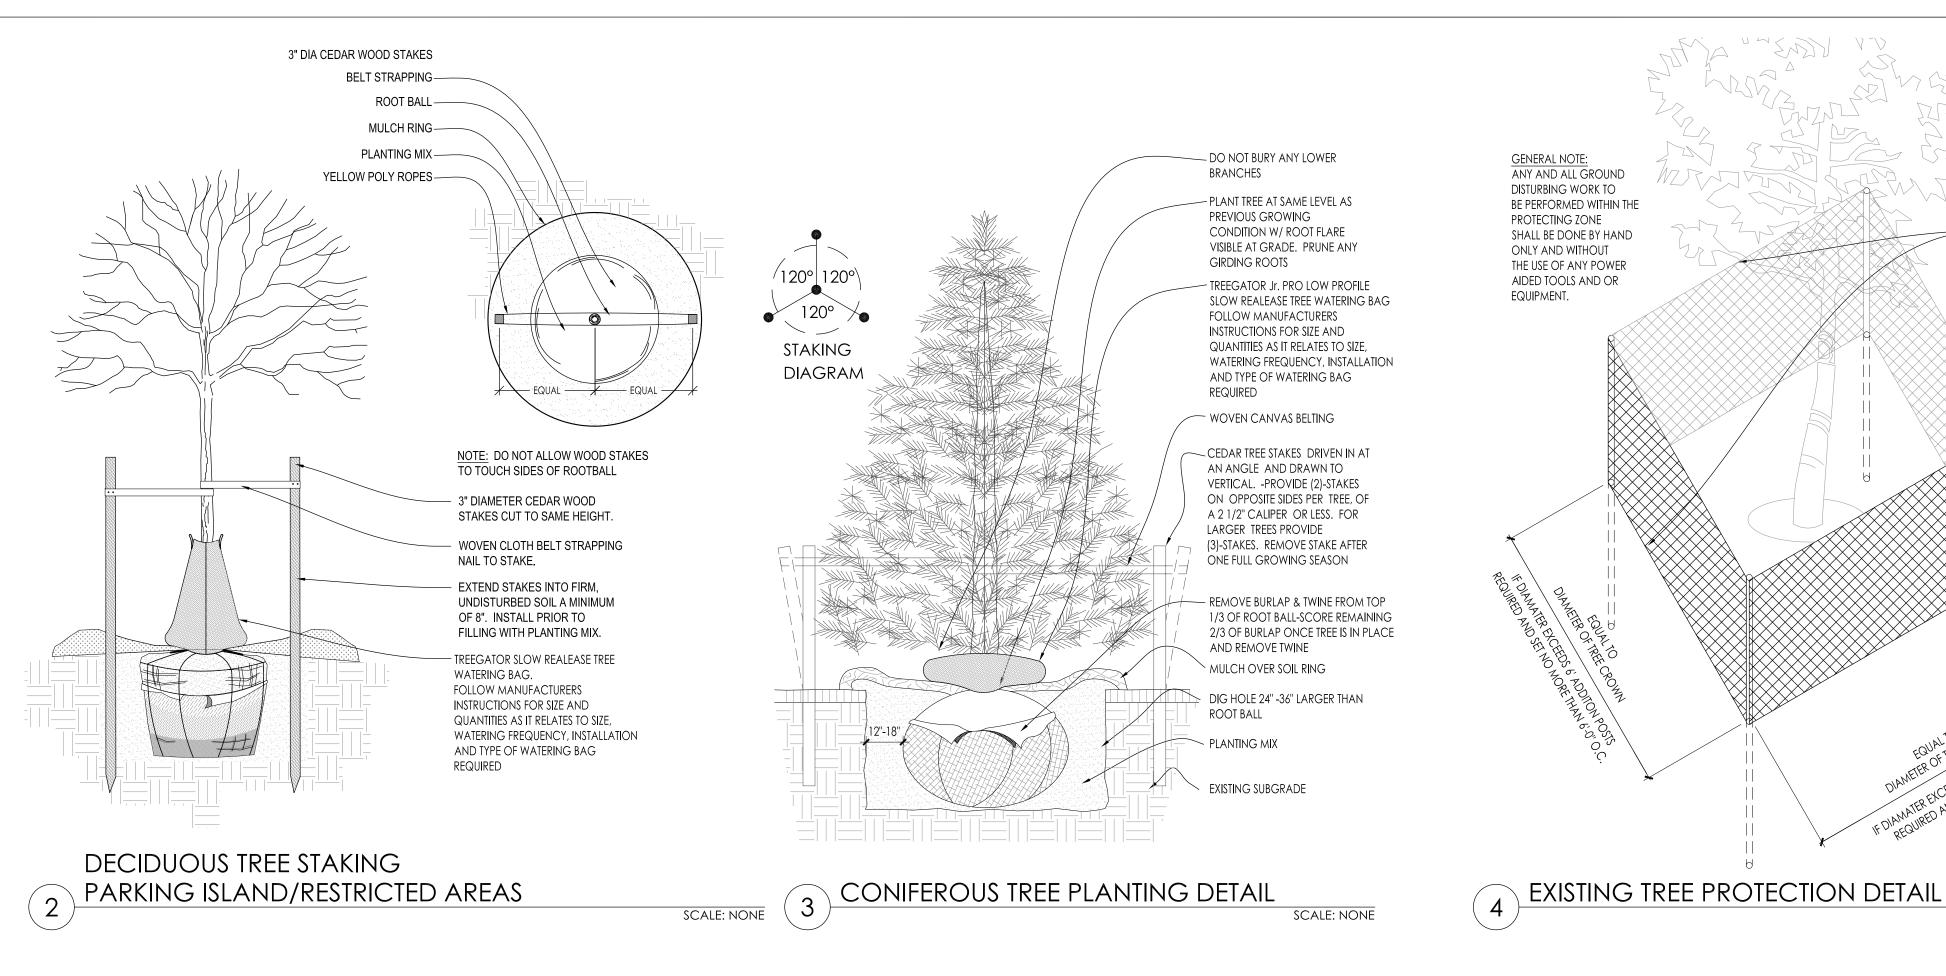
DAMAGES, LIABILITY, OR COST, INCLUDING

Sheet Title:

PROPOSED LANDSCAPE PLAN, PLANTING DETAILS

Date of Drawing:	06/17/16
Scale:	As Noted
Drawn By:	MCD
Job Number:	L16-024

Sheet Number:



- DIG HOLE 9" - 12" LARGER THAN DIA. OF ROOT MASS THIN OUT DEAD AND BROKEN BRANCHES, -RETAIN NORMAL PLANT SHAPE PLANT AT SAME DEPTH AS PREVIOUS GROWING > PLANT MIX - MULCH LAYER 9" - 12" PAPER FIBER POT CONTAINER GROWN REMOVE ENTIRE POT IF IT IS POSSIBLE. IF ROOTS HAVE PENETRATED POT, CAREFULLY REMOVE FROM PLASTIC POT AND SCORE ROOTS 1" REMOVE RIM AND SCORE SIDES WITH KNIFE *REFER TO CONIFER BALLED DEEP WITH A SHARP KNIFE AND BURLAPPED INSTALLATION

PRUNE OUT ANY BROWN BRANCHES - DO NOT BURY ANY BOTTOM BRANCHES - PLANT AT SAME DEPTH AS PREVIOUS - PLANTING MIX - FINISHED GRADE-MULCH 9" - 12" CONTAINER GROWN

CAREFULLY REMOVE FROM PLASTIC POT AND SCORE BALLED & BURLAPPED REMOVE BURLAP AND TWINE FROM TOP 1/3 OF ROOT BALL AND SCORE REMAINING 2/3 ROOTS 1" DEEP WITH A SHARP KNIFE

- DIG HOLE 9" - 12" LARGER THAN DIA.

OF ROOT BALL

BEDLINES ARE TO BE CUT CRISP AS PER PLAN. A CLEAN DEFINITION BETWEEN TURF AND PLANTING BED IS REQUIRED. TOPSOIL / PLANTING MIX TOP OF MULCH SHOULD BE CRESTED 1-2" ABOVE TURF FOR POSITIBE DRAINGE. SLOPE GRADUALLY. 3" (+/-) MULCH BED -

DECIDUOUS SHRUB PLANTING DETAIL

9 SPADE EDGE PLANT BED EDGE DETAIL

REFER TO SPECIFICATIONS FOR EDGING TYPE (TYP) -TURF GRASS 12" MINIMUM OF PLANTING SOIL MIX -UNDISTURBED EARTH

VARIES W/ BEDS

SCALE: NONE

DECIDUOUS TREE PLANTING DETAIL

PRUNE TREE AS NEEDED-

METHODS VARY DEPENDING

- TREEGATOR SLOW REALEASE TREE

FOLLOW MANUFACTURERS

INSTRUCTIONS FOR SIZE AND

AND TYPE OF WATERING BAG

PLANT TREE AT SAME LEVEL AS

CONDITION W/ ROOT FLARE

REMOVE BURLAP & TWINE FROM TOP 1/3 OF ROOT

BALL-SCORE REMAINING 2/3

OF BURLAP ONCE TREE IS IN

PLACE AND REMOVE TWINE

- CEDAR TREE STAKES DRIVEN IN

AT AN ANGLE AND DRAWN

(2)-STAKES ON OPPOSITE SIDES PER TREE, OF A 2 1/2" CALIPER

OR LESS. FOR LARGER TREES

STAKE AFTER ONE FULL

-WOVEN CANVAS BELTING

MULCH OVER SOIL RING

DIG HOLE 24" -36" LARGER

THAN ROOT BALL

PLANTING MIX

ORIGINAL SLOPE

MODIFIED SLOPE

MULCH 3" MIN.

PLANTING SOIL

EXISTING SUBGRADE

SCALE: NONE

EXISTING SUBGRADE

SCALE: NONE

GROWING SEASON

PROVIDE (3)-STAKES. REMOVE

TO VERTICAL. -PROVIDE

VISIBLE AT GRADE. PRUNE ANY

PREVIOUS GROWING

GIRDING ROOTS

QUANTITIES AS IT RELATES TO SIZE,

WATERING FREQUENCY, INSTALLATION

ON SPECIES AND TIME OF

WRAP TREE IN FALL AS

SEASON

REQUIRED

REQUIRED

WATERING BAG.

(120° /

STAKING

DIAGRAM

STAKING

DIAGRAM

4" TALL EARTH SAUCER BUILT ON LOW SIDE -

PERIMETER OF BUILDING

PERENNIALS AND/OR

PERENNIAL GRASSES

BARK MULCH

3/16" X 4" EDGING,

SHREDDED HARDWOOD

REFER TO PLANS PERENNIAL BED PLANTING DETAIL


SLOPE PLANTING DETAIL

REFER TO TYPICAL DECIDUOUS TREE DETAIL FOR STAKING

SCALE: NONE

CONIFEROUS SHRUB PLANTING DETAIL

SCALE: NONE

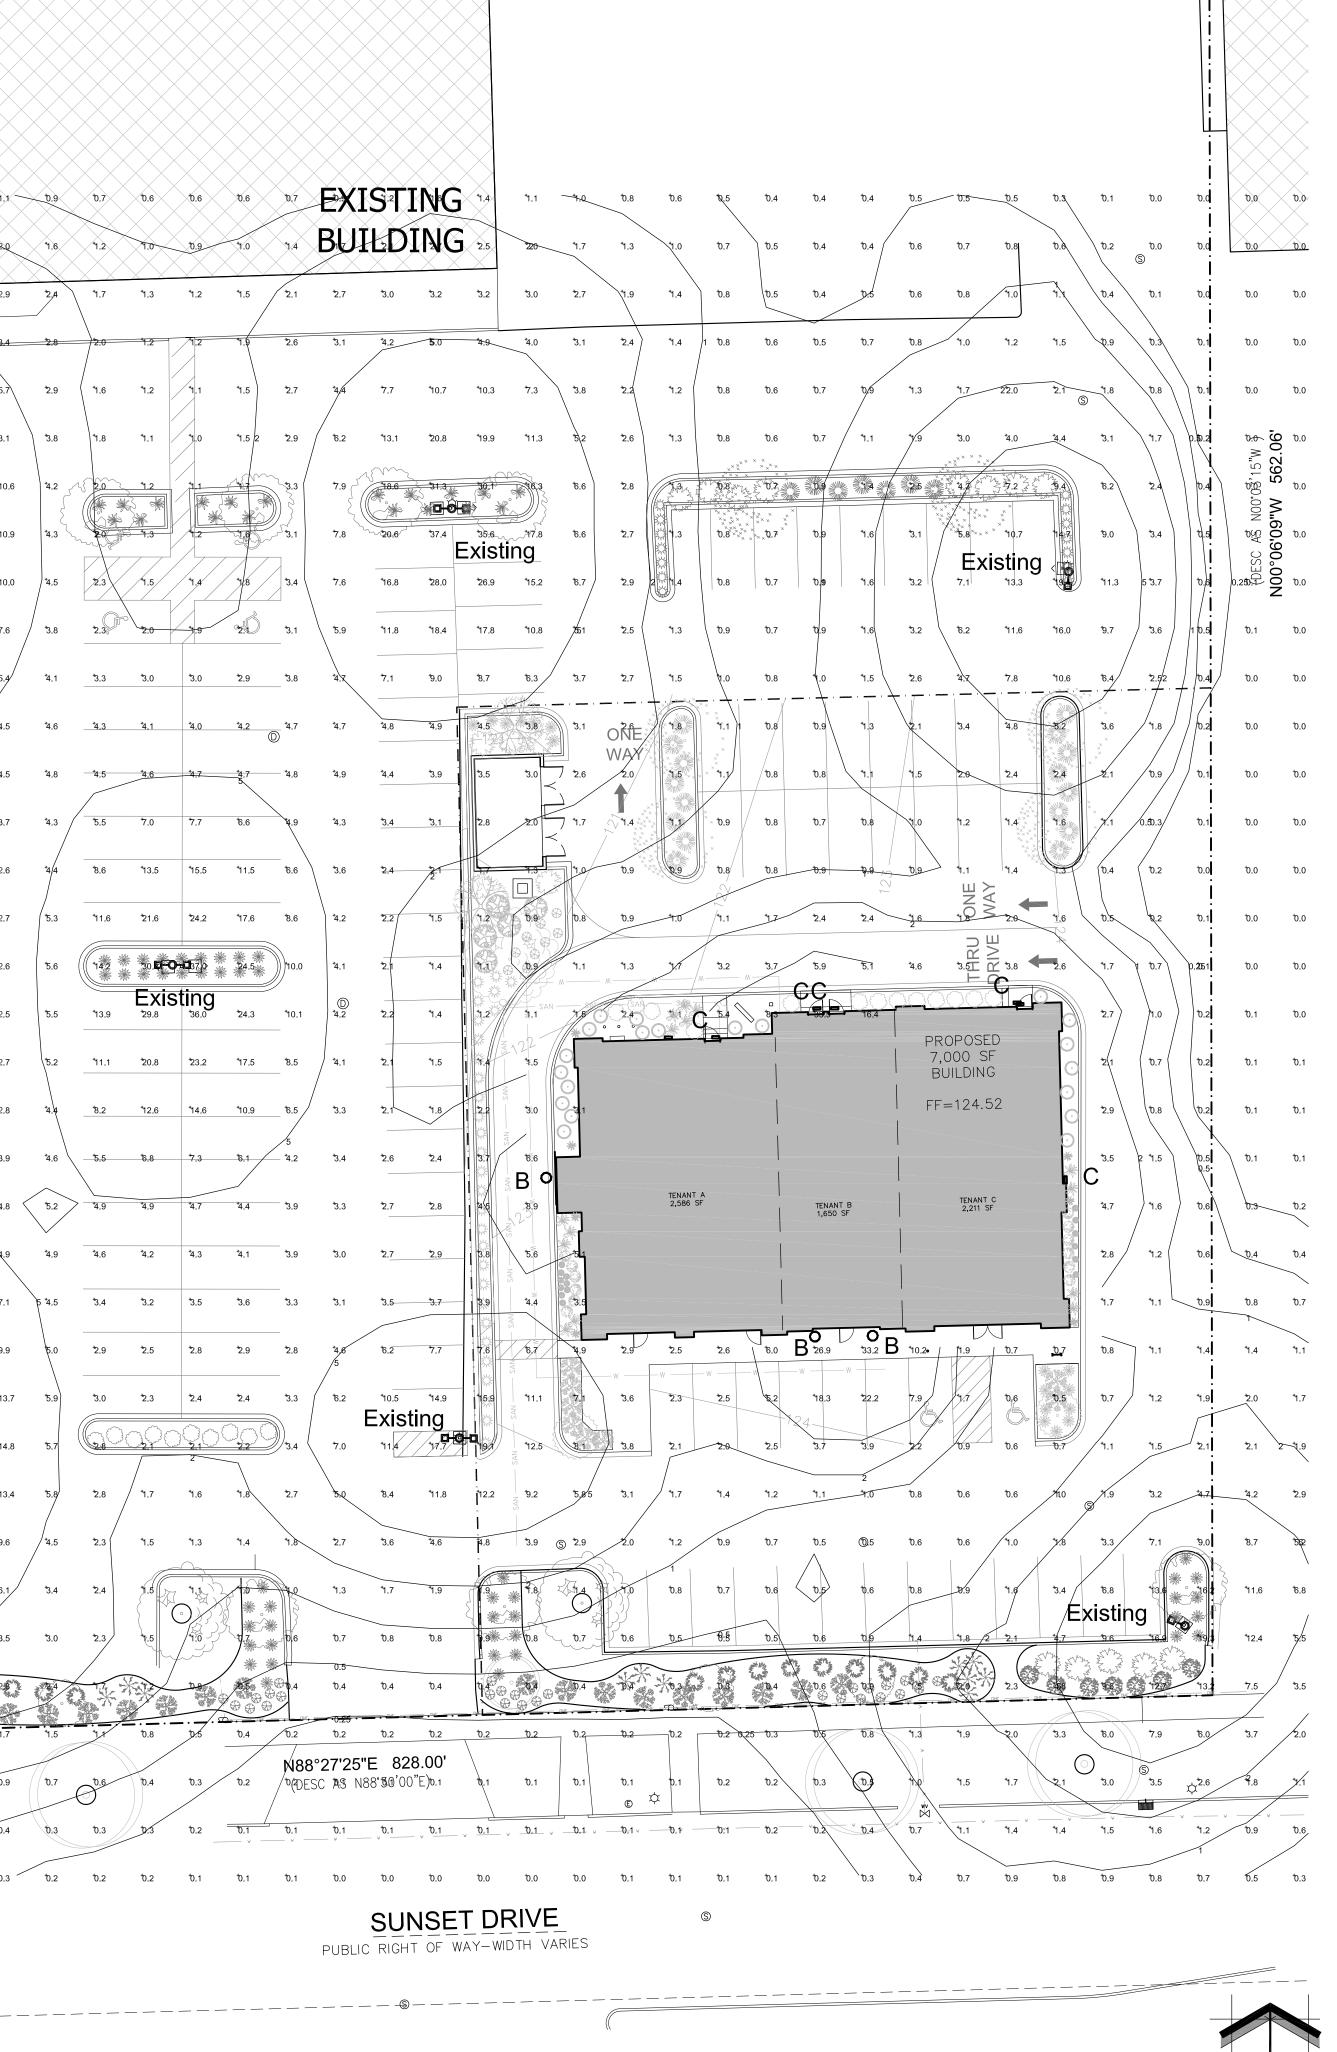

PROPOSED PARTIAL PHOTOMETRIC LIGHT LEVEL CALCULATIONS PLAN

LUMINAIRE SCHEDULE													
Symbol	Label	Qty	Catalog Num	ber	Description			Lamp		File	Lumens	LLF	Watts
	В	3	SOV-RD-175 PSMV-C73	j-	V 175 w/ PUI & A DIFFUSE	SE START META ED FLAT TEMPER OOF HARDWARE	PY FIXTURE TYPE AL HALIDE LAMP RED LENS AND A E(COLOR TO BE	1- 175W P BU	SMV CLEAR	SOV-RD-175- PSMV-C73.ies	17500	1.00	208
	С	5	CHWS-FT-10 F	00-MH-	CHALLENGER WALL SCONCE SERIES MEDIUM TYPE III FORWARD THROUGH w/ 100 W PSMV & FLAT CLEAR TEMPERED GLASS LENS w/ DIFFUSING REFLECTOR & DARK-SKY COMPLIANT HARDWARE HOUSE SIDE SHIELDING IN A BLACK FINISH AND AN OPTIONAL PHOTOCELL CONTROL		CHWS-FT-100- MH-F.ies	9000	1.00	129			
STATIS	ГICS												
Description		5	Symbol /	Avg	Max	Min	Max/Min	Avg/Min					
Calc Zone #2	2		+ 2	.6 fc	47.5 fc	0.0 fc	N/A	N / A					

EXISTING POLE MOUNTED FIXTURES IN THE PARKING LOT FILD ARE SHOW FOR REERENCE.

THIS LIGHTING PLAN REPRESENTS ILLUMINATION LEVELS CALCULATED FROM LABORATORY DATA TAKEN UNDER CONTROLLED CONDITIONS IN ACCORDANCE WITH THE ILLUMINATING ENGINEERING SOCIETY (IES) APPROVED METHODS. ACTUAL PERFORMANCE OF ANY MANUFACTURER'S LUMINAIRES MAY VARY DUE TO CHANGES IN ELECTRICAL VOLTAGE, TOLERANCE IN LAMPS/LED'S AND OTHER MAY VARY DUE TO CHANGES IN ELECTRICAL VOLTAGE, TOLERANCE IN LAMPS/LED'S AND OTHER VARIABLE FIELD CONDITIONS. CALCULATIONS DO NOT INCLUDE OBSTRUCTIONS SUCH AS BUILDINGS CURBS, LANDSCAPING, OR ANY OTHER ARCHITECTURAL ELEMENTS UNLESS NOTED.


PHOTOMETRIC GENERAL NOTES:

SCALE: 1" = 20'-0"

- BASED ON THE INFORMATION PROVIDED, ALL DIMENSIONS AND LUMINAIRE LOCATIONS SHOWN REPRESENT RECOMMENDED POLE PLACEMENTS AND LUMINAIRE ORIENTATION. THE ENGINEER AND/OR ARCHITECT MUST DETERMINE APPLICABILITY OF THE LAYOUT TO RELEVANT FIELD CONDITIONS.
- THE DEPICTED ILLUMINATION RESULTS ARE BASED UPON ILLUMINATION MEASUREMENTS AS CALCULATED BY AN INDEPENDENT LABORATORY. LUMINAIRE CHARACTERISTICAL DATA WAS MEASURED UNDER CONTROLLED CONDITIONS IN ACCORDANCE WITH APPROVED ILLUMINATION ENGINEERING SOCIETY METHODS. ACTUAL ON-SITE PERFORMANCE OF ANY MANUFACTURER'S LUMINAIRES MAY VARY FROM LABORATORY TEST RESULTS DUE TO VARIATIONS IN: ELECTRICAL VOLTAGE, TOLERANCE IN LAMPS, AND OTHER VARIABLE FIELD
- 3. IF EXISTING LUMINAIRES ARE INCLUDED IN THIS REPORT, THEIR ILLUMINATION CHARACTERISTICS ARE BASED UPON A COMBINATIONS OF CUSTOMER'S PROVIDED SPECIFICATIONS & OUR BEST ESTIMATIONS.

EXISTING CONDITIONS GENERAL NOTES:

- . Information pertaining to existing conditions given on these architectural drawings represents to the best of our knowledge the actual existing field CONDITIONS. INSITE LANDSCAPE DESIGN, INC. MAKES NO WARRANTY AS TO THEIR ACCURACY. CONTRACTOR TO FIELD VERIFY EXISTING CONDITIONS IMPERATIVE TO THEIR NEW WORK. REPORT ANY DISCREPANCIES BETWEEN THE DRAWINGS AND FIELD CONDITIONS TO THE LANDSCAPE ARCHITECT FOR REVIEW. ANY WORK PERFORMED PRIOR TO RESOLUTION OF DISCREPANCIES BY THE LANDSCAPE ARCHITECT IS SUBJECT TO REMOVAL AND REPLACEMENT AT NO ADDITIONAL COST TO THE CONTRACT.
- 2. VERIFY ALL EXISTING CONDITIONS, DIMENSIONS, AND ALIGNMENT OF WALLS. BRING ANY DISCREPANCIES TO THE LANDSCAPE ARCHITECTS ATTENTION PRIOR TO FABRICATION / CONSTRUCTION BEGINS.
- 3. VERIFY LOCATION OF ACCESS PANELS W/ MECHANICAL AND ELECTRICAL EQUIPEMENT FOR ACCESSIBILITY OF MECHANICAL & ELECTRICAL ITEMS.

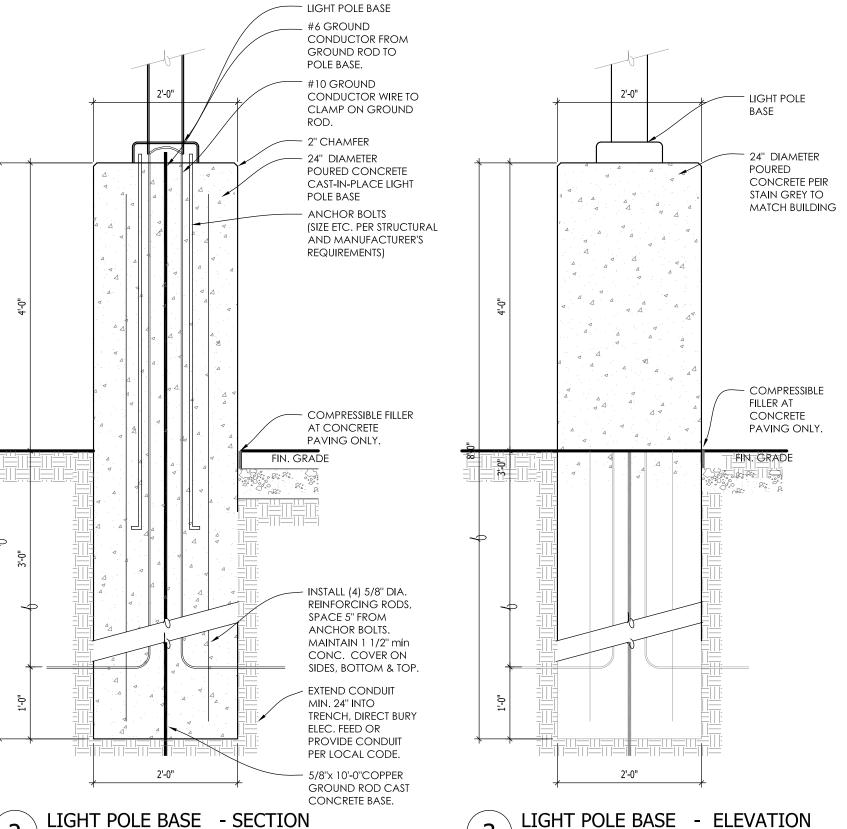

LIGHT POLE BASE - ELEVATION SCALE: 3/4"=1'-0"

> WISCONSIN STATUTE 182.0175 (1974) REQUIRES A MINIMUM OF 3 DAYS NOTICE BEFORE YOU EXCAVATE (NOT INCLUDING SATURDAY, SUNDAY OR LEGAL HOLIDAYS)

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MAY BE OTHER UNDERGROUND UTILITY INSTALLATIONS

WITHIN THE PROJECT AREA THAT ARE NOT SHOWN.

FACILITIES BEFORE YOU DIG IN UTILITY ALERT NETWORK <u>(800)-242-8511</u>, (262) 432-7910 (877) 500-9592 www.Diggershotline.com

PARTICIPANT'S UNDERGROUND

Call before you dig.

LANDSCAPE Landscape Architecture and Master Planning Design Consulting

> 11525 W. North Avenue Suite 1B Wauwatosa, WI 53226 Tel (414) 476-1204 www.insitelandscape.com mdavis@insitelandscape.com

<u>Project:</u>

SUNSET REDEVELOPMENT

120 E. Sunset Drive Waukesha, WI

Issuance and Revisions:

| Number | Description

05/11/16 Submittal

06/17/16

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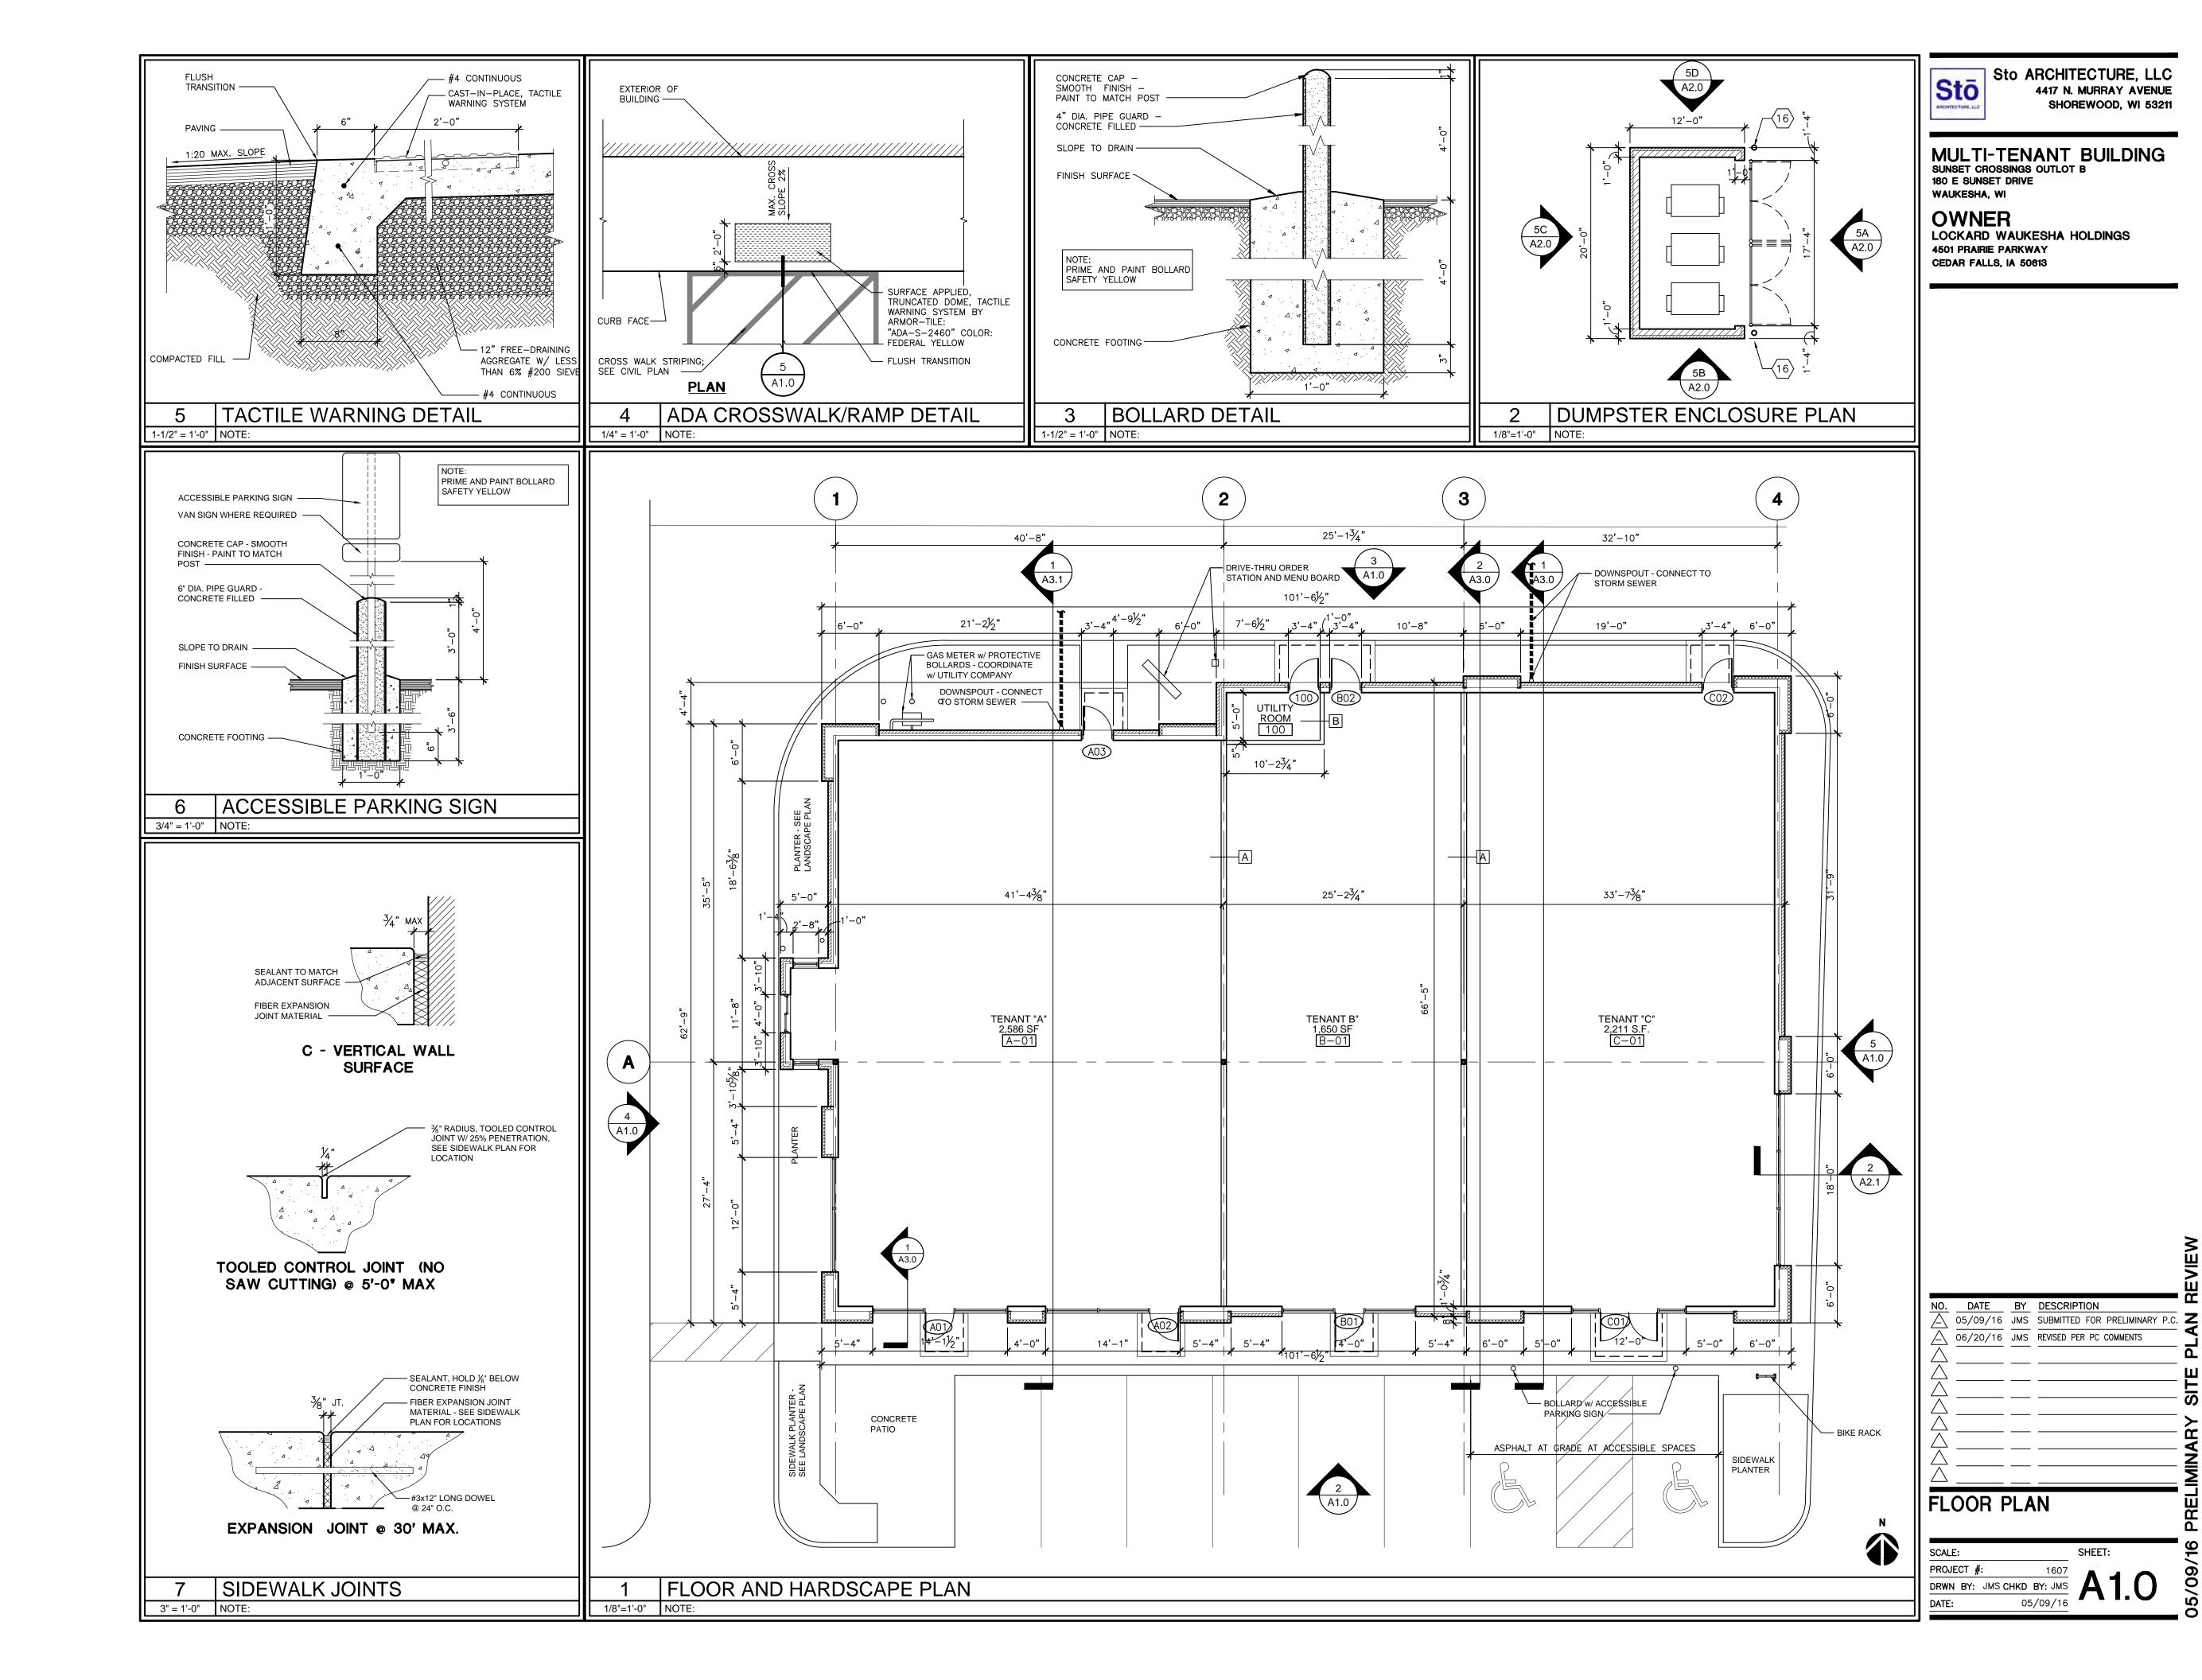
LANDSCAPE ARCHITECT, OR FROM ANY REUSE OF THE DRAWINGS OR DATA WITHOUT THE PRIOR WRITTEN CONSENT OF THE LANDSCAPE ARCHITECT.


MADE BY ANYONE OTHER THAN THE

PROPOSED PARTIAL PHOTOMETRIC LIGHT LEVEL CALCULATIONS PLAN, GENERAL NOTES, AND FIXTURE TABLE

Date of Drawing:	06/17/10
Scale:	1'' = 20'-0
Drawn By:	MCD
Job Number:	L16-02

Sheet Number:



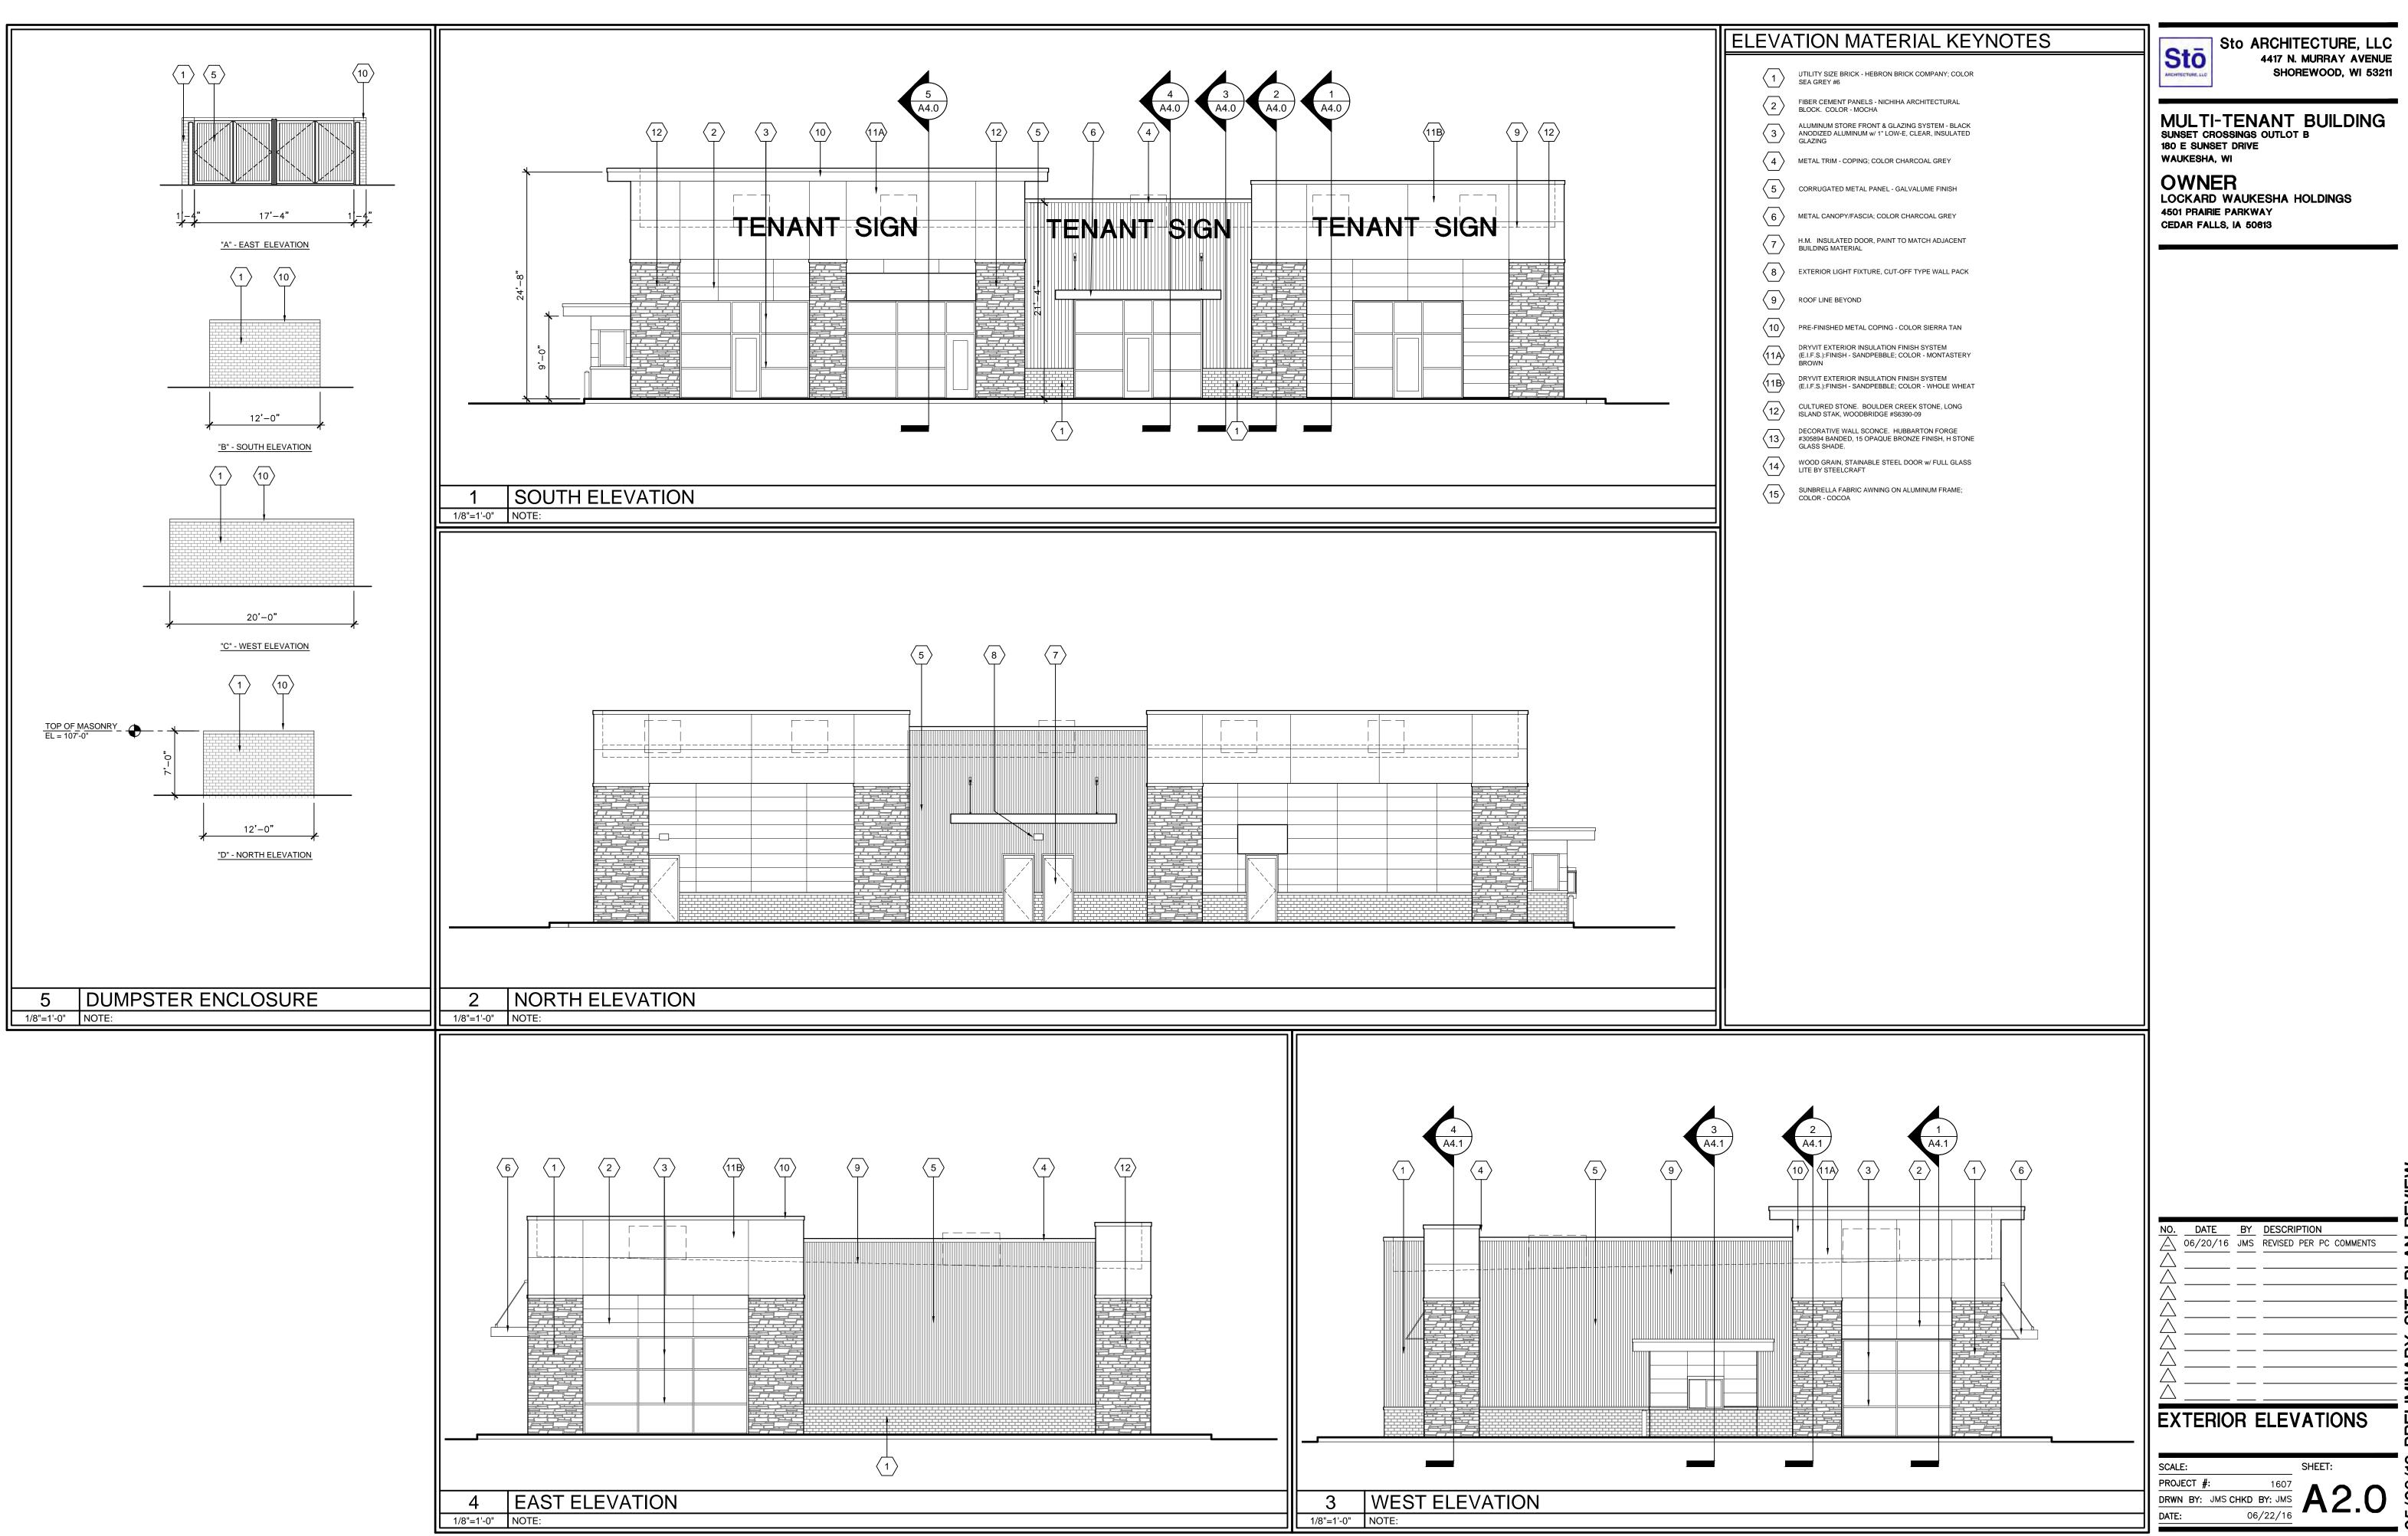

SHOREWOOD, WI 53211

MULTI-TENANT BUILDING SUNSET CROSSINGS OUTLOT B

DATEBYDESCRIPTION06/20/16JMSREVISED PER PC COMMENTS

EXTERIOR ELEVATIONS

PROJECT #: 1607

DRWN BY: JMS CHKD BY: JMS

06/22/16


A 2.0 06/22/16



12\\(11A\)



2 - REAR (NORTH) ELEVATION

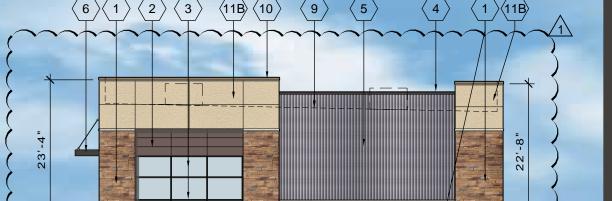

3 - SIDE (WEST) ELEVATION

4 - SIDE (EAST) ELEVATION SCALE: 1/16"= 1'-0"



Sto ARCHITECTURE, LLC 4417 N. MURRAY AVENUE SHOREWOOD, WI 53211

PROPOSED OUTLOT B **BUILDING**

120 E SUNSET DRIVE WAUKESHA, WI

REVISION

SCALE: 1/16"= 1'-0"

DATE

06-16-16

PROJECT NO. 1607

DATE 05-31-16

SHEET DE-2



SCALE: 1/16"= 1'-0"

24'-8"

PRODUCT SPECIFICATIONS



Banded Large Outdoor Sconce

Base Item #305894

Item #305894D-05-H37

A clean, sleek design that evokes dreams of the Far East is the hallmark of our Banded Collection. True to the collection's name, two handcrafted metal bands, intersected by a bold, vertical bar, encircle the glass and fasten to an aluminum mounting plate.



FINISH Bronze - 05 GLASS Stone Glass (H) LAMPING LED

SPECIFICATIONS

Banded Large Outdoor Sconce

Base Item #: 305894 Item #: 305894D-05-H37

Outdoor sconces with glass options: Banded

aluminum

 Handcrafted to order by skilled artisans in Vermont, USA

• Lifetime Limited Warranty when installed in residential setting

Dimensions

 Height
 20.80"

 Width
 7.80"

 Projection
 6.50"

Backplate 7.80" x 20.80"

Vertical Mounting Height 10.40"
Packed Weight 13.00 lbs
Shipping (DIM) Weight 29.00 lbs

LED Lamping Retrofit

LED: LED - GU24, 9.8W Bulb, 810lm (Bulb Incl)

CCT: 2700K CRI: Min 80 Dimming: Yes Voltage: 120V


Location Rating

Outdoor Wet

Safety Rating

UL, CUL listed

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THE CHALLENGER® WALL Sconce Series -AN INTEGRAL COMPONENT OF YOUR ARCHITECTURAL DESIGN

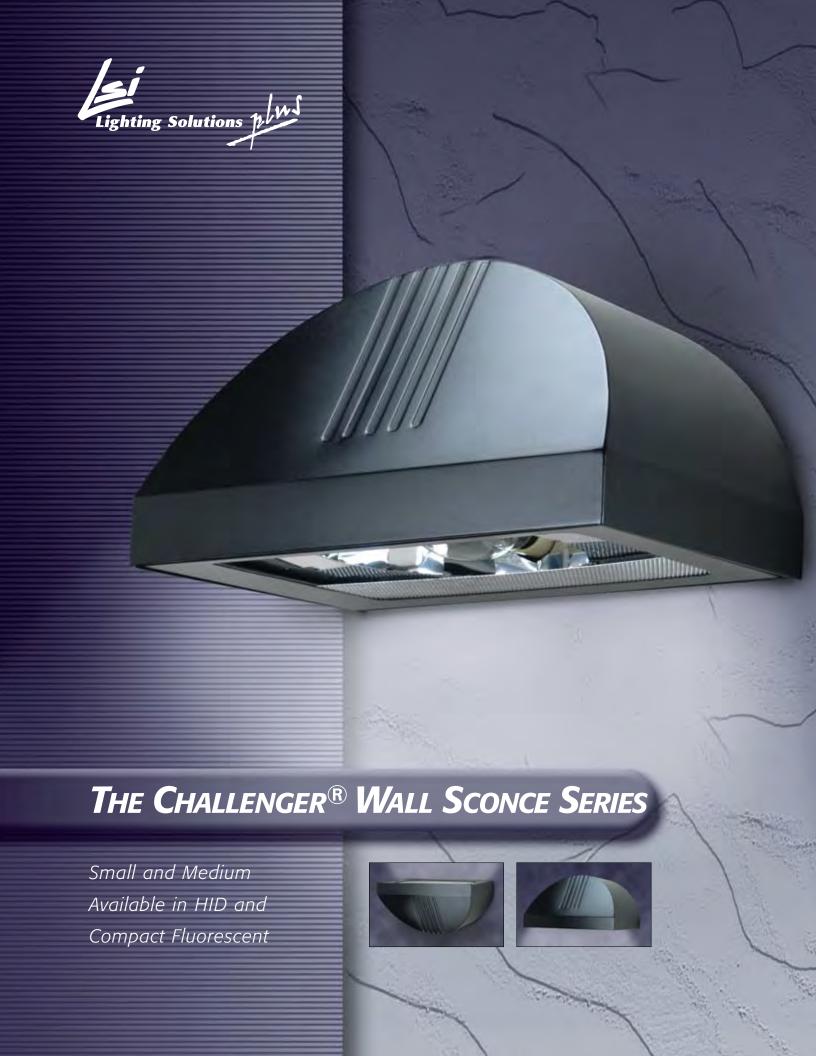Indoor or outdoor. General illumination, focused accent spotlighting, or a simple extension of your architectural statement. The Challenger Wall Sconce Series combines versatility and performance with sleek, aerodynamic styling for the perfect complement to your architectural experience.

Featuring simplified access, a horizontal lamp orientation, a flat lens, and a choice of high-performance reflector options and light sources, the Challenger Wall Sconce is extremely efficient and easy to maintain.

In addition, the Challenger Wall Sconce comes fully assembled for quick and easy installation. With smooth lines, refined curves, a choice of two sizes, and six standard finish colors, the Challenger Wall Sconce blends smoothly into any design environment for enhanced architectural appeal.

Downlight mounting is available for indoor and outdoor applications.



Uplight mounting is available for indoor or under canopy applications only.





HIGH-PERFORMANCE HORIZONTAL BURN

Where strict zoning requirements are encountered, the environmentally friendly Challenger Wall Sconce

downlight offers full cut-off lighting distribution as defined by the IESNA (Illuminating Engineering Society



ARCHITECTURAL HOUSING


Formed aluminum housing is rectangular in shape, featuring sleek, smooth lines and refined curves for an aerodynamic look that enhances the architectural integrity of any site.





Two Sizes

Small fixture is available from 50 to 150 Watts HID and 26 to 2/42 Watts Compact Fluorescent. Medium fixture is available from 250 to 400 Watts HID and 26 to 2/70 Watts Compact Fluorescent.

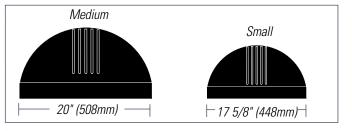

REMOVABLE DOOR FRAME WITH FLAT LENS

Aluminum door frame is sealed to housing with a one-piece, extruded silicone gasket, and is removable for easy access. Clear, flat, tempered glass lens is sealed to the door frame with EPDM gasketing to prevent entry of insects, dust and moisture.



Loosen two captive, stainless steel fasteners, and door frame swings open.



Squeeze wire-formed retainer to remove door frame.

SILICONE GASKET

One-piece, extruded silicone gasket seals the door frame against the housing.



LUMINAIRE FINISHES

Each Challenger Wall Sconce fixture is finished with DuraGrip^(R), LSI's baked-on, polyester-powder coat finishing process. LSI's DuraGrip finish withstands weather changes without cracking or peeling, and is guaranteed for 5 full years.











PLATINUM PLUS SATIN VERDE GREEN



THE NEW BENCHMARK IN WALL SCONCE PERFORMANCE & STYLE

FULLY ASSEMBLED FOR QUICK AND EASY INSTALLATION

The Challenger Wall Sconce comes fully assembled (pre-wired and HID pre-lamped) from the factory. The specially designed mounting plate provides for easy installation in just three quick steps.



1. Attach wall-mounting plate to the junction box.




2. Make the wiring connections, and attach the fixture to the wall-mounting plate by hanging it over the beveled lip of the wall-mounting plate.







3. Lock fixture into place by tightening two hex head screws.

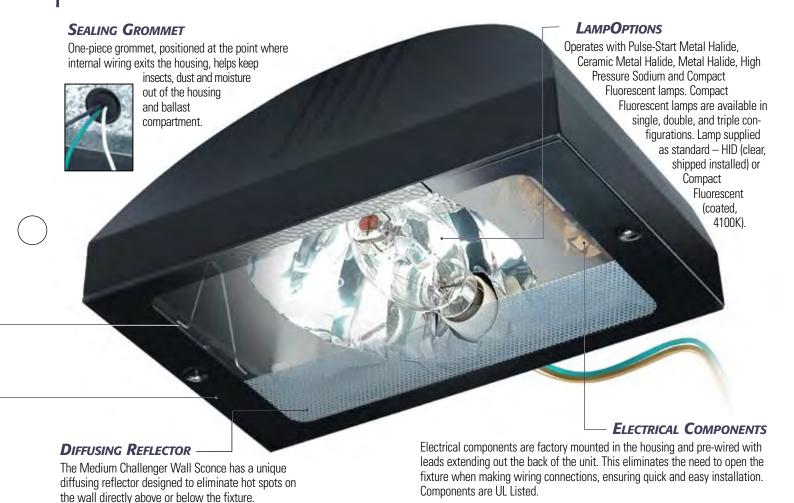

REFLECTOR OPTIONS - Reflector models are protected by U.S. Patents # 6,464,378.

Forward Throw (FTM & FT) and Type III reflector systems are available with both small and medium fixtures. Both offer high-performance, full cut-off distribution as defined by the IESNA. For detailed photometric data, please visit our website at www.lsi-industries.com




Typical Type FT photometric pattern.



La.

Typical Type III photometric pattern.

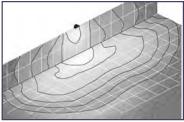

CHWM FT CHWM 3

Challenger site lighting fixtures have long been known as one of the industry's best values in architectural lighting, coupling a smooth, contoured appearance with high performance for maximum architectural effect.

Challenger Wall Sconces can be combined with Challenger site lighting fixtures for added architectural appeal and a sense of continuity throughout your site.

Working together, Challenger Wall Sconces and Challenger site lighting fixtures serve as the perfect complement to each other, while enhancing your overall architectural experience both inside and out.



The Challenger Wall Sconce



The Challenger Large -Featuring a die-cast aluminum housing, available with Vertical or Horizontal Burn optical systems. Up to 1000 Watt MH.


The Challenger II Medium – Featuring a formed aluminum housing, available with Vertical or Horizontal Burn optical systems. Up to 400 Watt HID.








DIMENSIONS

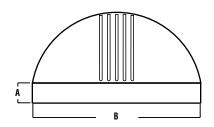

	Α	В	C	D	E
Small	(48mm)	(448mm)	(144mm)	(244mm)	(222mm)
	1-7/8"	17-5/8"	5-21/32"	9-5/8"	8-3/4"
Medium	(60mm)	(508mm)	(219mm)	(341mm)	(273mm)
	2-3/8"	20"	8-5/8"	13-7/16"	10-3/4"

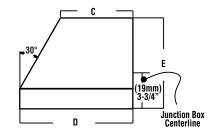

0			0	5-11/16" (145mm)
	$\overline{}$	$\neg \vdash$		
7	-3/4" ((197mn	1)	
Un	iversal	Mount	ina P	late

SHIPPING V	all Sconce			
Catalog Number	Est. Weight (kg/lbs.)	Length (mm/in.)	Width (mm/in.)	Height (mm/in.)
CHWS-HID	10 / 22	616 / 24.25	394 / 15.5	343 / 13.5
CHWM-HID	15 / 32	616 / 24.25	394 / 15.5	419 / 16.5
CHWS-CFL	8 / 17	616 / 24.25	394 / 15.5	343 / 13.5
CHWM-CFL	11 / 24	616 / 24.25	394 / 15.5	419 / 16.5



A Company with a Smart Vision

LSI LIGHTING SOLUTIONS PLUS 10000 Alliance Road Cincinnati, Ohio 45242 (513)793-3200 FAX (513)793-0147 www.lsi-industries.com



Listed for wet locations. (Downlight only) Listed for damp locations. (Uplight only)









SOVEREIGN




DIMENSIONS

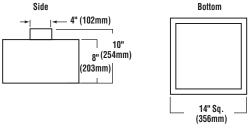

Note: Box not required on 100W MH (replaced with flat cover plate).

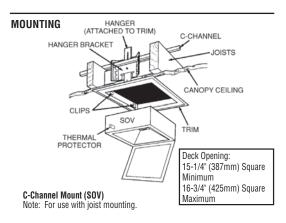

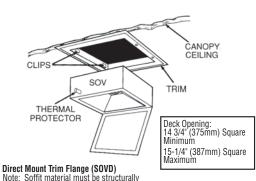

SHIPPING	G WEIGHTS -			
Catalog Number	Est. Weight (kg/lbs.)	Length (mm/in.)	Width (mm/in.)	Height (mm/in.)
SOV	10/21	425/16.75	425/16.75	413/16.25

Catalog #

sound to support trim flange kit and fixture.

oany with a Smart Vision

HOUSING - Top panel of housing, including box which encloses socket, and housing side panels are galvanized steel. Corners are finished to produce a clean, sharp appearance and increase housing strength. A thermal protector is a standard feature of the Sovereign.

DOOR FRAME - Two captive stainless steel machine screws secure the lens frame assembly to the housing while allowing easy access without loose hardware.

LENS/GASKET - Available with a C73 diffused flat tempered glass. A continuous one-piece EPDM gasket seals the lens frame to the housing.

SOCKETS - Porcelain mogul-base sockets. Medium-base sockets are featured on 100 Watt Metal Halide.

LIGHT SOURCES - Pulse-Start Metal Halide, Metal Halide, or High Pressure Sodium. Clear lamp is supplied as standard.

BALLASTS - High-power factor. High
Pressure Sodium fixtures utilize a type
HX-HPF or an R-HPF ballast designed for
-20° F operation. 175 Watt Pulse-Start
Metal Halide fixtures utilize a type CWA
ballast designed for -20° F operation.
100 Watt Metal Halide ballast utilizes
HX-HPF circuitry.

REFLECTOR/DISTRIBUTION PATTERN -

Sovereign reflector system and distribution pattern is available with vertical burn lamps: Type V Round (RD). Photometric data is tested in accordance with IESNA guidelines.

MOUNTING - Standard mounting type for the Sovereign is a C-Channel Mount or Direct Mount. Direct Mount Trim Flange Kit is constructed of prefinished aluminum trim flange with welded, mitered corners. The beveled outer edge seals the trim against the face of the soffit. The fixture snaps directly into the trim flange, secured by spring-loaded clips. Soffit material must be structurally sound to support trim flange kit and fixture.

FINISHES - Each fixture is finished with LSI's DuraGrip® polyester powder coat finishing process. The DuraGrip finish withstands extreme weather changes without cracking or peeling, and is guaranteed for five full years. Standard colors include bronze and white.

PHOTOMETRICS - Please visit our web site at <u>www.lsi-industries.com</u> for detailed photometric data.










Proiect Name | Fixture Type

SOVEREIGN

LUMINAIRE ORDERING INFORMATION

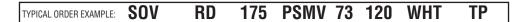



Luminaire Prefix	Distribution	Lamp Wattage		Lens	Line Voltage	Luminaire Finish	Options
SOV – C-Channel Mounting	RD – Type V Round	100 150 175	PSMV – Pulse-Start Metal Halide 175 Watt MH – Metal Halide	73 – C73 Diffused Flat Tempered Glass	120 208 240	BRZ – Bronze WHT – White	TP – Tamper-proof Door Hardware ¹ LL - Less Lamp
SOVD – Direct Mounting			100 Watt HPS – High Pressure Sodium 100, 150 Watt		277 347		
					Not available in Multi Tap, Tri Tap, or 480		
					Consult Factory for International Voltages and Light Sources		

FOOTNOTES:

1 - A Tamper-proof Screwdriver (SCD) must be ordered separately (see Accessory Ordering Information).

ACCESSORY ORDERING INFORMATION	(Accessories are field installed)		
Description	Order Number	Description	Order Number
SCD – Tamper-proof Screwdriver	36449	DFK208, 240 - Double Fusing	DFK208, 240
FK120 - Single Fusing	FK120	FK347 - Single Fusing	FK347
FK277 - Single Fusing	FK277	Direct Mounting Kit	132420CLR



Project Name _____ Fixture Type _____
Catalog #____

12/06/11