


AERIAL PHOTO

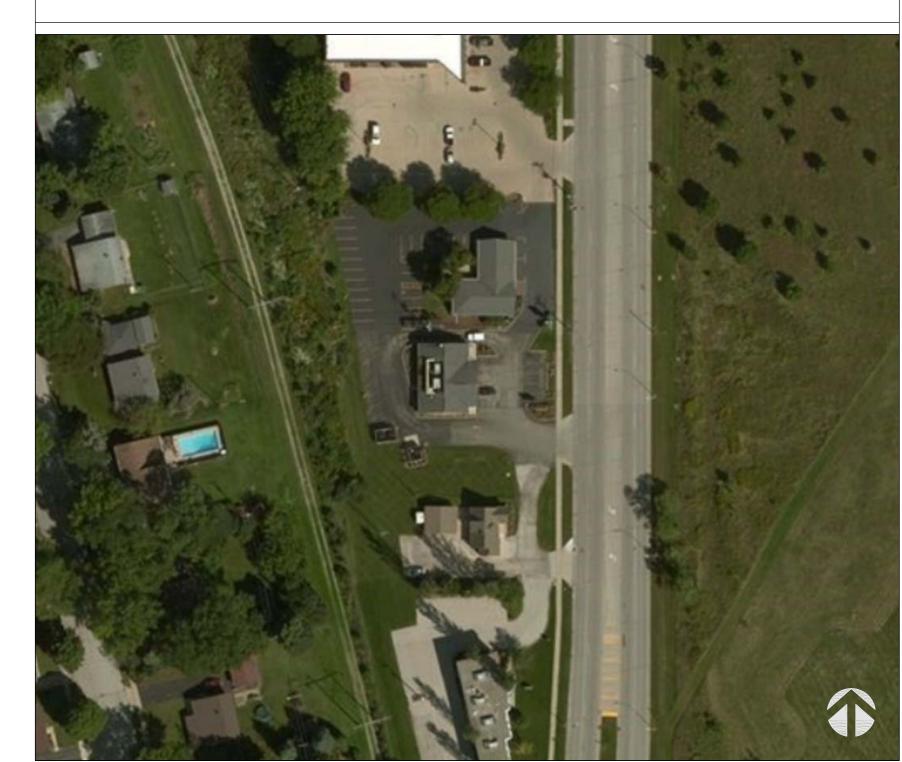

PARTICIPANTS

OWNER:

2260 N. Grandview Blvd LLC Waukesha, WI 53188 Tele: (262) 789-1930 Fax: (262) 789-8459 Contact: James D. Valentine E-mail: jvalentine@cousinssubs.com

ARCHITECT:

Perspective Design, Inc. 11525 W. North Avenue Wauwatosa, WI 53226 Tele: (414) 302-1780 Fax: (414) 302-1781 Contact: Brad Kropp E-mail: bkropp@pdi-arch.com

CIVIL ENGINEER:

CJ Engineering Design & Consulting 9205 W. Center Street Suite 214 Milwaukee, WI 53222 Tele: (414) 443-1312 x222 Cell: (414) 940-4450 Contact: Chris Jackson E-mail: chris@cj-engineering.com

LANDSCAPE:

Insite Landscape Design 11525 W. North Avenue Wauwatosa, WI 53226 Tele: (414) 476-1204 Contact: Mike Davis Email: mdavis@insitelandscape.com

GENERAL CONTRACTOR/ CONSTRUCTION MANAGER:

DRAWING INDEX CODE REFERENCE

TITLE SHEET

CIVIC:

SITE GRADING PLAN EROSION CONTROL PLAN

LANDSCAPE:

LSPI.I PROPOSED LANDSCAPE PLAN, GENERAL NOTES, & PLANT MATERIAL TABLE

LSP1.2 PROPOSED LANDSCAPE PLAN, PLANTING DETAILS

ARCHITECTURAL:

SPI.I SITE PLAN PSPI.I PHOTOMETRIC SITE PLAN PROPOSED FLOOR PLAN EX2.1 EXISTING EXTERIOR ELEVATIONS PROPOSED EXTERIOR ELEVATIONS RENDERINGS

BUILDING CODE:

WI COMMERCIAL BUILDING CODE ADOPTION OF THE INTERNATIONAL CODES

SUBJECT TO THE MODIFICATION SPECIFIED BY WI DEPTMARTMENT OF SAFETY \$ PROFESSIONAL SERVICES, CHAPTER 361-366 INTERNATIONAL BUILDING CODE - 2009

INTERNATIONAL ENERGY CONSERVATION CODE - 2009 COMCHECK: 3.9.03 INTERNATIONAL MECHANICAL CODE - 2009 INTERNATIONAL FUEL GAS CODE - 2009

INTERNATIONAL EXISTING BUILDING CODE - 200 ACCESSIBILITY CODES: INTERNATIONAL BUILDING CODE- 2009, CHAPTER 1 ICC/ANSI A117.1 - 2003 • D.O.J. - 2010 ADA STANDARDS FOR ACCESSIBLE DESIGN MECHANICAL CODE:
REFER TO WI COMMERCIAL BUILDING CODE

ELECTRICAL CODE: INTERNATIONAL BUILDING CODE - 2009, CHAPTER 27 WI SAFETY & PROFESSIONAL SERVICES, CHAPTER 316 REF. NATIONAL ELECTRIC CODE, NATIONAL ELECTRIC CODE (NEC) - 2008

SUBJECT TO THE CHANGES, ADDITIONS OR OMISSIONS SPECIFIED IN SUB CH. III. OF CHAPTER 316 PLUMBING CODE:

• INTERNATIONAL BUILDING CODE - 2009, CHAPTER 29

• WI SAFETY & PROFESSIONAL SERVICES, CHAPTER 381-387 FIRE PREVENTION: WI SAFETY & PROFESSIONAL SERVICES, CHAPTER 314 REFERENCE NFPA

NFPA I, FIRE CODE - 2009 AND/OR LOCAL FIRE ORDINANCE IF APPLICABLE SUBJECT TO THE MODIFICATIONS AS SPECIFIED IN CHAPTER 314

LIGHTING NOTES:
-THIS PROJECT IS AN ALTERATION TO AN EXISTING INTERIOR SPACE. LIGHTING PLANS, EMERGENCY LIGHTING PHOTOMETRIC, AND LIGHTING ENERGY CALCULATIONS SHALL BE PREPARED BY THE ELECTRICAL DESIGNER AND MADE AVAILABLE ON-SITE DURING CONSTRUCTION.

ACCESSIBILITY NOTES:
-THIS PROJECT INCLUDES AN ALTERATION TO AN AREA OF PRIMARY FUNCTION. AS TO THE ACCESSIBLE ROUTE, INCLUDING TOILET AND DRINKING FACILITIES, AS REQUIRED BY THE EXISTING BUILDING CODE. THESE UPGRADES ARE LIMITED TO 20% OF THE PROJECT COST AS ALLOWED BY THE EXISTING BUILDING CODE.

ABBREVIATIONS

STRUCTURAL:

MECHANICAL:

TO BE DESIGNED & SUBMITTED BY DESIGN BUILD

EGINEER UNDER SEPERATE CONTRACT

ELECTRICAL:

TO BE DESIGNED & SUBMITTED BY DESIGN BUILD EGINEER UNDER SEPERATE CONTRACT

PLUMBING:

TO BE DESIGNED & SUBMITTED BY DESIGN BUILD EGINEER UNDER SEPERATE CONTRACT

FIRE PROTECTION:

TO BE DESIGNED & SUBMITTED BY DESIGN BUILD EGINEER UNDER SEPERATE CONTRACT

EQUIPMENT: (PREPARED BY BOELTER CO.)

INSULATED HOLLOW INSULATION
INTERIOR
JOINT
JOIST
LAMINATE
LAVATORY
MATERIAL
MAXIMIM
MECHANICAL
MEDIUM
MISCELLANEOUS
MICROLAM
MISCOLAM
MAGONRY OPENING
METAL
MICROWAVE
NOT IN CONTRACT
NUMBER
NOMINAL
NOT TO SCALE
OVER ALL
ON CENTER
OVER ALL
ON CENTER
OVERHEAD DOOR
OPTIONAL
PERFORATED
PLATE
PLASTIC LAMINATE
PLYWOOD
DEBERNIGHED INSULATED HOLLOW METAL AIR CONDITIONING ACOUSTIC CEILING TILE CENTER LINE
CEILNG
CLOSET
CONCRETE MASONRY UNIT
COLUMN
CONCRETE
CONSTRUCTION
CONTINUOUS
CERAMIC TILE
CERAMIC TILE
DEMOLITION
DIAMETER
DIMENSION
DIAMSPOUT
DIAMINGS
DOUNSPOUT PLYWOOD
PREFIN PREFINISHED
PSF POUNDS PER SQUARE FOOT PAINT
POLYVINYLCHLORIDE
GUARRY TILE
ROD 4 SHELF
RECESSED

F REINFORCE
ROUGH OPENING

STAIN 4 VARNISH

SOLID CORE
ECT SECTION
HLV SHELVES
SIM SHELVES
SIM SHELVES
SIM STAIN
STOR STAIN
STORAGE
STRUCT STRUCTURAL
SV SHEET VINYL DOUNGPOUT
DISHWASHER
EACH
EXISTING
EXTERIOR INSULATION FINISH SYSTEM
EXPANSION OF EXPOSED
ELECTRICAL
ELEVATION
EQUIPMENT
EQUIVALENT
EXISTING TO REMAIN
EXTERIOR EIR EXISTING TO REEXT EXTERIOR
EW EACH WAY
FD FLOOR DRAIN
FF FINISH FLOOR
FIN FINISH
FIXT FIXTURE
FLR FLOOR
FDN FOUNDATION
FO FACE OF
F6 FLOOR SEAL
FTG FOOTING
FURN FURNACE
GA GAUGE
GALY GALVANIZED
GLU-LAM GLUE LAMINATED BEAM
GT GROUT
GUB GYPSUM WALL BOARD
H HARDWARE
HC HOLLOW CORE
HD HEADE
T HEIGHT
1 HOLLOW METAL
FIX FOR TOWN FOR THE FOR T STRUCTURAL
SHEET VINYL
STRIP WOOD
TO BE DETERMINED
TOP & BOTTOM
TOP OF
TELEPHONE
TONGUE & GROOVE
TRUSS JOIST
TOP OF PLATE
TYPICAL
UNDER COUNTER
UNLESS OTHERWISE NOTED
COVED VINYL BASE
VINYL COMPOSITION TILE
VERTICAL
VERIEY IN FIELD
VINYL WALL BASE
WITH

WALK-IN CLOSET
WOOD
WINDOW
WITHOUT
WATERPROOF
WELDED WIRE FABRIC

Drawing Title: TITLE SHEET


뿔뿔

IN ANY OE BY

Project:

07.08.16 Scale: Job:

Sheet:

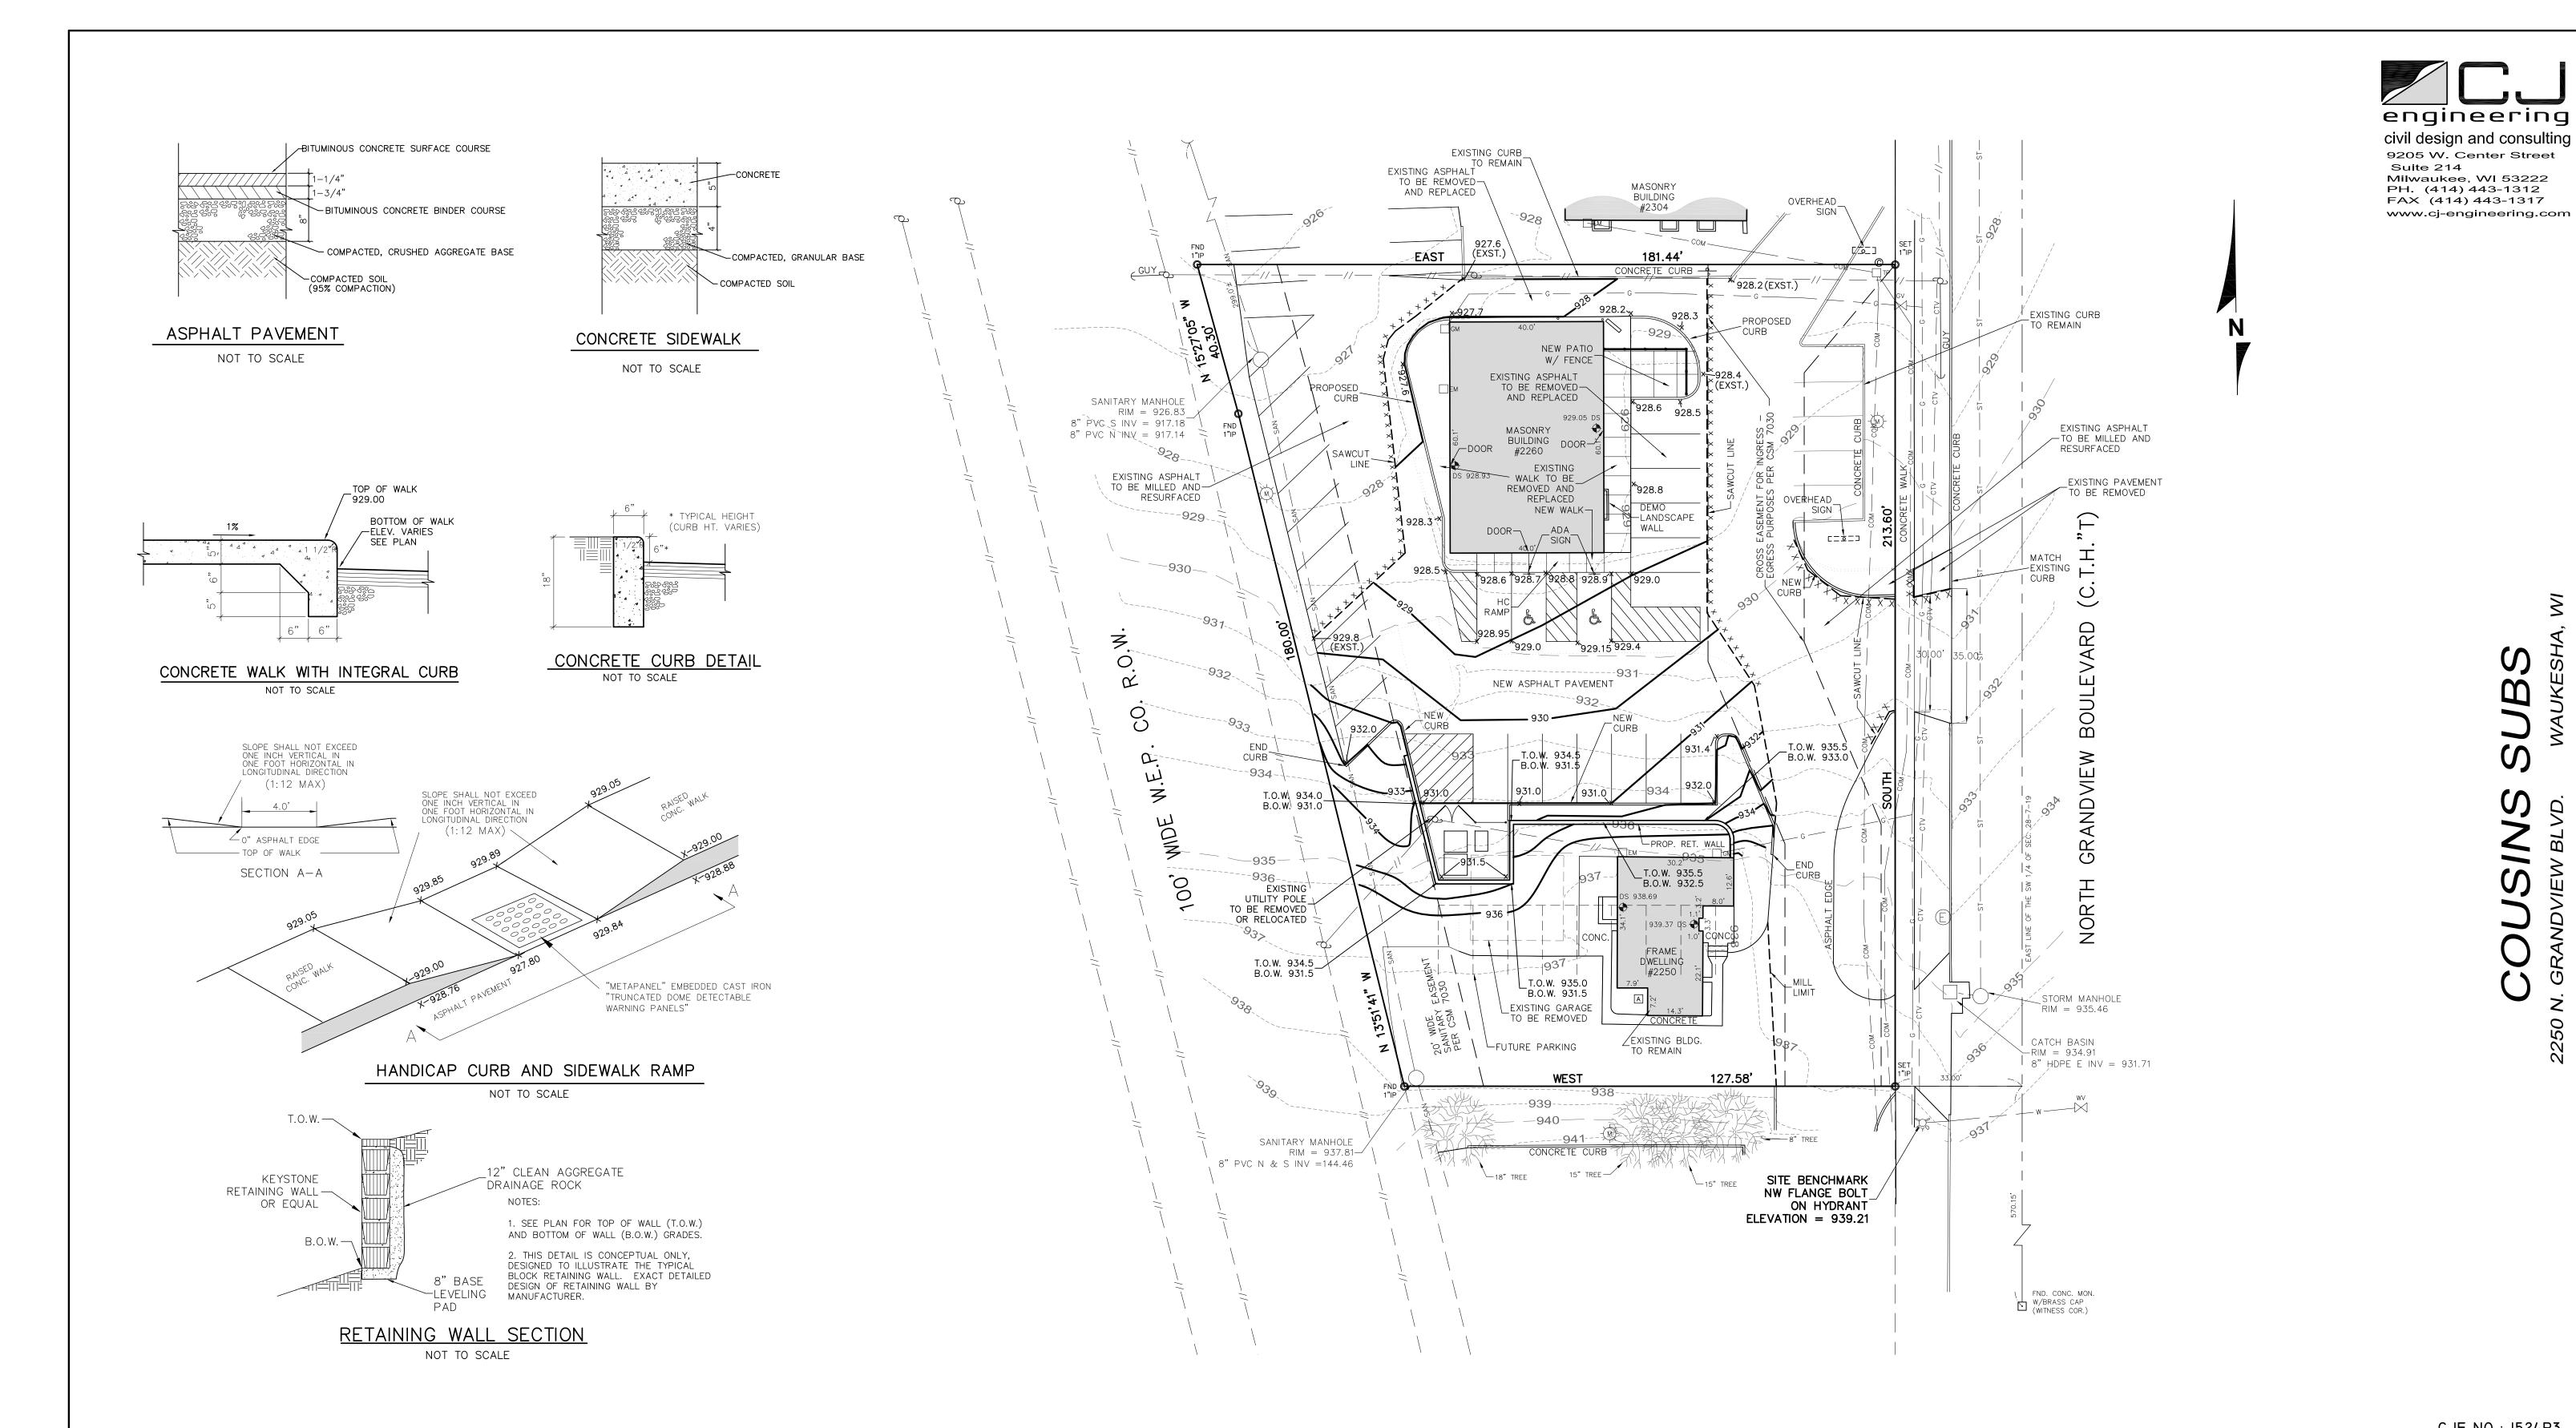

CJE NO.: 1524R3 JULY 7, 2016

SHEET 1 OF 2




LEGEND	
926	EXISTING CONTOUR
929 ———	PROPOSED CONTOUR
x 931.0	PROPOSED ELEVATION
	PROPOSED SAW CUT

NOTES:


1. DISTURBED AREA = 13,045 S.F. (0.30 ACRES).

2. NET INCREASE IN IMPERVIOUS AREA = 3,620 S.F. (0.083 AC.)

3. ALL PROPOSED SPOT GRADES SHOWN ARE AT BOTTOM OF CURB / WALK.

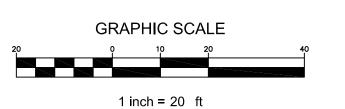

SITE GRADING PLAN C1.0

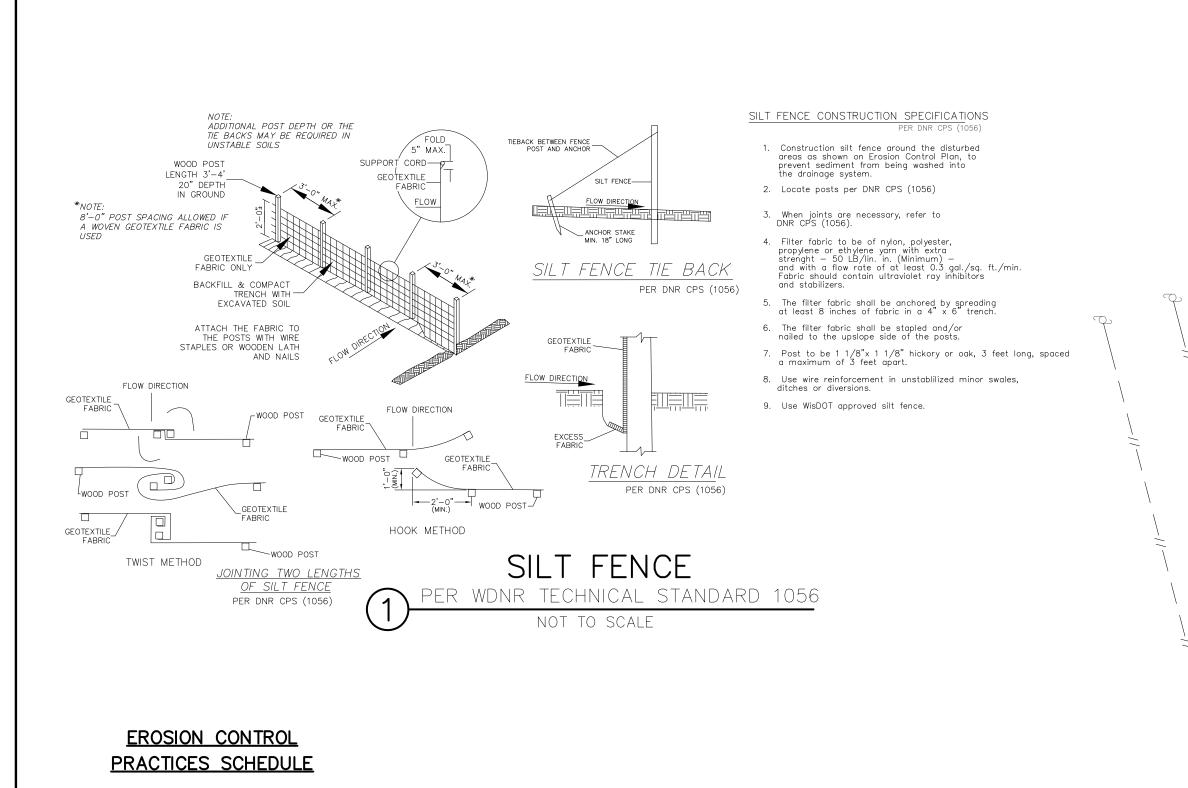

CONSTRUCTION SCHEDULE

1. OBTAIN PLAN APPROVAL AND OTHER APPLICABLE PERMITS.
2. FLAG THE WORK LIMIT AND BUFFER AREA FOR PROTECTION.

1 SILT FENCE


- 4. DEMO EXISTING GARAGE AND PAVEMENT AND GRASS AREA TO BE REMOVED. REMOVE MATERIAL FROM SITE.

 5. ROUGH GRADE SITE.
- 6. PROVIDE IMMEDIATE TEMPORARY STABILIZATION OF ANY DISTURBED AREAS WHICH WILL REMAIN INACTIVE FOR A PERIOD EXCEEDING 7 DAYS.
 7. INSTALL CURB, WALK AND BASE COURSE OF PAVEMENT.
- 8. FINAL GRADE SLOPES AND TOPSOIL CRITICAL SLOPES; VEGETATE AND MULCH ALL DISTURBED AREAS
- 9. ALL EROSION CONTROL PRACTICES WILL BE INSPECTED WEEKLY AND AFTER RAINFALL, NEEDED REPAIRS WILL BE PERFORMED IMMEDIATELY.
- 10. AFTER SITE IS STABILIZED, REMOVE ALL TEMPORARY MEASURES AND VEGETATE THE
- DISTURBED AREAS.

 11. ESTIMATED TIME BEFORE FINAL STABILIZATION 3 MONTHS.

MAINTENANCE PLAN

- 1. ALL EROSION AND SEDIMENT CONTROL PRACTICES WILL BE CHECKED FOR STABILITY AND OPERATION FOLLOWING EVERY ½" RUNOFF-PRODUCTION RAINFALL BUT IN NO CASE LESS THAN ONCE EVERY WEEK. ANY NEEDED REPAIRS WILL BE MADE IMMEDIATELY TO MAINTAIN ALL PRACTICES AS DESIGNED.
- 2. SEDIMENT WILL BE REMOVED FROM BEHIND THE SILT FENCE WHEN IT BECOMES ABOUT 0.5 FT. DEEP AT THE FENCE. THE SILT FENCE WILL BE REPAIRED AS NECESSARY TO MAINTAIN A BARRIER.
- 3. ALL SEEDED AREAS WILL BE WATERED, FERTILIZED, RESEEDED AS NECESSARY, AND MULCHED TO MAINTAIN A VIGOROUS, DENSE VEGETATIVE COVER.
- 4. ANY SEDIMENT REACHING A PUBLIC OR PRIVATE ROAD SHALL BE REMOVED BY STREET CLEANING BEFORE THE END OF EACH DAY.

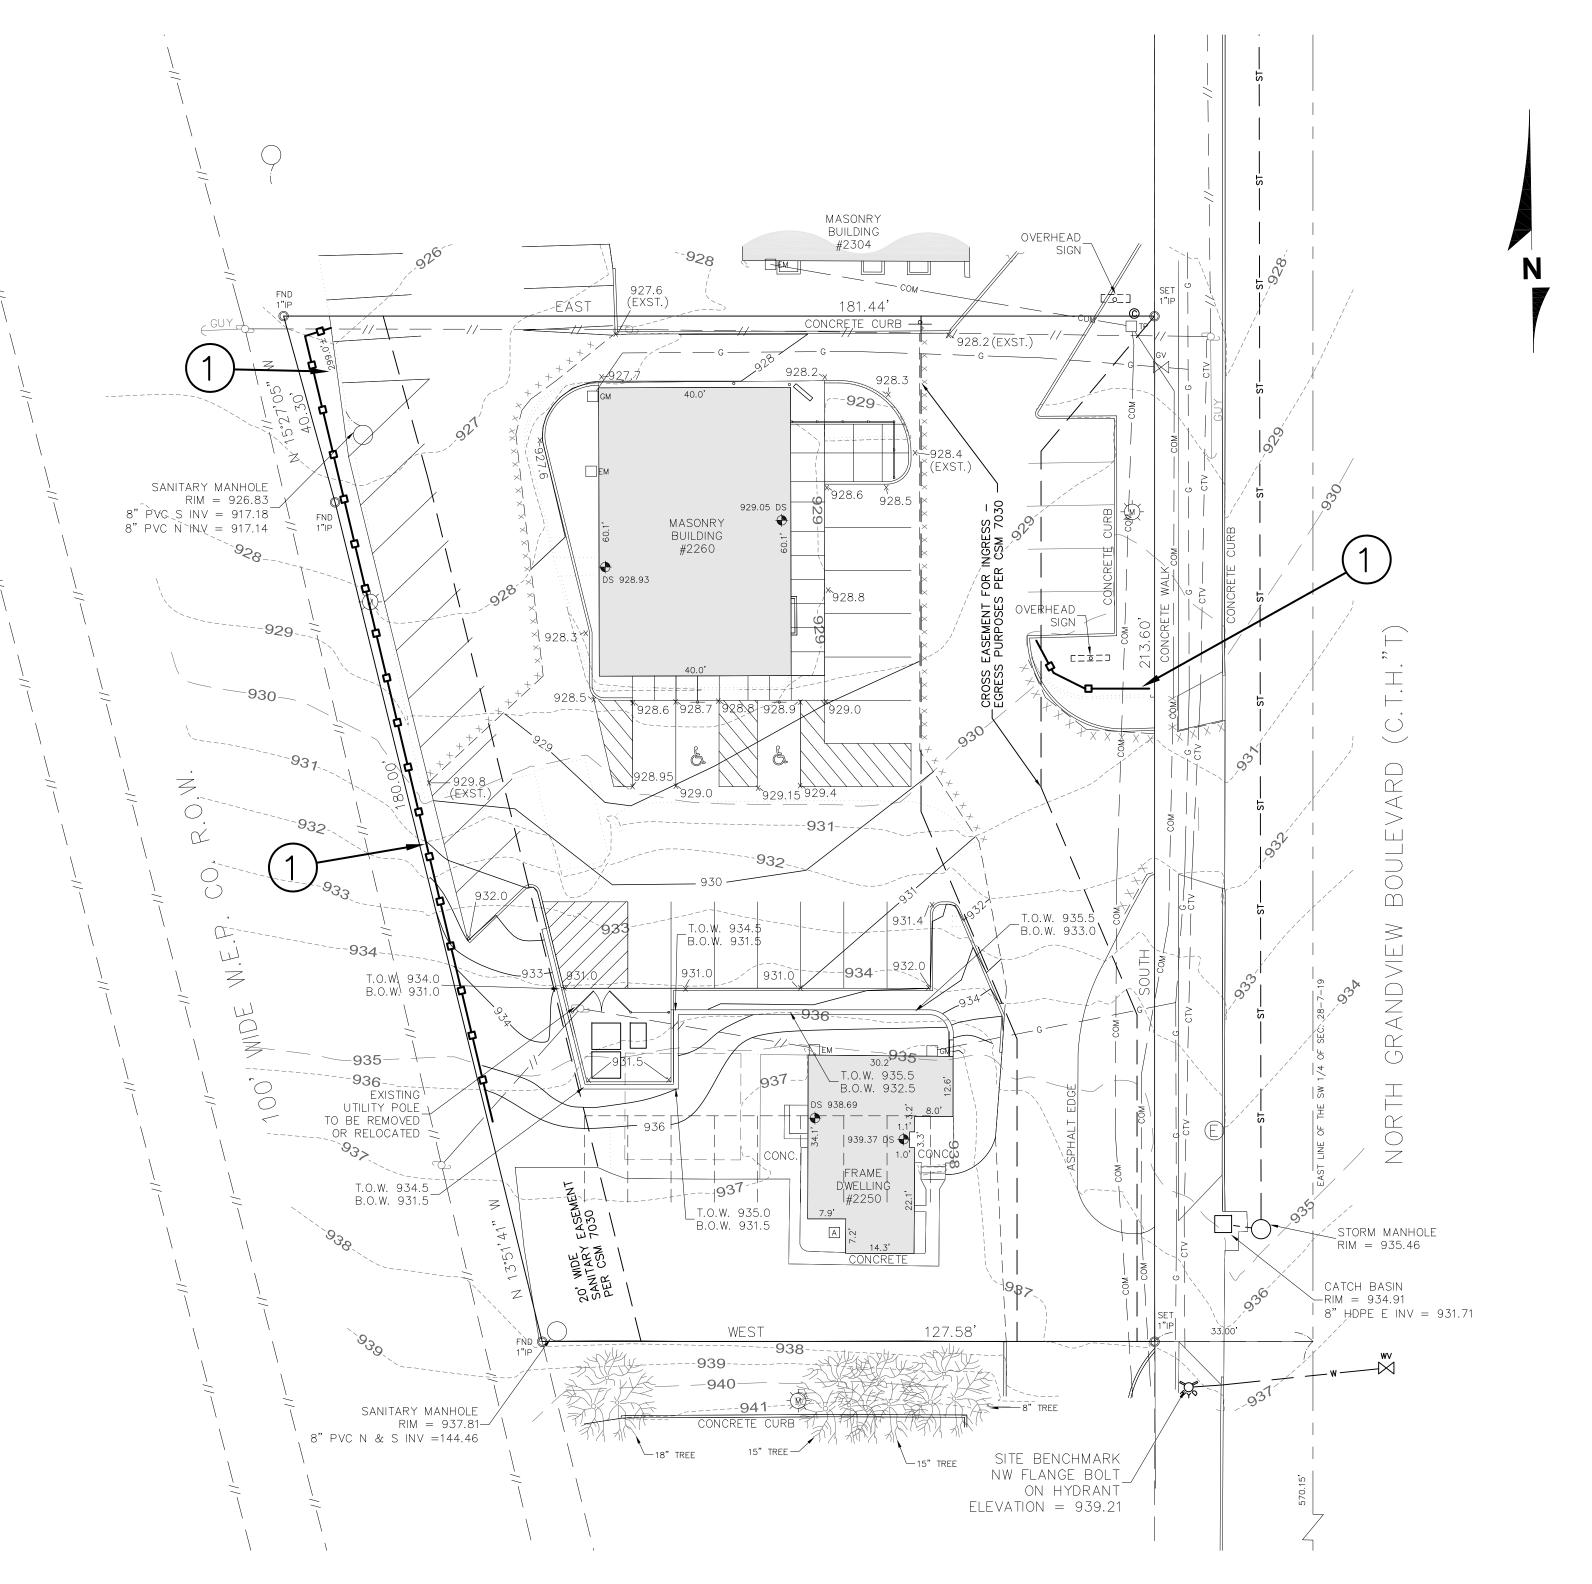

engineering
civil design and consulting
9205 W. Center Street
Suite 214
Milwaukee, WI 53222
PH. (414) 443-1312
FAX (414) 443-1317
www.cj-engineering.com

COUSINS SUB


CJE NO.: I524R3 JULY 7, 2016




LEGEN	ND
926	EXISTING CONTOUR
929 ———	PROPOSED CONTOUR
x 931.0	PROPOSED ELEVATION
	PROPOSED SAW CUT

NOTES:

- 1. DISTURBED AREA = 13,045 S.F. (0.30 ACRES).
- 2. NET INCREASE IN IMPERVIOUS AREA = 3,620 S.F. (0.083 AC.)
- 3. ALL PROPOSED SPOT GRADES SHOWN ARE AT BOTTOM OF CURB / WALK.4. SITE GRADING TO BEGIN AUGUST 1, 2016 AND BE COMPLETED BY NOVEMBER 1, 2016

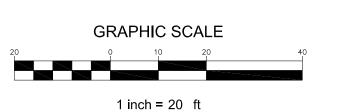

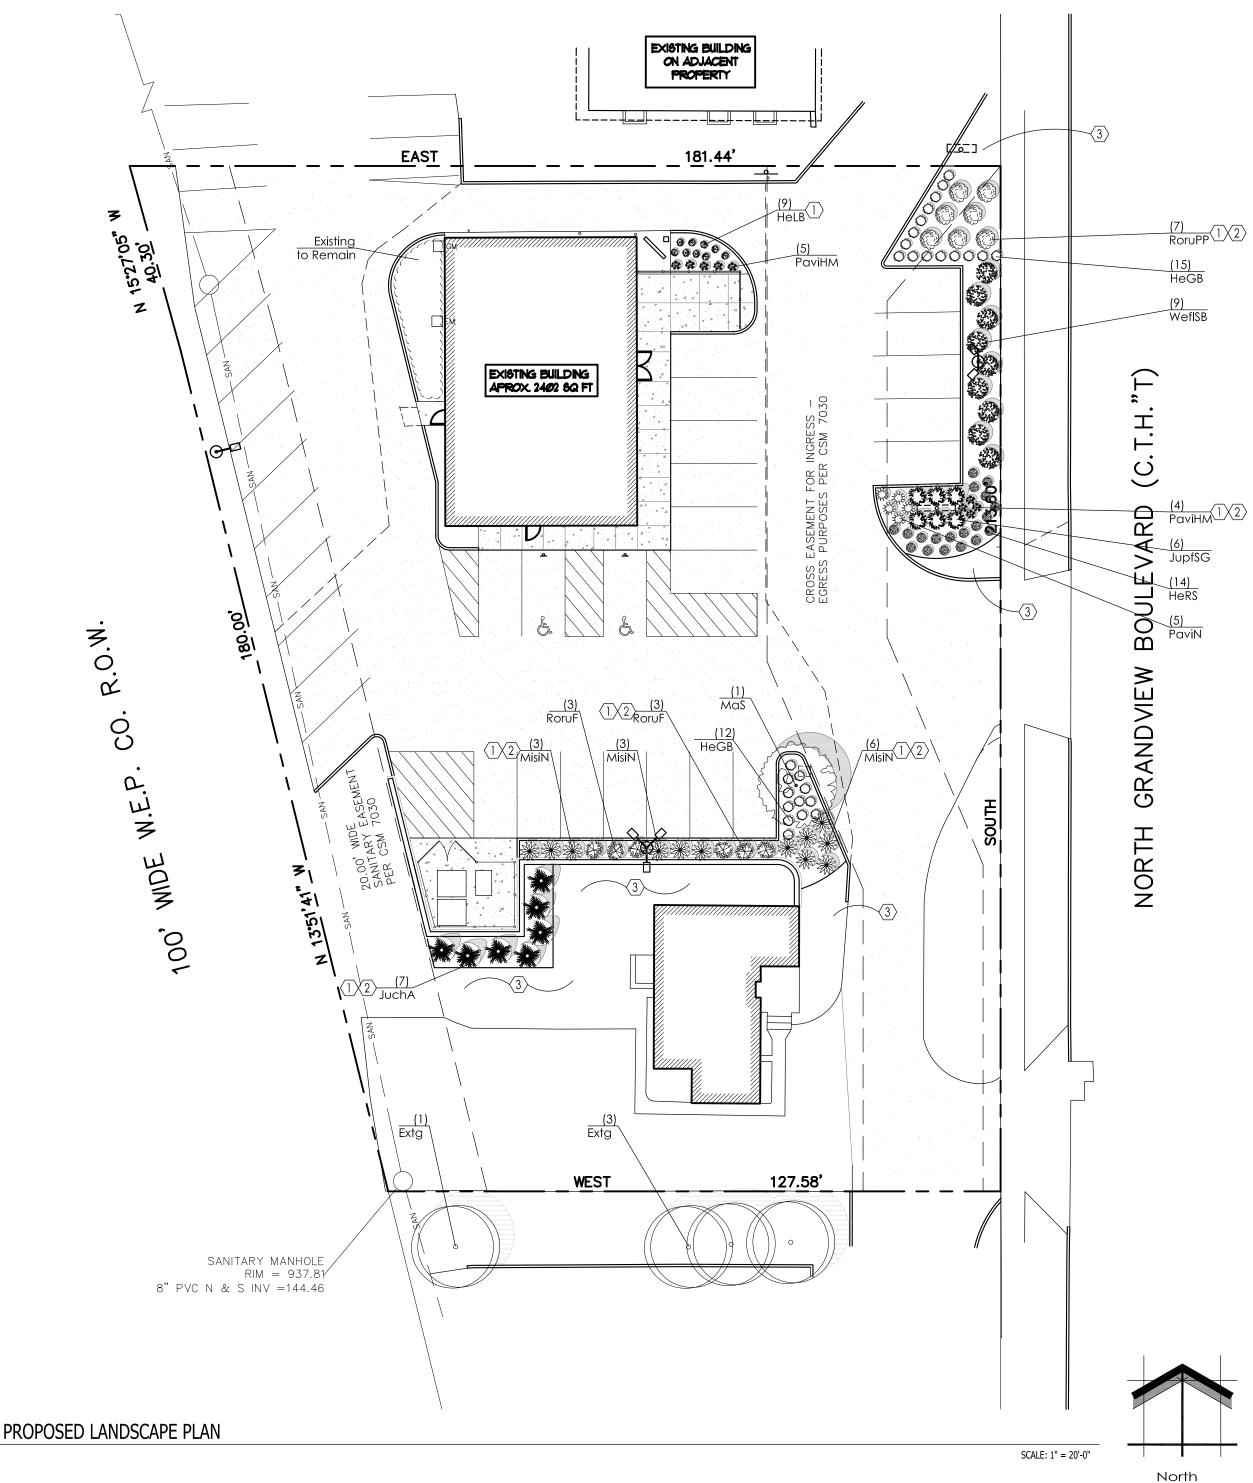

<u>Proposed Plant Material Table</u>

Broadleaf Deciduous Tree	

HeLB

HeRS

Broadleaf De	eciduous Tree					
Quantity	Code Name	Symbol	Scientific Name	Common Name	Planting Size	Comments
1	MaS	0	Malus x 'Snowdrift'	Snowdrift Crabapple	2"-Cal - B&B	
4	Extg	0	Existing	Existing	Existing	
Conifer Ever	green Tree					
Quantity	Code Name	Symbol	Scientific Name	Common Name	Planting Size	Comments
7	JuchA	*	Juniperus chinensis 'Ames'	Ames Juniper	6' - 7' - B&B	
Broadleaf De	eciduous Shrub					
Quantity	Code Name	Symbol	Scientific Name	Common Name	Planting Size	Comments
6	RoruF	E	Rosa rugosa 'Foxi'	Foxi Pavement Rose	18" - Cont	
7	RoruPP		Rosa rugosa 'Purple Pavement'	Purple Pavement Rose	18" - 24"- Cont	
9	WefISB		Weigela florida 'Bokrasopin'	Sonic Bloom Pink Reblooming Weigela	18" - Cont	
Conifer Ever	green Shrub	•		·	•	•
Quantity	Code Name	Symbol	Scientific Name	Common Name	Planting Size	Comments
6	JupfSG	A. S.	Juniperus x pfizeriana 'MonSan'	Sea of Gold Juniper	18" - 24" - B&B	
Perennial Gr	ass			·	,	'
Quantity	Code Name	Symbol	Scientific Name	Common Name	Planting Size	Comments
12	MisiN	*	Miscanthus sinensis 'Nippon'	Nippon Maiden Grass	1-Gal - Cont	
9	PaviHM	**	Panicum virgatum 'Heavy Metal'	Blue Switch Grass	1-Gal - Cont	
5	PaviN	ZW.	Panicum virgatum 'Northwind'	Northwind Switch Grass	1-Gal - Cont	
Perennial						
Quantity	Code Name	Symbol	Scientific Name	Common Name	Planting Size	Comments

Going Bananas Daylily

Ruby Spider Daylily

Little Business Dwarf Daylily

Hemerocallis x 'Going Bananas'

Hemerocallis x 'Little Business'

Hemerocallis x 'Ruby Spider'

4 1/2" pot

4 1/2" pot

4 1/2" pot

CODED NOTES

LANDSCAPE / SITE DEMOLITION CONTRACTOR TO VERIFY LOCATIONS OF EXISTING TREES TO BE

SALVAGED AND CLEARLY TAG THEM WITH MARKING TAPE AND CONSTRUCTION FENCE.

LANDSCAPE INSTALLATION CONTRACTOR TO COORDINATE INSTALLATION OF NEW PLANT MATERIAL AND THE COORDINATION WITH EXISTING TREES TO BE SALVAGED.


- MULCH BED AREA. DRESS WITH 2"-3" OF SHREDDED HARDWOOD BARK MULCH ON TOP OF DEWITT PRO 3 OZ WEED BARRIERWITH WEED BARRIER. TAKE CARE WITH INSTALLATION NOT TO DAMAGE OR COVER PLANTS. REFER TO GENERAL NOTES AND SPECIFICATIONS FOR FURTHER INFORMATION.
- (2) EARTHEN BED EDGE (SHOVEL POINT) LANDSCAPE EDGE. TYPICAL ALL PLANT MATERIAL AREAS. DRESS WITH 2"-3" OF SHREDDED HARDWOOD BARK MULCH (OR BROWN ENVIRO-MULCH. REFER TO GENERAL NOTES AND SPECIFICATIONS FOR FURTHER INFORMATION.
- $\langle \overline{3} \rangle$ Seeded areas of turf grass. Repair any and all turf damage from the CONSTRUCTION PROCESS. IT IS VERY IMPORTANT TO FOLLOW THE MANUFACTURERS INSTALLATION INSTRUCTIONS REGARDING THE TURF GRASS FOR PROPER GERMINATION AND SURVIVABILITY OF THE SEED MIX. ALSO REFER TO GENERAL NOTES FOR PREPARATION OF TOP SOIL AND SEED INSTALLATION. REFER TO GRADING PLAN FOR FURTHER INFORMATION. ALSO REFER TO GENERAL NOTES AND SPECIFICATIONS FOR FURTHER INFORMATION.

LANDSCAPE PLAN GENERAL NOTES

- * * PLANT MATERIAL SHOWN ON LANDSCAPE PLAN IS DEPICTED AT MATURE GROWTH. * *
- 1. AT LEAST SEVENTY-TWO HOURS PRIOR TO ANY EXCAVATION, CONTRACTOR SHALL VERIFY UTILITY LOCATIONS AS GIVEN BY THE ELECTRIC, GAS, TELEPHONE, WATER, SEWER, AND CABLE TELEVISION COMPANIES, UTILITIES OR ENTITIES. REVIEW WITH OWNER'S REPRESENTATIVE SITE MECHANICAL, SITE ELECTRICAL AND LIGHTING, SITE GRADING AND DRAINAGE, SITE IRRIGATION AND ALL OTHER DRAWINGS PERTAINING TO UNDERGROUND UTILITY LOCATIONS. RECORD SET OF INFORMATION THE SAME AS IN POSSESSION OF OWNER'S REPRESENTATIVE. ALSO REVIEW OWNER'S "MARK SETS" OF ALL OF THESE DRAWINGS IN POSSESSION OF THE CONTRACTOR OR OWNER. MARK ALL SUCH UTILITIES ON THE SITE PRIOR TO COMMENCING. COORDINATE WITH OWNER BEFORE AND DURING CONSTRUCTION. REPAIR ANY DAMAGE TO ANY SYSTEM THAT IS CAUSED BY LANDSCAPE CONTRACTOR AT NO COST TO OWNER.
- all plantings shall comply with standards as described in american standard of nursery
- DEVIATIONS FROM THESE PLANS SHALL BE NOTED ON THE RECORD DRAWING BY THE CONTRACTOR AND ONLY WITH PRIOR APPROVAL OF THE LANDSCAPE ARCHITECT AND OWNER'S REPRESENTATIVE. VERBAL AGREEMENTS OR REVISIONS WITHOUT A CHANGE ORDER WILL NOT BE RECOGNIZED BY LANDSCAPE
- ALL PLANTS MUST BE BID AND SELECTED PER THE SPECIES SPECIFIED ON THE PLANS. THE SIZES OF PLANT MATERIAL LISTED HEREIN IS A MINIMUM ACCEPTABLE SIZE. ADDITIONALLY, IF EXCESSIVE PRUNING REDUCES THE CROWN THE PLANT SHALL BE REPLACED.
- PROTECT PUBLIC FROM CONSTRUCTION WITH BARRIERS AND BARRICADES.
- ALL AREAS THAT WERE DISTURBED DURING CONSTRUCTION AND AREAS NOT COVERED WITH PAVEMENT, BUILDING, PLANTING BEDS, OR TREE PITS ARE TO BE TOPSOILED 6" DEEP (MIN.) AND SHALL BE SODDED/SEEDED WITH SPECIFIED LAWN GRASS. LANDSCAPE CONTRACTOR SHALL INCLUDE COST PER SQUARE YARD FOR ADDITIONAL SEED OPERATIONS AS MAY BE POSSIBLY REQUIRED TO REESTABLISH ADJACENT TURF GRASS AREAS WHICH MAY BECOME DAMAGED DURING THE CONSTRUCTION PROCESS OR TO REPAIR DAMAGE DONE BY OTHERS.
- CONTRACTOR IS RESPONSIBLE FOR FURNISHING ALL MATERIALS, TOOLS, EQUIPMENT, LABOR, AND PLANTS NECESSARY FOR PROPER PLANTING AND INSTALLATION OF ALL LANDSCAPE MATERIAL.
- QUANTITIES ON PLANT MATERIALS LIST ARE FOR CONVENIENCE OF BIDDING ONLY. CONTRACTOR IS RESPONSIBLE FOR ALL PLANTS SHOWN ON LANDSCAPE PLANS AND COVERAGE OF ALL AREAS DELINEATED. THE PLANS ARE TO SUPERSEDE THE PLANT LIST IN ALL CASES.
- CONTRACTOR IS RESPONSIBLE FOR ALL ESTIMATING AND BIDDING, ALL AREAS, QUANTITIES MATERIALS SHOULD BE FIELD VERIFIED WITH SITE CONDITIONS.
- 10. WHERE DISCREPANCIES OCCUR BETWEEN THE LANDSCAPE PLANS AND/OR ARCHITECTURAL AND/OR THE CIVIL DRAWINGS (AND ANY OTHER SITE DRAWINGS) THE DISCREPANCIES MUST BE BROUGHT TO THE LANDSCAPE ARCHITECTS ATTENTION FOR COORDINATION AND RESOLUTION.
- 11. ALL DISEASED, NOXIOUS OR INAPPROPRIATE MATERIALS SHALL BE REMOVED FROM THE PROPOSED SITE PRIOR TO THE START OF CONSTRUCTION AND DURING THE MAINTENANCE PERIOD.
- 12. GENERAL CONTRACTOR SHALL LEAVE THE SITE FREE OF CONSTRUCTION DEBRIS.
- 13. ALL LAWN AND PLANTING AREAS SHALL SLOPE TO DRAIN A MINIMUM OF 2% UNLESS NOTED OTHERWISE AND REVIEWED WITH OWNER'S REPRESENTATIVE FOR FINAL APPROVAL.
- 14. FINISH GRADES FOR SHRUB AND GROUND COVER AREAS SHALL BE HELD 1" BELOW TOP OF ADJACENT PAVEMENTS AND CURBS, UNLESS NOTED OTHERWISE ON THE PLANS. REFER TO LSP1.2 FOR FURTHER
- 15. ALL PERENNIAL, ANNUAL AND GROUND COVER AREAS TO RECEIVE A BLEND OF ORGANIC SOIL AMENDMENTS PRIOR TO PLANTING. TILL THE FOLLOWING MATERIALS INTO EXISTING TOPSOIL TO A DEPTH OF APPROXIMATELY 8". A DEPTH OF 12" IN TREE PITS. PROPORTIONS AND QUANTITIES MAY REQUIRE ADJUSTMENT DEPENDING ON THE CONDITION OF EXISTING SOIL. REFER TO LSP1.2 FOR FURTHER INFORMATION.
 - PER EVERY 100 SQUARE FEET ADD:
 - -ONE 2 CUBIC FOOT BALE OF PEAT MOSS, -2 POUNDS OF 5-10-5 GARDEN FERTILIZER
 - -1/4 CUBIC YARD OF COMPOSTED MANURE
 - PLANT STARTER OR OTHER COMPOSTED, ORGANIC MATERIAL
- 16. ALL SHRUBS TO BE POCKET PLANTED WITH A 50/50 MIX OF PLANT STARTER AND EXISTING SOIL. INSTALL TOPSOIL INTO ALL BEDS AS NEEDED TO ACHIEVE PROPER GRADE. REMOVE ALL EXCESSIVE GRAVEL, CLAY AND STONES. REFER TO LSP1.2 FOR FURTHER INFORMATION.
- 17. PLANT ALL TREES SLIGHTLY HIGHER THAN FINISHED GRADE AT ROOT FLARE. BACK FILL HOLE WITH 2/3 EXISTING TOPSOIL AND 1/3 PEAT MOSS. AVOID ANY AIR POCKETS. DISCARD ANY GRAVEL CLAY OR
- STONES. REFER TO LSP1.2 FOR FURTHER INFORMATION. 18. ALL TREES TO BE INSTALLED, STAKED AND GUYED ACCORDING TO DETAILS. REFER TO LSP1.2 FOR
- FURTHER INFORMATION. 19. PROVIDE A 4'-0" - 5'-0" DIAMETER MULCH RING ALL LAWN TREES.
- 20. ALL PLANTINGS TO BE WATERED AT THE TIME OF PLANTING, THROUGHOUT CONSTRUCTION AND UPON
- COMPLETION OF PROJECT AS REQUIRED. WHERE SPECIFIED, ALL PLANT BEDS, PITS AND TREE RINGS ARE TO RECEIVE A MINIMUM OF 2'-3" DRESSING OF SHREDDED HARDWOOD OAK BARK MULCH SHAVINGS (OR BROWN ENVIRO-MULCH) FREE OF GROWTH, WEEDS, FOREIGN MATTER DETRIMENTAL TO PLANT LIFE OR GERMINATION INHIBITING INGREDIENTS. LANDSCAPE CONTRACTOR TO PROVIDE A SAMPLE TO OWNER FOR APPROVAL. CONTRACTOR TO TAKE CARE WITH INSTALLATION NOT TO DAMAGE OR COVER PLANTS. REFER TO LSP1.2
- FOR FURTHER INFORMATION. 22. LAWN INSTALLATION: CONTRACTOR TO FURNISH AND PREPARE TOPSOIL (3" MIN) AND SEED BED (REMOVE ALL STONES 1" OR LARGER), APPLY STARTER FERTILIZER AND SEED UNIFORMLY. PROVIDE A MULCH COVERING SUITABLE TO GERMINATE AND ESTABLISH TURF. EROSION CONTROL MESH SHOULD BE USED IN SWALES AND STEEP GRADES WHERE APPLICABLE. METHODS OF INSTALLATION MAY VARY AT THE DISCRETION OF CONTRACTOR. IT IS HIS/HER RESPONSIBILITY TO ESTABLISH AND GUARANTEE A SMOOTH,
- UNIFORM, QUALITY TURF. IF STRAW MULCH IS USED AS A COVERING, A TACKIFIER MAY BE NECESSARY TO AVOID WIND DAMAGE. 23. RECOMMENDED SEED MIX:
 - PREMIUM 60 GRASS SEED MIX REINDER'S (262) 786-3300 20% AMERICAN KENTUCKY BLUE GRASS 20% ALPINE KENTUCKY BLUE GRASS 20% LANGARA KENTUCKY BLUE GRASS 20% VICTORY CHEWINGS FESCUE 10% FIESTA III PERENNIAL RYE GRASS
 - 10% CUTTER PERENNIAL RYE GRASS APPLY AT A RATE OF 175 POUNDS PER ACRE. REFER TO SUPPLIERS SPECIFICATIONS AND
 - INSTALLATION CUT SHEETS FOR FURTHER INFORMATION
- 24. DURING THE INITIAL "30 DAY MAINTENANCE PERIOD" THE LANDSCAPE CONTRACTOR IS REQUIRED TO PROVIDE AND ON-GOING PLEASANT VISUAL ENVIRONMENT WHEREAS ANY PLANT WHICH IS NOT RESPONDING TO TRANSPLANTING OR THRIVING SHALL IMMEDIATELY BE REPLACED. NEW LAWNS SHALL WATERED AND REPAIRED AND WEEDS MUST CONSTANTLY BE REMOVED, NO EXCEPTIONS WILL BE
- LANDSCAPE / SITE DEMOLITION CONTRACTOR TO VERIFY LOCATIONS OF EXISTING TREES AND SHRUBS BE SALVAGED AND CLEARLY TAG THEM WITH MARKING TAPE AND CONSTRUCTION FENCE.
- 26. LANDSCAPE / SITE DEMOLITION CONTRACTOR TO VERIFY LOCATIONS OF EXISTING TREES AND SHRUBS TO BE RELOCATED. ALL PLANT MATERIAL TO BE RELOCATED IS TO BE CLEARLY TAGGED WITH MARKING TAPE MOVED BEFORE AND SITE DEMOLITION IS TO BEGIN.
- **OPTIONAL BID:** DESIGN IRRIGATION SYSTEM TO BE DESIGNED FOR A OVERLAPPING ZONED SPRINKLER HEAD SYSTEM IN ALL LAWN & ISLAND AREAS & A DRIP SYSTEM FOR ALL FOUNDATION PLANTING AREAS.

BEFORE SITE GRADING AND DEMOLITION IS TO BEGIN FOR PROPOSED NEW PAVEMENT, THE AREA IS TO BE STAKED AND ALL TREE AND SHRUBS THAT ARE TO BE PRESERVED ARE TO BE TAGGED BY LANDSCAPE ARCHITECT AND RELOCATED BY LANDSCAPE CONTRACTOR. IF REQUIRED A TREE PRESERVATION PLAN WILL BE PRODUCED AND COORDINATED WITH CITY STAFF. DEMOLITION CONTRACTOR TO COORDINATE W/ LANDSCAPE ARCHITECT, OWNER AND LANDSCAPE CONTRACTOR.

TO OBTAIN LOCATION OF PARTICIPANT'S UNDERGROUND FACILITIES BEFORE YOU DIG IN WISCONSIN

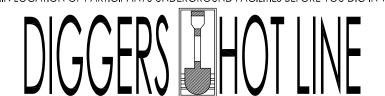

WISCONSIN STATUTE 182.0175 (1974) REQUIRES A MINIMUM OF 3 DAYS NOTICE BEFORE YOU EXCAVATE (NOT INCLUDING SATURDAY, SUNDAY OR LEGAL HOLIDAYS)

UNDERGROUND SEWER AND UTILITY INFORMATION AS SHOWN IS OBTAINED FROM THE RECORDS OF

> CERTIFIED TO. THE LOCATIONS OF EXISTING UTILITY INSTALLATIONS AS (800)-242-8511, (262) 432-7910 SHOWN ON THIS SURVEY ARE APPROXIMATE. THERE MAY BE OTHER UNDERGROUND UTILITY INSTALLATIONS WITHIN THE PROJECT AREA THAT ARE NOT SHOWN.

PARTICIPANT'S UNDERGROUND MUNICIPALITY AND LOCAL UTILITY COMPANIES. THE FACILITIES BEFORE YOU DIG IN ACCURACY OF WHICH CAN NOT BE GUARANTEED OR WISCONIN CALL THE MILWAUKEE UTILITY ALERT NETWORK (877) 500-9592

www.Diggershotline.com



NO-MOW LOW GROW GRASS SEED MIX REINDER'S

15% TRANSIT ANNUAL RYE GRASS

INSTALLATION CUT SHEETS FOR FURTHER

APPLY AT A RATE OF 175 POUNDS PER ACRE. REFER TO SUPPLIERS SPECIFICATIONS AND

45% SPARTAN HARD FESCUE

40% AZAY SHEEP FESCUE

INFORMATION

LANDSCAPE

Landscape Architecture and Master Planning Design Consulting

11525 W. North Avenue Suite 1B Wauwatosa, WI 53226 Tel (414) 476-1204 www.insitelandscape.com mdavis@insitelandscape.com

COUSINS SUBS

2260 N. Grandview Blvd Waukesha, WI 53188

Issuance and Revisions:

| Number | Description

06/21/16 Plan Commission

07/08/16

Plan Commission Submittal

Submittal

COPYRIGHT InSite Landscape Design Inc. 2014 ALL RIGHTS RESERVED THIS DRAWING IS NOT TO BE REPRODUCED, CHANGED, COPIED OR ASSIGNED TO ANY THIRD PARTY IN ANY FORM OR MANNER WITHOUT FIRST OBTAINING THE EXPRESSED WRITTEN PERMISSION OF InSite Landscape Design, Inc. THE CLIENT AGREES TO INDEMNIFY AND HOLD THE LANDSCAPE ARCHITECT HARMLESS FROM ANY DAMAGES, LIABILITY, OR COST, INCLUDING ATTORNEY'S FEES AND COSTS OF DEFENSE ARISING FROM ANY CHANGES OR ALTERATIONS

MADE BY ANYONE OTHER THAN THE LANDSCAPE ARCHITECT, OR FROM ANY REUSE OF THE DRAWINGS OR DATA WITHOUT THE PRIOR WRITTEN CONSENT OF THE LANDSCAPE ARCHITECT.


PROPOSED LANDSCAPE PLAN, GENERAL NOTES, AND PLANT MATERIAL TABLE

Date of Drawing:	07/08/16
Scale:	1" = 20'-0"
Drawn By:	MCD

L16-023

Sheet Number:

Job Number:

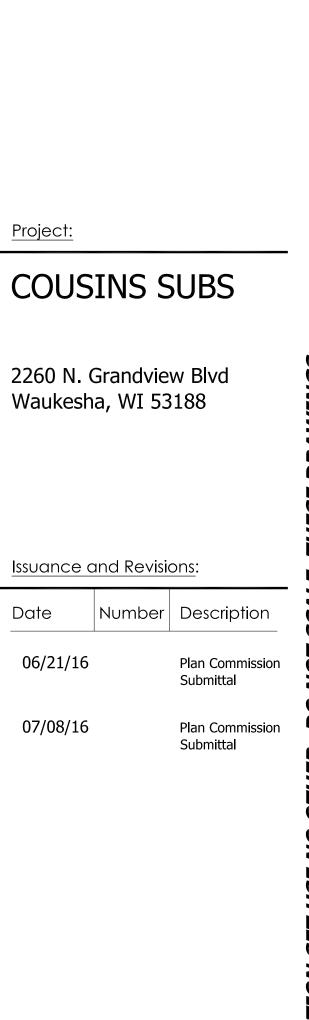

LANDSCAPE

Landscape Architecture

and Master Planning Design Consulting


11525 W. North Avenue Suite 1B

Wauwatosa, WI 53226

Tel (414) 476-1204

www.insitelandscape.com

mdavis@insitelandscape.com

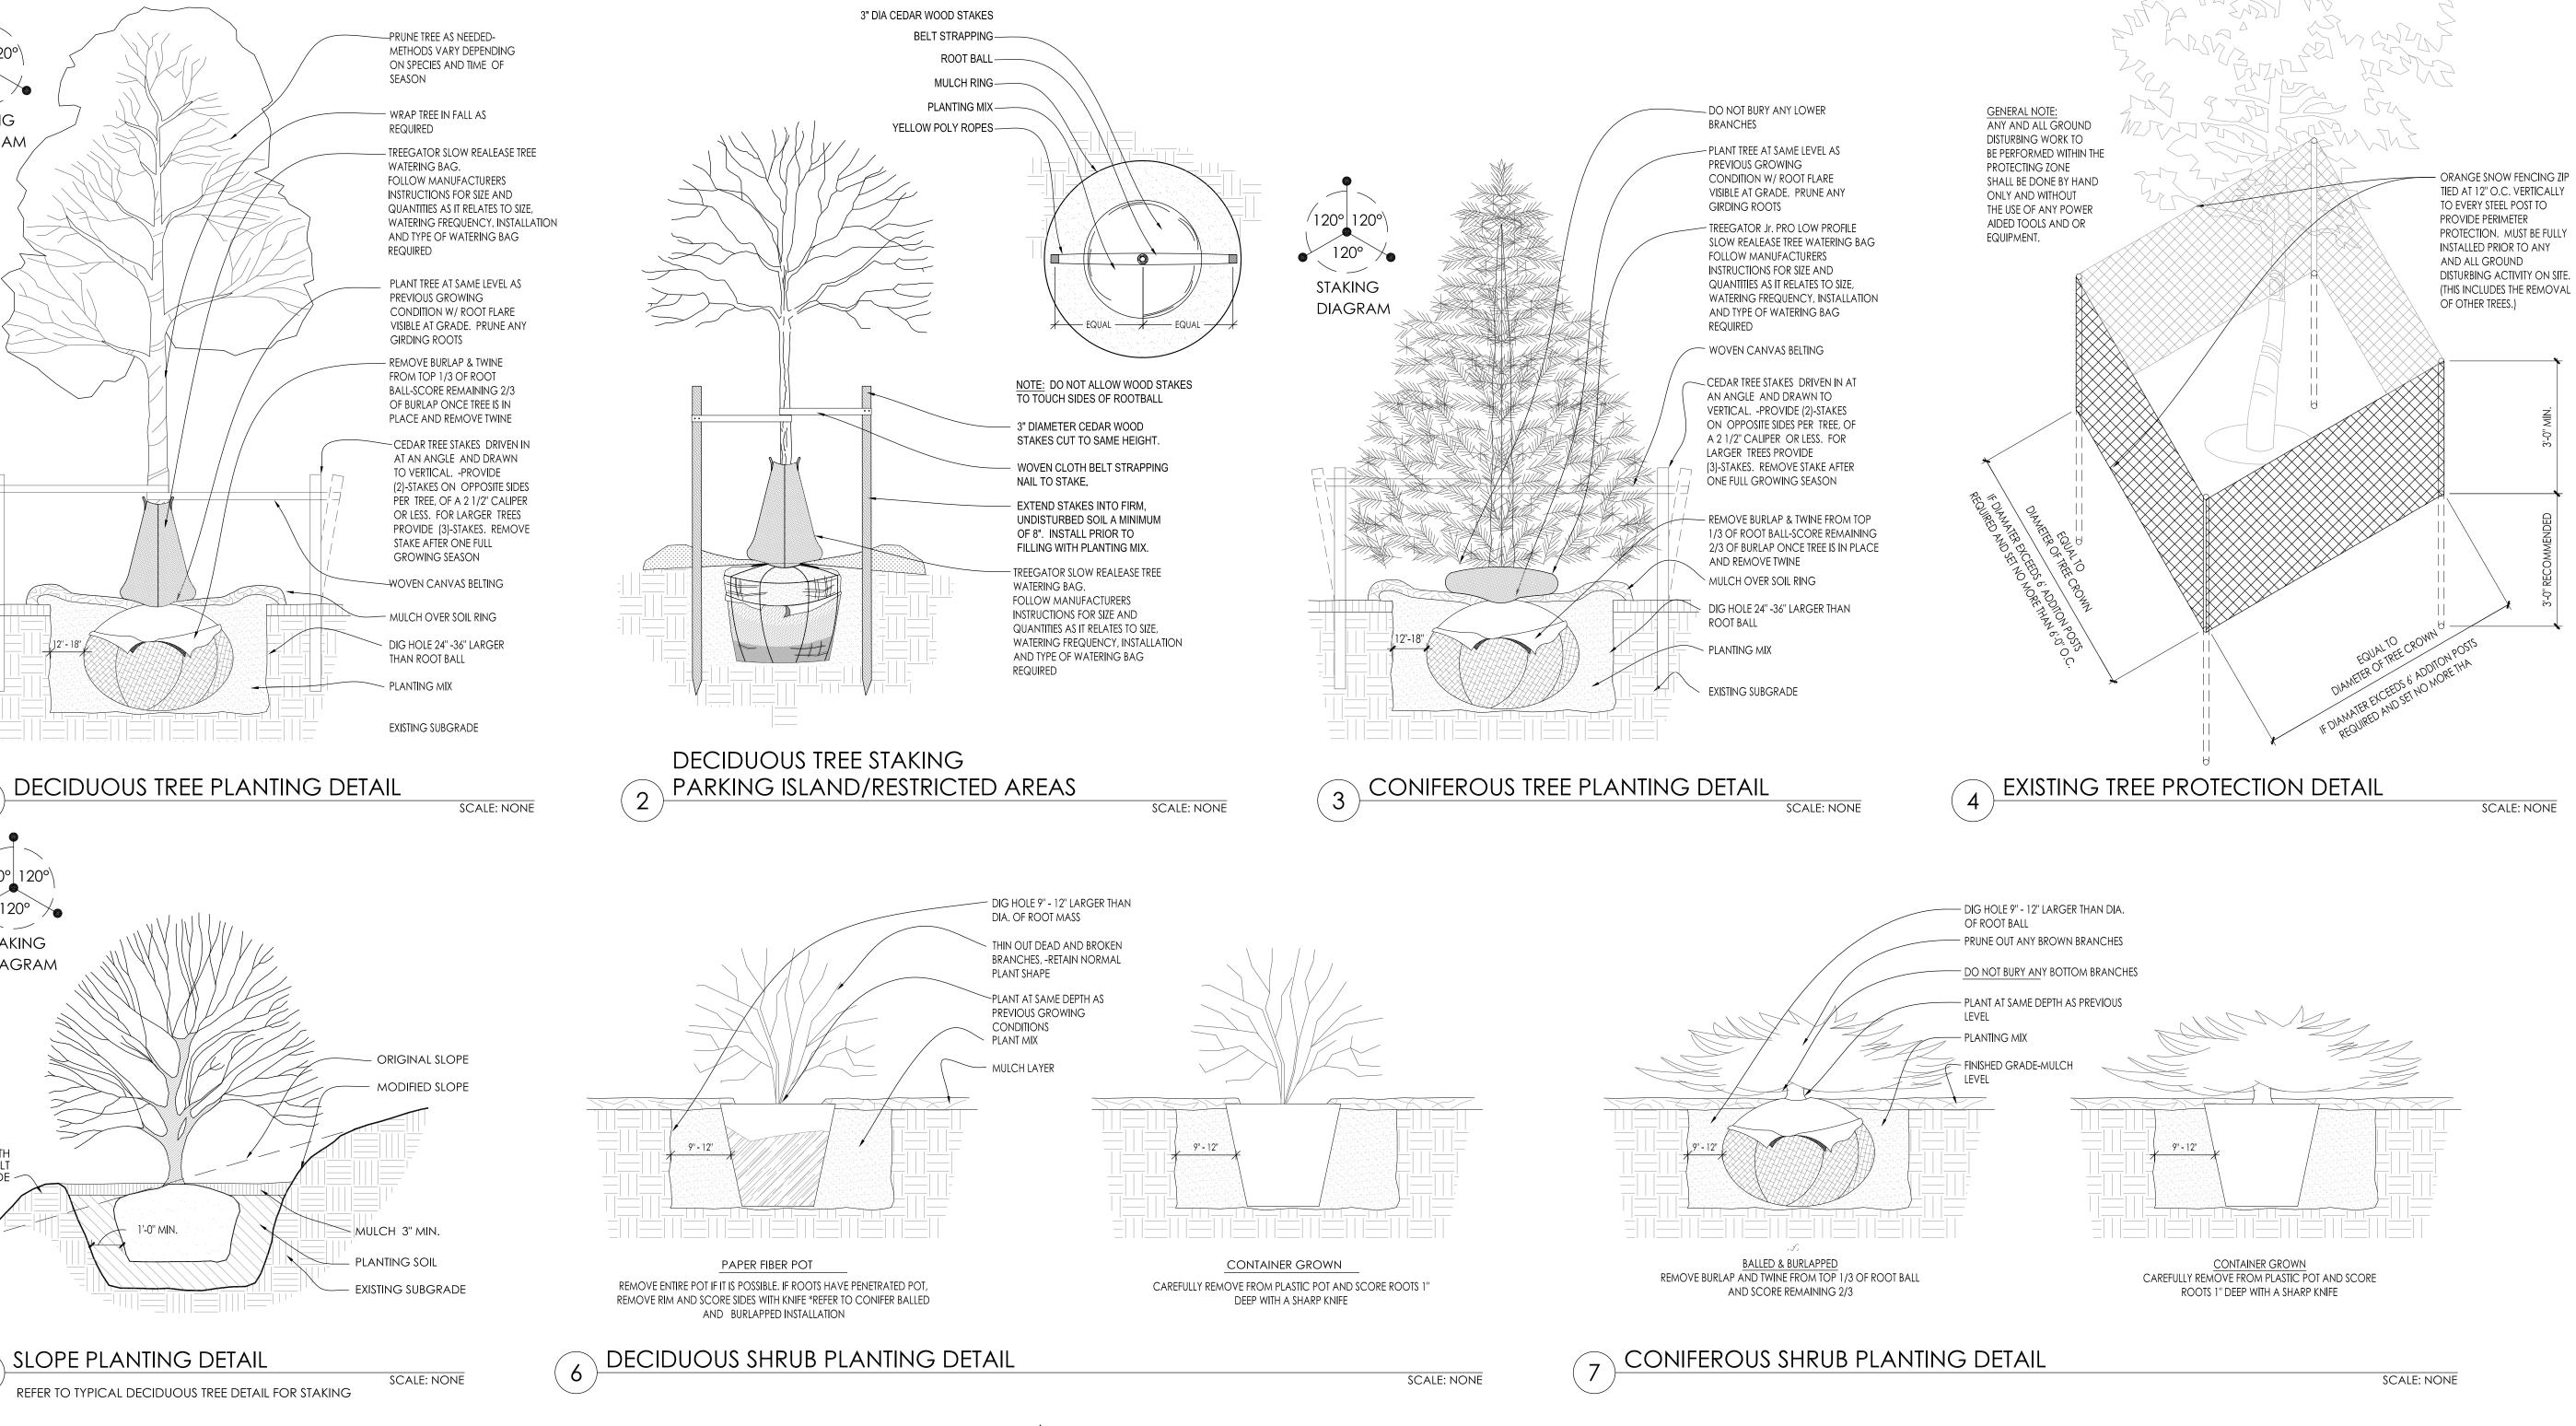

COPYRIGHT InSite Landscape Design Inc. 2014 ALL RIGHTS RESERVED THIS DRAWING IS NOT TO BE REPRODUCED, CHANGED, COPIED OR ASSIGNED TO ANY THIRD PARTY IN ANY FORM OR MANNER WITHOUT FIRST OBTAINING THE EXPRESSED WRITTEN PERMISSION OF InSite Landscape Design, Inc. THE CLIENT AGREES TO INDEMNIFY AND HOLD THE LANDSCAPE ARCHITECT HARMLESS FROM ANY DAMAGES, LIABILITY, OR COST, INCLUDING ATTORNEY'S FEES AND COSTS OF DEFENSE ARISING FROM ANY CHANGES OR ALTERATIONS MADE BY ANYONE OTHER THAN THE LANDSCAPE ARCHITECT, OR FROM ANY REUSE OF THE DRAWINGS OR DATA WITHOUT THE PRIOR WRITTEN CONSENT OF THE LANDSCAPE ARCHITECT.

Sheet Title:


06/21/16

07/08/16

PROPOSED LANDSCAPE PLAN, PLANTING DETAILS

Date of Drawing:	0=100116
	07/08/16
Scale:	A N. I. I.
	As Noted
Drawn By:	N.4.0.D
•	MCD
Job Number:	
	L16-023
Shoot Number	

Sheet Number:

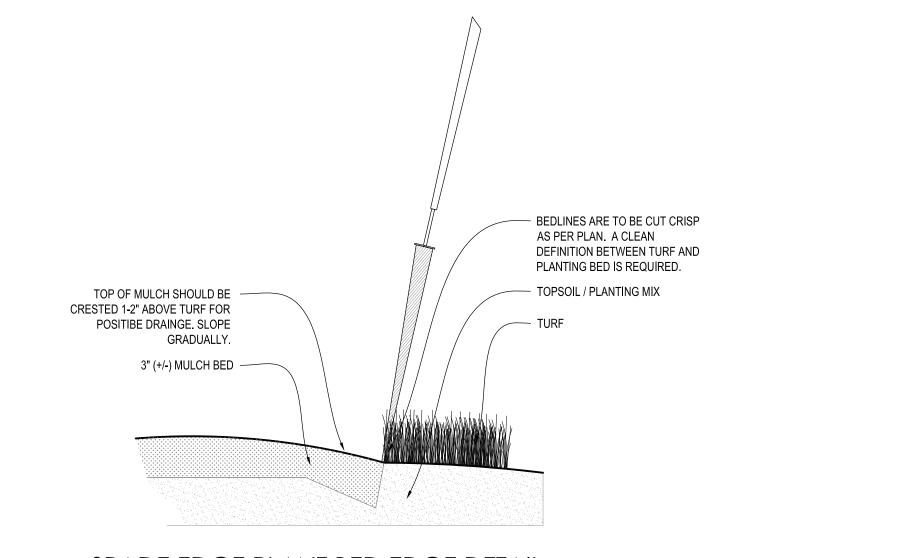

SCALE: NONE

PERENNIAL BED PLANTING DETAIL

VARIES W/ BEDS REFER TO PLANS

(120° /

STAKING

DIAGRAM

Staking

DIAGRAM

4" TALL EARTH SAUCER BUILT ON LOW SIDE -

PERIMETER OF BUILDING

PERENNIALS AND/OR

PERENNIAL GRASSES

SHREDDED HARDWOOD BARK MULCH ____

SPADE EDGE EARTHEN

BED EDGE STANDARD -

TURF GRASS


12" MINIMUM OF


UNDISTURBED EARTH

PLANTING SOIL MIX

9 SPADE EDGE PLANT BED EDGE DETAIL

SCALE: NONE

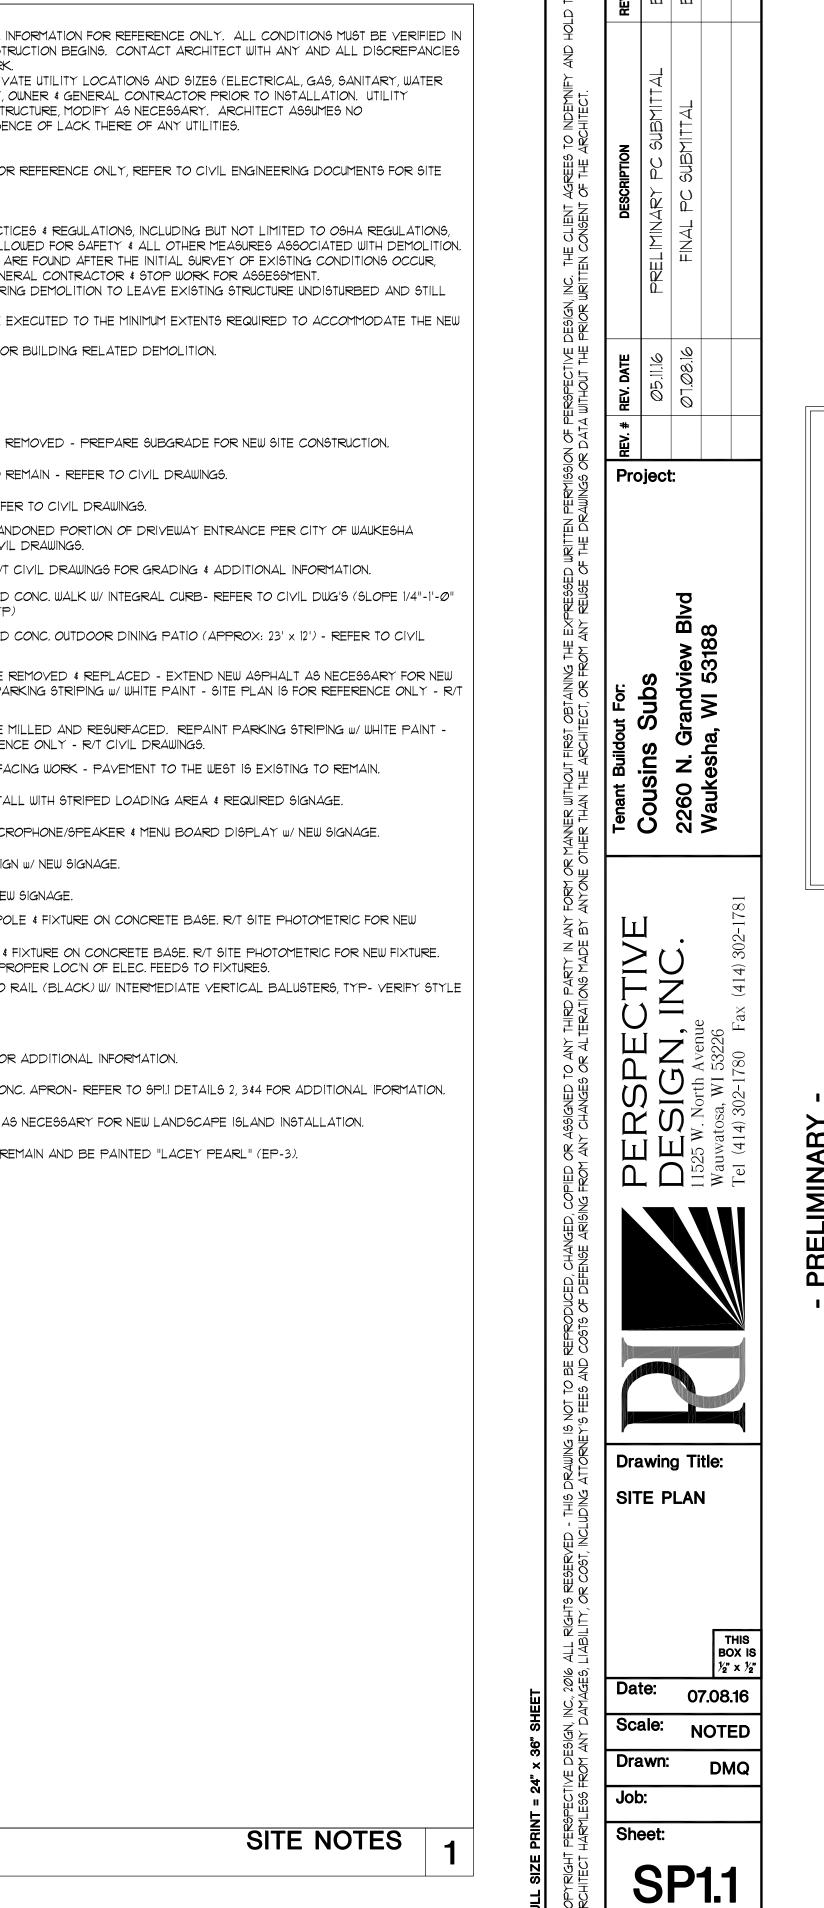

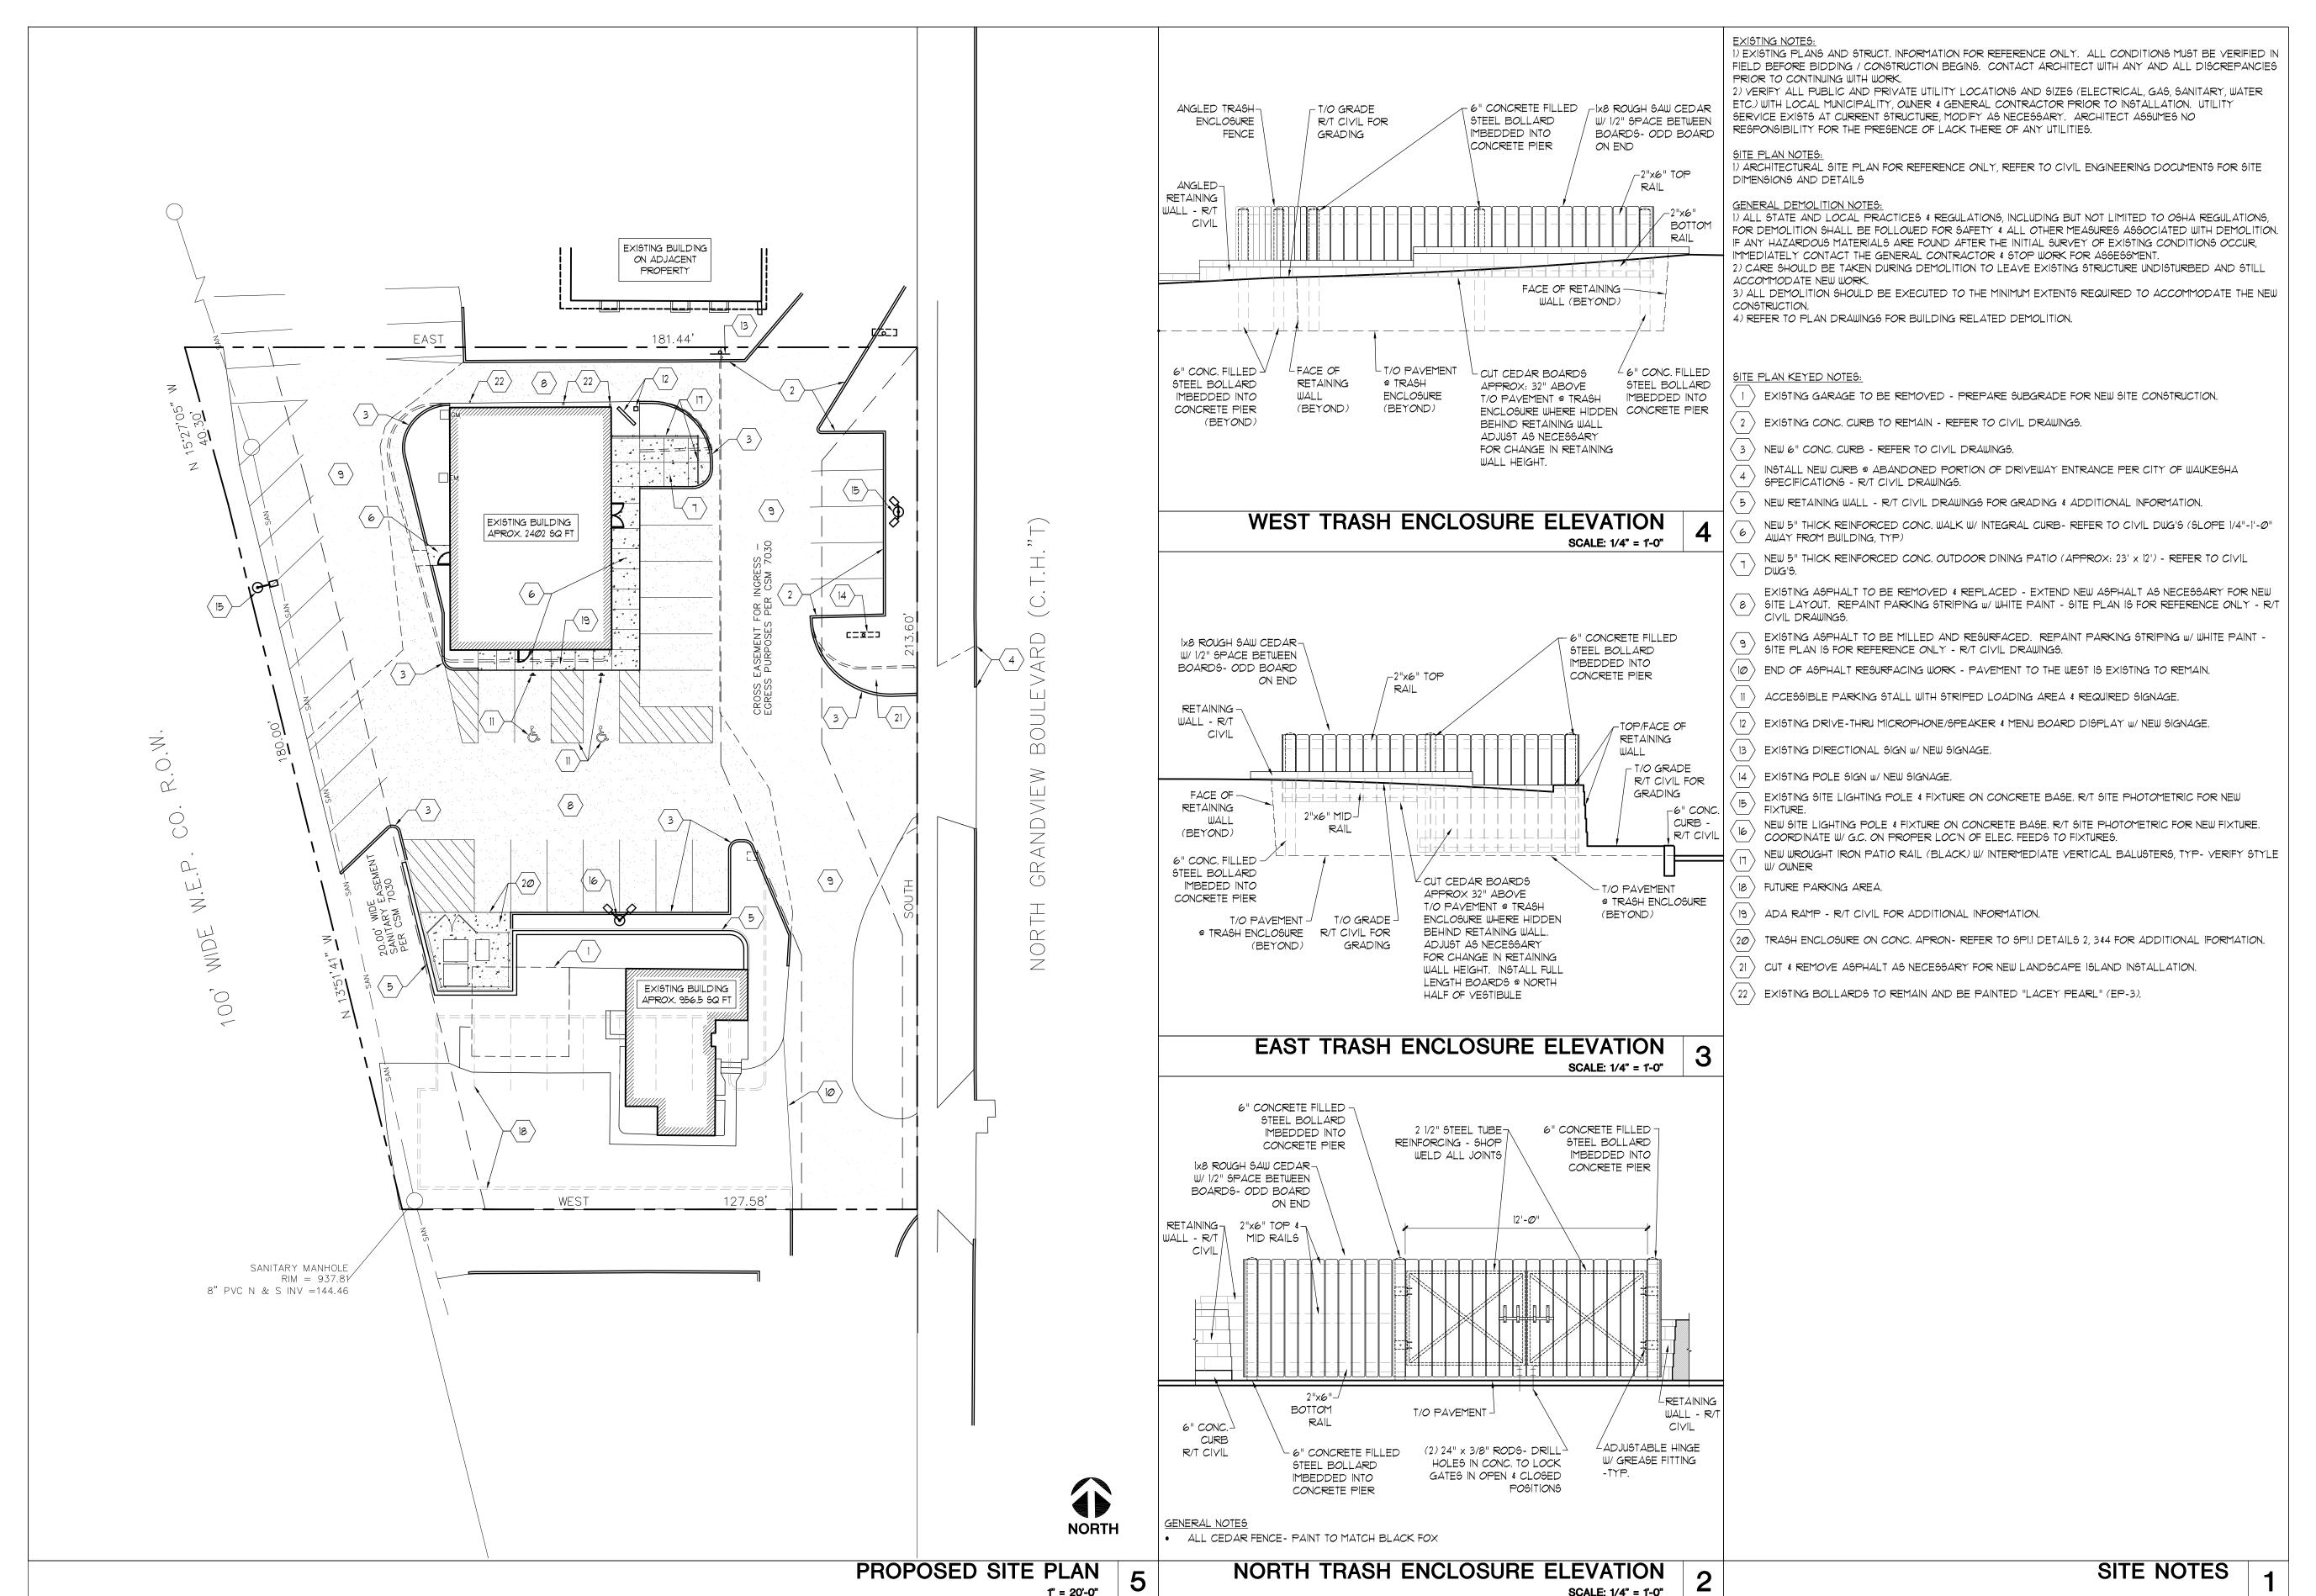

1" = 20'-0"

SCALE: 1/4" = 1'-0"

LUMINAIRE SCHEDULE i47.345;EXISTING Description Symbol Label Qty Catalog Number i78.811;0N ADJACENT XGBM-3-LED-SS-LED fixture-Super Saver wattage SS-NW-LED Area Light Pole mounted at 22' HSS.ies Model XGBM Type 3 Optics w/ House Side Shield XGBM-FT-LED-XGBM-FT-LED-SS-LSI Industries LED fixture-Super Saver wattage B 1 NW-HSS Absolute 1.00 SS-NW-LED Area Light Pole mounted at 22' = PERSPECTIVE DESIGN, I ,TA WITHOUT THE PRIOR W Forward Throw Optics w/ House Side Shield HSS.ies Model XGBM 0.3 XGBM-5-LED-XGBM-5-LED-SS-LED fixture-Super Saver wattage LSI Industries C 1 NW SS-NW.IES Absolute 1.00 188.5 LED Area Light Pole mounted at 22' Model XGBM Type 5 Optics XGBM-FT-LED-SS-NW-ies Absolute 1.00 189 XGBM-FT-LED-SS-LSI Industries LED fixture-Super Saver wattage ₹0.0 D 2 NW LED Area Light Pole mounted at 22' Model XGBM Forward Throw Optics √0.4 [†]2.7 [†]4.2 [†]3.1 3.4 ⁺1.5 2.3 0.0 ⁺3.9 *3.0 /2 0.4 EXIOSTING DAULDING 0.8 APROX. 24 3.2 0.7 5.7 6.4 2.8 3.8 [†]2.2 [†]2.7 2.5 1.4 [†]1.5 [†]1.5 [†]1.9 3.2 2.9 1.3 \ 1.5 1.5 1.8 1.8 2.4 2.7 2.8 2.4 PARTY IN ANY FORM OR N ONS MADE BY ANYONE OT ⁺1.3 1.9 1.8 1.5 0.4 **2.3 2.9 3.8 4.5 3.5 2.8 2.3** [†]1.7 [†]1.6 [†]1.3
 0.0
 0.0
 0.1
 0.1
 [†]1.2 [†]1.5 0.3 6.6 ∕5 ⁺4.5 WEST Plan View Scale 1" = 16' NORTH PHOTOMETRIC SITE PLAN 1" = 16'

Drawing Title:

CTIO STRU Z

Project:

TIVE VC.

PHOTOMETRIC SITE PLAN

Date: 07.08.16

PSP1.1

Scale:

Drawn:

Sheet:

Job:

THIS BOX IS 1/2" x 1/2"

NOTED

DMQ

Drawing Title: PROPOSED FLOOR PLAN

Job:

Sheet:

A1.1

PROPOSED FLOOR PLAN
SCALE: 1/4" = 1'-0"


CONSTRUCTION



THIS BOX IS 1/2" x 1/2"

NOTED

CONSTRUCTION

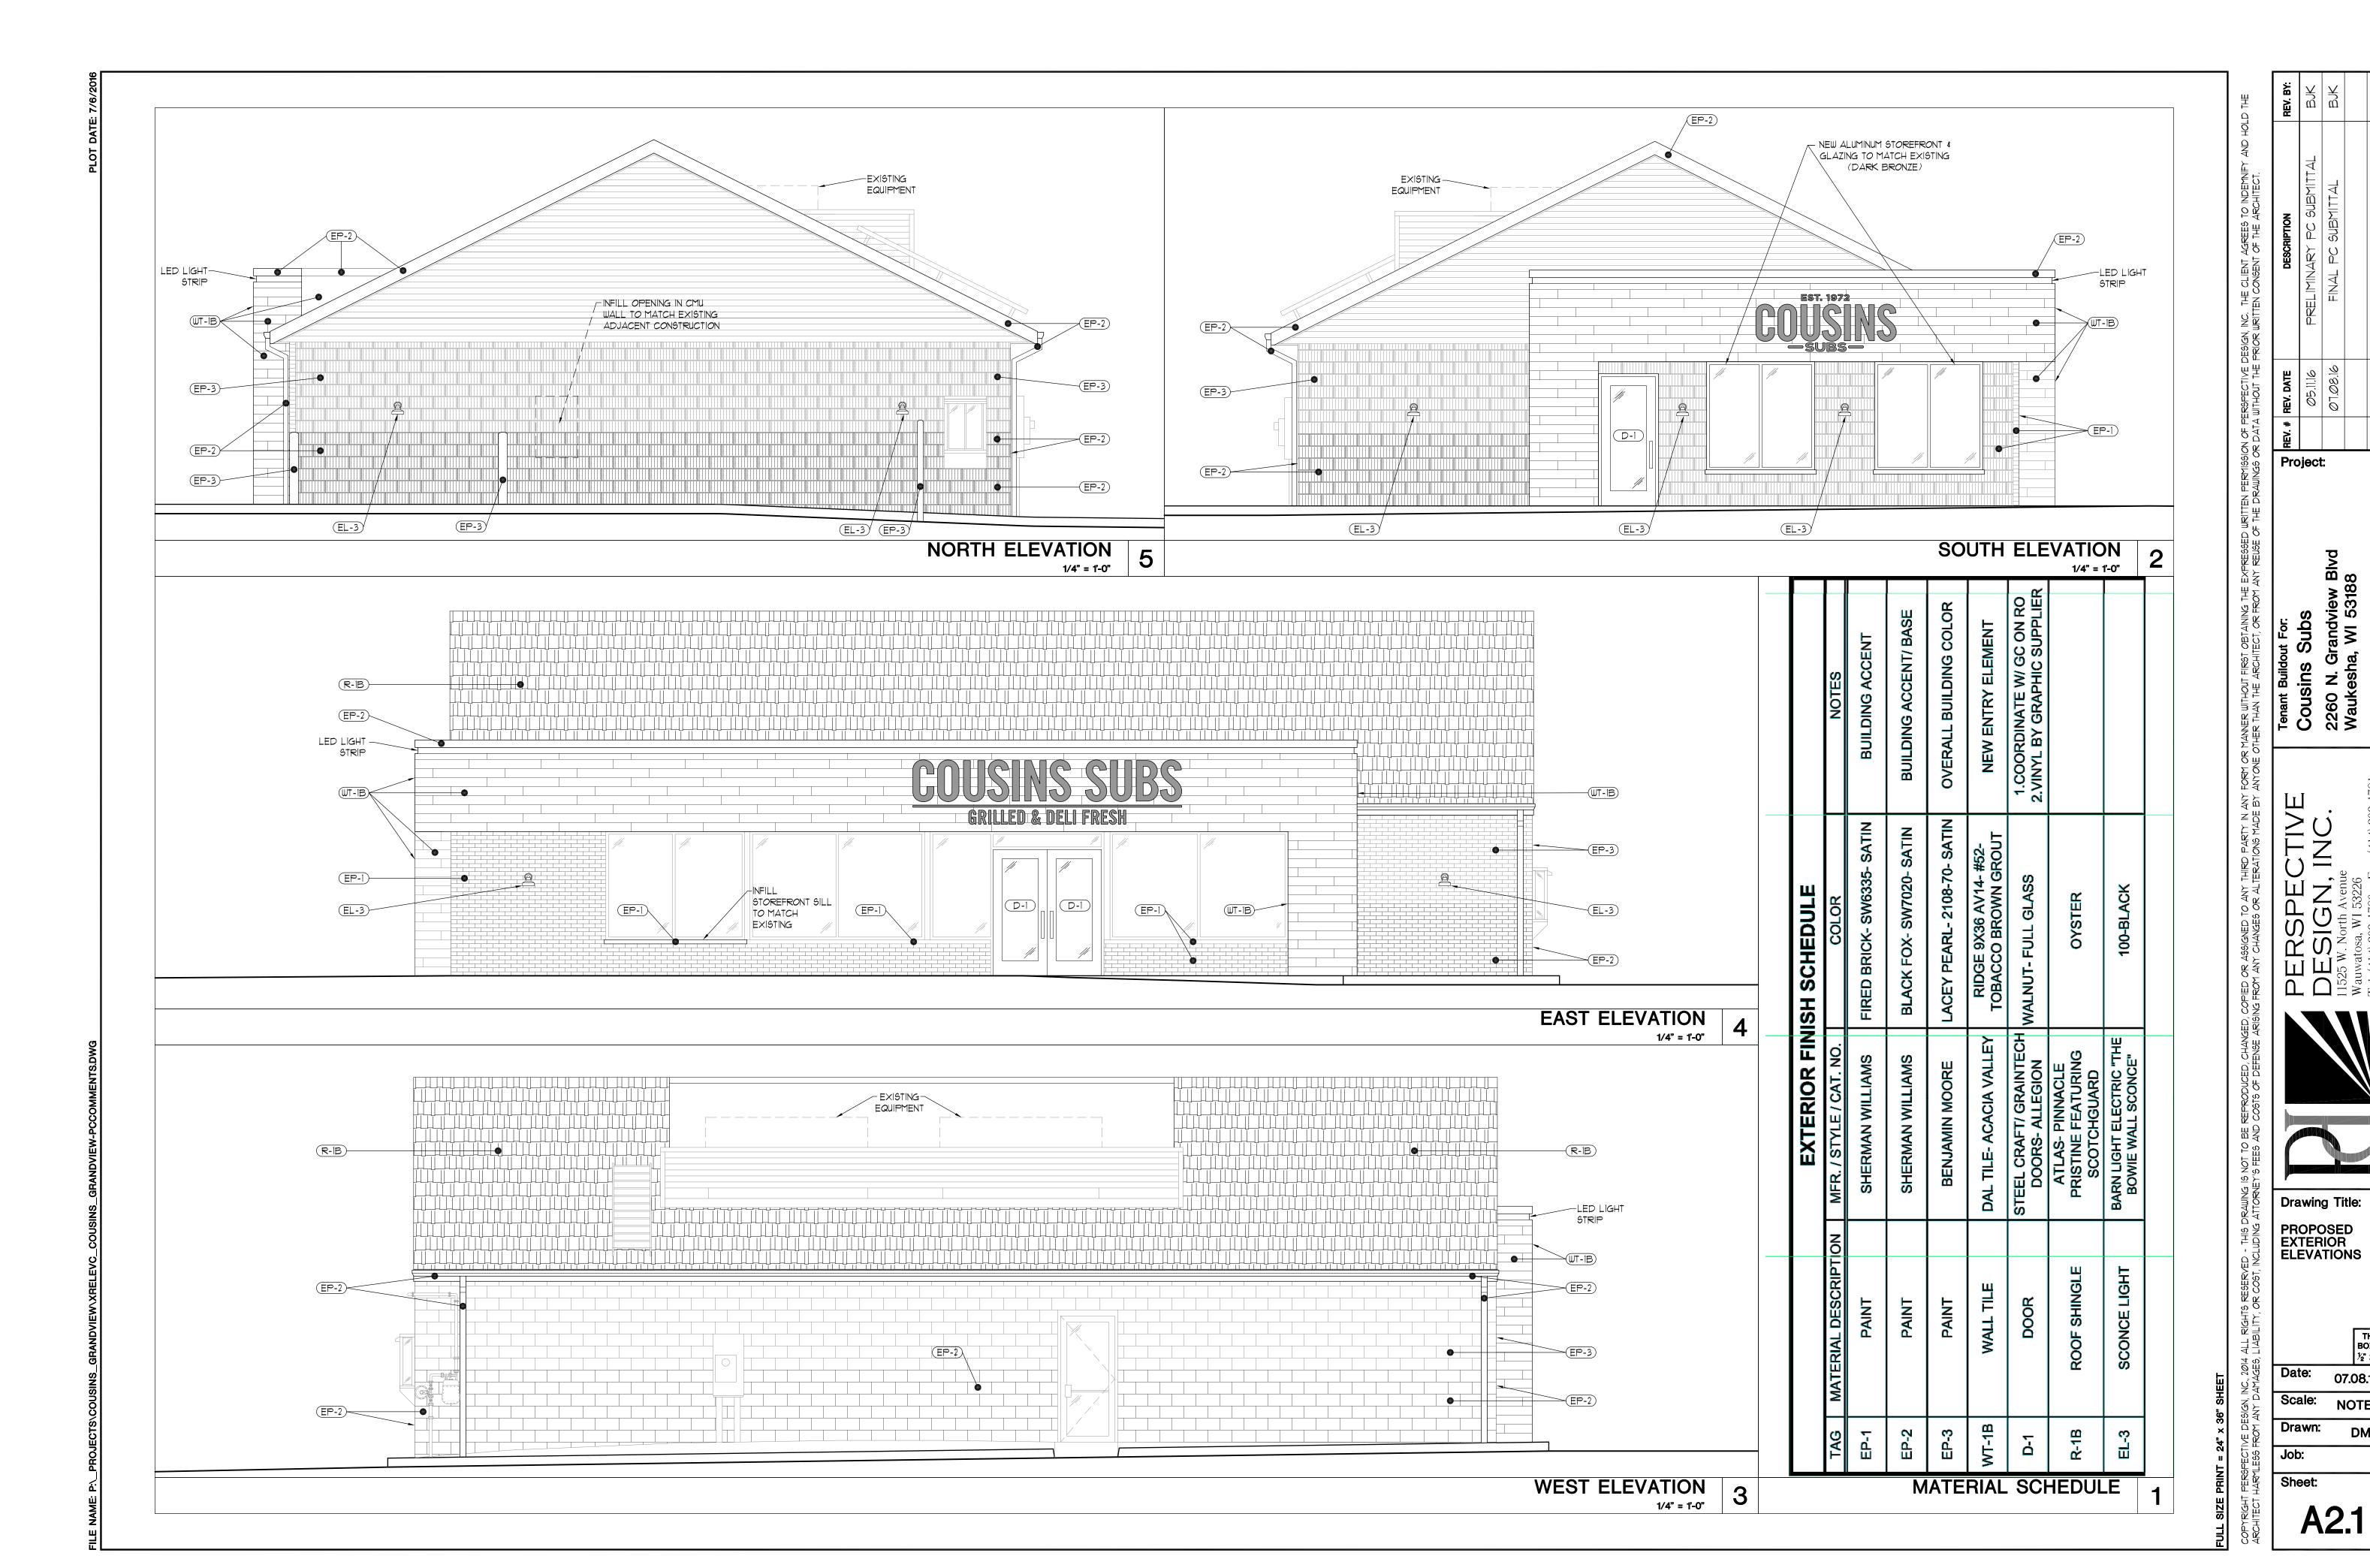

THIS BOX IS 1/2" x 1/2"

CONSTRUCTION



COUSINS SUBS SOUTH ELEVATION SCALE: 1/4"=1-0" NORTH ELEVATION SCALE: 1/4"=1"-0" COUSINS SUBS
GRILLED & DELI FRESH EAST ELEVATION SCALE: 1/4"=1-0"

WEST ELEVATION SCALE: 1/4"=1-0"