


Project: Tenant Buildou Cousins (2260 N. Gl Waukesha, T THIRD PARTY IN ANY FORM OR M
LTERATIONS MADE BY ANYONE OTH
LINCTINE
LINCT Drawing Title: PHOTOMETRIC SITE PLAN (PHASE 2) Scale: Drawn: Job: 15-064 / 15-065 Sheet:

THIS BOX IS 1/2" x 1/2"

08.31.16

NOTED

DNG

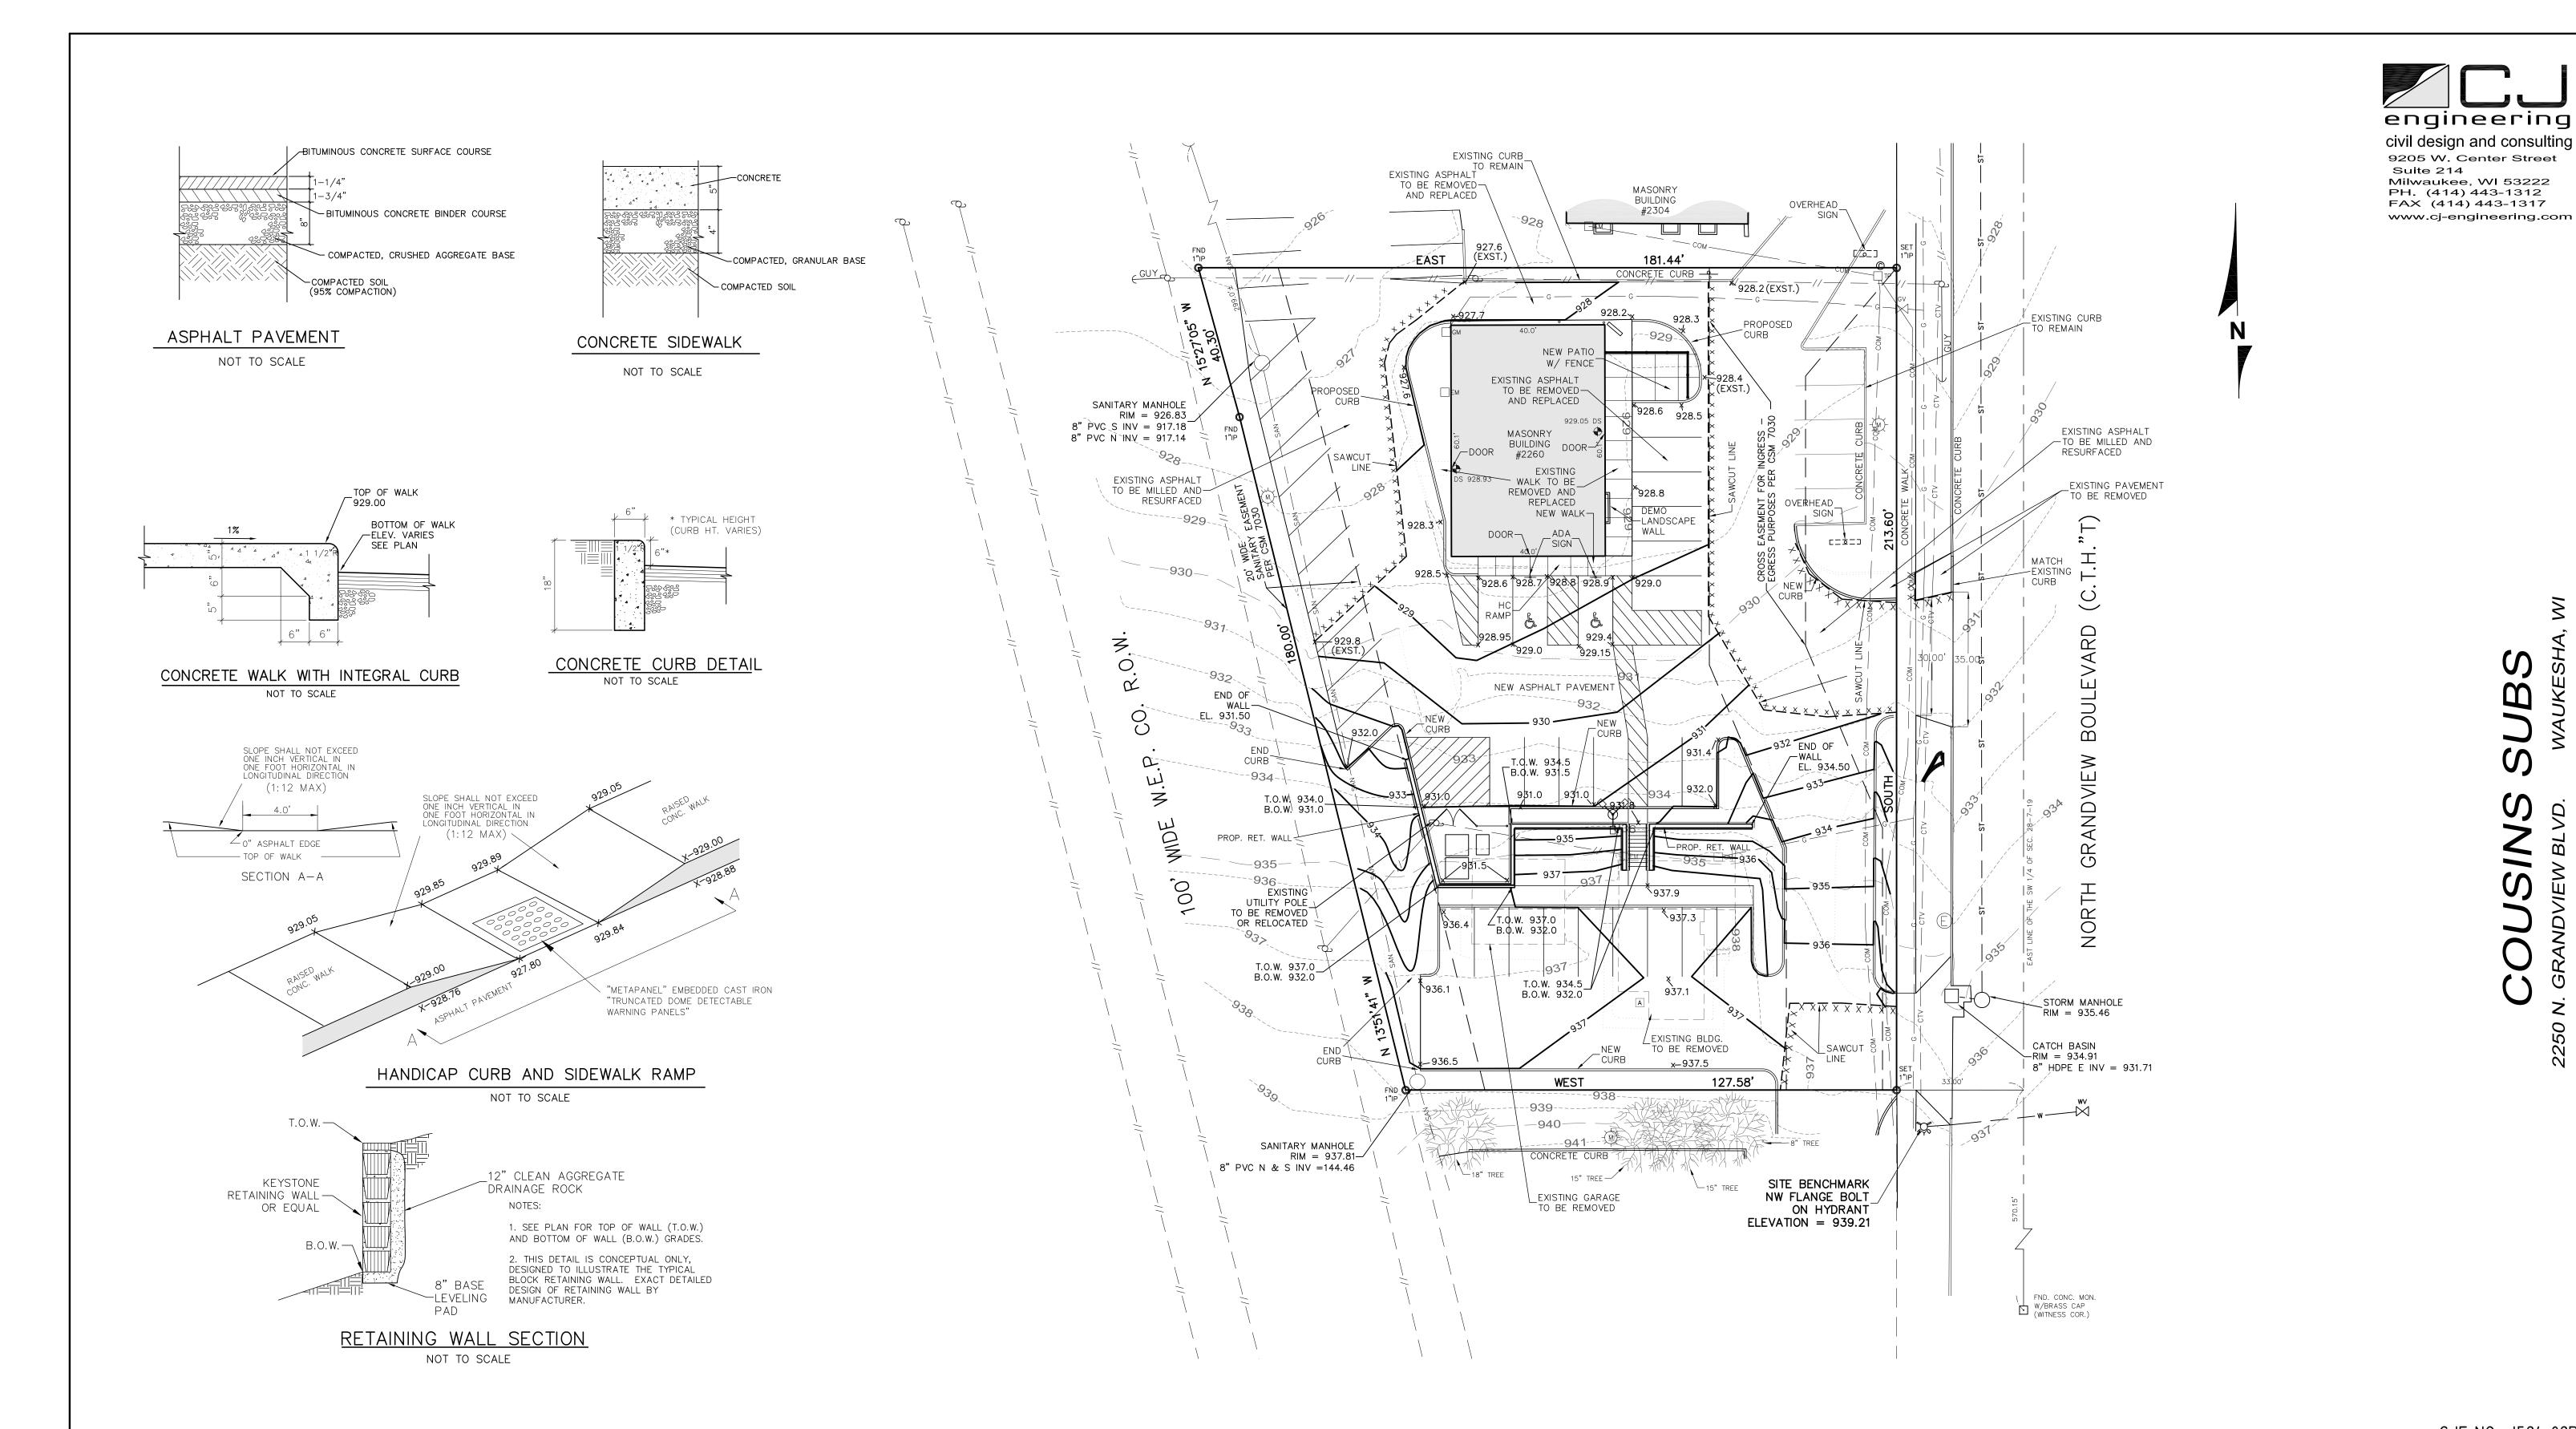

CJE NO.: 1524-02R0 AUGUST 18, 2016




LEGEND		
926	EXISTING CONTOUR	
929 ———	PROPOSED CONTOUR	
x 931.0	PROPOSED ELEVATION	
	PROPOSED SAW CUT	

NOTES:


1. DISTURBED AREA = 20,195 S.F. (0.46 ACRES).

2. NET INCREASE IN IMPERVIOUS AREA = 3,950 S.F. (0.09 AC.)

3. ALL PROPOSED SPOT GRADES SHOWN ARE AT BOTTOM OF CURB / WALK.

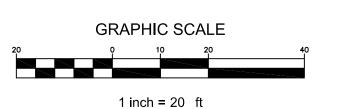

SITE GRADING PLAN

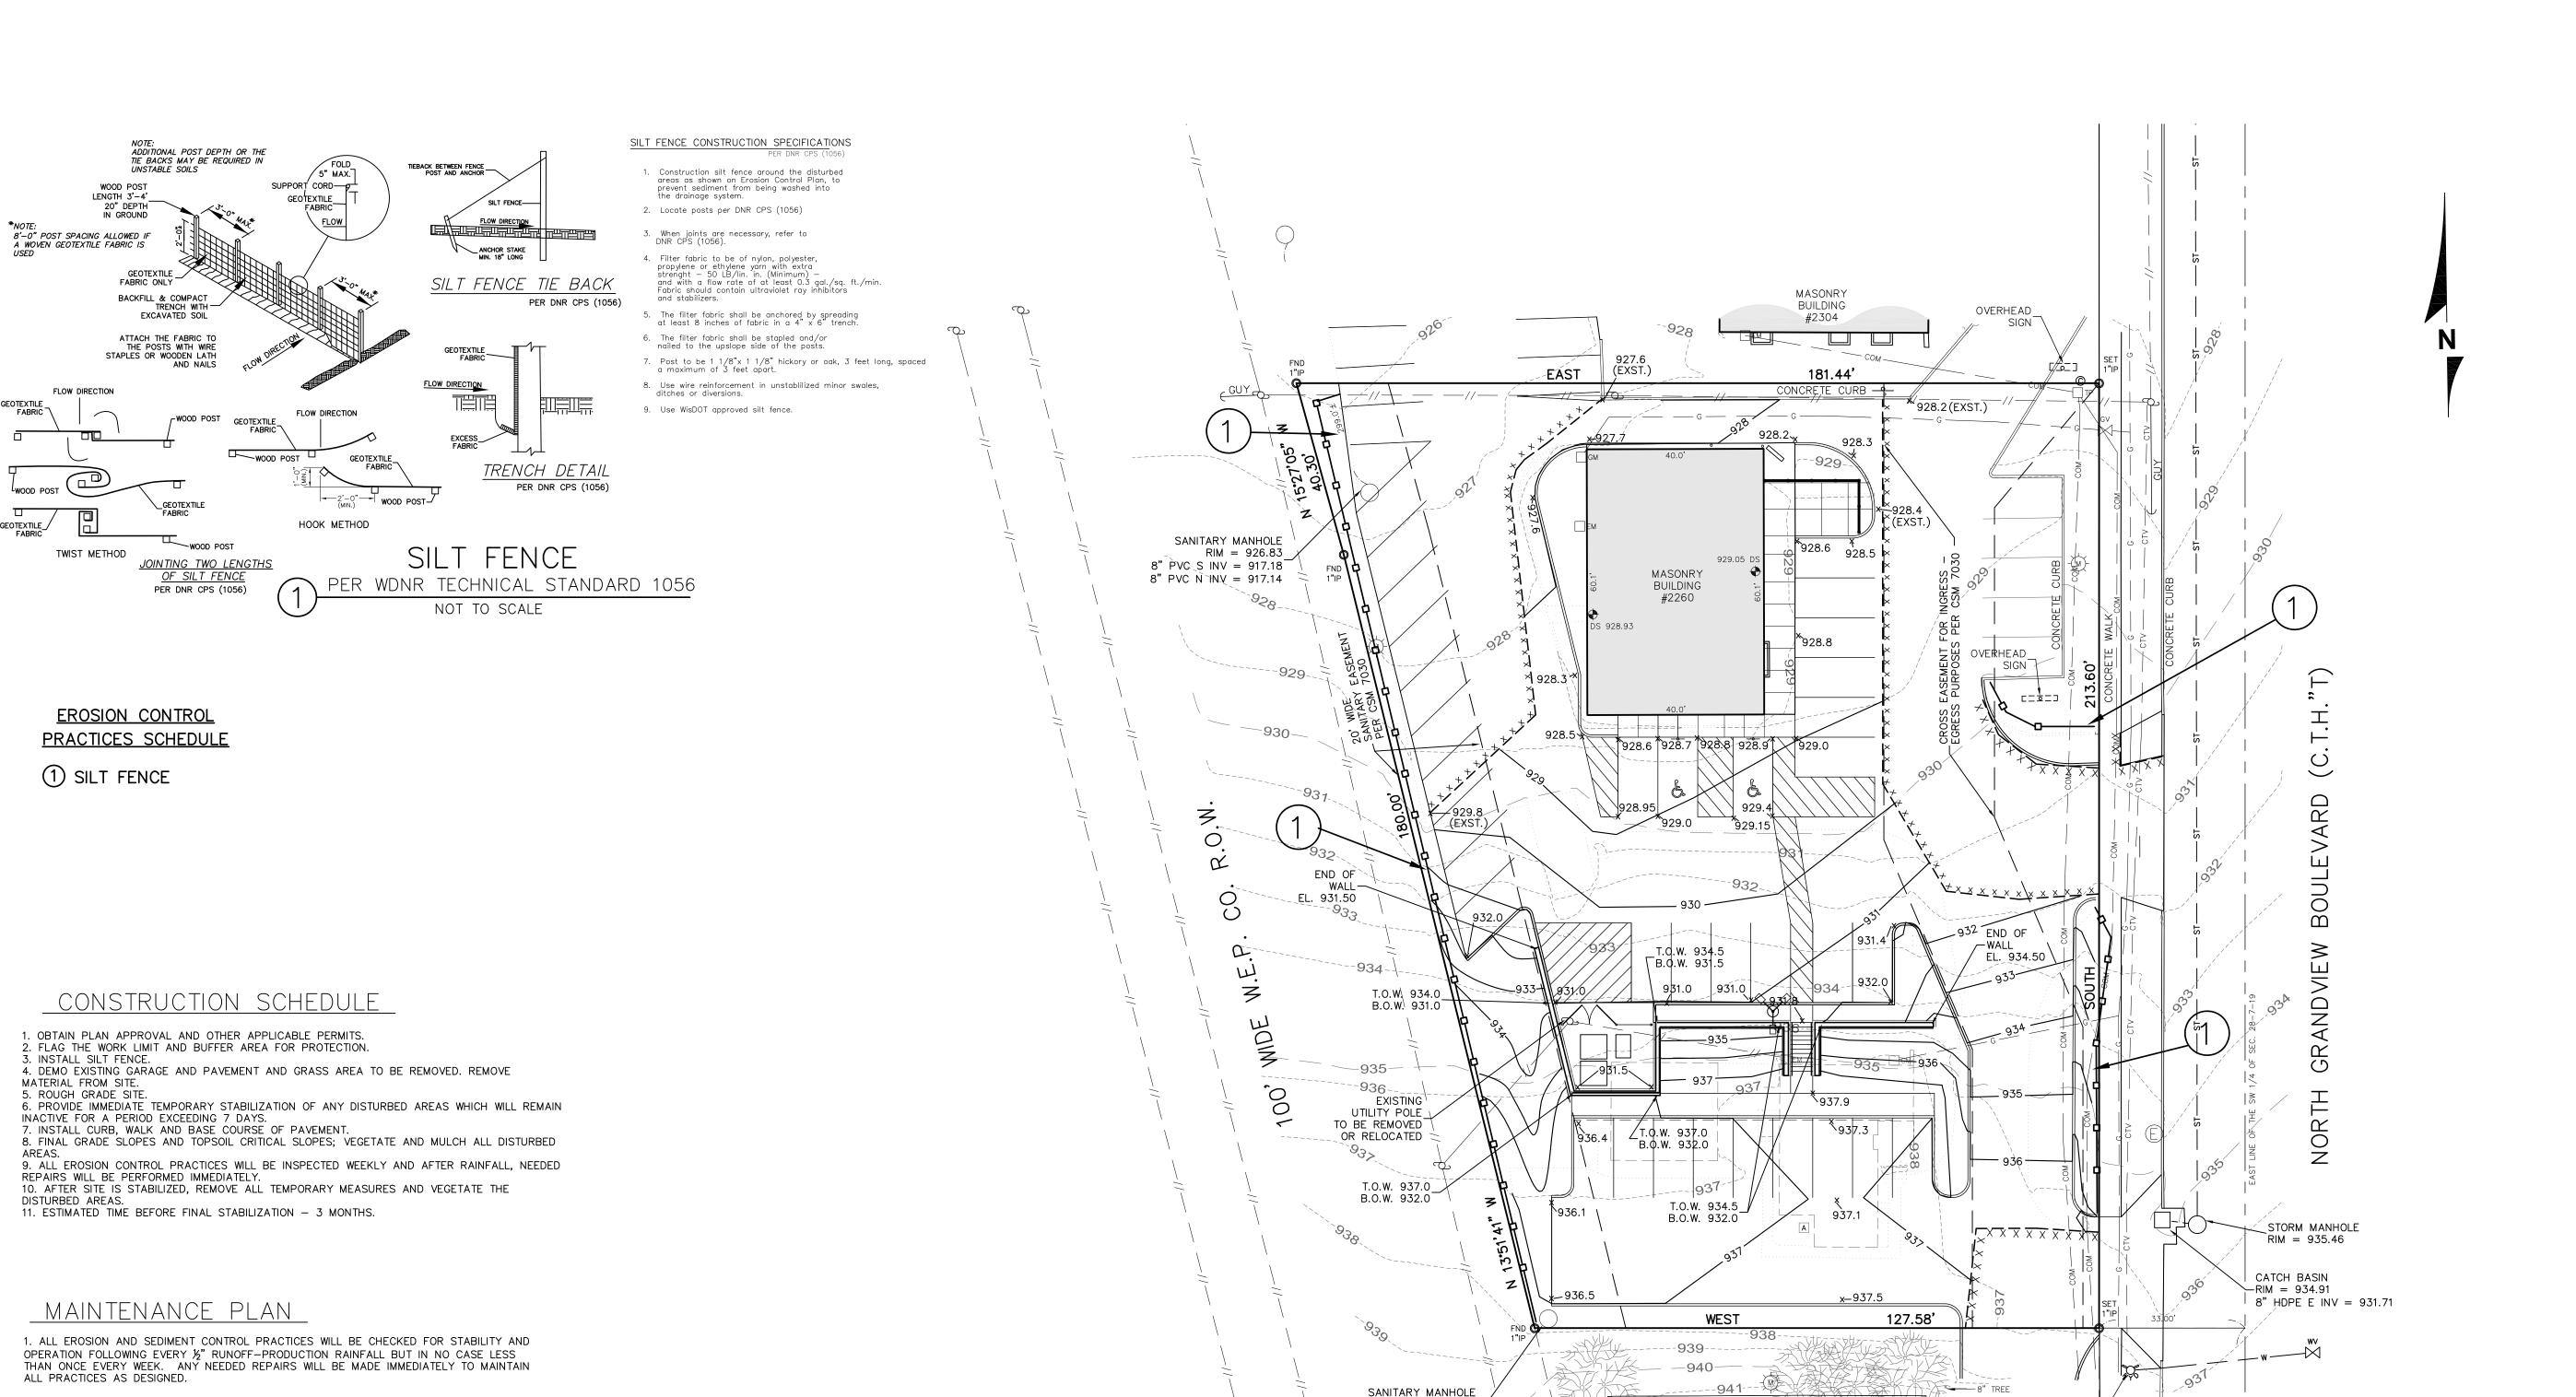

 $RIM = 937.81 - \checkmark$

8" PVC N & S INV =144.46

CJE NO.: 1524-02R0 AUGUST 18, 2016

engineering

civil design and consulting 9205 W. Center Street

Milwaukee, WI 53222

PH. (414) 443-1312 FAX (414) 443-1317 www.cj-engineering.com

Suite 214



LEGEND		
926	EXISTING CONTOUR	
929 ———	PROPOSED CONTOUR	
x 931.0	PROPOSED ELEVATION	
	PROPOSED SAW CUT	

2. SEDIMENT WILL BE REMOVED FROM BEHIND THE SILT FENCE WHEN IT BECOMES ABOUT 0.5

FT. DEEP AT THE FENCE. THE SILT FENCE WILL BE REPAIRED AS NECESSARY TO MAINTAIN

3. ALL SEEDED AREAS WILL BE WATERED, FERTILIZED, RESEEDED AS NECESSARY, AND

4. ANY SEDIMENT REACHING A PUBLIC OR PRIVATE ROAD SHALL BE REMOVED BY STREET

MULCHED TO MAINTAIN A VIGOROUS, DENSE VEGETATIVE COVER.


CLEANING BEFORE THE END OF EACH DAY.

1. DISTURBED AREA = 20,195 S.F. (0.46 ACRES).

2. NET INCREASE IN IMPERVIOUS AREA = 3,950 S.F. (0.09 AC.)

3. ALL PROPOSED SPOT GRADES SHOWN ARE AT BOTTOM OF CURB / WALK.

4. SITE GRADING TO BEGIN SEPTEMBER 1, 2016 AND BE COMPLETED BY NOVEMBER 15, 2016

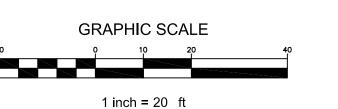


SITE BENCHMARK

NW FLANGE BOLT

ELEVATION = 939.21

ON HYDRANT

EROSION CONTROL PLAN C2.0

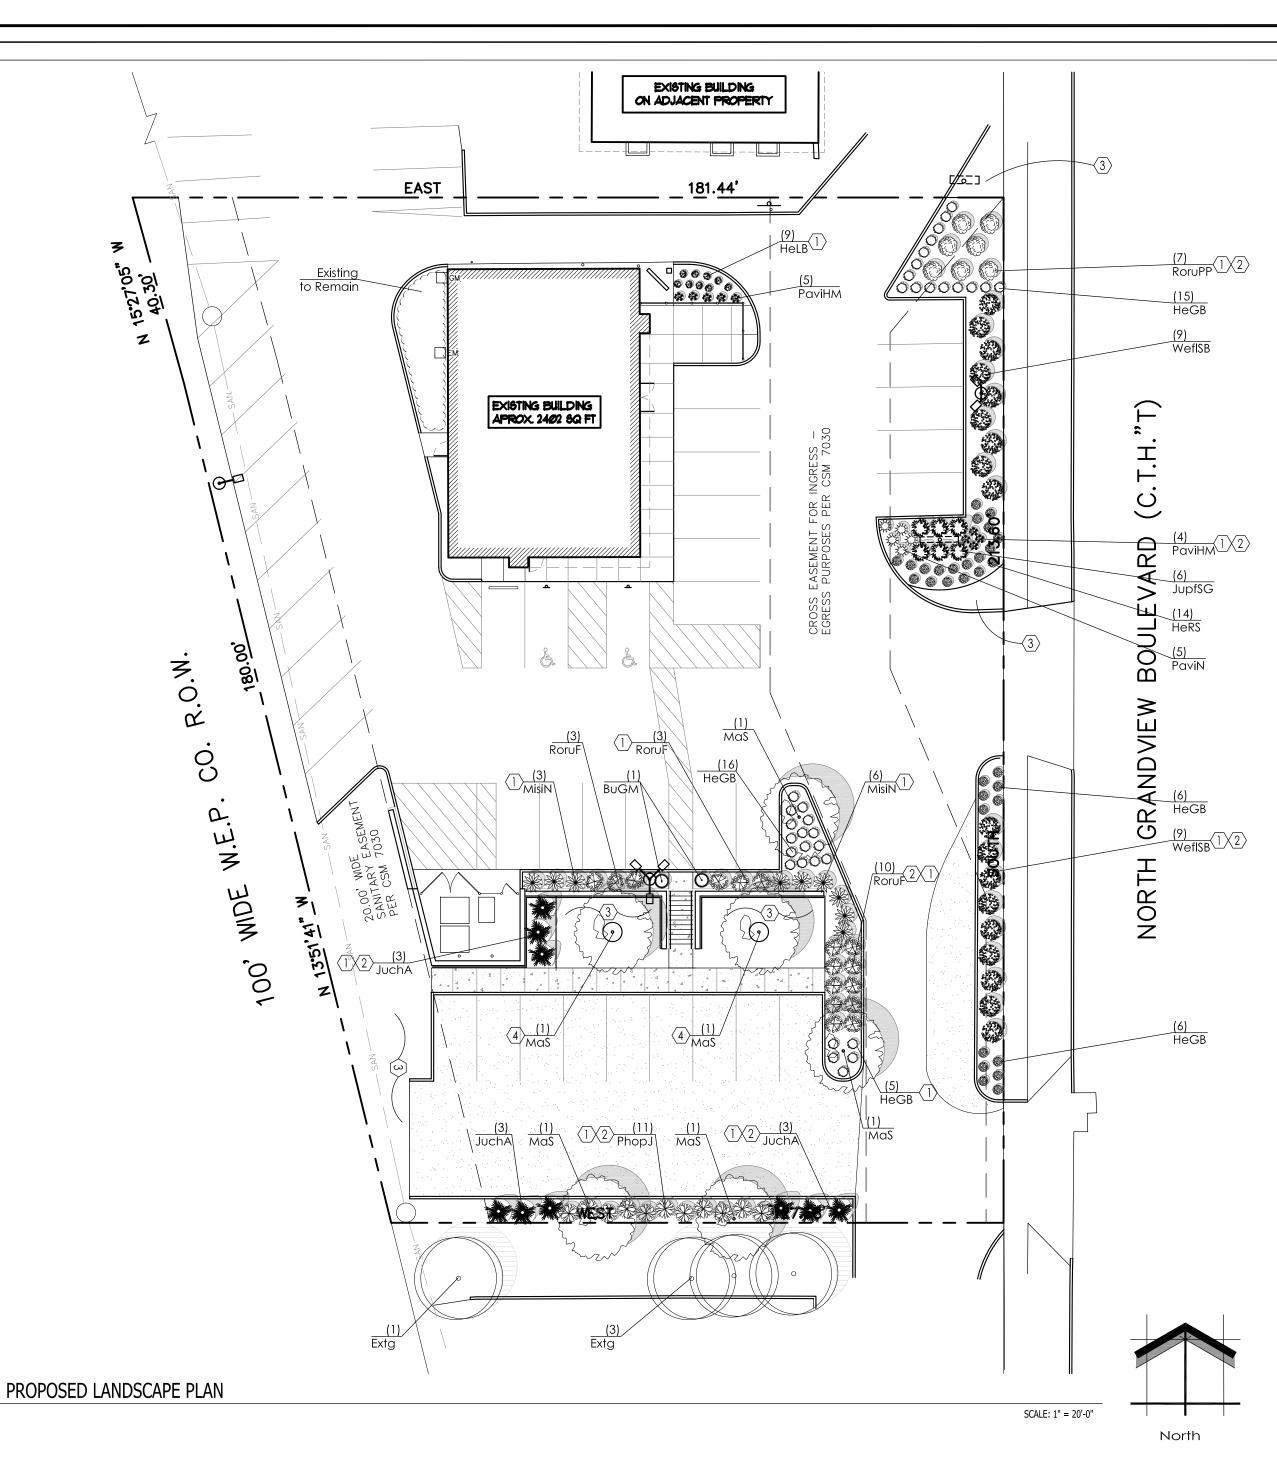

Proposed Plant Material Table

			<u>Fioposea Fiai</u>	<u>II Material Table</u>		
	eciduous Tree	C. was la sil	Coinchific Name	Caraga are Nama	Diamatica e Cin-	Communication
Quantity	Code Name	Symbol	Scientific Name	Common Name	Planting Size	Comments
6	MaS	9	Malus x 'Snowdrift'	Snowdrift Crabapple	2"-Cal - B&B	
4	Extg		Existing	Existing	Existing	
Conifer Everç	green Tree	_				
Quantity	Code Name	Symbol	Scientific Name	Common Name	Planting Size	Comments
9	JuchA	*	Juniperus chinensis 'Ames'	Ames Juniper	6' - 7' - B&B	
Broadleaf De	eciduous Shrub					
Quantity	Code Name	Symbol	Scientific Name	Common Name	Planting Size	Comments
11	PhopJ	**	Physocarpus opulifolius 'Jefam'	First Editions Amber Jubilee Ninebark	18" - 24"- Cont	
16	RoruF	\$ 100 mg	Rosa rugosa 'Foxi'	Foxi Pavement Rose	18" - Cont	
7	RoruPP		Rosa rugosa 'Purple Pavement'	Purple Pavement Rose	18" - 24"- Cont	
18	WefISB		Weigela florida 'Bokrasopin'	Sonic Bloom Pink Reblooming Weigela	18" - Cont	
Broadleaf Ev	ergreen Shrub				·	
Quantity	Code Name	Symbol	Scientific Name	Common Name	Planting Size	Comments
2	BuGM	0	Buxus 'Green Mountain'	Green Mountain Boxwood	24" - 30" - B&B	
Conifer Ever	green Shrub					
Quantity	Code Name	Symbol	Scientific Name	Common Name	Planting Size	Comments
6	JupfSG		Juniperus x pfizeriana 'MonSan'	Sea of Gold Juniper	18" - 24" - B&B	
Perennial Gr	ass			,	'	1
Quantity	Code Name	Symbol	Scientific Name	Common Name	Planting Size	Comments
9	MisiN	*	Miscanthus sinensis 'Nippon'	Nippon Maiden Grass	1-Gal - Cont	
9	PaviHM	**	Panicum virgatum 'Heavy Metal'	Blue Switch Grass	1-Gal - Cont	
5	PaviN	ZWZ	Panicum virgatum 'Northwind'	Northwind Switch Grass	1-Gal - Cont	
Perennial		, ,,,		1	1	
Quantity	Code Name	Symbol	Scientific Name	Common Name	Planting Size	Comments
35	HeGB		Hemerocallis x 'Going Bananas'	Going Bananas Daylily	4 1/2" pot	

Little Business Dwarf Daylily

Ruby Spider Daylily

4 1/2" pot

4 1/2" pot

Hemerocallis x 'Little Business'

Hemerocallis x 'Ruby Spider

HeLB

HeRS

CODED NOTES

LANDSCAPE / SITE DEMOLITION CONTRACTOR TO VERIFY LOCATIONS OF EXISTING TREES TO BE SALVAGED AND CLEARLY TAG THEM WITH MARKING TAPE AND CONSTRUCTION FENCE.

LANDSCAPE INSTALLATION CONTRACTOR TO COORDINATE INSTALLATION OF NEW PLANT

MATERIAL AND THE COORDINATION WITH EXISTING TREES TO BE SALVAGED.

(1) MULCH BED AREA. DRESS WITH 2"-3" OF SHREDDED HARDWOOD BARK MULCH ON TOP OF DEWITT PRO 3 OZ WEED BARRIERWITH WEED BARRIER. TAKE CARE WITH INSTALLATION NOT TO DAMAGE OR COVER PLANTS. REFER TO GENERAL NOTES AND SPECIFICATIONS FOR FURTHER INFORMATION.

(2) EARTHEN BED EDGE (SHOVEL POINT) LANDSCAPE EDGE. TYPICAL ALL PLANT MATERIAL AREAS. DRESS WITH 2"-3" OF SHREDDED HARDWOOD BARK MULCH (OR BROWN ENVIRO-MULCH. REFER TO GENERAL NOTES AND SPECIFICATIONS FOR FURTHER INFORMATION.

 $\langle \overline{3} \rangle$ Seeded areas of turf grass. Repair any and all turf damage from the CONSTRUCTION PROCESS. IT IS VERY IMPORTANT TO FOLLOW THE MANUFACTURERS INSTALLATION INSTRUCTIONS REGARDING THE TURF GRASS FOR PROPER GERMINATION AND SURVIVABILITY OF THE SEED MIX. ALSO REFER TO GENERAL NOTES FOR PREPARATION OF TOP SOIL AND SEED INSTALLATION. REFER TO GRADING PLAN FOR FURTHER INFORMATION.

ALSO REFER TO GENERAL NOTES AND SPECIFICATIONS FOR FURTHER INFORMATION. MULCHED 4'-0" DIA. TREE RING BED AREA W/ EARTHEN BED EDGE (SHOVEL POINT) LANDSCAPE EDGE AS REQUIRED. DRESS WITH 2"-3" OF SHREDDED HARDWOOD BARK MULCH (OR BROWN ENVIRO-MULCH. REFER TO LSP1.2, GENERAL NOTES AND SPECIFICATIONS FOR FURTHER INFORMATION.

LANDSCAPE PLAN GENERAL NOTES

- * * PLANT MATERIAL SHOWN ON LANDSCAPE PLAN IS DEPICTED AT MATURE GROWTH. * *
- 1. AT LEAST SEVENTY-TWO HOURS PRIOR TO ANY EXCAVATION, CONTRACTOR SHALL VERIFY UTILITY LOCATIONS AS GIVEN BY THE ELECTRIC, GAS, TELEPHONE, WATER, SEWER, AND CABLE TELEVISION COMPANIES, UTILITIES OR ENTITIES. REVIEW WITH OWNER'S REPRESENTATIVE SITE MECHANICAL, SITE ELECTRICAL AND LIGHTING, SITE GRADING AND DRAINAGE, SITE IRRIGATION AND ALL OTHER DRAWINGS PERTAINING TO UNDERGROUND UTILITY LOCATIONS. RECORD SET OF INFORMATION THE SAME AS IN POSSESSION OF OWNER'S REPRESENTATIVE. ALSO REVIEW OWNER'S "MARK SETS" OF ALL OF THESE DRAWINGS IN POSSESSION OF THE CONTRACTOR OR OWNER. MARK ALL SUCH UTILITIES ON THE SITE PRIOR TO COMMENCING. COORDINATE WITH OWNER BEFORE AND DURING CONSTRUCTION. REPAIR ANY DAMAGE TO ANY SYSTEM THAT IS CAUSED BY LANDSCAPE CONTRACTOR AT NO COST TO OWNER.

ALL PLANTINGS SPECIFIED FOR THE COUSINS SUBS -GRANDVIEW PROJECT PLANTING TABLE SHEET LSP1.1 SHALL COMPLY WITH STANDARDS AS DESCRIBED IN AMERICAN STANDARD OF NURSERY STOCK ANSI Z60.1 2014 AND ANSI STANDARDS FOR PLANTING 2012

- DEVIATIONS FROM THE APPROVED THE COUSINS SUBS -GRANDVIEW PROJECT PLANS SHALL BE NOTED ON THE RECORD DRAWING BY THE CONTRACTOR AND ONLY WITH PRIOR APPROVAL OF THE LANDSCAPE ARCHITECT AND OWNER'S REPRESENTATIVE. VERBAL AGREEMENTS OR REVISIONS WITHOUT A CHANGE ORDER WILL NOT BE RECOGNIZED BY LANDSCAPE ARCHITECT AND OWNER.
 - ALL PLANTS MUST BE BID AND SELECTED PER THE SPECIES SPECIFIED ON THE PLANS. THE SIZES OF PLANT MATERIAL LISTED HEREIN IS A MINIMUM ACCEPTABLE SIZE. ADDITIONALLY, IF EXCESSIVE PRUNING REDUCES THE CROWN THE PLANT SHALL BE REPLACED.

PROTECT PUBLIC FROM CONSTRUCTION WITH BARRIERS AND BARRICADES.

- ALL AREAS THAT WERE DISTURBED DURING CONSTRUCTION AND AREAS NOT COVERED WITH PAVEMENT, BUILDING, PLANTING BEDS, OR TREE PITS ARE TO BE TOPSOILED 3" DEEP (MIN.) AND SHALL BE SODDED/SEEDED WITH SPECIFIED LAWN GRASS. LANDSCAPE CONTRACTOR SHALL INCLUDE COST PER SQUARE YARD FOR ADDITIONAL SEED OPERATIONS AS MAY BE POSSIBLY REQUIRED TO REESTABLISH ADJACENT TURF GRASS AREAS WHICH MAY BECOME DAMAGED DURING THE CONSTRUCTION PROCESS OR TO REPAIR DAMAGE DONE BY OTHERS.
- CONTRACTOR IS RESPONSIBLE FOR FURNISHING ALL MATERIALS, TOOLS, EQUIPMENT, LABOR, AND PLANTS NECESSARY FOR PROPER PLANTING AND INSTALLATION OF ALL LANDSCAPE MATERIAL.
- QUANTITIES ON PLANT MATERIALS LIST ARE FOR CONVENIENCE OF BIDDING ONLY. CONTRACTOR IS RESPONSIBLE FOR ALL PLANTS SHOWN ON LANDSCAPE PLANS AND COVERAGE OF ALL AREAS DELINEATED. THE PLANS ARE TO SUPERSEDE THE PLANT LIST IN ALL CASES.
- CONTRACTOR IS RESPONSIBLE FOR ALL ESTIMATING AND BIDDING, ALL AREAS, QUANTITIES MATERIALS SHOULD BE FIELD VERIFIED WITH SITE CONDITIONS.
- 10. WHERE DISCREPANCIES OCCUR BETWEEN THE LANDSCAPE PLANS AND/OR ARCHITECTURAL AND/OR THE CIVIL DRAWINGS (AND ANY OTHER SITE DRAWINGS) THE DISCREPANCIES MUST BE BROUGHT TO THE LANDSCAPE ARCHITECTS ATTENTION FOR COORDINATION AND RESOLUTION.
- 11. ALL DISEASED, NOXIOUS OR INAPPROPRIATE MATERIALS SHALL BE REMOVED FROM THE PROPOSED SITE PRIOR TO THE START OF CONSTRUCTION AND DURING THE MAINTENANCE PERIOD.
- 12. GENERAL CONTRACTOR SHALL LEAVE THE SITE FREE OF CONSTRUCTION DEBRIS.
- 13. ALL LAWN AND PLANTING AREAS SHALL SLOPE TO DRAIN A MINIMUM OF 2% UNLESS NOTED OTHERWISE AND REVIEWED WITH OWNER'S REPRESENTATIVE FOR FINAL APPROVAL
- 14. FINISH GRADES FOR SHRUB AND GROUND COVER AREAS SHALL BE HELD 1" BELOW TOP OF ADJACENT PAVEMENTS AND CURBS, UNLESS NOTED OTHERWISE ON THE PLANS. REFER TO LSP1.2 FOR FURTHER INFORMATION.
- 15. ALL PERENNIAL, ANNUAL AND GROUND COVER AREAS TO RECEIVE A BLEND OF ORGANIC SOIL AMENDMENTS PRIOR TO PLANTING. TILL THE FOLLOWING MATERIALS INTO EXISTING TOPSOIL TO A DEPTH OF APPROXIMATELY 8". A DEPTH OF 12" IN TREE PITS. PROPORTIONS AND QUANTITIES MAY REQUIRE ADJUSTMENT DEPENDING ON THE CONDITION OF EXISTING SOIL. REFER TO LSP1.2 FOR FURTHER INFORMATION.

PER EVERY 100 SQUARE FEET ADD:

- ONE 2 CUBIC FOOT BALE OF PEAT MOSS, 2 POUNDS OF 5 10 5 GARDEN FERTILIZER, 1/4 CUBIC YARD OF COMPOSTED MANURE OR OTHER COMPOSTED, ORGANIC MATERIAL 16. ALL SHRUBS TO BE POCKET PLANTED WITH A 50/50 MIX OF COMPOSTED, ORGANIC MATERIAL AND EXISTING SOIL. INSTALL TOPSOIL INTO ALL BEDS AS NEEDED TO ACHIEVE PROPER GRADE. REMOVE ALL
- EXCESSIVE GRAVEL, CLAY AND STONES. REFER TO LSP1.2 FOR FURTHER INFORMATION. 17. PLANT ALL TREES SLIGHTLY HIGHER THAN FINISHED GRADE AT ROOT FLARE. BACK FILL HOLE WITH 2/3 EXISTING TOPSOIL AND ORGANIC SOIL AMENDMENTS SPECIFIED IN NOTE 15. AVOID ANY AIR POCKETS.
- DISCARD ANY GRAVEL CLAY OR STONES. REFER TO LSP1.2 FOR FURTHER INFORMATION. 18. ALL TREES TO BE INSTALLED, STAKED AND GUYED ACCORDING TO DETAILS. REFER TO ANSI STANDARDS FOR PLANTING 2012 AND DETAILS ON LSP1.2 FOR FURTHER INFORMATION.
- 19. PROVIDE A 4'-0" 5'-0" DIAMETER MULCH RING ALL LAWN TREES.
- ALL PLANTINGS TO BE WATERED AT THE TIME OF PLANTING, THROUGHOUT CONSTRUCTION AND UPON COMPLETION OF PROJECT AS REQUIRED.
- WHERE SPECIFIED, ALL PLANT BEDS, PITS AND TREE RINGS ARE TO RECEIVE A MINIMUM OF 2'-3" DRESSING OF SHREDDED HARDWOOD OAK BARK MULCH SHAVINGS FREE OF GROWTH, WEEDS, FOREIGN MATTER DETRIMENTAL TO PLANT LIFE OR GERMINATION INHIBITING INGREDIENTS. LANDSCAPE CONTRACTOR TO PROVIDE A SAMPLE TO OWNER FOR APPROVAL. CONTRACTOR TO TAKE CARE WITH INSTALLATION NOT TO DAMAGE OR COVER PLANTS. REFER TO LSP1.2 FOR FURTHER INFORMATION.
- 22. LAWN INSTALLATION: CONTRACTOR TO FURNISH AND PREPARE TOPSOIL (3" MIN) AND SEED BED (REMOVE ALL STONES 1" OR LARGER), APPLY STARTER FERTILIZER AND SEED UNIFORMLY. PROVIDE A MULCH COVERING SUITABLE TO GERMINATE AND ESTABLISH TURF. EROSION CONTROL MESH SHOULD BE USED IN SWALES AND STEEP GRADES WHERE APPLICABLE. METHODS OF INSTALLATION MAY VARY AT THE DISCRETION OF CONTRACTOR. IT IS HIS/HER RESPONSIBILITY TO ESTABLISH AND GUARANTEE A SMOOTH, UNIFORM, QUALITY TURF. IF STRAW MULCH IS USED AS A COVERING, A TACKIFIER MAY BE NECESSARY TO AVOID WIND DAMAGE.

23. REQUIRED SEED MIXES: PREMIUM 60 GRASS SEED MIX REINDER'S (262) 786-3300

20% AMERICAN KENTUCKY BLUE GRASS 20% ALPINE KENTUCKY BLUE GRASS 20% LANGARA KENTUCKY BLUE GRASS 20% VICTORY CHEWINGS FESCUE 10% FIESTA III PERENNIAL RYE GRASS 10% CUTTER PERENNIAL RYE GRASS APPLY AT A RATE OF 175 POUNDS PER ACRE. REFER TO SUPPLIERS SPECIFICATIONS AND INSTALLATION CUT SHEETS FOR FURTHER INFORMATION

RECOMMENDED TURF GRASS MIX TO BE PRESENT IN SOD

- 1. Rye Grass Type: 20 percent. 2. Fescue Grass Type: 20 percent.
- Kentucky Blue Grass Type: 60 percent. 4. Thickness: "Thin" sod, minimum 1/2 inch and
- maximum 1 inch topsoil base. 5. Thickness: "Thick" sod, minimum 1 inch and
- maximum 1-3/8 inch topsoil base. 6. Cut sod in area not exceeding 1 sq yd. 7. Machine cut sod and load on pallets in
- accordance with TPI Guidelines. 24. DURING THE INITIAL "30 DAY MAINTENANCE PERIOD" THE LANDSCAPE CONTRACTOR IS REQUIRED TO PROVIDE AND ON-GOING PLEASANT VISUAL ENVIRONMENT WHEREAS ANY PLANT WHICH IS NOT RESPONDING TO TRANSPLANTING OR THRIVING SHALL IMMEDIATELY BE REPLACED. NEW LAWNS SHALL
- 25. ALL NEWLY PLANTED TREES AND SHRUBS ARE TO RECIEVE AN APPLICATION OF AN ANTI-TRANSPIRANT SPRA THAT WILL EFFECTIVELY REDUCE THE WATER LOSS OF TRANSPIRATION OF PLANT MATERIAL AND REDUCE THE STRESS OF TRANSPLANTATION. IT IS RECOMENDED AS PART OF THE ONGOING MAINTENANCE THAT ANY BROADLEAF EVERGREEN AND CONIFEROUS TREE AND SHRUBS (EXCLUDING ARBORVITAE) RECIEVE AN

WATERED AND REPAIRED AND WEEDS MUST CONSTANTLY BE REMOVED, NO EXCEPTIONS WILL BE

- APPLIATION OF AN ANTI-DESICANT SPRAY TO REDUCE THE LOSS OF MOISTURE DUE TO WINTER DESICCATIO MAINTENANCE. THE OWNER SHALL TEND AND MAINTAIN ALL PLANT MATERIALS IN A HEALTHY GROWING CONDITION AS PER THE APPROVED PLAN. PLANTINGS SHALL BE REPLACED WHEN NECESSARY AND KEPT FREE FROM REFUSE & DEBRIS. ALL PLANTING MATERIAL WHICH IS DYING OR DAMAGED BEYOND RECOVERY SHALL BE REPLACED WITHIN SIX (6) MONTHS OR BY THE NEXT PLANTING SEASON, WHICHEVER COMES FIRST. LANDSCAPE / SITE DEMOLITION CONTRACTOR TO VERIFY LOCATIONS OF EXISTING TREES AND SHRUBS BE
- SALVAGED AND CLEARLY TAG THEM WITH MARKING TAPE AND CONSTRUCTION FENCE. 28. ALTERNATE BID: DESIGN IRRIGATION SYSTEM TO BE DESIGNED FOR A OVERLAPPING ZONED SPRINKLER HEAL SYSTEM IN ALL LAWN & ISLAND AREAS AND A DRIP SYSTEM FOR ALL FOUNDATION PLANTING AREAS.



WISCONSIN STATUTE 182.0175 (1974) REQUIRES A MINIMUM OF 3 DAYS NOTICE BEFORE YOU EXCAVATE (NOT INCLUDING SATURDAY, SUNDAY OR LEGAL HOLIDAYS)

UNDERGROUND SEWER AND UTILITY INFORMATION AS SHOWN IS OBTAINED FROM THE RECORDS OF CERTIFIED TO.

THE LOCATIONS OF EXISTING UTILITY INSTALLATIONS AS (800)-242-8511, (262) 432-7910 SHOWN ON THIS SURVEY ARE APPROXIMATE. THERE MAY BE OTHER UNDERGROUND UTILITY INSTALLATIONS WITHIN THE PROJECT AREA THAT ARE NOT SHOWN.

PARTICIPANT'S UNDERGROUND MUNICIPALITY AND LOCAL UTILITY COMPANIES. THE FACILITIES BEFORE YOU DIG IN ACCURACY OF WHICH CAN NOT BE GUARANTEED OR WISCONIN CALL THE MILWAUKEE UTILITY ALERT NETWORK (877) 500-9592

www.Diggershotline.com



LANDSCAPE

Landscape Architecture and Master Planning Design Consulting

11525 W. North Avenue Suite 1B Wauwatosa, WI 53226 Tel (414) 476-1204 www.insitelandscape.com mdavis@insitelandscape.com

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Issuance and Revisions:

Daic	Description
06/21/16	Plan Commission

07/08/16

08/31/16

Submittal

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<u>Sheet Title:</u>

PROPOSED LANDSCAPE PLAN, GENERAL NOTES, AND PLANT MATERIAL TABLE

Date of Drawing:	08/31/16
Scale:	1" = 20'-0"
Drawn By:	MCD
Job Number:	116.022

L16-023

Sheet Number:

LANDSCAPE

ORANGE SNOW FENCING ZIP

TIED AT 12" O.C. VERTICALLY TO EVERY STEEL POST TO

PROTECTION. MUST BE FULLY

DISTURBING ACTIVITY ON SITE.

(THIS INCLUDES THE REMOVAL

INSTALLED PRIOR TO ANY

PROVIDE PERIMETER

AND ALL GROUND

OF OTHER TREES.)

SCALE: NONE

Landscape Architecture

and Master Planning Design Consulting


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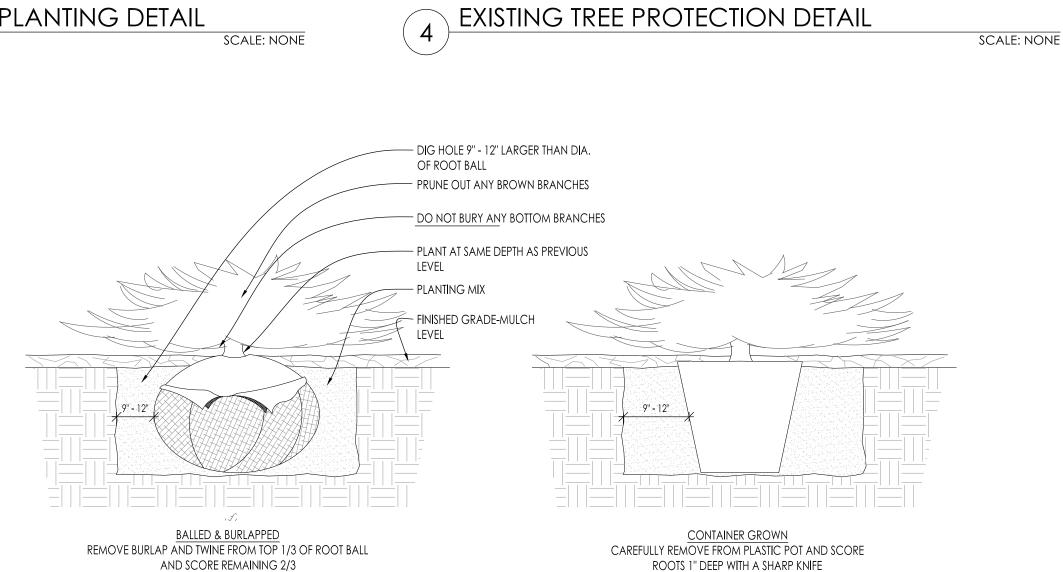
Wauwatosa, WI 53226

Tel (414) 476-1204

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mdavis@insitelandscape.com



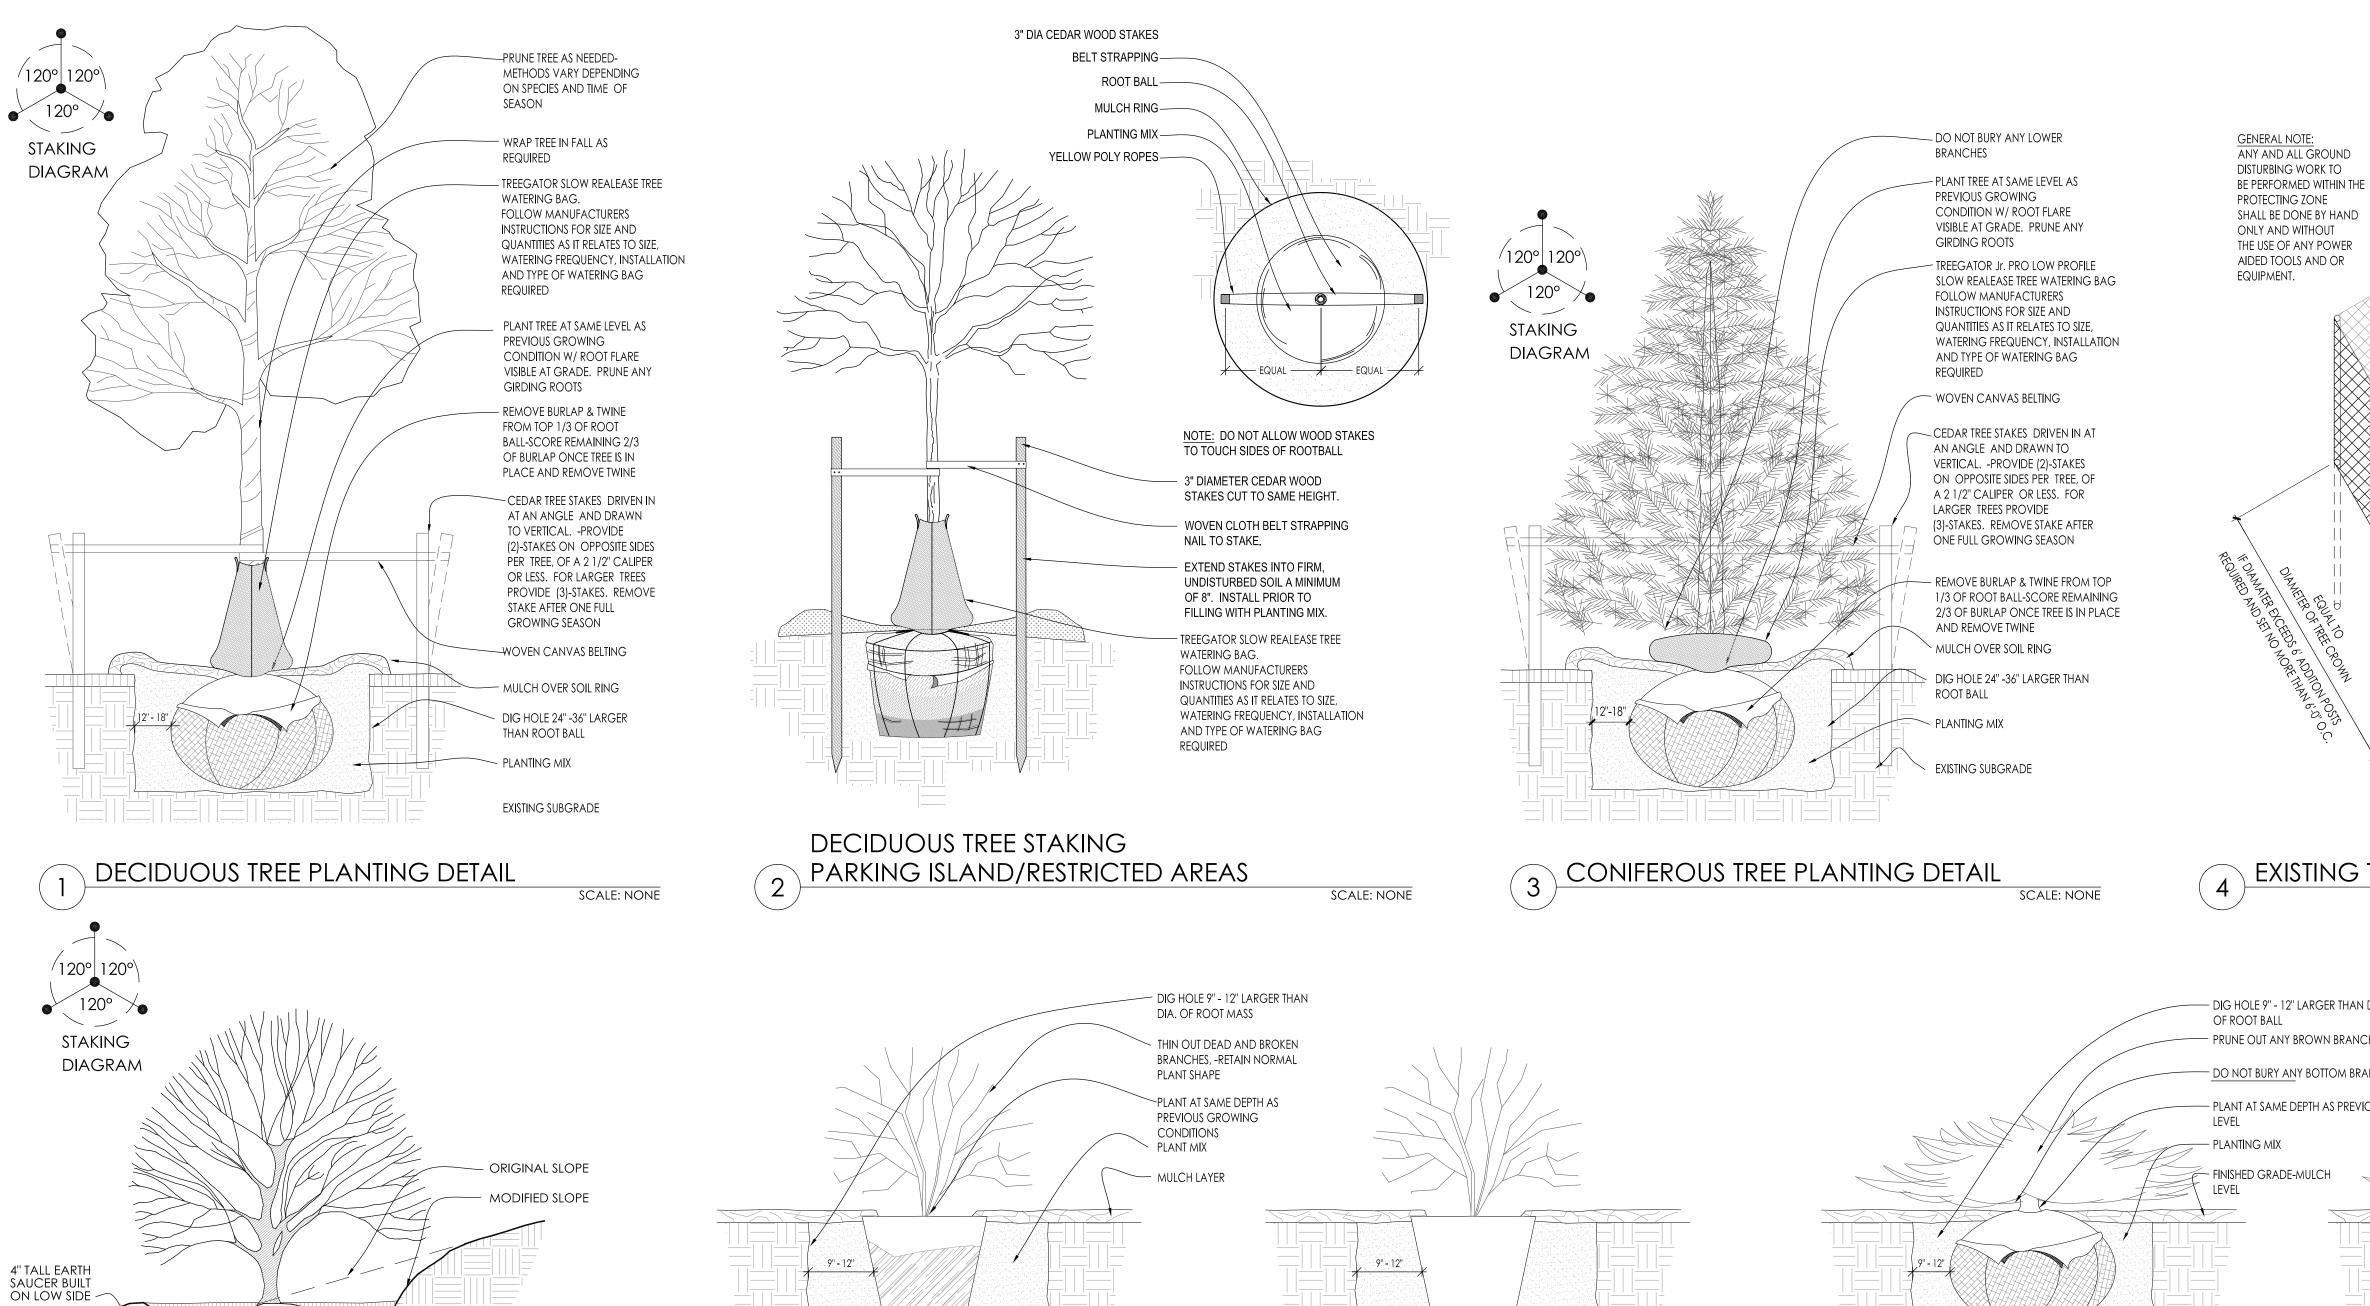

SCALE: NONE

CONTAINER GROWN

CAREFULLY REMOVE FROM PLASTIC POT AND SCORE ROOTS 1"

DEEP WITH A SHARP KNIFE

CONIFEROUS SHRUB PLANTING DETAIL

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06/21/16


07/08/16

08/31/16

PROPOSED LANDSCAPE PLAN, PLANTING DETAILS

Date of Drawing:	08/31/16
Scale:	As Noted
Drawn By:	MCD
Job Number:	L16-023
Shoot Number	

Sheet Number:

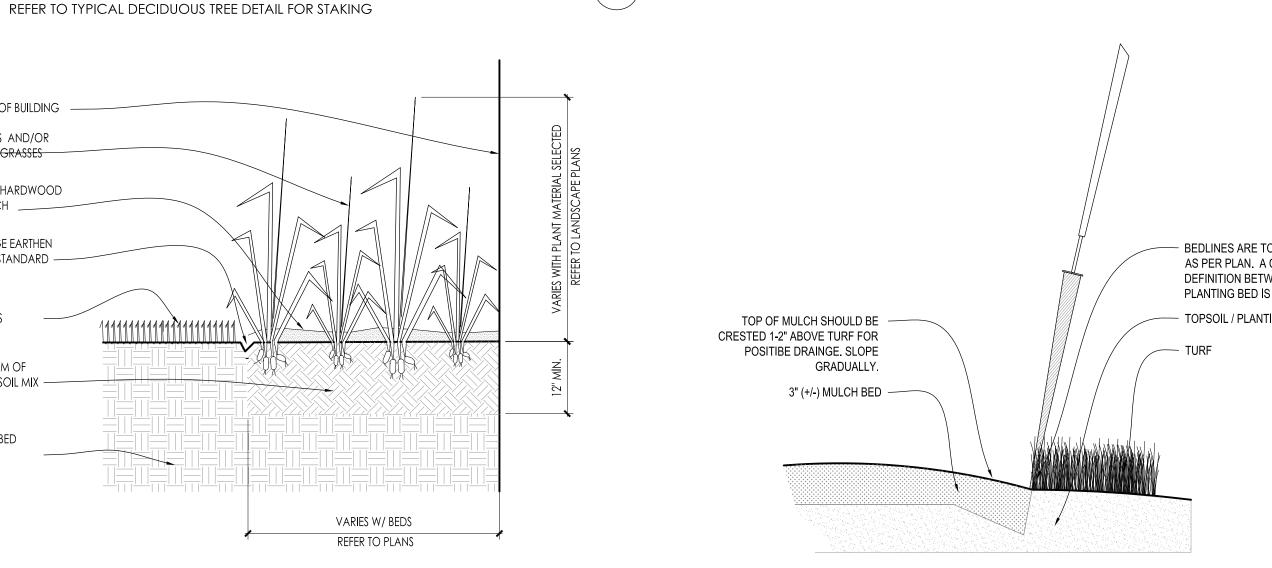

PAPER FIBER POT

REMOVE ENTIRE POT IF IT IS POSSIBLE. IF ROOTS HAVE PENETRATED POT,

REMOVE RIM AND SCORE SIDES WITH KNIFE *REFER TO CONIFER BALLED

AND BURLAPPED INSTALLATION

DECIDUOUS SHRUB PLANTING DETAIL

BEDLINES ARE TO BE CUT CRISP AS PER PLAN. A CLEAN DEFINITION BETWEEN TURF AND PLANTING BED IS REQUIRED. TOPSOIL / PLANTING MIX

BARK MULCH ____ SPADE EDGE EARTHEN BED EDGE STANDARD -TURF GRASS 12" MINIMUM OF PLANTING SOIL MIX UNDISTURBED EARTH

MULCH 3" MIN.

PLANTING SOIL

EXISTING SUBGRADE

SCALE: NONE

PERENNIAL BED PLANTING DETAIL

SLOPE PLANTING DETAIL

PERIMETER OF BUILDING

PERENNIALS AND/OR

PERENNIAL GRASSES

SHREDDED HARDWOOD

SCALE: NONE

9 SPADE EDGE PLANT BED EDGE DETAIL

SCALE: NONE