
ZT DISTRIBUTION - VENTURE COURT BUILDING, PARKING LOT, & UTILITY CONSTRUCTION

CITY OF WAUKESHA, WISCONSIN

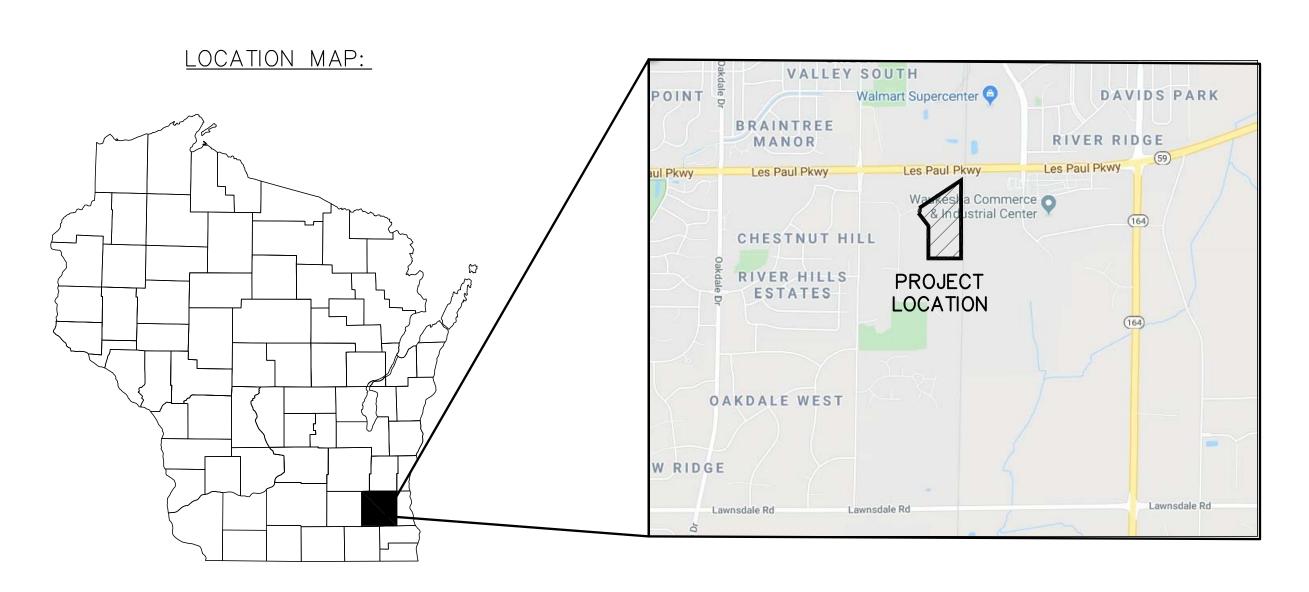







CIVIL SH	HEET INDEX:
SHEET	SHEET TITLE
C-100	COVER
C-101	EXISTING SITE PLAN
C-102	GRADING AND EROSION CONTROL PLAN
C-103	UTILITY PLAN
C-104	CONSTRUCTION DETAILS AND GENERAL NOTES

	(202) 000 0011, www.quamongmooning.com
PROJECT CONTACTS:	BENCHMARK:
OWNER: SCOT TROJANOWSKI 5441 S 9TH STREET MILWAUKEE, WI 53221	<u>SITE BENCHMARK:</u> RIM OF SANITARY MANHOLE, CUL—DE—SAC VENTURE COURT ELEV=825.15
CIVIL: QUAM ENGINEERING, LLC ATTN: KEVIN PARISH 122 WISCONSIN STREET WEST BEND, WI 53095	<u>LOCATION:</u> LOT 1 WAUKESHA CORPORATE CENTER SW 1/4 OF SEC 15, T6N, R7E.
Dial or (800)242-8511	NOTES: THE CONTRACTOR SHALL REFER TO THE MUNICIPAL STANDARD SPECIFICATIONS, WATER SPECIFICATIONS, WISDOT, AND STANDARD SPECIFICATIONS FOR SEWER & WATER CONSTRUCTION IN WISCONSIN.
www.DiggersHotline.com	

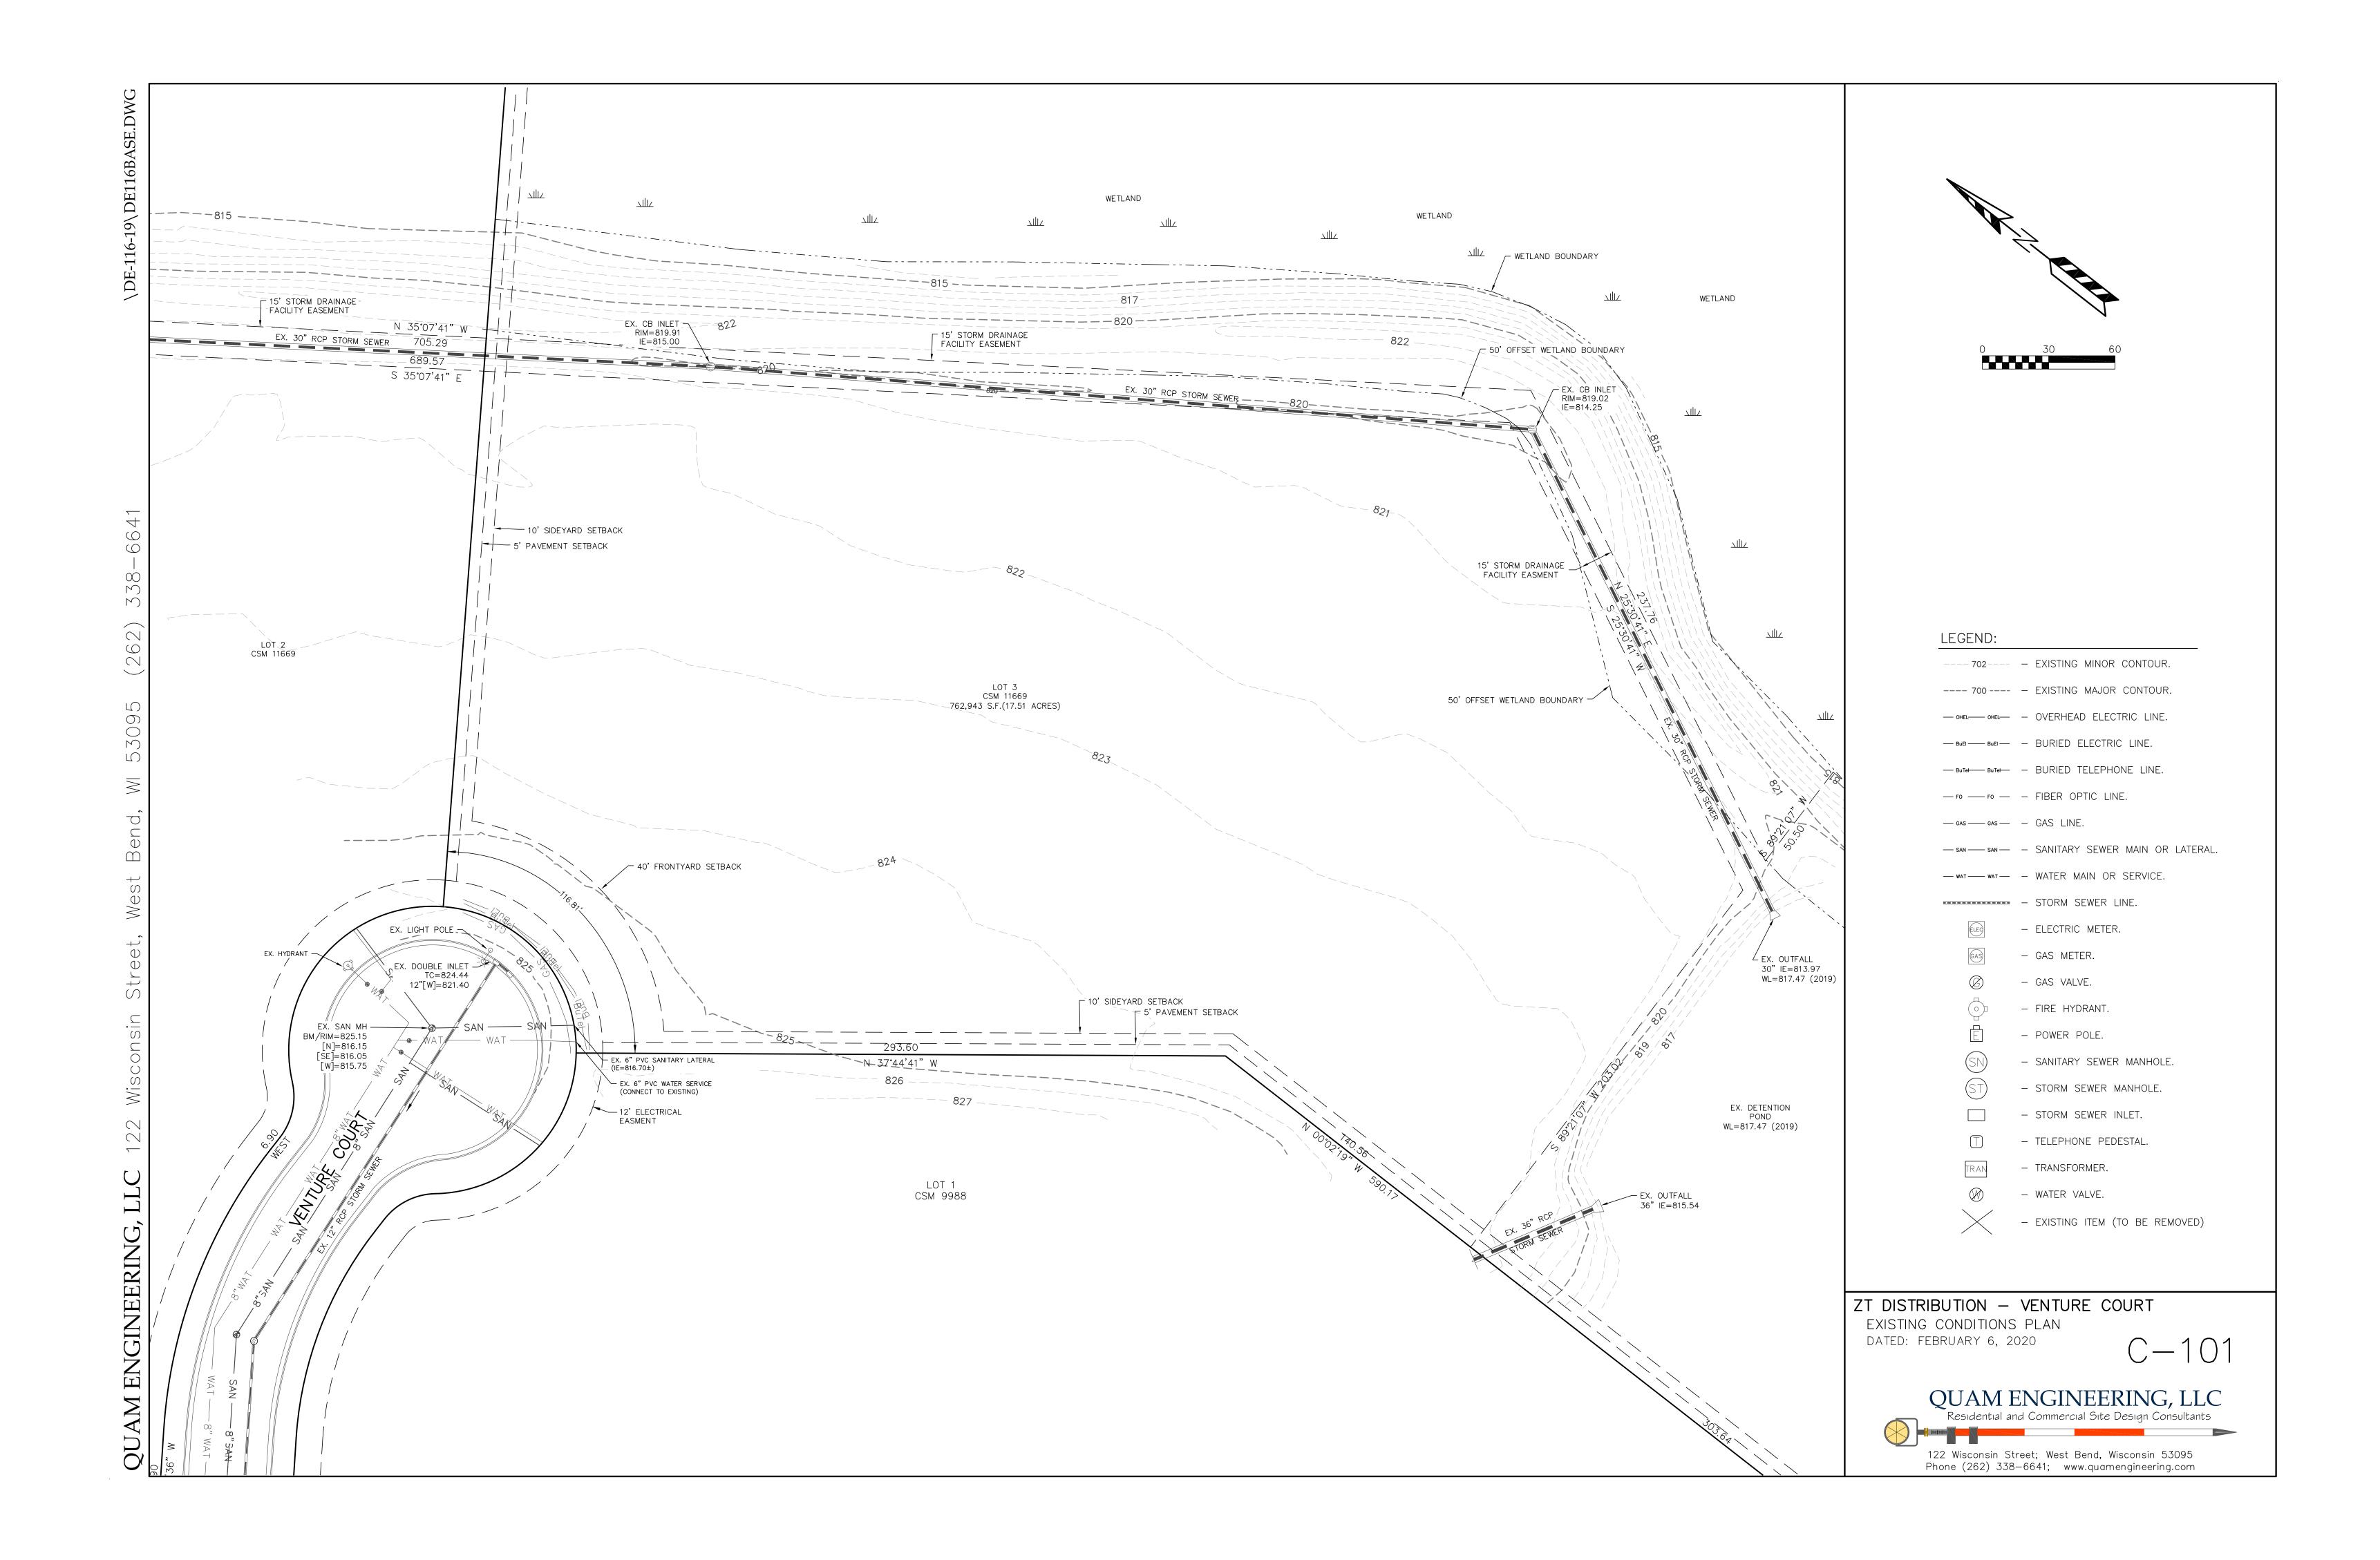

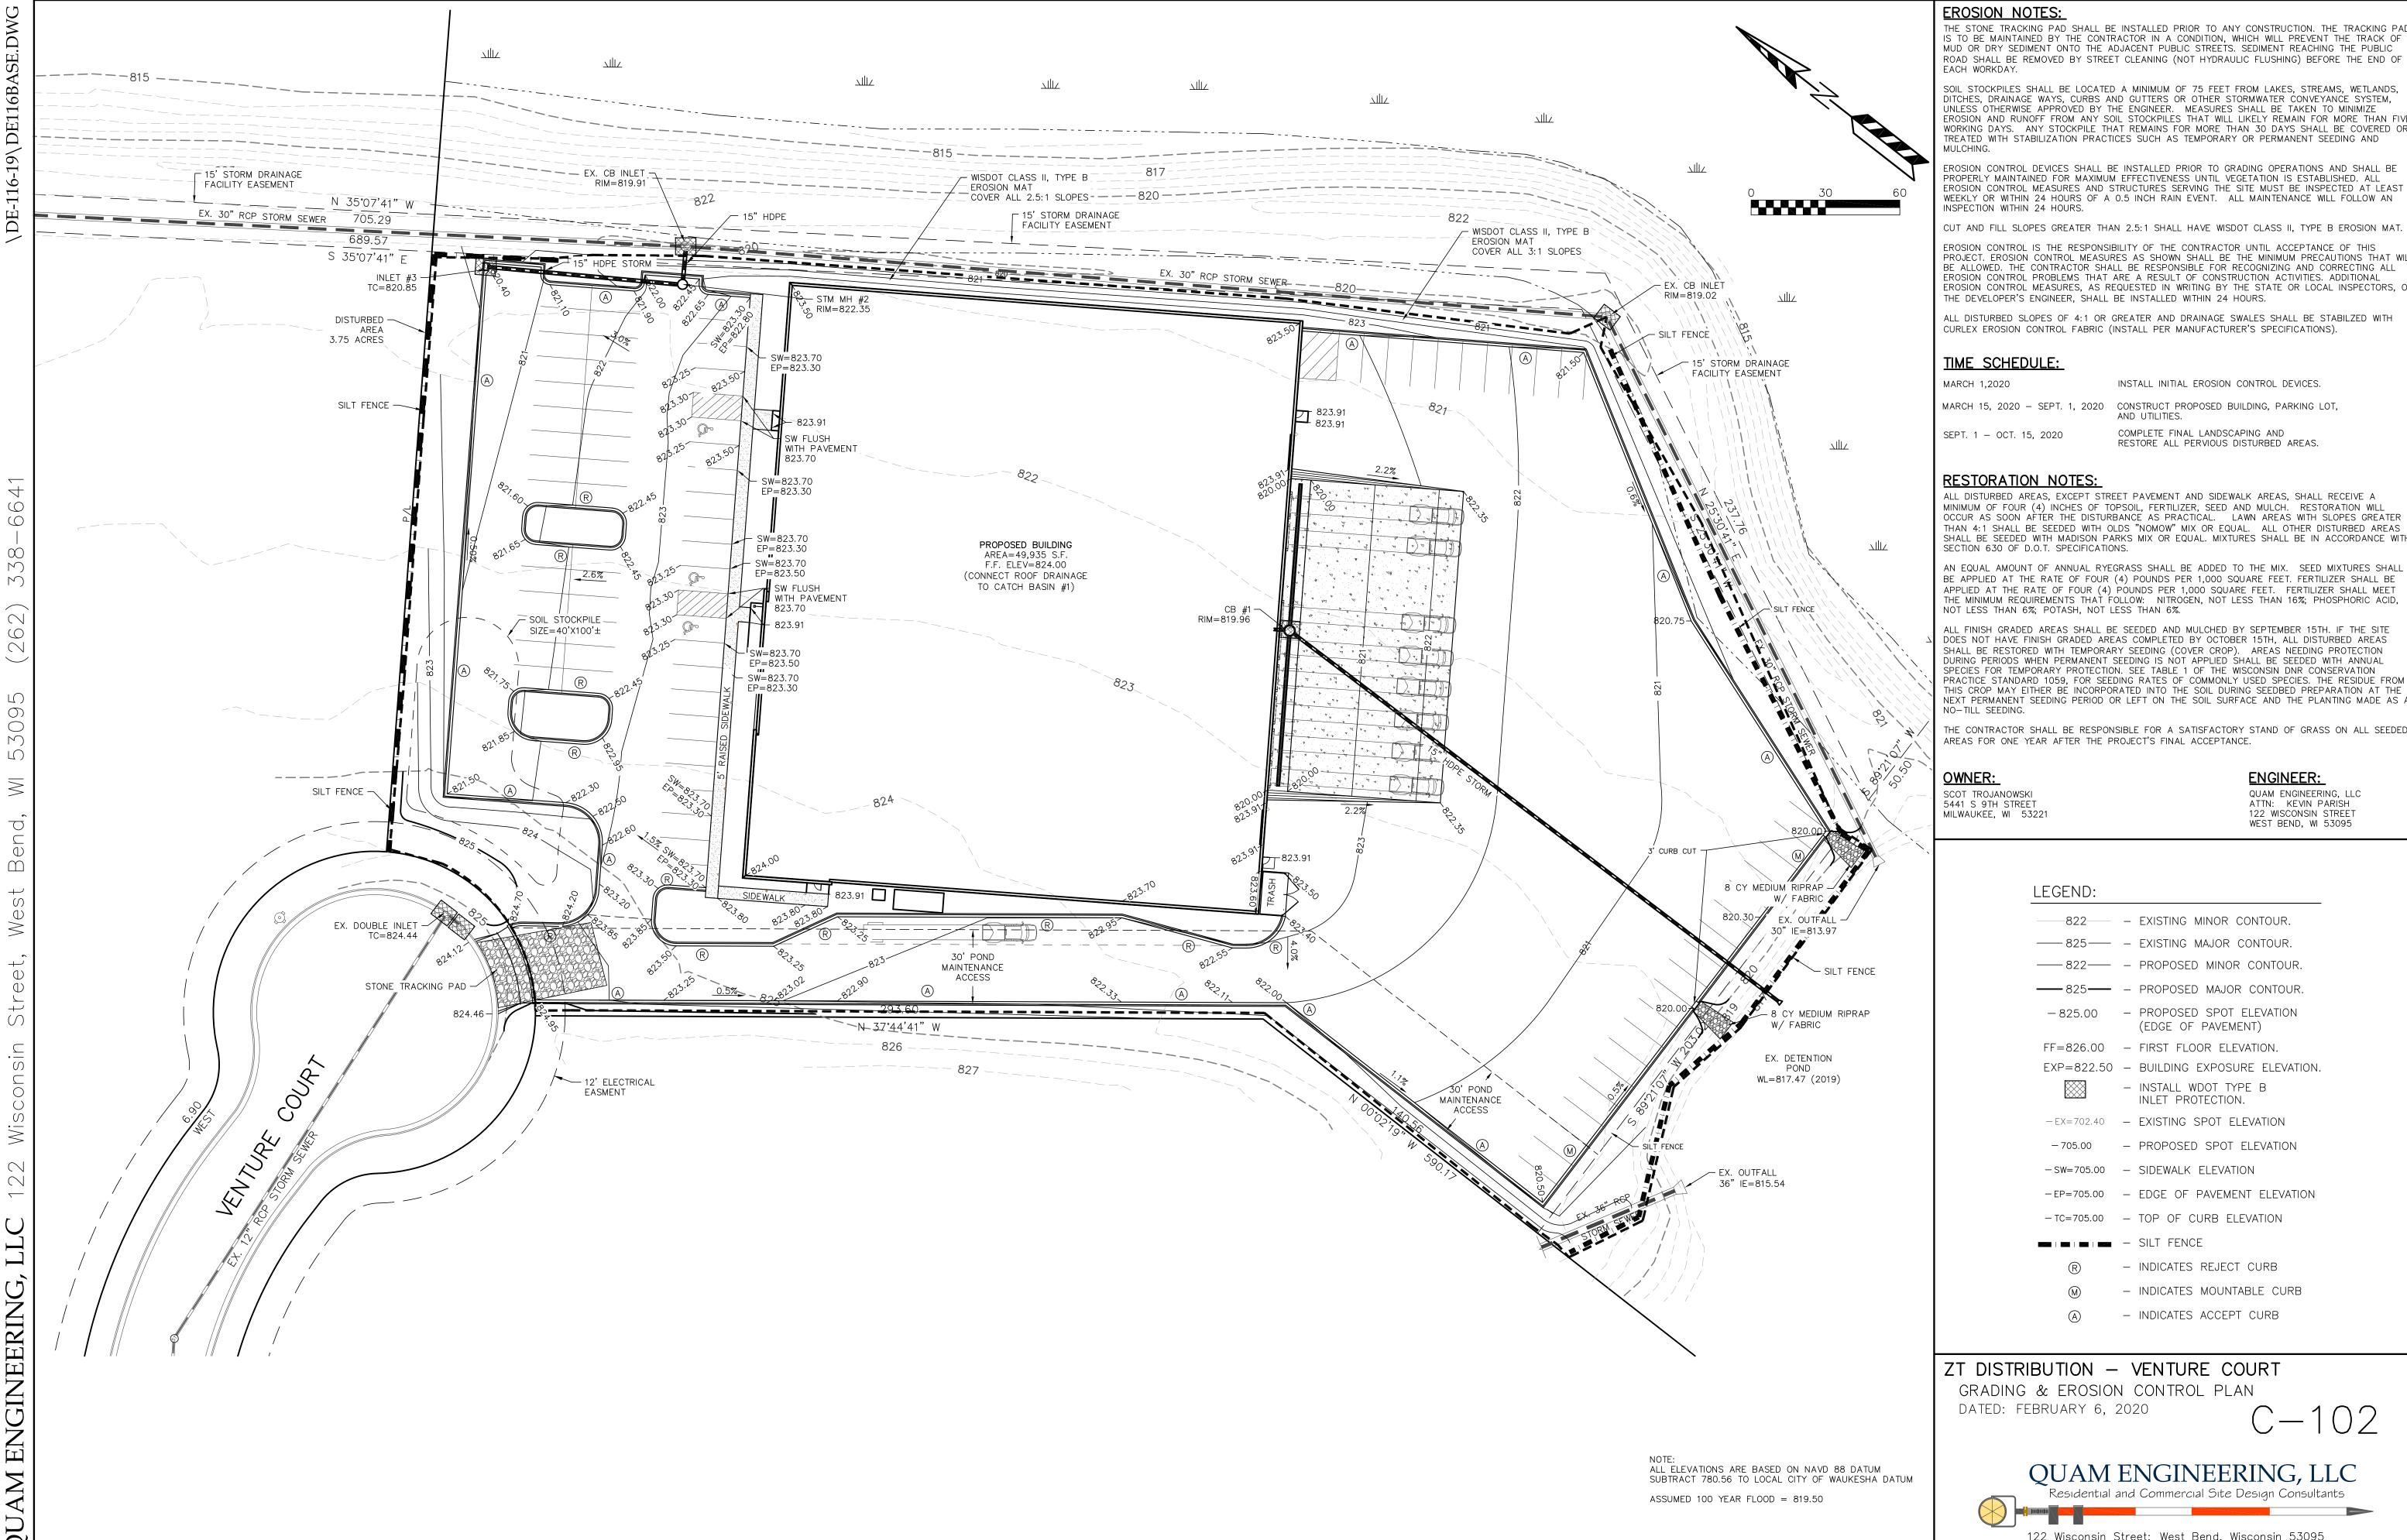

EROSION NOTES:

THE STONE TRACKING PAD SHALL BE INSTALLED PRIOR TO ANY CONSTRUCTION. THE TRACKING PAD IS TO BE MAINTAINED BY THE CONTRACTOR IN A CONDITION, WHICH WILL PREVENT THE TRACK OF MUD OR DRY SEDIMENT ONTO THE ADJACENT PUBLIC STREETS. SEDIMENT REACHING THE PUBLIC ROAD SHALL BE REMOVED BY STREET CLEANING (NOT HYDRAULIC FLUSHING) BEFORE THE END OF EACH WORKDAY.

SOIL STOCKPILES SHALL BE LOCATED A MINIMUM OF 75 FEET FROM LAKES, STREAMS, WETLANDS, DITCHES, DRAINAGE WAYS, CURBS AND GUTTERS OR OTHER STORMWATER CONVEYANCE SYSTEM, UNLESS OTHERWISE APPROVED BY THE ENGINEER. MEASURES SHALL BE TAKEN TO MINIMIZE EROSION AND RUNOFF FROM ANY SOIL STOCKPILES THAT WILL LIKELY REMAIN FOR MORE THAN FIVE WORKING DAYS. ANY STOCKPILE THAT REMAINS FOR MORE THAN 30 DAYS SHALL BE COVERED OR TREATED WITH STABILIZATION PRACTICES SUCH AS TEMPORARY OR PERMANENT SEEDING AND

EROSION CONTROL DEVICES SHALL BE INSTALLED PRIOR TO GRADING OPERATIONS AND SHALL BE PROPERLY MAINTAINED FOR MAXIMUM EFFECTIVENESS UNTIL VEGETATION IS ESTABLISHED. ALL EROSION CONTROL MEASURES AND STRUCTURES SERVING THE SITE MUST BE INSPECTED AT LEAST WEEKLY OR WITHIN 24 HOURS OF A 0.5 INCH RAIN EVENT. ALL MAINTENANCE WILL FOLLOW AN INSPECTION WITHIN 24 HOURS.

CUT AND FILL SLOPES GREATER THAN 2.5:1 SHALL HAVE WISDOT CLASS II, TYPE B EROSION MAT. EROSION CONTROL IS THE RESPONSIBILITY OF THE CONTRACTOR UNTIL ACCEPTANCE OF THIS PROJECT. EROSION CONTROL MEASURES AS SHOWN SHALL BE THE MINIMUM PRECAUTIONS THAT WILL BE ALLOWED. THE CONTRACTOR SHALL BE RESPONSIBLE FOR RECOGNIZING AND CORRECTING ALL EROSION CONTROL PROBLEMS THAT ARE A RESULT OF CONSTRUCTION ACTIVITIES. ADDITIONAL

ALL DISTURBED SLOPES OF 4:1 OR GREATER AND DRAINAGE SWALES SHALL BE STABILZED WITH CURLEX EROSION CONTROL FABRIC (INSTALL PER MANUFACTURER'S SPECIFICATIONS).

TIME SCHEDULE:

INSTALL INITIAL EROSION CONTROL DEVICES.

MARCH 15, 2020 — SEPT. 1, 2020 CONSTRUCT PROPOSED BUILDING, PARKING LOT, AND UTILITIES.

SEPT. 1 - OCT. 15, 2020 COMPLETE FINAL LANDSCAPING AND RESTORE ALL PERVIOUS DISTURBED AREAS.

RESTORATION NOTES:

ALL DISTURBED AREAS, EXCEPT STREET PAVEMENT AND SIDEWALK AREAS, SHALL RECEIVE A MINIMUM OF FOUR (4) INCHES OF TOPSOIL, FERTILIZER, SEED AND MULCH. RESTORATION WILL OCCUR AS SOON AFTER THE DISTURBANCE AS PRACTICAL. LAWN AREAS WITH SLOPES GREATER THAN 4:1 SHALL BE SEEDED WITH OLDS "NOMOW" MIX OR EQUAL. ALL OTHER DISTURBED AREAS SHALL BE SEEDED WITH MADISON PARKS MIX OR EQUAL. MIXTURES SHALL BE IN ACCORDANCE WITH

AN EQUAL AMOUNT OF ANNUAL RYEGRASS SHALL BE ADDED TO THE MIX. SEED MIXTURES SHALL BE APPLIED AT THE RATE OF FOUR (4) POUNDS PER 1,000 SQUARE FEET. FERTILIZER SHALL BE APPLIED AT THE RATE OF FOUR (4) POUNDS PER 1,000 SQUARE FEET. FERTILIZER SHALL MEET THE MINIMUM REQUIREMENTS THAT FOLLOW: NITROGEN, NOT LESS THAN 16%; PHOSPHORIC ACID, NOT LESS THAN 6%; POTASH, NOT LESS THAN 6%.

ALL FINISH GRADED AREAS SHALL BE SEEDED AND MULCHED BY SEPTEMBER 15TH. IF THE SITE DOES NOT HAVE FINISH GRADED AREAS COMPLETED BY OCTOBER 15TH, ALL DISTURBED AREAS SHALL BE RESTORED WITH TEMPORARY SEEDING (COVER CROP). AREAS NEEDING PROTECTION DURING PERIODS WHEN PERMANENT SEEDING IS NOT APPLIED SHALL BE SEEDED WITH ANNUAL SPECIES FOR TEMPORARY PROTECTION. SEE TABLE 1 OF THE WISCONSIN DNR CONSERVATION PRACTICE STANDARD 1059, FOR SEEDING RATES OF COMMONLY USED SPECIES. THE RESIDUE FROM THIS CROP MAY EITHER BE INCORPORATED INTO THE SOIL DURING SEEDBED PREPARATION AT THE NEXT PERMANENT SEEDING PERIOD OR LEFT ON THE SOIL SURFACE AND THE PLANTING MADE AS A

THE CONTRACTOR SHALL BE RESPONSIBLE FOR A SATISFACTORY STAND OF GRASS ON ALL SEEDED AREAS FOR ONE YEAR AFTER THE PROJECT'S FINAL ACCEPTANCE.

SCOT TROJANOWSKI 5441 S 9TH STREET MILWAUKEE, WI 5322

ENGINEER:

QUAM ENGINEERING, LLC ATTN: KEVIN PARISH 122 WISCONSIN STREET WEST BEND, WI 53095

LEGEND:

-825.00 - PROPOSED SPOT ELEVATION (EDGE OF PAVEMENT)

FF=826.00 - FIRST FLOOR ELEVATION.

EXP=822.50 - BUILDING EXPOSURE ELEVATION. - INSTALL WDOT TYPE B

INLET PROTECTION. -EX=702.40 - EXISTING SPOT ELEVATION

PROPOSED SPOT ELEVATION

-SW=705.00 - SIDEWALK ELEVATION

-EP=705.00 - EDGE OF PAVEMENT ELEVATION

-TC=705.00 - TOP OF CURB ELEVATION

- SILT FENCE

INDICATES REJECT CURB

- INDICATES MOUNTABLE CURB


INDICATES ACCEPT CURB


ZT DISTRIBUTION - VENTURE COURT GRADING & EROSION CONTROL PLAN

C - 102



122 Wisconsin Street; West Bend, Wisconsin 53095 Phone (262) 338-6641; www.quamengineering.com

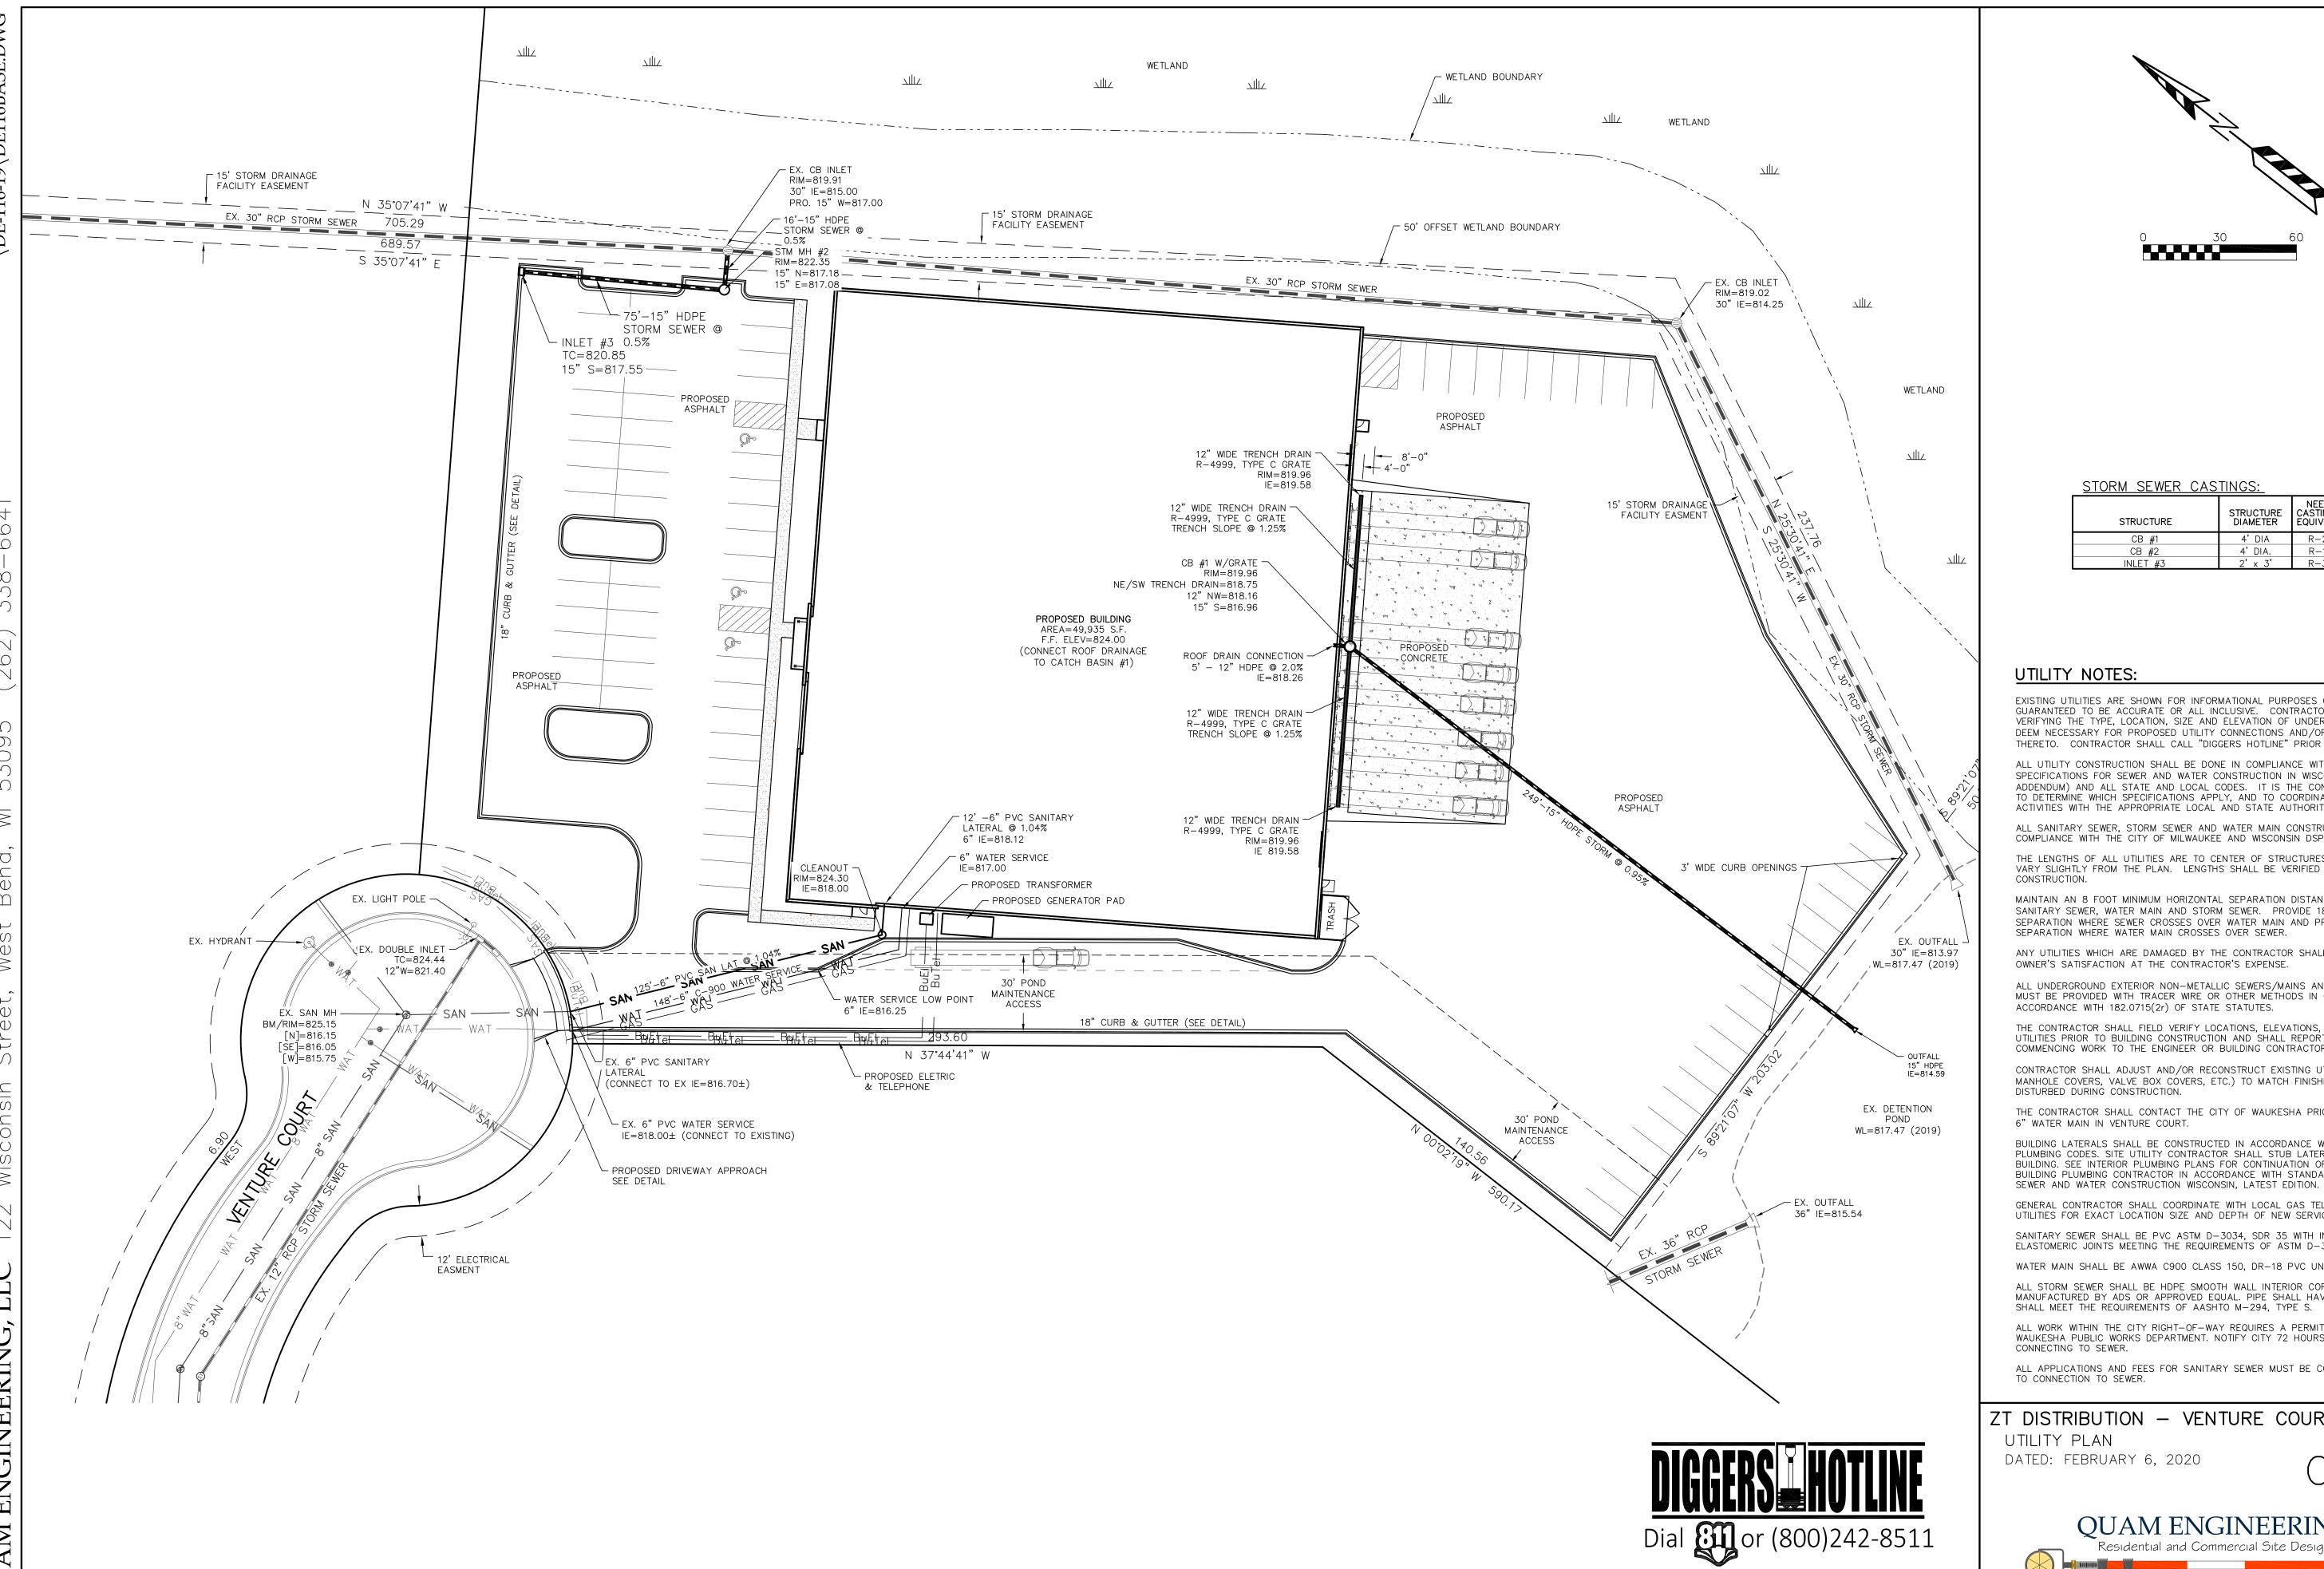

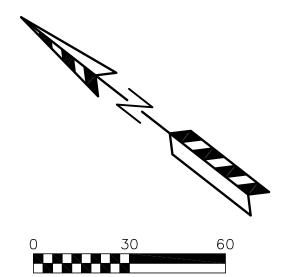

STORM SEWER CASTINGS:

STRUCTURE	STRUCTURE DIAMETER	NEENAH CASTING OR EQUIVALENT
CB #1	4'DIA	R-2540
CB #2	4' DIA.	R-1550
INLET #3	2' x 3'	R-3067

UTILITY NOTES:

EXISTING UTILITIES ARE SHOWN FOR INFORMATIONAL PURPOSES ONLY AND ARE NOT GUARANTEED TO BE ACCURATE OR ALL INCLUSIVE. CONTRACTOR IS RESPONSIBLE FOR VERIFYING THE TYPE, LOCATION, SIZE AND ELEVATION OF UNDERGROUND UTILITIES AS THEY DEEM NECESSARY FOR PROPOSED UTILITY CONNECTIONS AND/OR TO AVOID DAMAGE THERETO. CONTRACTOR SHALL CALL "DIGGERS HOTLINE" PRIOR TO ANY CONSTRUCTION.

ALL UTILITY CONSTRUCTION SHALL BE DONE IN COMPLIANCE WITH THE STANDARD SPECIFICATIONS FOR SEWER AND WATER CONSTRUCTION IN WISCONSIN (LATEST EDITION AND ADDENDUM) AND ALL STATE AND LOCAL CODES. IT IS THE CONTRACTORS RESPONSIBILITY TO DETERMINE WHICH SPECIFICATIONS APPLY, AND TO COORDINATE ALL CONSTRUCTION ACTIVITIES WITH THE APPROPRIATE LOCAL AND STATE AUTHORITIES.

ALL SANITARY SEWER, STORM SEWER AND WATER MAIN CONSTRUCTION SHALL BE IN COMPLIANCE WITH THE CITY OF MILWAUKEE AND WISCONSIN DSPS STANDARDS.

THE LENGTHS OF ALL UTILITIES ARE TO CENTER OF STRUCTURES OR FITTINGS AND MAY VARY SLIGHTLY FROM THE PLAN. LENGTHS SHALL BE VERIFIED IN THE FIELD DURING

MAINTAIN AN 8 FOOT MINIMUM HORIZONTAL SEPARATION DISTANCE BETWEEN PUBLIC SANITARY SEWER, WATER MAIN AND STORM SEWER. PROVIDE 18" MINIMUM VERTICAL SEPARATION WHERE SEWER CROSSES OVER WATER MAIN AND PROVIDE 6" MINIMUM VERTICAL SEPARATION WHERE WATER MAIN CROSSES OVER SEWER.

ANY UTILITIES WHICH ARE DAMAGED BY THE CONTRACTOR SHALL BE REPAIRED TO THE OWNER'S SATISFACTION AT THE CONTRACTOR'S EXPENSE.

ALL UNDERGROUND EXTERIOR NON-METALLIC SEWERS/MAINS AND WATER SERVICES/MAINS MUST BE PROVIDED WITH TRACER WIRE OR OTHER METHODS IN ORDER TO BE LOCATED IN ACCORDANCE WITH 182.0715(2r) OF STATE STATUTES.

THE CONTRACTOR SHALL FIELD VERIFY LOCATIONS, ELEVATIONS, AND SIZES OF ALL EXISTING UTILITIES PRIOR TO BUILDING CONSTRUCTION AND SHALL REPORT DISCREPANCIES PRIOR TO COMMENCING WORK TO THE ENGINEER OR BUILDING CONTRACTOR.

CONTRACTOR SHALL ADJUST AND/OR RECONSTRUCT EXISTING UTILITY COVERS (SUCH AS MANHOLE COVERS, VALVE BOX COVERS, ETC.) TO MATCH FINISHED GRADES OR THE AREAS DISTURBED DURING CONSTRUCTION.

THE CONTRACTOR SHALL CONTACT THE CITY OF WAUKESHA PRIOR TO CONNECTING TO THE 6" WATER MAIN IN VENTURE COURT.

BUILDING LATERALS SHALL BE CONSTRUCTED IN ACCORDANCE WITH LOCAL AND STATE PLUMBING CODES. SITE UTILITY CONTRACTOR SHALL STUB LATERAL TO 5 FEET OUTSIDE BUILDING. SEE INTERIOR PLUMBING PLANS FOR CONTINUATION OF PIPING INTO BUILDING BY BUILDING PLUMBING CONTRACTOR IN ACCORDANCE WITH STANDARD SPECIFICATIONS FOR

GENERAL CONTRACTOR SHALL COORDINATE WITH LOCAL GAS TELEPHONE, AND ELECTRICAL UTILITIES FOR EXACT LOCATION SIZE AND DEPTH OF NEW SERVICE.

SANITARY SEWER SHALL BE PVC ASTM D-3034, SDR 35 WITH INTEGRAL BELL TYPE ELASTOMERIC JOINTS MEETING THE REQUIREMENTS OF ASTM D-3212.

WATER MAIN SHALL BE AWWA C900 CLASS 150, DR-18 PVC UNLESS INDICATED OTHERWISE.

ALL STORM SEWER SHALL BE HDPE SMOOTH WALL INTERIOR CORRUGATED PIPE AS MANUFACTURED BY ADS OR APPROVED EQUAL. PIPE SHALL HAVE WATERTIGHT JOINTS AND SHALL MEET THE REQUIREMENTS OF AASHTO M-294, TYPE S.

ALL WORK WITHIN THE CITY RIGHT-OF-WAY REQUIRES A PERMIT FROM THE CITY OF WAUKESHA PUBLIC WORKS DEPARTMENT. NOTIFY CITY 72 HOURS IN ADVANCE OF CONNECTING TO SEWER.

ALL APPLICATIONS AND FEES FOR SANITARY SEWER MUST BE COMPLETED AND PAID PRIOR TO CONNECTION TO SEWER.


ZT DISTRIBUTION - VENTURE COURT

UTILITY PLAN DATED: FEBRUARY 6, 2020

www.DiggersHotline.com

C - 103



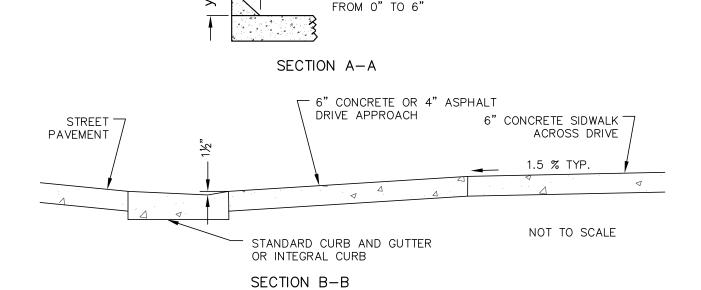


FROM O" AT THE SIDEWALK TO


THE VALUE FOR Y WILL VARY

1.5' AT THE CURB


NOTE: DRIVEWAYS 10' TO 20' WIDE SHALL HAVE ONE & JOINT. DRIVEWAYS 21' TO 30' WIDE SHALL HAVE TWO & JOINTS EQUALLY SPACED. 1/2"X 6" EXPANSION JOINT AT THE FACE OF WALK AND BACK OF CURB IS REQUIRED ONLY FOR CONCREETE DRIVE APPROACH FLARE WIDTH, 3' MIN. TO 5' MAX. (CAN BE WIDER WITH APPROVAL OF THE CITY(ENGINEER) 8" CONCRETE ALLOWED FOR APPROACH AND SIDEWALK FOR HEAVY TRAFFIC. $\pm 0.5\%$ Construction tolerance in Sidewalk cross—slope. Cross—slope shall not exceed 2%

TYPICAL DETAIL OF STANDARD DRIVE APPROACH

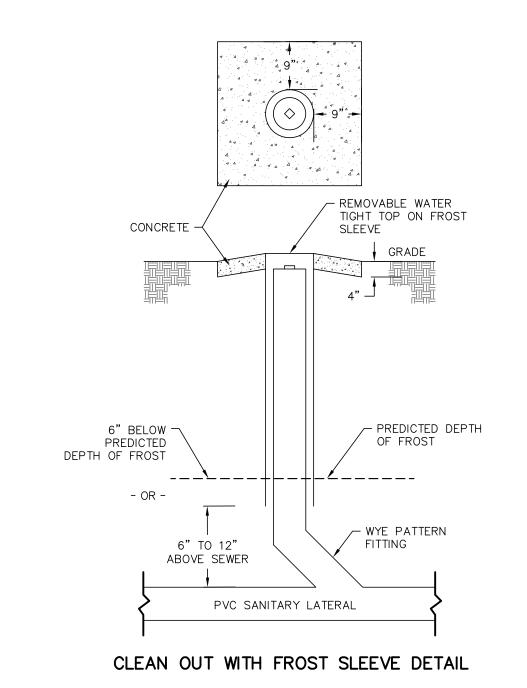

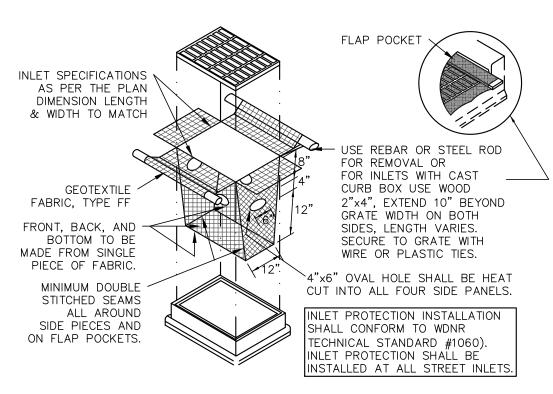


TYPE D INLET PROTECTION DETAIL

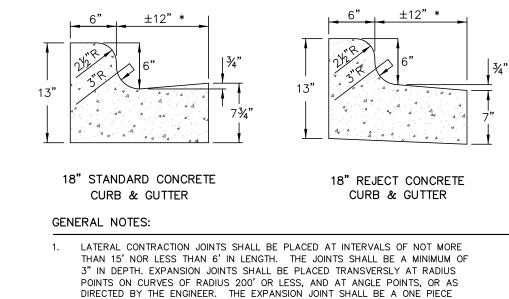


OF THE STANSION JOINTS SHALL BE PLACED TRANSVERSLY AT RADIUS POINTS ON CURVES OF RADIUS 200' OR LESS, AND AT ANGLE POINTS, OR AS DIRECTED BY THE ENGINEER. THE EXPANSION JOINT SHALL BE A ONE PIECE ASPHALTIC MATERIAL HAVING THE SAME DIMENSIONS AS CURB & GUTTER AT THAT STATION AND BE 1/2" THICK. IN ALL CASES, CONCRETE CURB & GUTTER SHALL BE PLACED ON THOROUGHLY COMPACTED CRUSHED STONE. 2. * CURB APRON ±12" TO FIT STANDARD CURB MACHINE

18" CURB AND GUTTER DETAILS

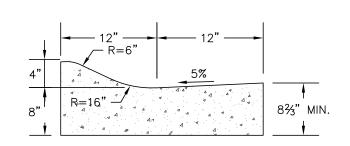



TYPICAL MOUNTABLE CURB SECTION DETAIL

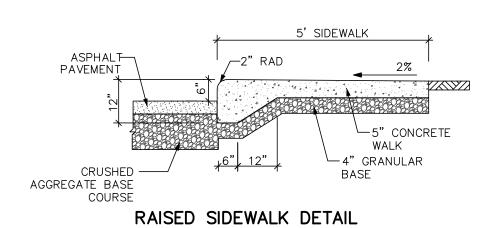


TECHNICAL STANDARD #1057) 3"-6" CLEAR STONE STONE TRACKING PAD DETAIL


STONE TRACKING PAD INSTALLATION SHALL CONFORM TO WISCONSIN DNR

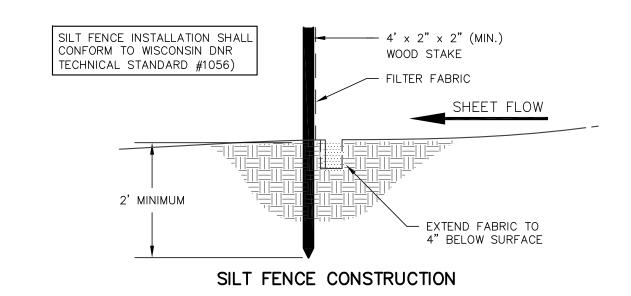

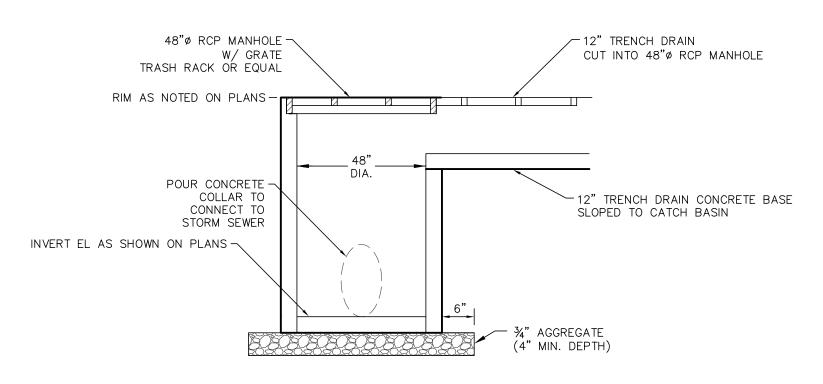

48" CATCH BASIN W/ GRATE & TRENCH DRAIN CONNECTION DETAIL

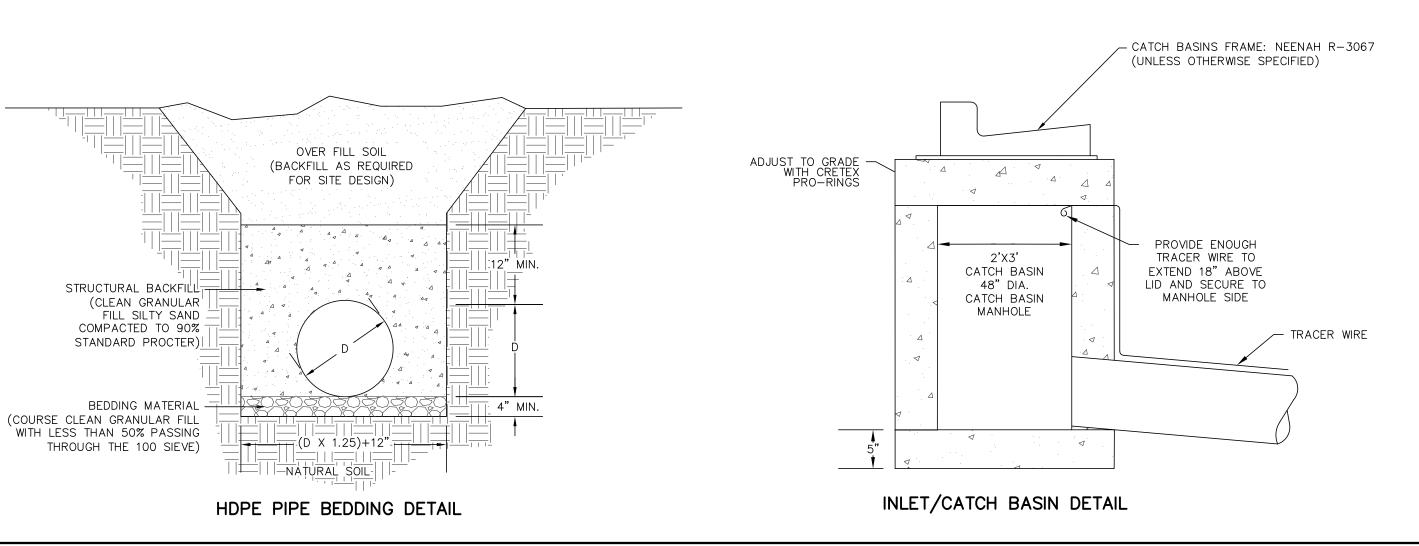

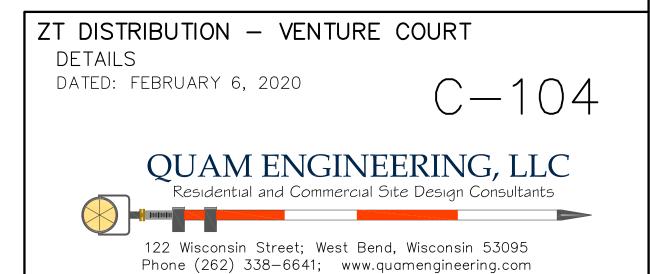

SITE GENERAL NOTES:

- 1. PROPOSED BUILDING IS ONE STORY.
- 2. MAXIMUM % GRADE AT RIGHT-OF-WAY TO BE 8%.
- 3. DUMPSTER ENCLOSURE TO BE LOCATED AS SHOWN ON PLAN. EXACT SIZE OF DUMPSTER ENCLOSURE TO BE DETERMINED PER OWNER'S REQUIREMENTS.
- 4. SEE GRADING PLAN FOR ALL PROPOSED AND EXISTING CONTOURS AND STORM WATER DRAINAGE PATTERNS.
- 5. ALL ROOF TOP MECHANICAL UNITS TO BE PAINTED TO MATCH BUILDING.
- S. SEE LANDSCAPE PLAN FOR ALL PLANTING LOCATIONS.
- 7. ALL EXTERIOR LIGHTING FIXTURES TO BE CUT-OFF TYPE.
- 8. ALL SITE UTILITIES TO BE VERIFIED W/ PROPER AGENCIES PRIOR TO CONSTRUCTION.
- 9. ALL APPROACHES & CULVERTS IN RIGHT-OF-WAY TO BE VERIFIED W/LOCAL MUNICIPALITY PRIOR TO CONSTRUCTION.

MODIFY NOTES AS REQUIRED FOR ACTUAL PROJECT

(REFER TO UNDERLINED AND NUMBERED AREAS) AND DELETE EXTRA NOTES

SITE DATA:

SITE AREA:	762,943 SF 17.51 ACRES
AREA OF PROPOSED BUILDING:	49,920 SF
TOTAL BUILDING FOOTPRINT:	49,920 SF
TOTAL HARD SURFACE AREA: CONCRETE AREA: HEAVY DUTY PAVING: LIGHT DUTY PAVING:	82,390 SF 1,350 SF 65,318 SF 15,722 SF
TOTAL GREEN SPACE AREA:	630,633 SF (82.7% OF SITE)

ZONING DISTRICT: C-1 (LOWLAND CONSERVANCY, M-3 (LIMITED BUSINESS AND INDUSTRIAL PARK)

ALLOWABLE BUILDING HEIGHT: 50'-0"
BUILDING HEIGHT: 33'-0"
FRONT YARD SETBACK: 40'-0"

SIDE YARD SETBACK: 40'-0"
SIDE YARD SETBACK: 10'-0"
REAR YARD SETBACK: 10'-0"

PARKING STALL REQUIREMENTS:
OFFICE: ***/1,000 SF***

OFFICE: ***/1,000 SF***
FACTORY: ***/1,000 SF***
TOTAL # OF STALLS REQ'D: ***


TOTAL PARKING PROVIDED:
HANDICAP PARKING REQUIRED:

79 (INCL. H.C. STALLS)

HANDICAP PARKING PROVIDED: FUTURE PARKING STALLS:

MODIFY NOTES AS REQUIRED FOR ACTUAL PROJECT

(REFER TO UNDERLINED AND NUMBERED AREAS) AND DELETE EXTRA NOTES

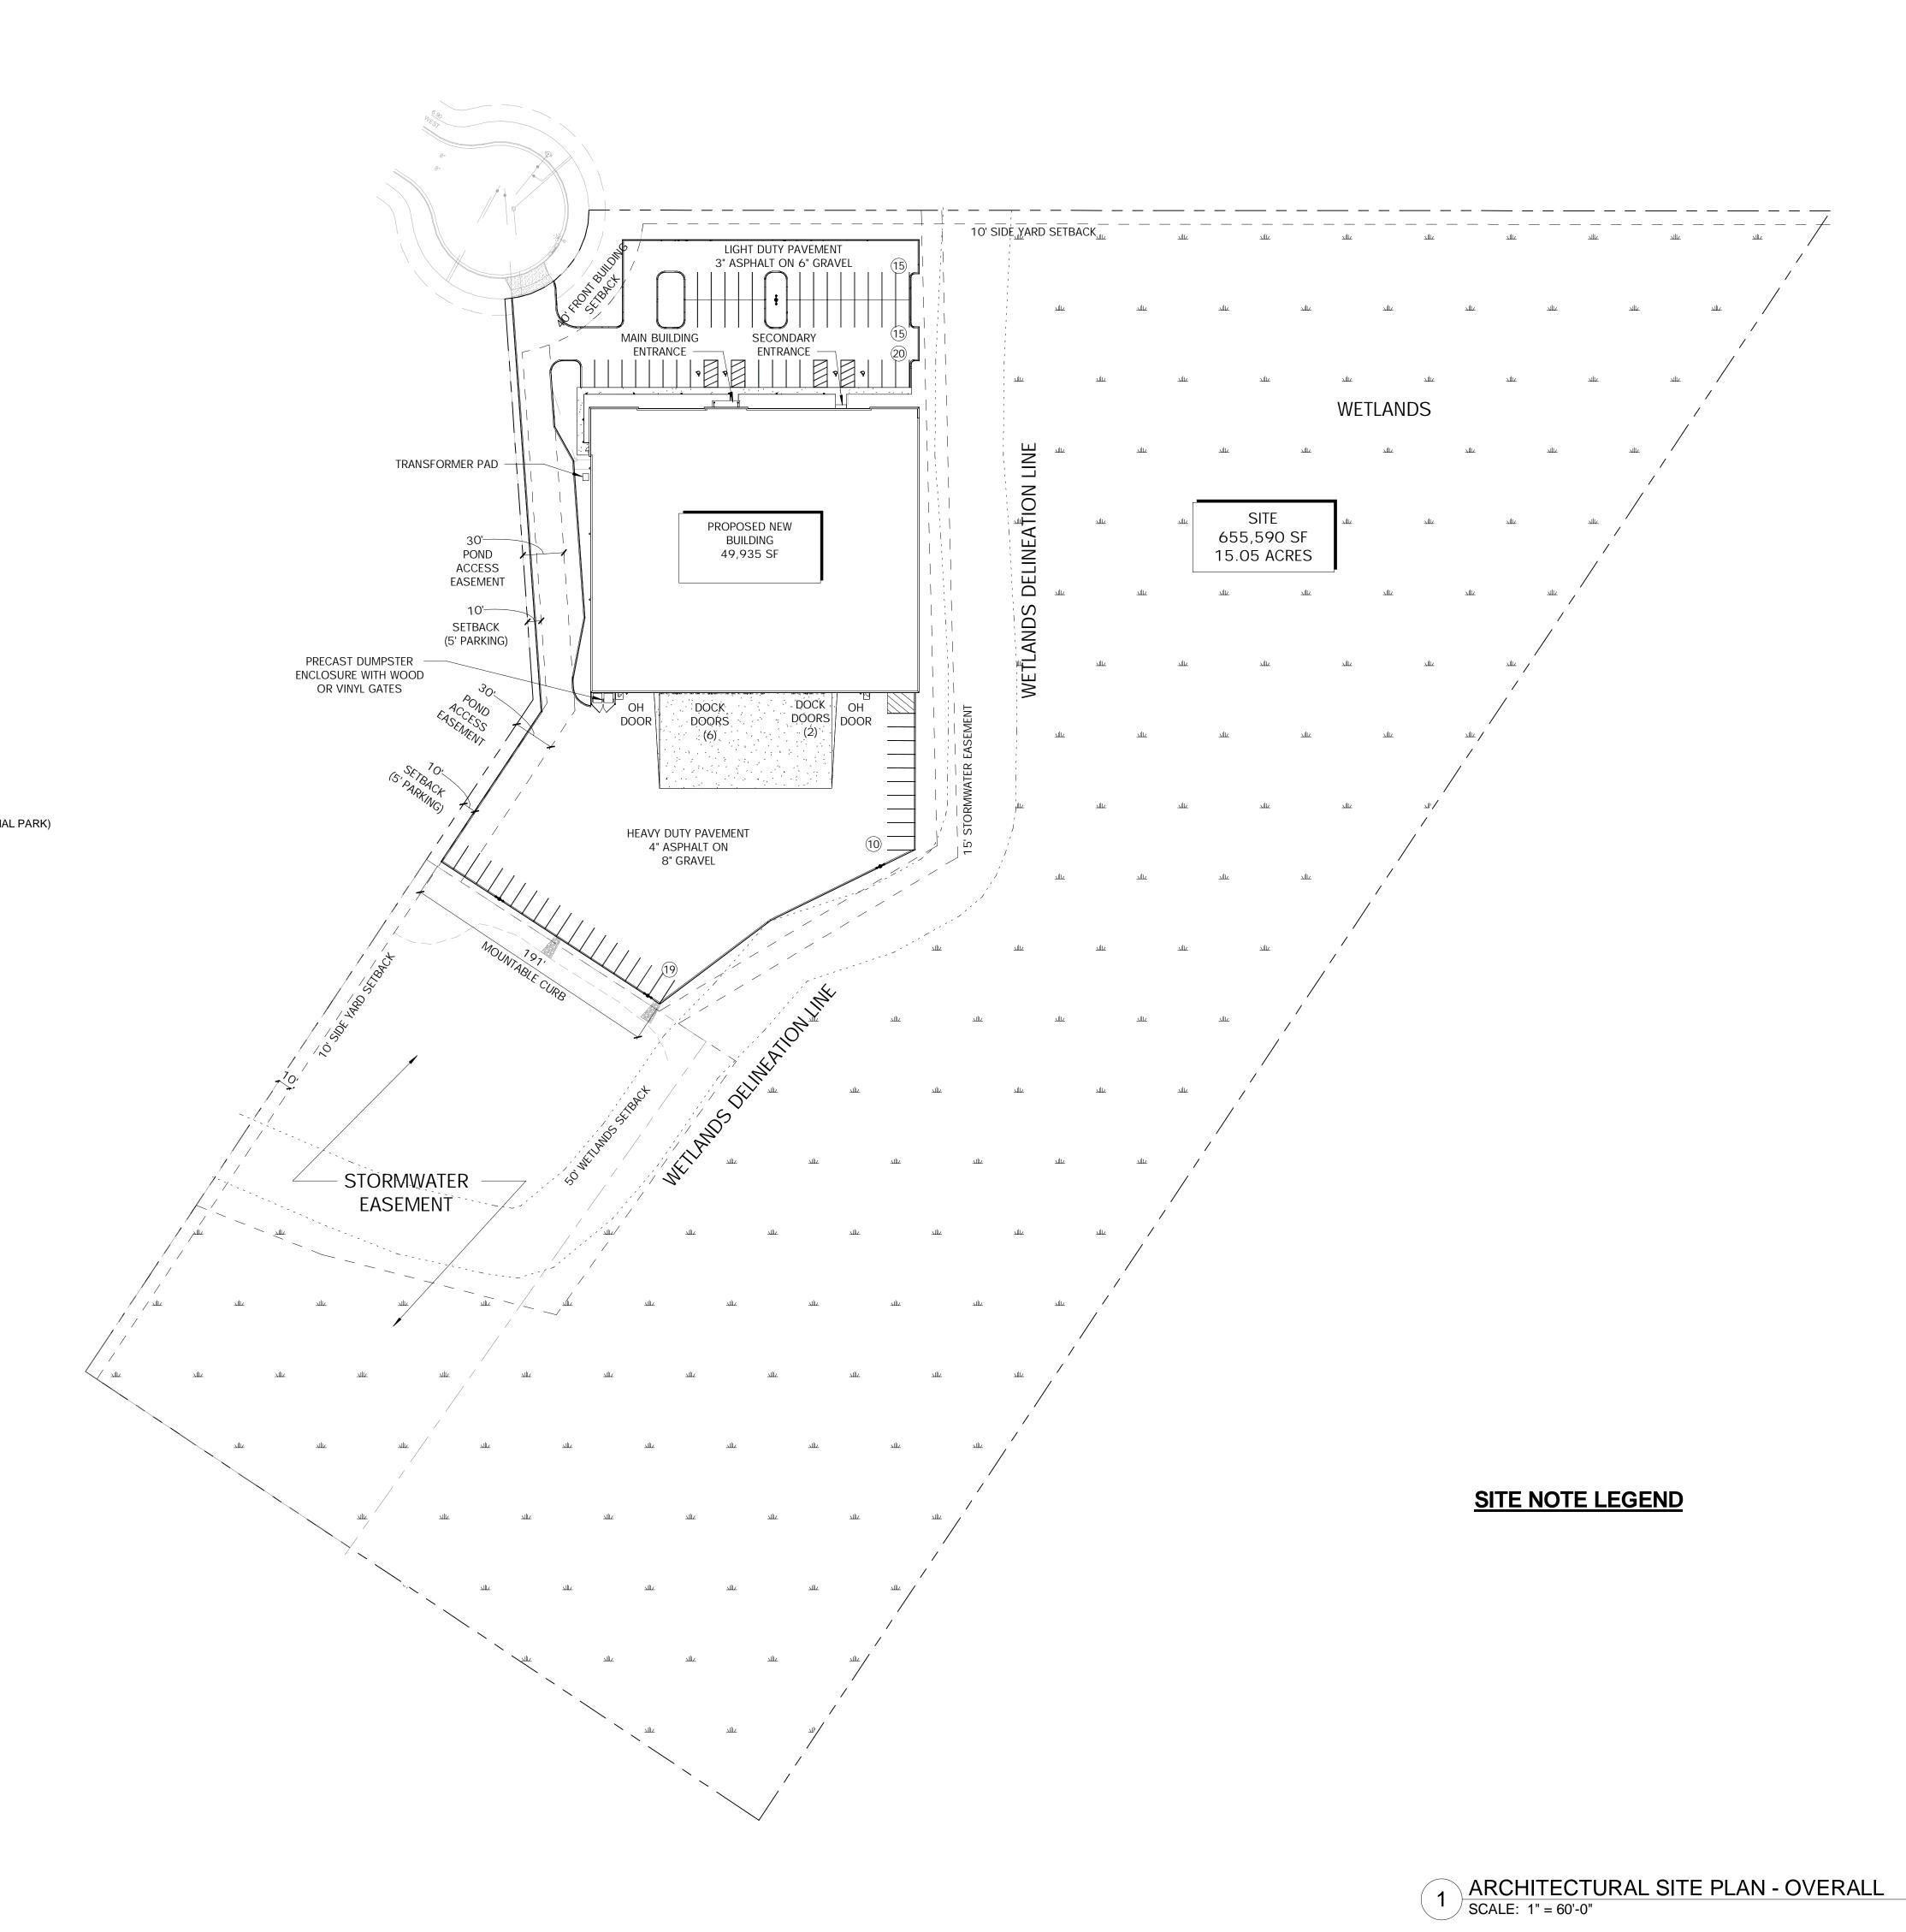



PHONE 262.677.9933

FAX 262.677.9934

info@design2construct.com

BUILDING DESIGN FOR:
PROPOSAL 19-00201

SHEET TITLE

ARCHITECTURAL SITE PLAN

REVISIONS

PROJECT DATA

DATE


02.11.2020

JOB NO.


19-00201
SET USE
PRELIMINARY
DRAWN BY

SHEET NO.

A1.0

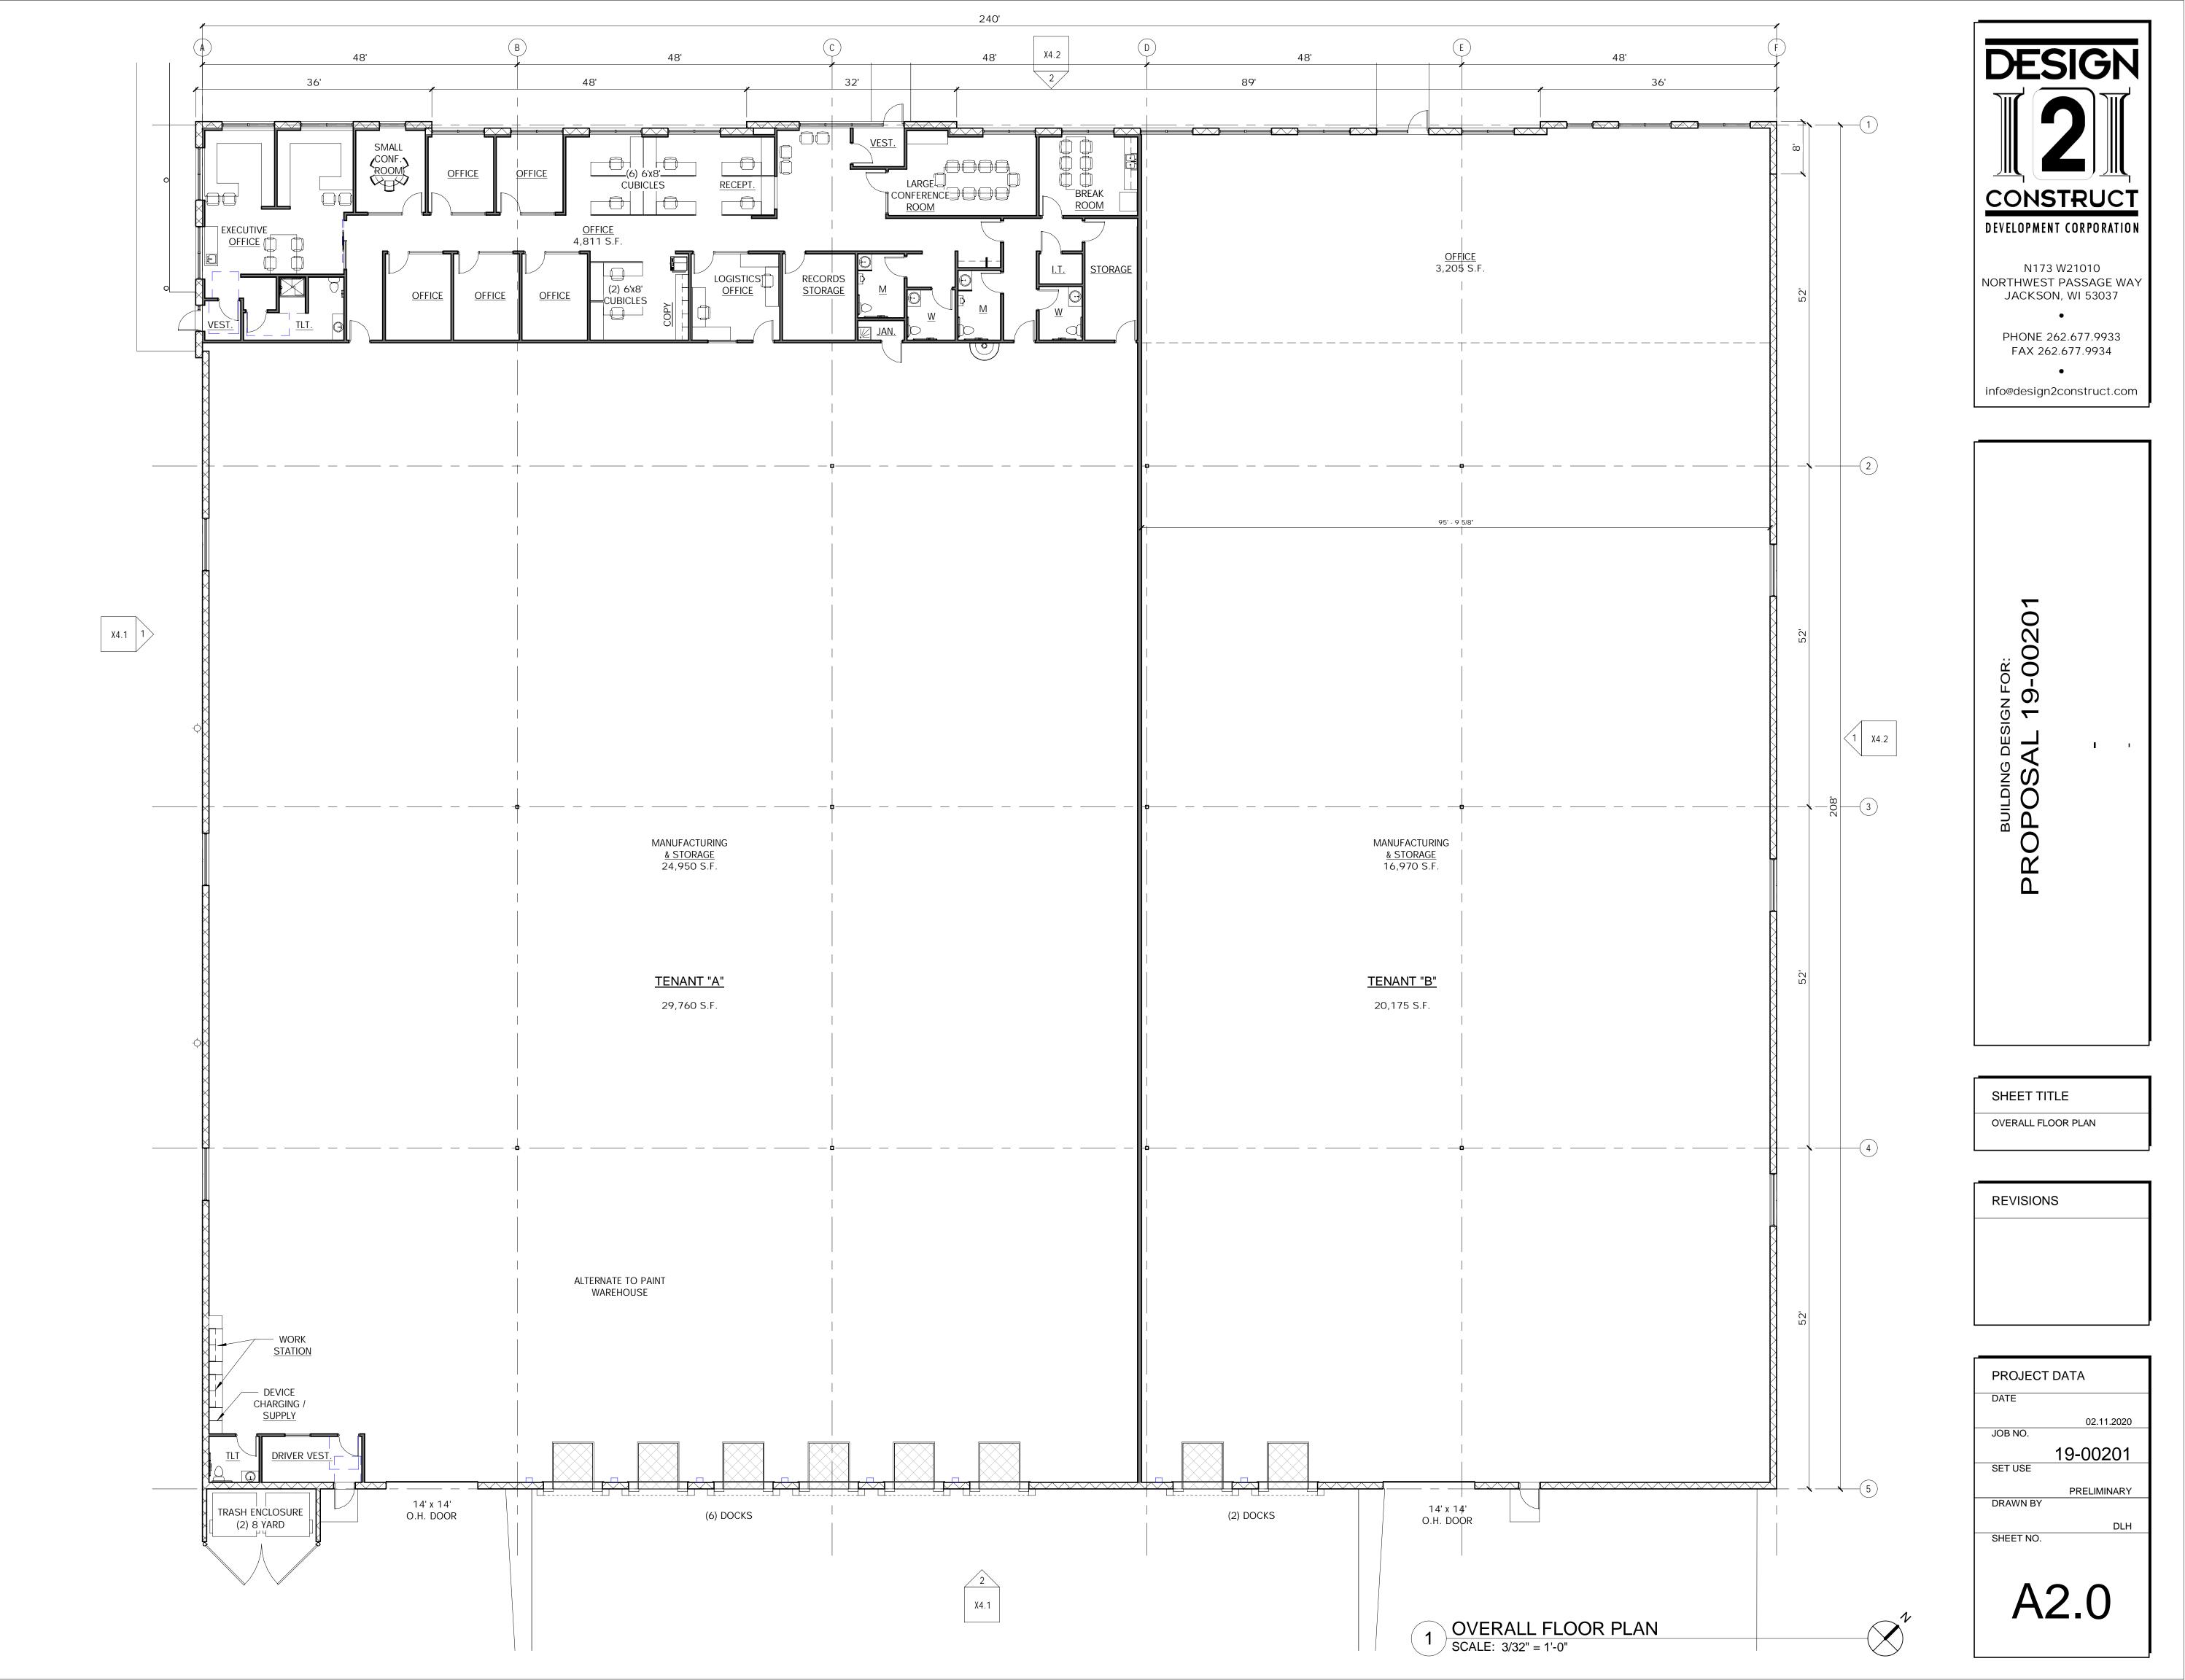

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KEY PLAN C 48' 32' 12' VESTIBULE 50' (6) 6'x8' CUBICLES **RECEPTION** LARGE CONFERENCE BREAK ROOM ROOM OPEN OFFICE RECORD STORAGE (2) 6'x8' CUBICLES LOGISTICS <u>STORAGE</u> WAREHOUSE (24,950 SF)
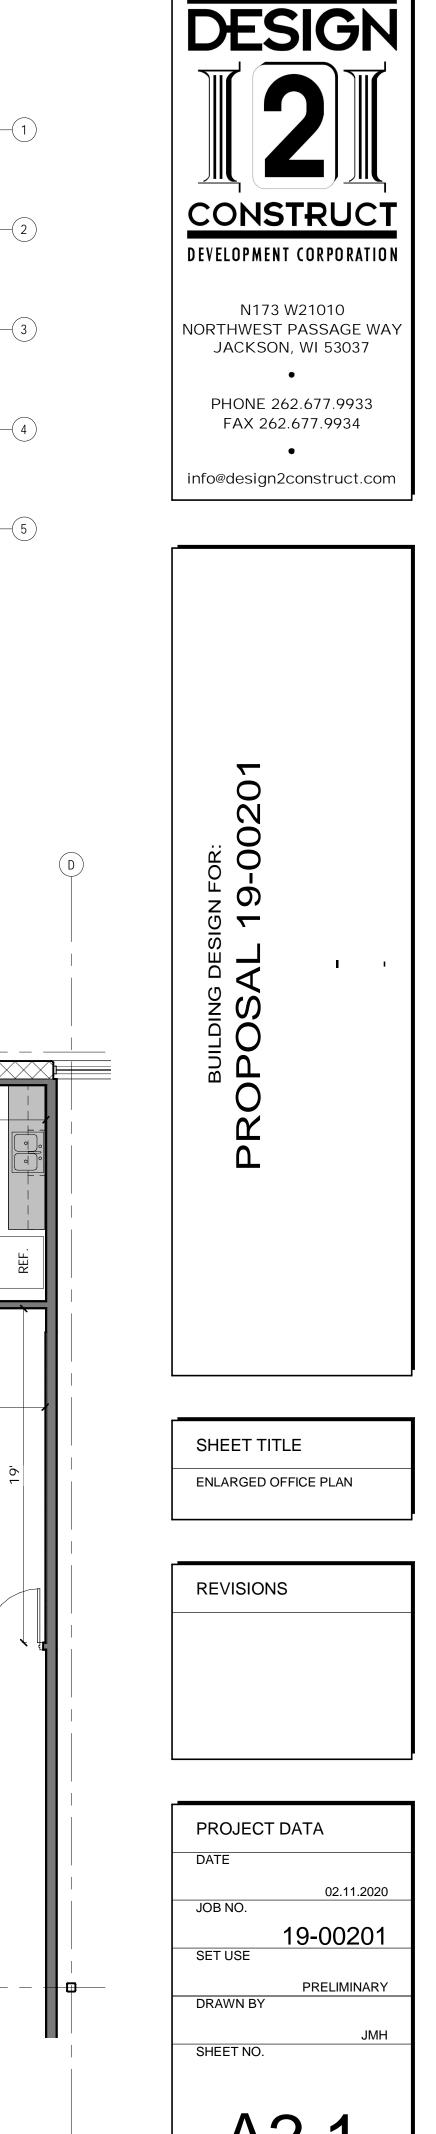
> 1 ENLARGED OFFICE PLAN SCALE: 3/16" = 1'-0"

24'

OFFICE AREA (4,811 SF)

<u>OFFICE</u>

10'

OFFICE

10'

/SMALL CONFERENCE ROOM/

OFFICE

10'


EXECUTIVE OFFICE


<u>VESTIBULE</u>

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ELEVATION NOTE LEGEND

- PREFINISHED METAL COPING
- PAINTED PRECAST CONCRETE WALL PANEL WHITE
- PAINTED PRECAST CONCRETE WALL PANEL RED
- PAINTED PRECAST CONCRETE WALL PANEL LIGHT
- PAINTED PRECAST CONCRETE WALL PANEL DARK GREY PRECASE CONCRETE WALL PANEL REVEAL
- SPANDREL GLAZING
- PREFINISHED THERMALLY BROKEN STOREFRONT SYSTEM w/ INSULATED GLASS
- PREFINISHED METAL CANOPY
- PREFINISHED THERMALLY BROKEN ALUMINUM FRAME w/ INSULATED GLASS INSULATED HOLLOW METAL DOOR AND FRAME (PAINTED)
- 14' x 14' PREFINISHED STEEL INSULATED OVERHEAD DOOR
- 9' x 10" PREFINISHED STEEL INSULATED OVERHEAD DOOR w/ DOCK SEAL
- LED WALL-PAK LIGHT FIXTURE
- TRASH ENCLOSURE PRECAST WALLS WITH WOOD OR
 - VINYL GATE



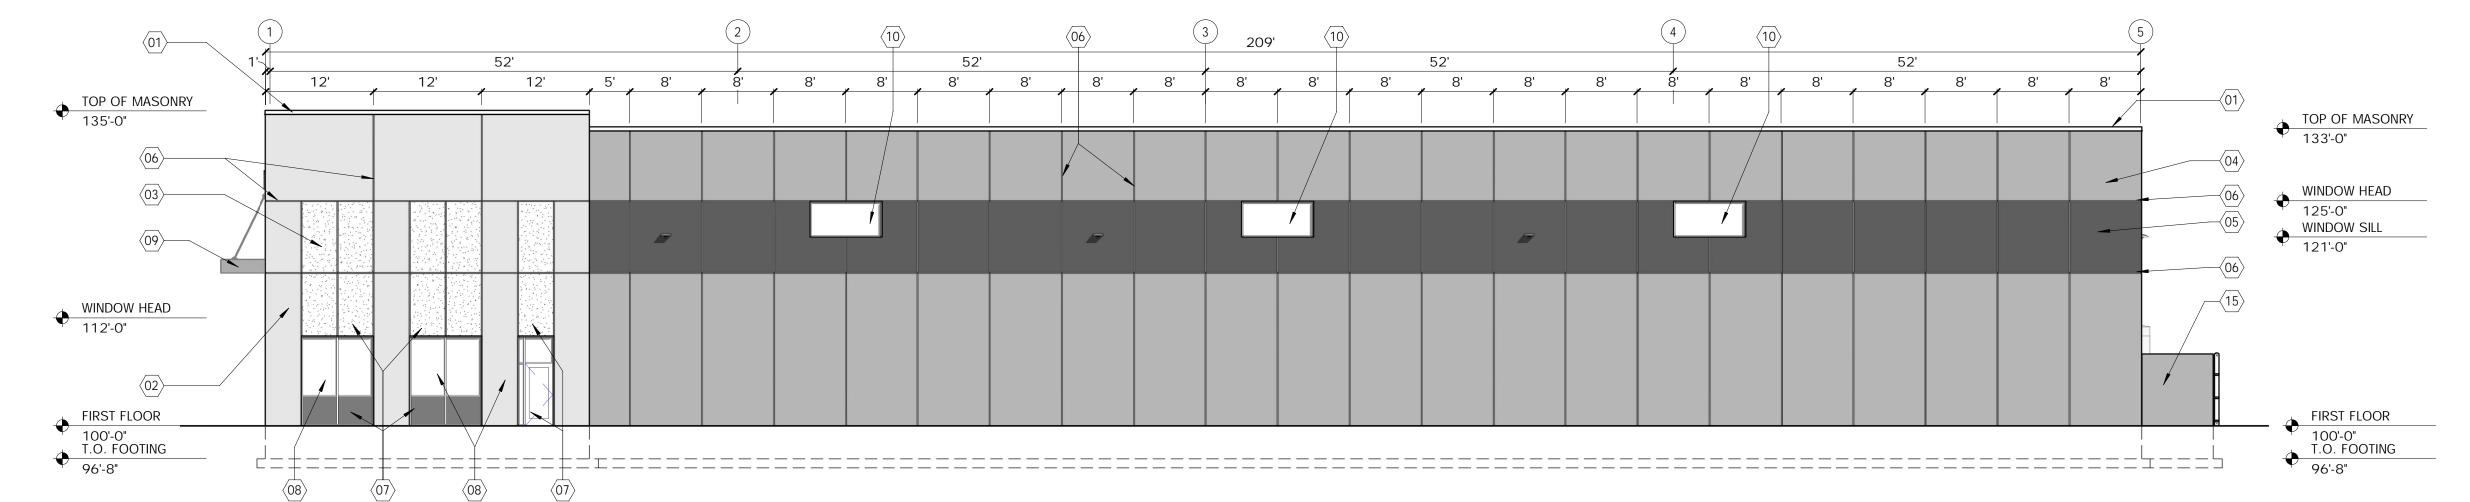

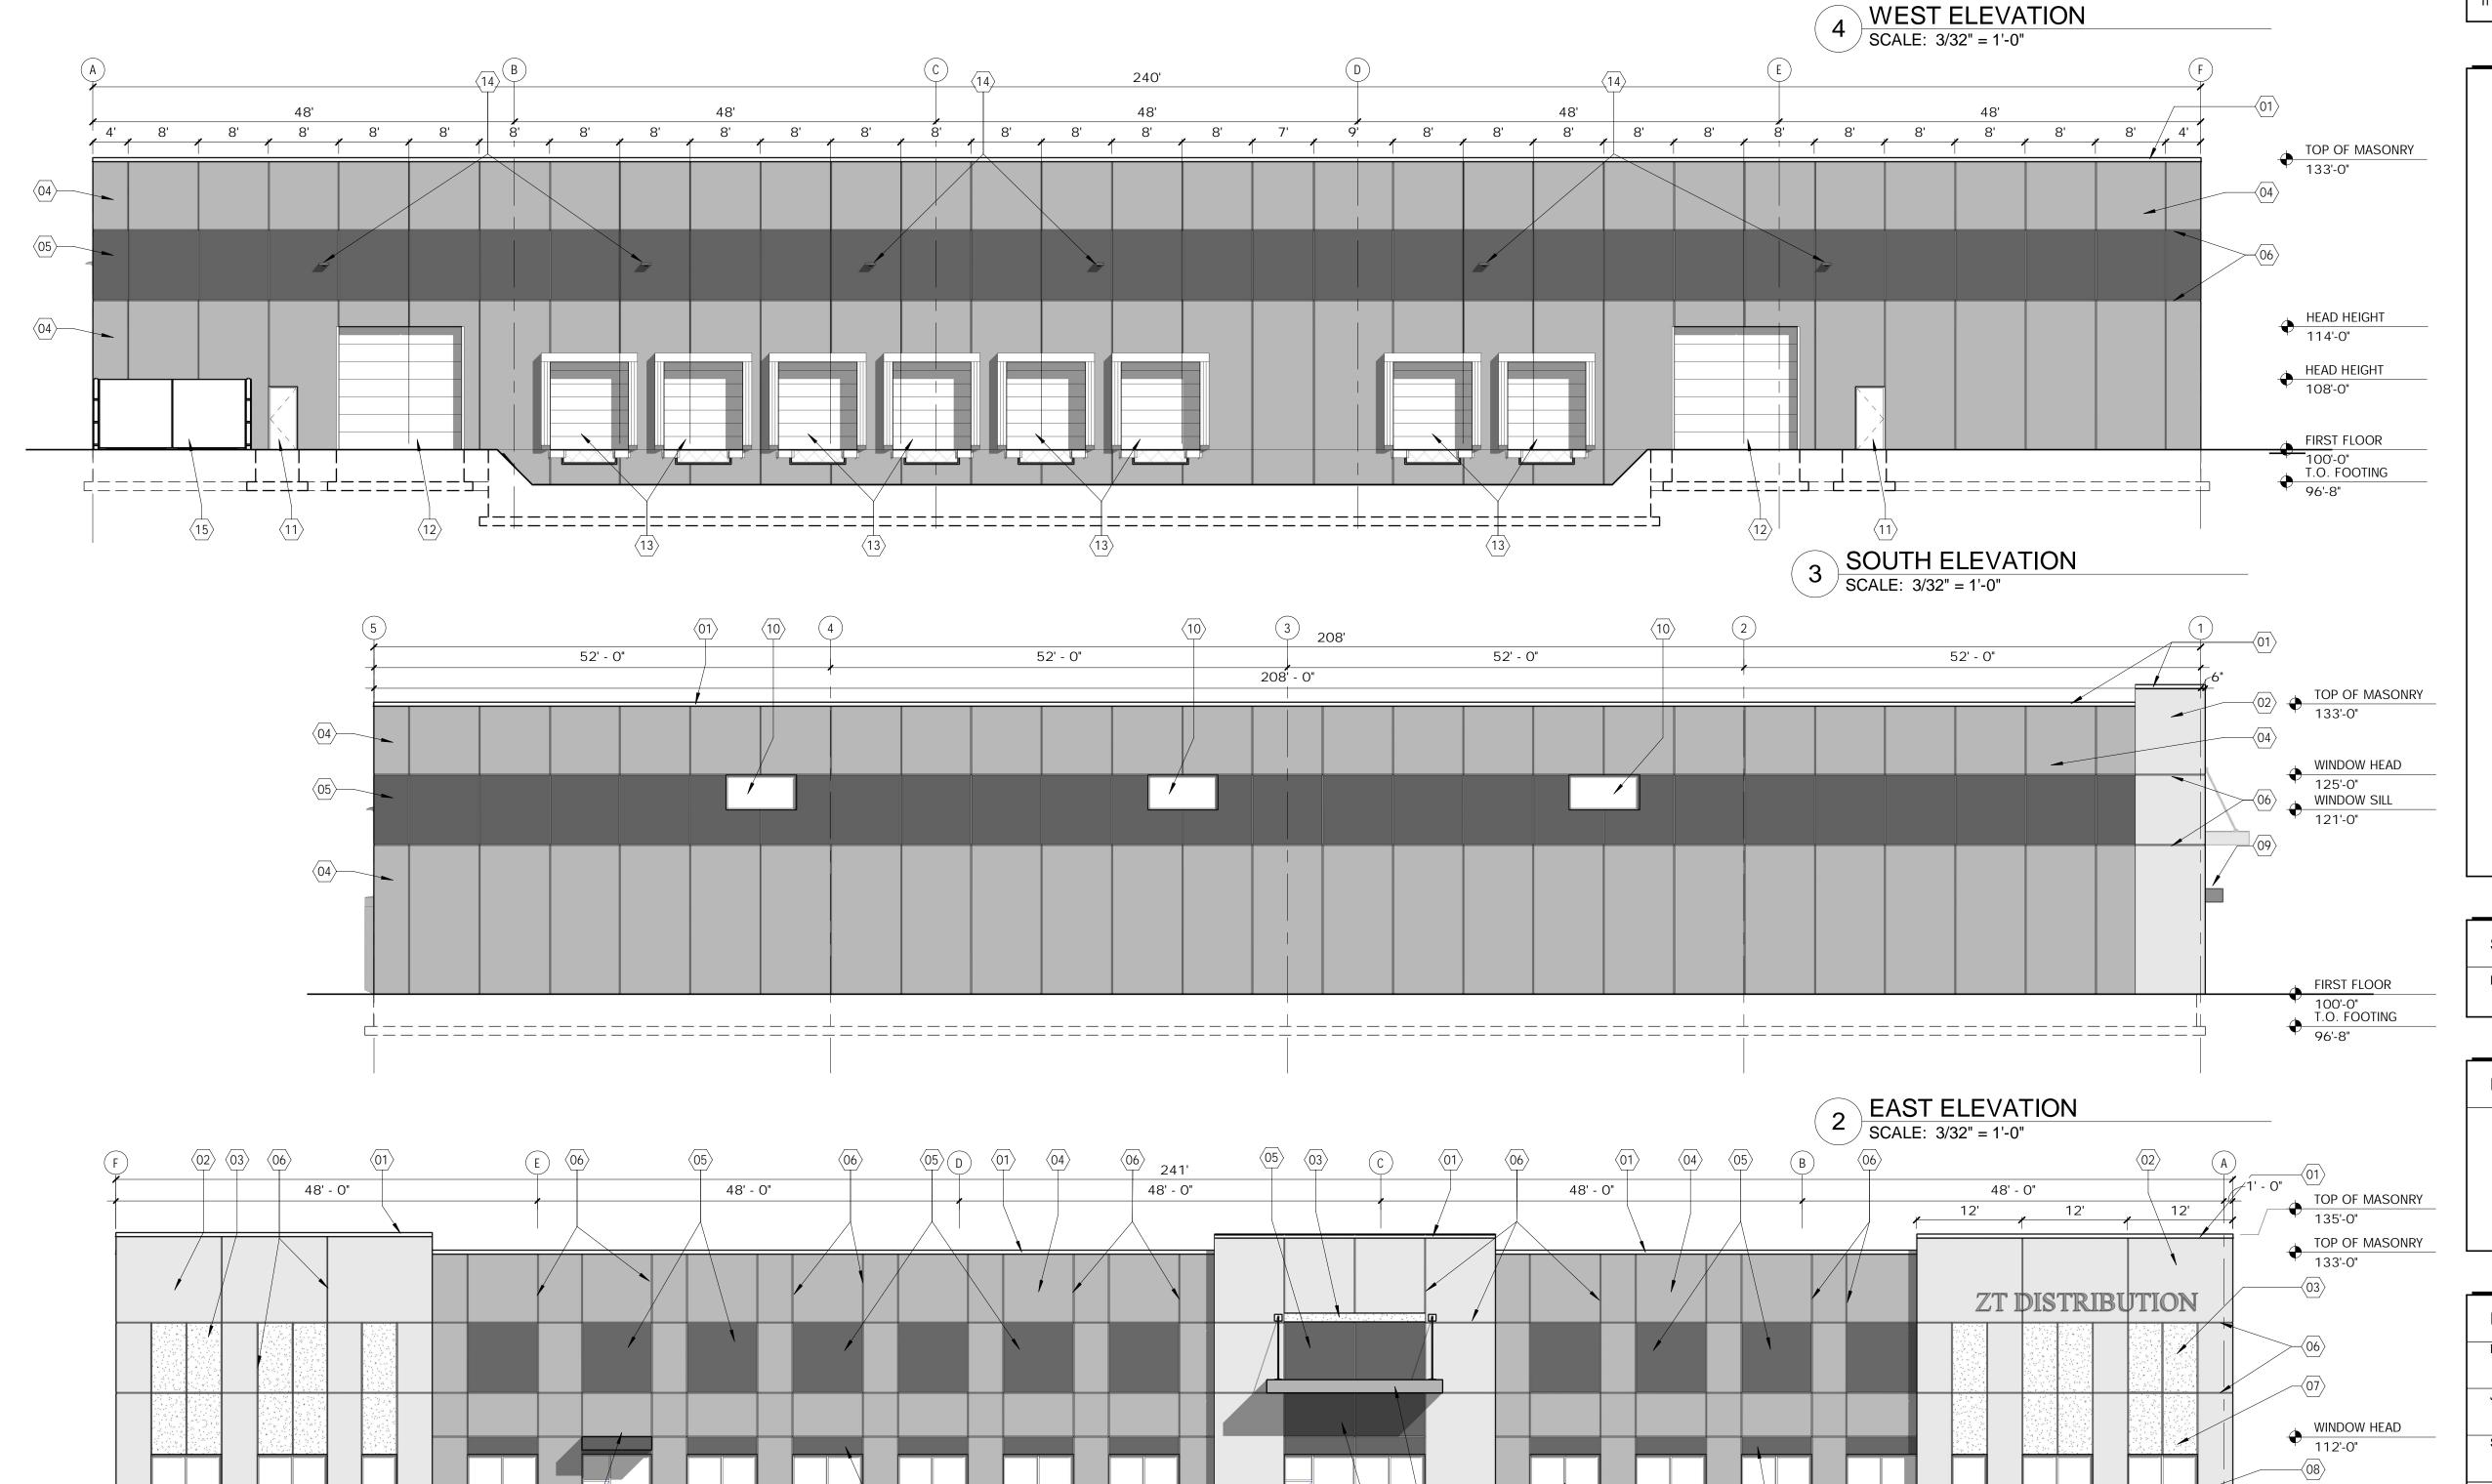 $\langle 09 \rangle \qquad \langle 04 \rangle$






SHEET TITLE EXTERIOR ELEVATIONS

REVISIONS

PROJECT DATA 02.11.2020 JOB NO. 19-00201 SET USE PRELIMINARY DRAWN BY SHEET NO.


FIRST FLOOR

100'-0" T.O. FOOTING

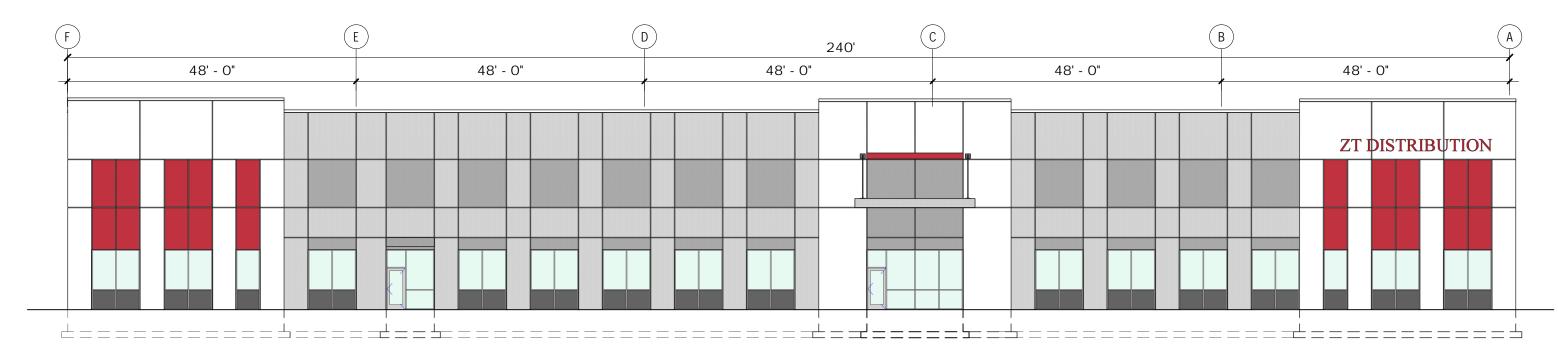

NORTH ELEVATION

SCALE: 1/16" = 1'-0"

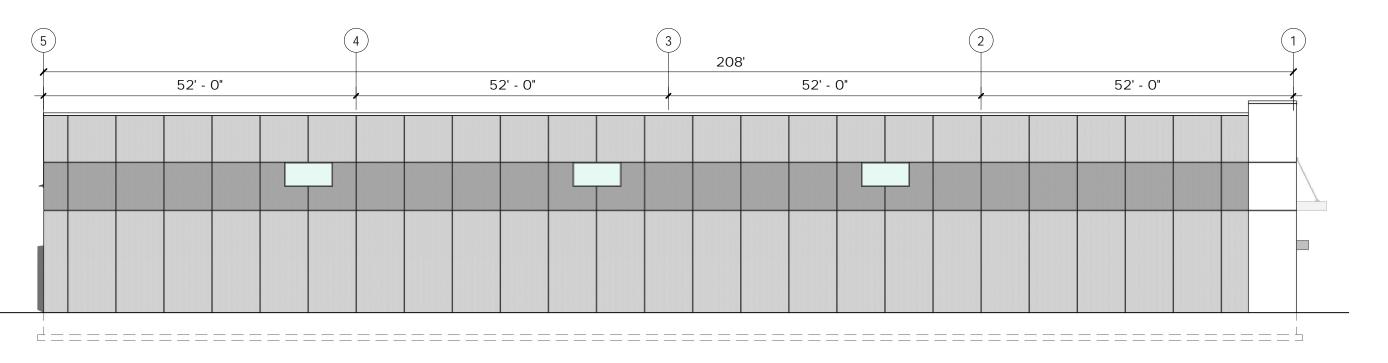

2 CONSTRUCT


EAST ELEVATION

DESIGN 2 CONSTRUCT

SCALE: 1/16" = 1'-0"


N173 W21010 Northwest Passage, Jackson, WI 53037

PHONE: 262.677.9933 FAX: 262.677.9934

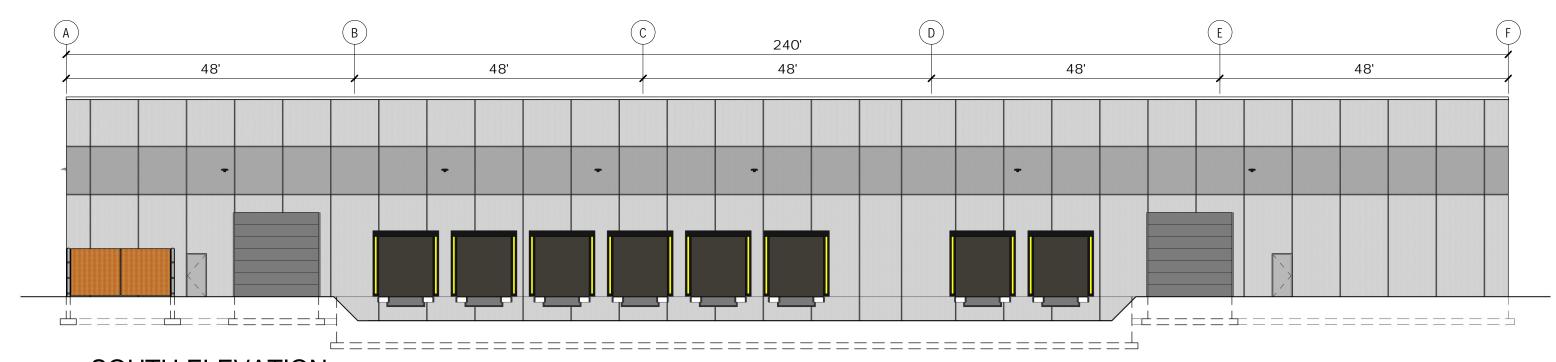

SOUTH ELEVATION

SCALE: 1/16" = 1'-0"

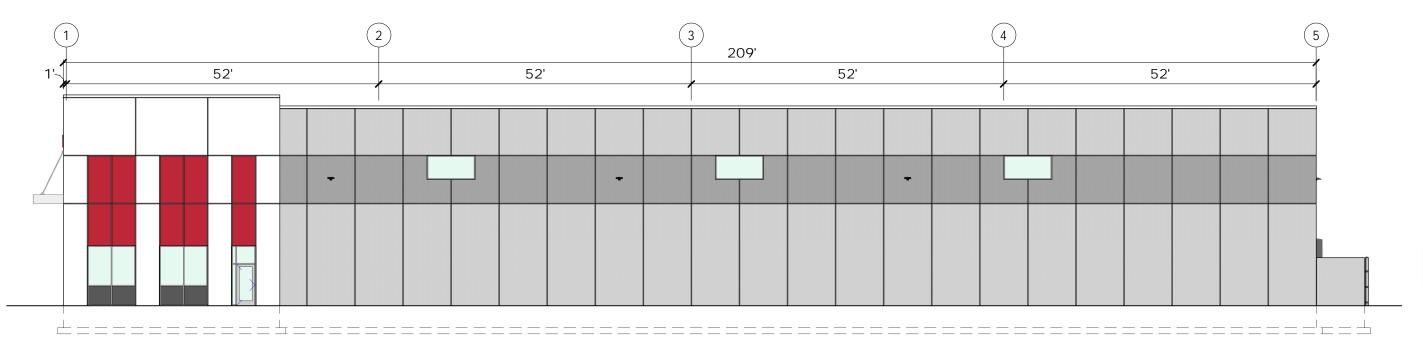

N173 W21010 Northwest Passage, Jackson, WI 53037

WEST ELEVATION

SCALE: 1/16" = 1'-0"

DESIGN 2 CONSTRUCT

PHONE: 262.677.9933 FAX: 262.677.9934









PLANT SCHEDULE

CANOPY	TREES	(INSTALL	IN	ACCORDANCE	WITH DETAIL	1/L2.0)

CODE	SCIENTIFIC NAME	COMMON NAME	QTY.	PLANTING SIZE	MATURE SIZE
ACFAF	Acer x freemanıı 'Autumn Fantasy'	Autumn Fantasy Maple	3	2.5" Cal. B&B	H-50', W-30'
ACMSS	Acer miyabei 'State Street'	State Street Miyabe Maple	3	2.5" Cal. B&B	H-50', W-40'
CEOCP	Celtis occidentalis 'Prairie Pride'	Prairie Pride Hackberry	3	2.5" Cal. B&B	H-50', W-45'
GIBAG	Ginko biloba 'Autumn Gold'	Autumn Gold Ginko (male)	2	2.5" Cal. B&B	H-50', W-30'
GLTIS	Gleditsia triacanthos inermis 'Shademaster'	Shademaster Honeylocust	3	2.5" Cal. B&B	H-50', W-35'
QUBI	Quercus bicolor	Swamp White Oak	1	2.5" Cal. B&B	H-60', W-60'
TADSB	Taxodium distichum 'Mickelson'	Shawnee Brave Bald Cypress	1	2.5" Cal. B&B	H-60', W-20'

ORNAMENTAL TREES (INSTALL IN ACCORDANCE WITH DETAIL 3/L2.0)

| CODE | SCIENTIFIC NAME COMMON NAME QTY. PLANTING SIZE MATURE SIZE SYRISM Syringa reticulata 'Ivory Silk' 8' B\$B, multi-stem | H-25', W-15' Ivory Silk Japanese Tree Lilac | 1

EVERGREEN TREES (INSTALL IN ACCORDANCE WITH DETAIL 2/L2.0)

CODE	SCIENTIFIC NAME	COMMON NAME	QTY,	PLANTING SIZE	MATURE SIZE
PIPFA	Picea pungens 'Fat Albert'	Fat Albert Spruce	3	6' Tall B&B	H-20', W-15'
THON	Thuja occidentalis 'Nigra'	Dark Green Arborvitae	13	6' Tall B&B	H-25', W-10'

EVERGREENS / BROADLEAF EVERGREEN SHRUBS (INSTALL IN ACCORDANCE WITH DETAIL 4/L2.0)

CODE	SCIENTIFIC NAME	COMMON NAME	QTY.	PLANTING SIZE	MATURE SIZE
JUCHM	Juniperus chinensis 'Mountbatten'	Mountbatten Chinese Juniper	8	4' Tall B&B	H-12', W-5'
JUCSG	Juniperus chinensis 'Sea Green'	Sea Green Juniper	5	18" Spread Pot	H-4', W-6'
TAMET	Taxus x media 'Tauntonii'	Tauntonii Yew	٦	24" Spread B&B	H-4', W-5'

DECIDUOUS SHRUBS (INSTALL IN ACCORDANCE WITH DETAIL 4/L2.0)

CODE	SCIENTIFIC NAME	COMMON NAME	QTY.	PLANTING SIZE	MATURE SIZE
EUALC	Euonymous alatus 'Compactus'	Dwarf Burning Bush	6	24" Tall B\$B	H-5', W-7'
HYPAJ	Hydrangea paniculata 'Jane'	Little Lime Hydrangea	20	18" Tall Pot	H-4', W-4'
PHOPD	Physocarpus opulifolius 'Dart's Golden'	Dart's Golden Ninebark	3	36" Tall B\$B	H-6', W-7'
PHOPM	Physocarpus opulifolius 'Monlo'	Purple Leaf Ninebark	2	36" Tall B\$B	H-7', W-8'
RHARG	Rhus aromatica 'Gro-low'	Grow Low Sumac	٦	18" Spread Pot	H-2', W-5'
SPBET	Spiraea betulifolia 'Tor'	Tor Birchleaf Spirea	8	18" Tall Pot	H-3', W-3'
SYMEP	Syrınga meyeri 'Palibin'	Dwarf Korean Lilac	8	2' Tall B&B	H-5', W-7'
SYPEN	Syringa x 'Penda'	Bloomerang Purple Lilac	٦	24" Tall Pot	H-5', W-5'

PERENNIALS / GRASSES / VINES

CODE	SCIENTIFIC NAME	COMMON NAME	QTY.	PLANTING SIZE	SPACING
CAAC	Calamagrostis acutiflora 'Karl Foerster'	Karl Foerster Feather Reed Grass	43	#I Pot	24" O.C.
HEGB	Hemerocallis 'Going Bananas'	Going Bananas Daylily	43	#I Pot	18" O.C.
MISIP	Miscanthus sinensis purpurascens	Flamegrass	22	#I Pot	36" O.C.
NEWL	Nepeta x 'Walker's Low'	Walker's Low Catmint	17	#1 Pot	24" O.C.
PEALS	Perovskia atriplicifolia 'Little Spire'	Little Spire Russian Sage	11	#I Pot	18" O.C.
SPHE	Sporobolus heterolepsis	Prairie Dropseed	20	#I Pot	18" O.C.

VENTURE COURT

L2.0

TYPICAL -LIGHT POLE

LANDSCAPE CALCULATIONS - WAUKESHA

LANDSCAPE REQUIREMENTS		
SITE ZONING = M-3		
LOT AREA = 763,479 SF		
GREENSPACE AREA = 621,256 SF		
NORTH PARKING LOT PAVED AREA = 23,455 SF		
NORTH PARKING LOT INTERIOR LANDSCAPE AREA = 1183 SF	REQUIRED	PROVIDED
GREENSPACE REQUIREMENTS - MINIMUM 25% GREENSPACE		
621,256 SF GREENSPACE / 763,479 SF LOT AREA = 0.814	25%	81.4%
PARKING LOT INTERIOR LANDSCAPE REQUIREMENTS - MINIMUM 5%		
1183 SF INTERIOR LANDSCAPE / 23,455 SF PARKING AREA = 0.0504	5%	5.0%
PARKING LOT INTERIOR LANDSCAPE ISLANDS TO BE PLANTED		
WITH TREES, SHRUBS, FLOWERS AND SIMILAR PLANTINGS	YES	YES
PARKING LOT SCREENING FROM RIGHT-OF-WAY REQUIRED	YES	YES-TREES, SHRUBS \$
		ORNAMENTAL GRASSES

GRASS SEED MIX

GRASS SEED SHALL CONSIST OF THE FOLLOWING VARIETIES (OR APPROVED

20% KENTUCKY BLUEGRASS (SOD QUALITY) 10% MERCURY KENTUCKY BLUEGRASS 20% KENBLUE KENTUCKY BLUEGRASS 25% CREEPING RED FESCUE 15% WICKED PERENNIAL RYEGRASS 10% FIESTA 4 PERENNIAL RYEGRASS

SEEDING RATE SHALL BE 4-1/2 POUNDS PER 1,000 SQUARE FEET

SEEDS SHALL BE INSTALLED & TO 1 BELOW FINISH GRADE.

ABBREVIATIONS ABBREVIATION FULL WORDS

ABBREVIATION	FULL WORDS
B \$ B	Balled and burlapped
CAL.	Caliper
DBH	Diameter at breast height (Measured 4'-6" above finish grade)
DIA.	Diameter
E×.	Existing
HTT	Height to tip
O.C.	On center
SQ. FTor- SF	Square feet
TR	Tree

LANDSCAPE LEGEND

M-3 ZONING

M-3 ZONING

LIGHT POLE

LIGHTING PLAN)

(16) HEGB-

(1) SYPEN-

(13) CAAC-

) ACFAF

(4) TAMET —

(T) HYPAJ-

(SEE SITE

/ (13) HYPAJ-

(SEE CIVIL)


2) JUCHM — ⁷

 \mathcal{L} (3) EUALC

TYPICAL WALL PACK LIGHT

> TYPICAL WALL PACK LIGHT

(6)SPHE-

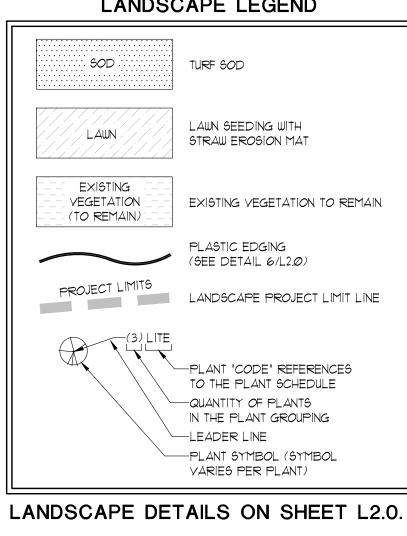

INDEX OF SHEETS

SHEET L1.0 LANDSCAPE PLAN L2.0 LANDSCAPE DETAILS

GENERAL NOTES:

1. LOCATE ALL PRIVATE AND PUBLIC UNDERGROUND UTILITIES PRIOR TO THE COMMENCEMENT OF ANY DIGGING/CLEARING OPERATIONS.

EXISTING

(TO REMAIN)

EXISTING

WETLAND

(TO REMAIN

UNDISTURBED)

EXISTING

VEGETATION

(TO REMAIN)

LAWN MOW-LINE EDGE

LOADING DOCK

LIGHT POLE

PROJECT LIMITS RIPRAP

EX. STORM WATER BASIN (TO REMAIN)

NFORMATION SHOWN ON THIS DRAWING IS BASED ON A SITE PLAN DEVELOPED BY DESIGN 2 CONSTRUCT, TOPOGRAPHIC

SURVEY AND CIVIL DRAWINGS COMPLETED BY OTHERS. THE

REPRESENTATIONS AS TO THE ACCURACY AND COMPLETENESS (

THE SITE PLAN, SURVEY AND CIVIL DRAWINGS. ALL INFORMATION

SHOWN ON THE DRAWINGS SHALL BE FIELD VERIFIED BY THE

LANDSCAPE ARCHITECT MAKES NO WARRANTIES OR

(SEE SITE LIGHTING PLAN

VEGETATION -

EXISTING

VEGETATION

(TO REMAIN)

PARKING

LOT

(SEE SITE LIGHTING PLAN

LAWN MOW-

LINE EDGE

TYPICAL — LIGHT POLE

50' WETLAND

EXISTING

VEGETATION

BUILDING SETBACK

VEGETATION S (TO REMAIN)

EXISTING

VEGETATION

(TO REMAIN)

LAWN MOW-

(1) PHOPM

(3) TAMET-

(8) SPBET-

PROPOSED

BUILDING

ENCLOSURE -(1) TADSB

40' PROPOSED

EASEMENT

-LAWN MOW LINE EDGE

PROJECT LIMITS

TO OBTAIN LOCATION OF

PARTICIPANTS' UNDERGROUND

FACILITIES BEFORE YOU

DIG IN WISCONSIN

DIGGERS HOTLINE

1-800-242-8511

WIS. STATUE 182.0175(1974)

NOTICE BEFORE YOU EXCAVATE.

TOLL FREE

REQUIRES MIN. OF 3 WORK DAYS

LIGHT POLE

CONTRACTOR.

(SEE SITE LIGHTING PLAN PARKING

RIPRAP -

(SEE CIVIL)

LINE EDGE

(8) CAAC-(8) HEGB-

PARKING SOD-

LOT

2. ALL PLANTING BEDS NOT ADJACENT TO ASPHALT, CONCRETE OR CURBS SHALL HAVE PLASTIC EDGING AS INDICATED ON THE PLAN. ALL PLANTING BEDS SHALL BE TOPDRESSED WITH DOUBLE SHREDDED HARDWOOD BARK MULCH ON WEED BARRIER AS INDICATED ON THE PLAN.

3. THE PLANT SCHEDULE IS ON SHEET LI.O. IT IS PROVIDED FOR CONVENIENCE ONLY. PLANT QUANTITIES SHALL BE VERIFIED BY THE CONTRACTOR. WHEN DISCREPANCIES BETWEEN THE SCHEDULE, LABELS AND THE PLAN OCCUR, THE QUANTITY DRAWN ON THE PLAN SHALL BE THE OFFICIAL QUANTITY.

4. WATER PLANTS IMMEDIATELY AFTER INSTALLATION.

5. GUARANTEE ALL PLANTINGS FOR I YEAR FROM THE DATE OF INSTALLATION.

6. SEE PLANTING DETAILS ON SHEET L2.0

FOR PLANT INSTALLATION REQUIREMENTS.

7. ALL AREAS INDICATED AS "LAWN" SHALL BE SEEDED AND COVERED WITH STRAW EROSION MAT. AREAS INDICATED AS "SOD" SHALL BE SODDED.

8. PROPOSED LIGHT POLE LOCATIONS ARE APPROXIMATED. SEE SITE LIGHTING PLAN FOR OFFICIAL LOCATIONS OF LIGHT POLES. COORDINATE TREE LOCATIONS TO AVOID LIGHT POLES AS NECESSARY.

9. SEE CIVIL PLANS FOR OFFICIAL SITE UTILITIES AND EROSION MAT LOCATIONS. SITE UTILITIES SHOWN ON THIS PLAN ARE FOR CONVENIENCE ONLY.

> **EXISTING** WETLAND (TO REMAIN UNDISTURBED)

> > EXISTING - VEGETATION (TO REMAIN)

> > > EXISTING

EXISTING VEGETATION (TO REMAIN)

EXISTING

WETLAND

(TO REMAIN

UNDISTURBED)

EXISTING

VEGETATION

(TO REMAIN)

VEGETATION -(TO REMAIN)

CLIENT NAME & ADDRESS

PARAGON

DESIGN GROUP, LLC

SITE DESIGN

· LANDSCAPE ARCHITECTURE ·

PLANNING

2776 North Sholes Avenue

Milwaukee, WI 53210

Tel: 414.449.1555

Fax: 414.449.2425

www.paragondg.com

PROJECT NAME

PROJECT LOCATION

WAUKESHA, WI 53189

VENTURE COURT

ZT DISTRIBUTION

LANDSCAPE PLAN

SHEET TITLE

REVISIONS

PROFESSIONAL SEAL BRIAN J. No. 401 AMILWAUKEE/ . WIS.

USE OF INFORMATION THESE DRAWINGS, AS INSTRUMENTS OF SERVICE, REMAIN THE PROPERTY OF PARAGON DESIGN GROUP, LLC. ANY CHANGES, PUBLICATION OR UNAUTHORIZED USE IS PROHIBITED

UNLESS EXPRESSLY APPROVED. ZT Distr LA DRAWN BY CHECKED BY 19-808 PDG PROJECT * 2-19-2020

SHEET NO.

SCALE 1" = 30'-0"



· SITE DESIGN · LANDSCAPE ARCHITECTURE PLANNING

> 2776 North Sholes Avenue Milwaukee, WI 53210 Tel: 414.449.1555 Fax: 414.449.2425 www.paragondg.com

PROJECT NAME

PROJECT LOCATION

WAUKESHA, WI 53189

CLIENT NAME & ADDRESS

VENTURE COURT

ZT DISTRIBUTION

TOP OF PLASTIC PLANTING BED EDGING VARIES (SEE PLAN) ¹" ABOVE TYP. WEED BARRIER FINISH GRADE - TYP. MULCH - FINISH GRADE (SEE DETAIL) — TURF GRASS -TOPSOIL HEAVY DUTY PLASTIC EDGING - METAL STAKE -EXISTING SUBGRADE - PLANTING SOIL

SHEET TITLE TYPICAL PLASTIC EDGE SECTION

LANDSCAPE **DETAILS**

REVISIONS Date

PROFESSIONAL SEAL

USE OF INFORMATION

FILE NAME

DRAWN BY

CHECKED BY

SHEET NO.

PDG PROJECT #

BRIAN J.

BOEDING

MILWAUKEE!

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No. 401

2: WIS.

L2.0

TYPICAL SHREDDED HARDWOOD MULCH SECTION SCALE 3/4"= 1'-0"

-TOP OF MULCH

-WEED BARRIER

-DOUBLE SHREDDED

HARDWOOD MULCH

SHRUB PLANTING NOTES


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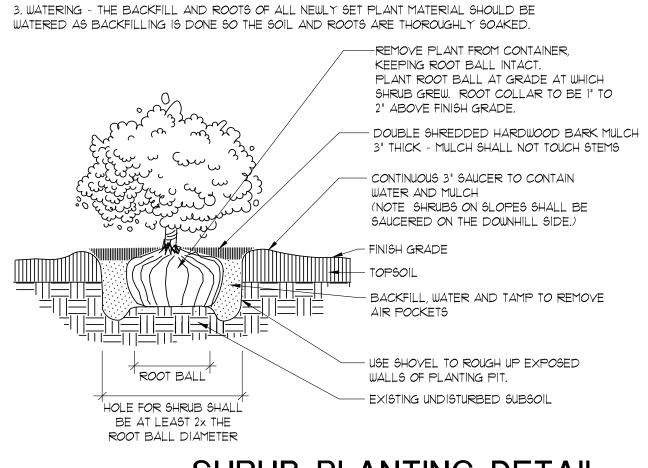
SCALE: NOT TO SCALE

1. PRUNING - CLEANLY PRUNE DAMAGED BRANCHES AND ROOTS AT THIS TIME. ADDITIONAL PRUNING SHOULD BE ONLY FOR SHAPING PURPOSES.

2. PLANTING - ALL SYNTHETIC MATERIAL SHOULD BE REMOVED FROM THE ROOTS, TRUNK, OR CROWN OF PLANT. SET THE PLANT SO IT WILL BE AT ITS ORIGINAL DEPTH SLIGHTLY ABOVE EXISTING GRADE. BACKFILL WITH SPECIFIED SOIL MIX.



SHRUB PLANTING DETAIL

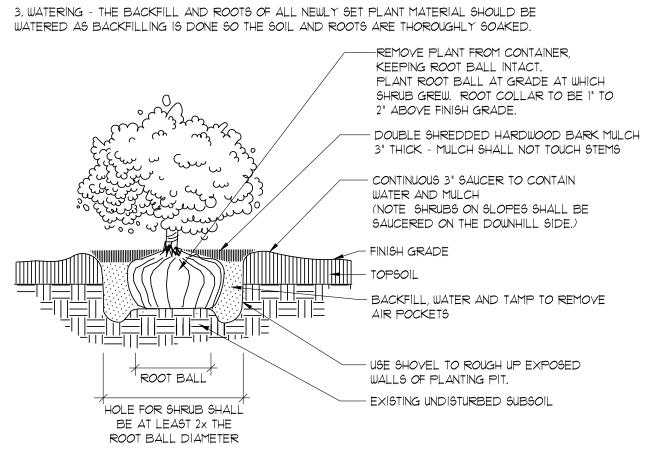

L2.0


TREE STAKING AND PLANTING NOTES

I. STAKING - ONLY TREES THAT ARE UNABLE TO REMAIN UPRIGHT AFTER PLANTING SHALL BE STAKED. TREES WILL BECOME STRONGER FASTER WHEN THE TOP 2/3 OF THE TREE IS FREE TO SWAY. TIE WEBBED STRAPPING TO THE TREE 1/3 UP THE TRUNK AND WIRE TO THREE STAKES POSITIONED EVENLY AROUND THE TREE. STAKES SHOULD BE DRIVEN DEEPLY INTO THE GROUND TO PREVENT DISLODGING. CHECK AT LEAST EVERY THREE MONTHS FOR BINDING OR OTHER PROBLEMS. STAKES AND TIES SHOULD BE REMOVED SIX MONTHS TO ONE YEAR AFTER PLANTING.

2. PRUNING - CLEANLY PRUNE DAMAGED BRANCHES AND ROOTS AT THIS TIME. ADDITIONAL PRUNING SHOULD BE ONLY FOR SHAPING PURPOSES.

3. PLANTING - ALL SYNTHETIC MATERIAL SHOULD BE REMOVED FROM THE ROOTS, TRUNK, OR CROWN OF PLANT. SET THE PLANT SO IT WILL BE AT ITS ORIGINAL DEPTH SLIGHTLY ABOVE EXISTING GRADE. BACKFILL WITH SPECIFIED SOIL MIX.

4. WATERING - THE BACKFILL AND ROOTS OF ALL NEWLY SET PLANT MATERIAL SHOULD BE

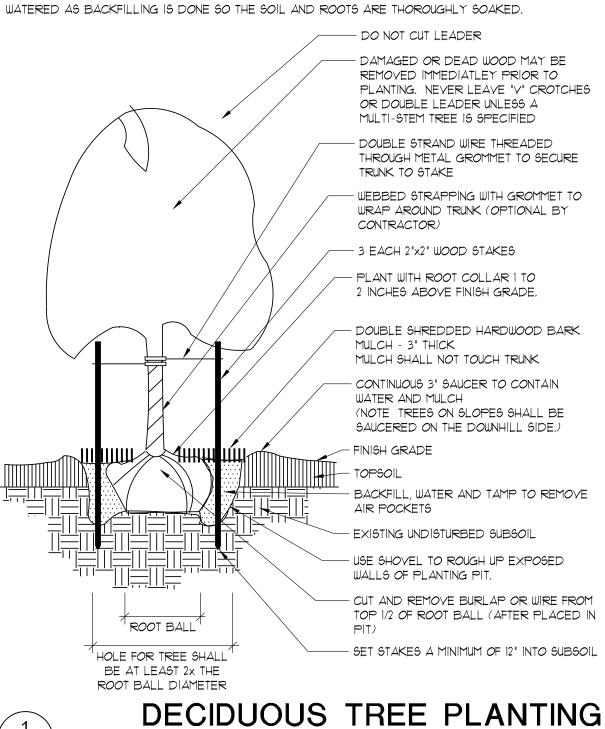


EVERGREEN TREE STAKING AND PLANTING NOTES

1. STAKING - ONLY EVERGREEN TREES THAT ARE UNABLE TO REMAIN UPRIGHT AFTER PLANTING SHALL BE STAKED. EVERGREEN TREES WILL BECOME STRONGER FASTER WHEN THE TOP 2/3 OF THE EVERGREEN TREE 16 FREE TO SWAY. TIE WEBBED STRAPPING TO THE TREE 1/3 UP THE TRUNK AND WIRE TO THREE STAKES POSITIONED EVENLY AROUND THE EVERGREEN TREE. STAKES SHOULD BE DRIVEN DEEPLY INTO THE GROUND TO PREVENT DISLODGING. CHECK AT LEAST EVERY THREE MONTHS FOR BINDING OR OTHER PROBLEMS. STAKES AND TIES SHOULD BE REMOVED SIX MONTHS TO ONE YEAR AFTER PLANTING.

2. PRUNING - CLEANLY PRUNE ONLY DAMAGED BRANCHES AND ROOTS AT THIS TIME. ADDITIONAL PRUNING SHOULD BE ONLY FOR SHAPING PURPOSES.

3. PLANTING - ALL SYNTHETIC MATERIAL SHOULD BE REMOVED FROM THE ROOTS, TRUNK, OR CROWN OF PLANT. SET THE PLANT SO IT WILL BE AT ITS ORIGINAL DEPTH SLIGHTLY ABOVE EXISTING GRADE, BACKFILL WITH SPECIFIED SOIL MIX.

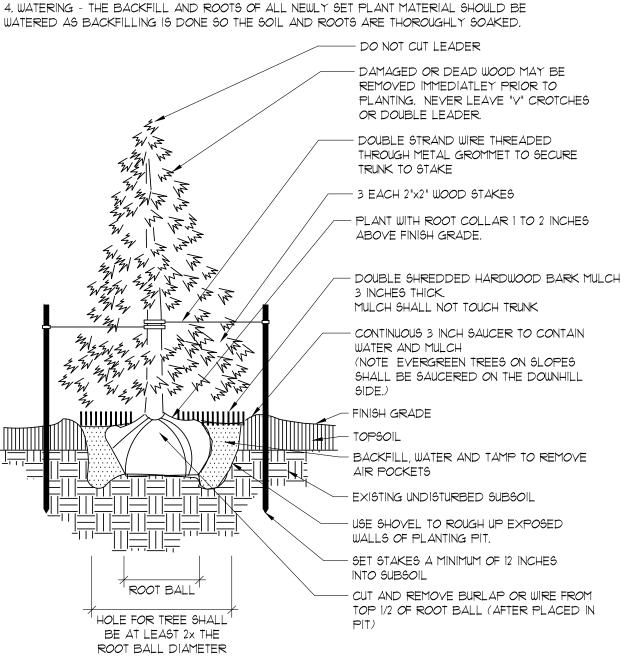

EVERGREEN TREE PLANTING


MULTI-STEM TREE STAKING AND PLANTING NOTES

I. STAKING - MULTI-STEM TREES SHALL NOT BE STAKED. TREES WILL BECOME STRONGER FASTER WHEN THE TOP 2/3 OF THE TREE IS FREE TO SWAY.

2. PRUNING - CLEANLY PRUNE DAMAGED BRANCHES AND ROOTS AT THIS TIME. ADDITIONAL PRUNING SHOULD BE ONLY FOR SHAPING PURPOSES.

3. PLANTING - ALL SYNTHETIC MATERIAL SHOULD BE REMOVED FROM THE ROOTS, TRUNK, OR CROWN OF PLANT. SET THE PLANT SO IT WILL BE AT ITS ORIGINAL DEPTH SLIGHTLY ABOVE EXISTING GRADE, BACKFILL WITH SPECIFIED SOIL MIX.

4. WATERING - THE BACKFILL AND ROOTS OF ALL NEWLY SET PLANT MATERIAL SHOULD BE WATERED AS BACKFILLING IS DONE SO THE SOIL AND ROOTS ARE THOROUGHLY SOAKED.

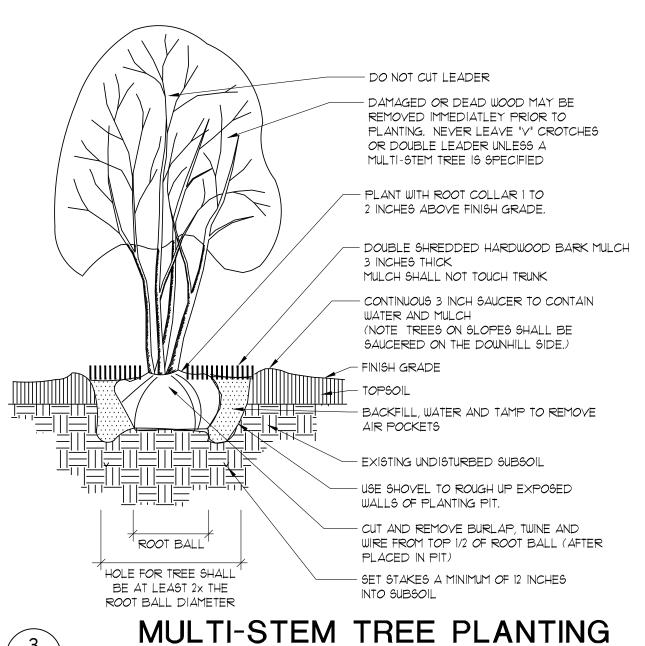

ZT Distr LA

19-808


2-19-2020

SCALE: NOT TO SCALE

SCALE: NOT TO SCALE

L2.0/

L2.0 SCALE: NOT TO SCALE

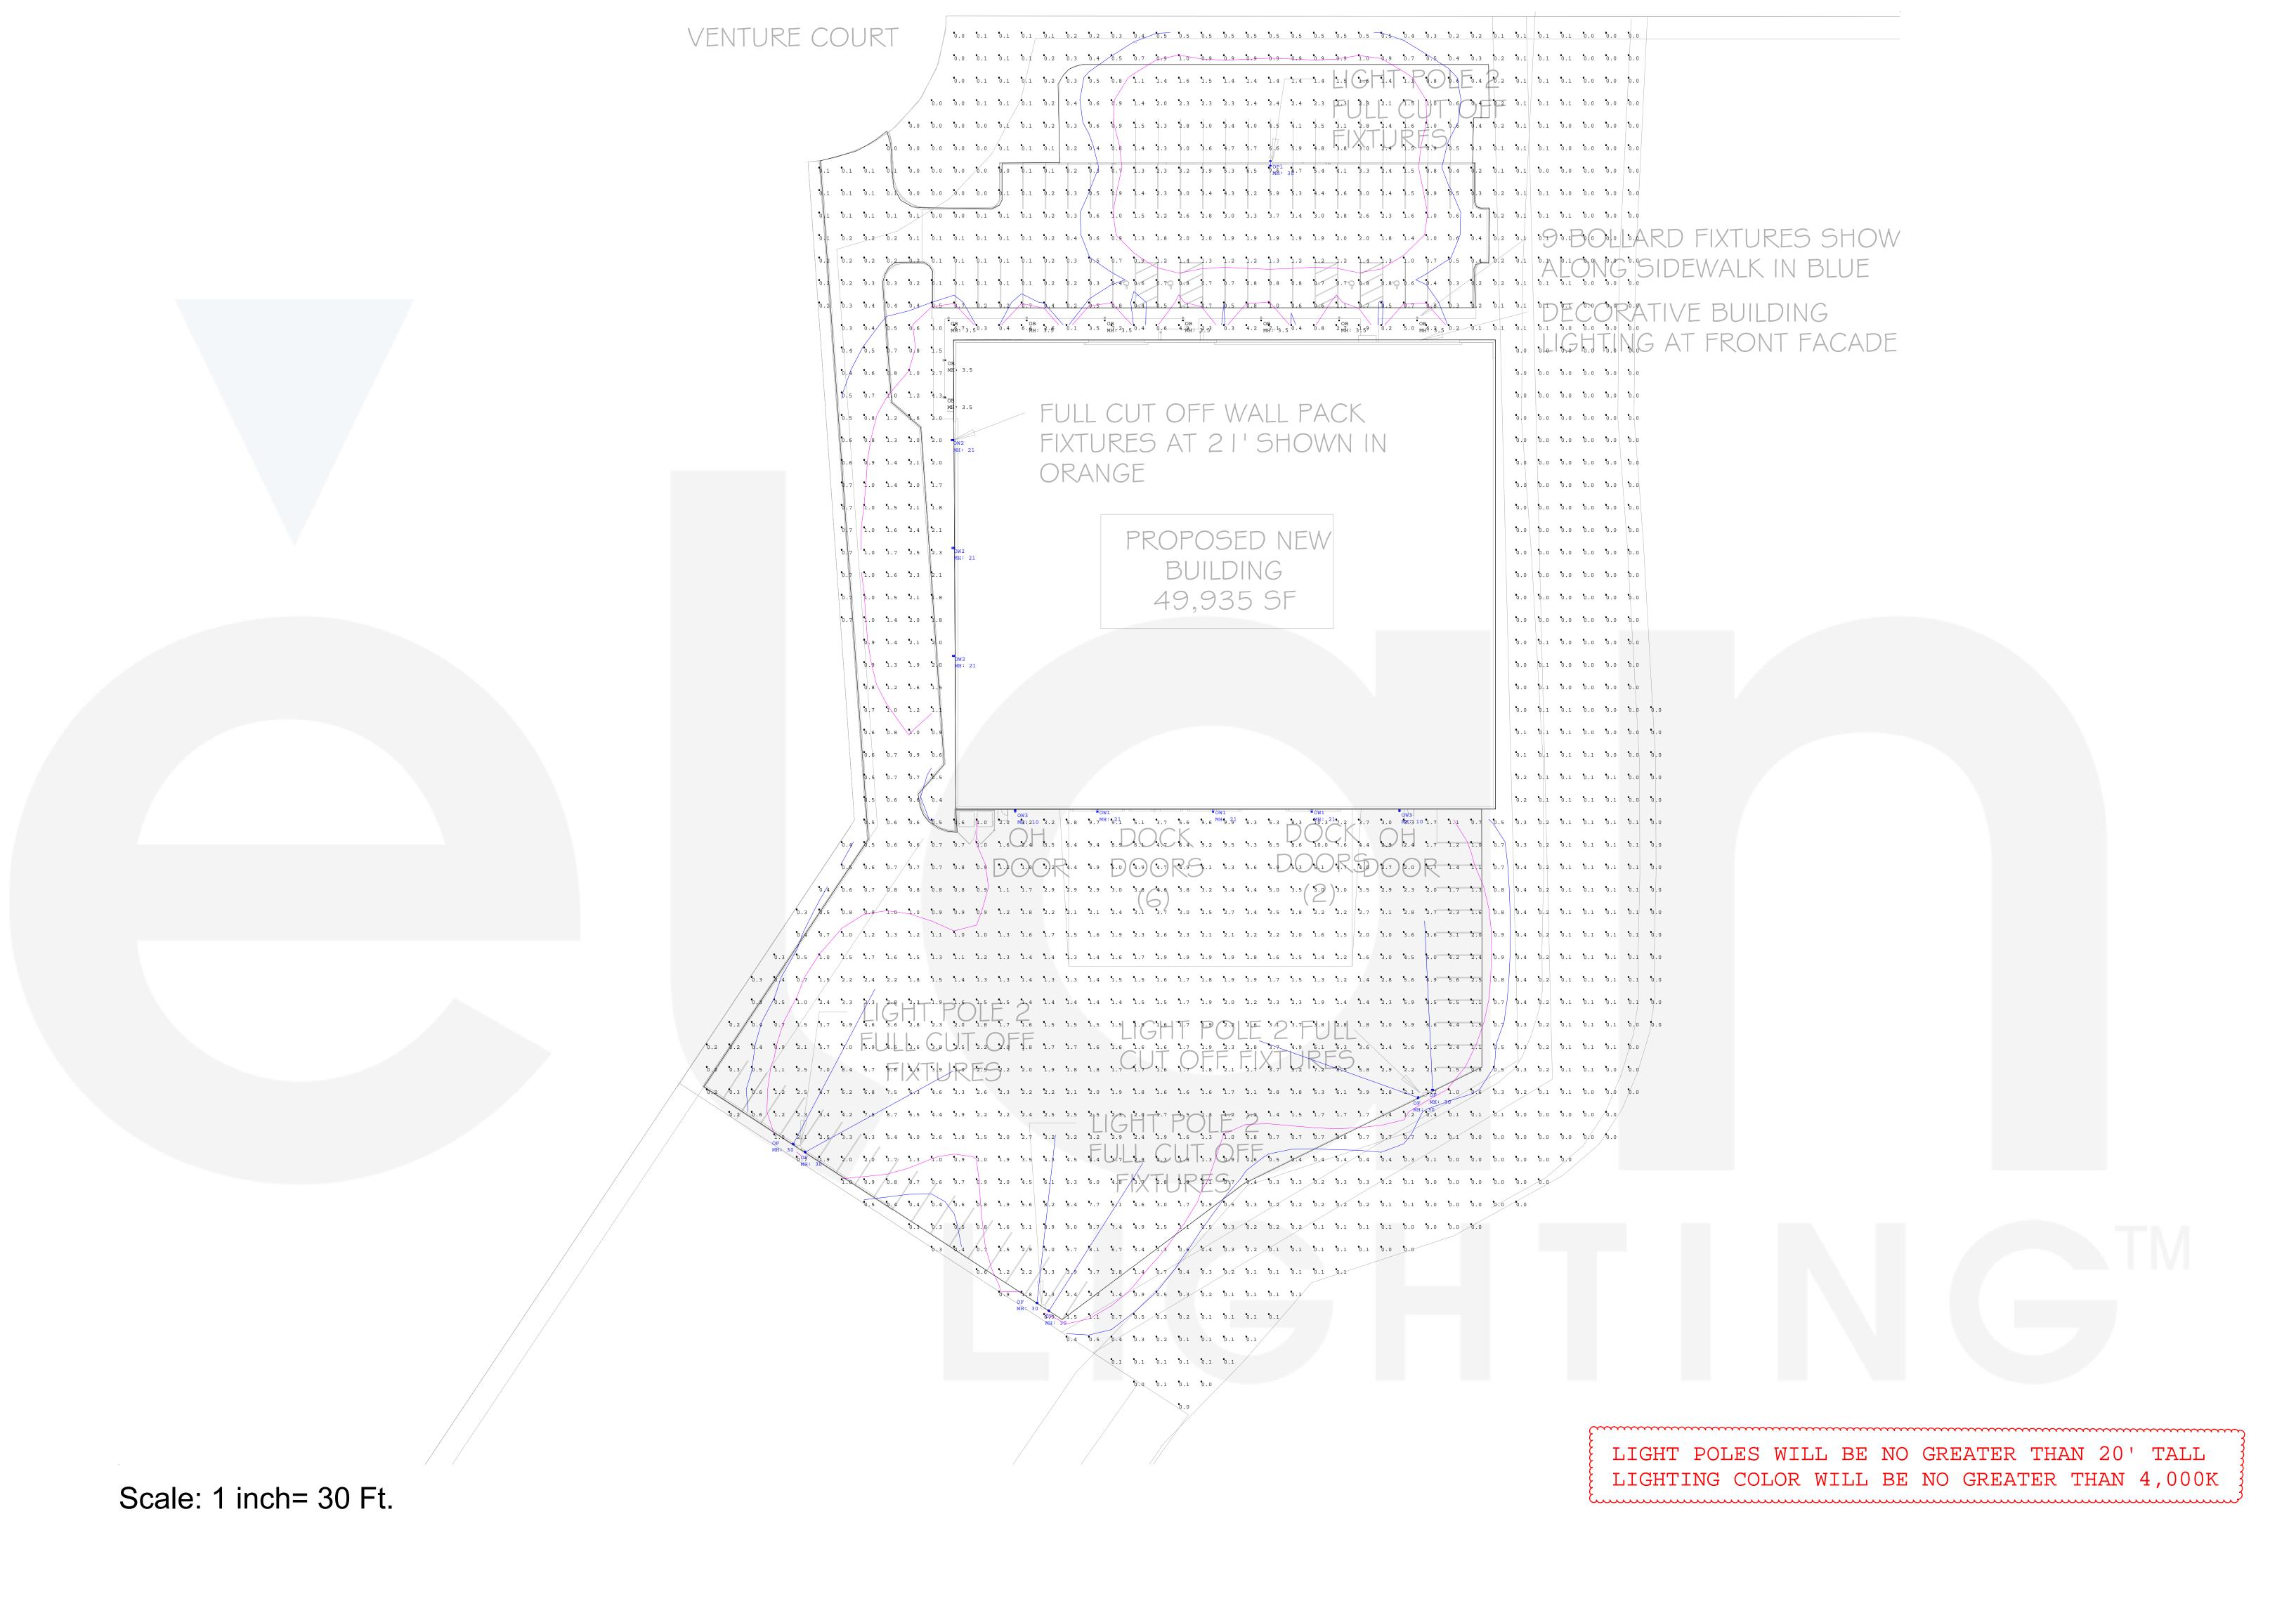

Symbol	Label	Quantity	Manufacturer	Catalog Number	Lumens	LLF	Watts
,	ОВ	9	EATON - LUMIERE (FORMER COOPER LIGHTING)	303-B1-LEDB2-4000-UNV-T2-DIM10-BK	1433	1.000	15.5
-	OF	6	Visionaire Lighting LLC	VMF-1-FM-64LC-10-4K-UNV-KM-XX (2 FIXT. PER POLE ON BULLHORN)	26296	0.900	219
+	OP1	1	Visionaire Lighting LLC	VSX-1-T3-25L-4K-UNV	23865	0.900	167
→	OW1	3	Visionaire Lighting LLC	VSX-1-T4-25L-4K-UNV-WM-XX-BAWP	23518	0.900	167
	OW2	3	Visionaire Lighting LLC	VSX-1-T2-10L-4K-UNV-WM-XX-BAWP	9620	0.900	70
	OW3	2	Visionaire Lighting LLC	VSC-1-T3-16LC-3-4K-UNV-WM	2355	0.900	18

Calculation Summary						
Label	Avg	Max	Min	Avg/Min	Max/Min	Units
SITE	1.42	10.3	0.0	N.A.	N.A.	Fc
PARKING-DRIVE	2.23	10.3	0.0	N.A.	N.A.	Fc

filwaukee Main Offic 6350 W. Glendale Dr. lew Berlin, WI 53151 hone: 262-785-0144

CHING SYSTEMS

THESE CALCULATIONS ARE ESTIMATE BASED ON INFORMATION AVAILABLE AT TIME OF LAYOUT REQUEST AND DO NOT REPRESENT ON-SITE CONDITIONS WITH 100% ACCURACY.

Date:1/23/2020 Paper Size: ARCH E1 - 30x42

TRIBUTION SITE

Page 1 of 1