CONSTRUCTION DOCUMENT SET


BUCHNER PARK POOL

March 11, 2020

City of Waukesha, WI


223 OAKLAND AVE. WAUKESHA, WI 53186

Sheet Index

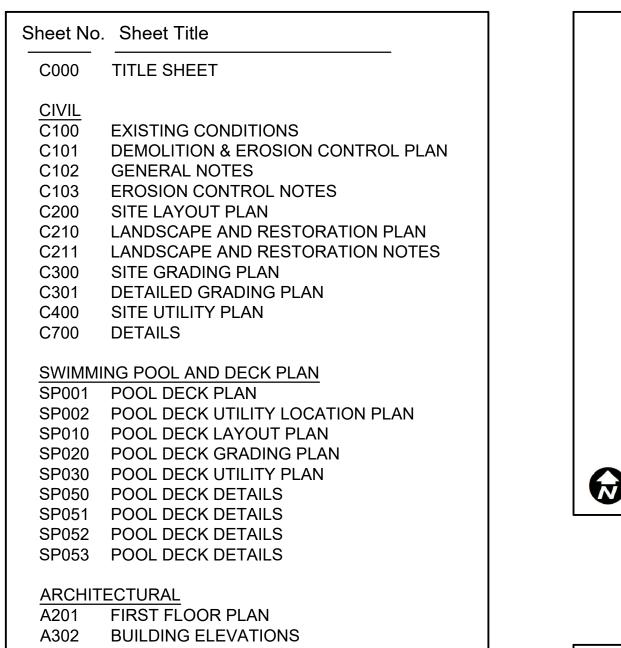

E000 SITE PHOTOMETRICS

Location Map

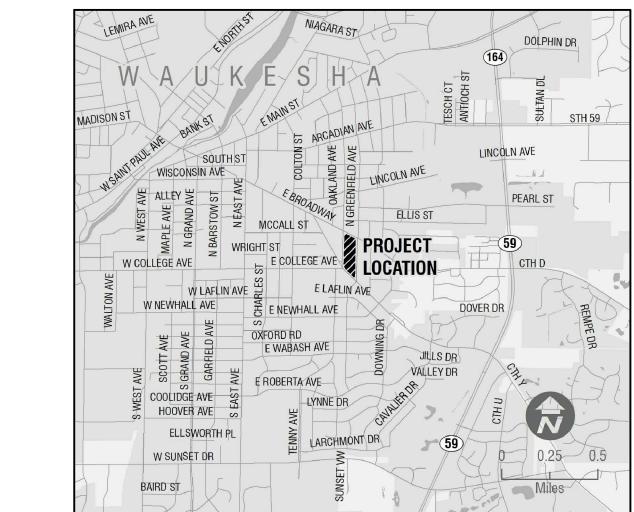

Vicinity Map

CIVIL ENGINEER AYRES ASSOCIATES 5201 E TERRACE AVE, STE 200 MADISON, WI 53718

608-443-1200

LANDSCAPE ARCHITECT AYRES ASSOCIATES 5201 E TERRACE AVE, STE 200 MADISON, WI 53718 608-443-1200

ARCHITECT ICONICA 901 DEMING WAY MADISON, WI 53717 608-664-3500

STRUCTURAL ICONICA 901 DEMING WAY MADISON, WI 53717 608-664-3500

POOL DECK PARKITECTURE + PLANNING 901 DEMING WAY, SUITE 102 MADISON, WI 53717 608-664-3500

5201 E. Terrace Drive

Suite 200 Madison, WI 53718 608.443.1200 www.AyresAssociates.com



ICONICA 901 Deming Way // Madison, WI 53717

Ph: 608.664.3500 // Fx: 608.664.3535





Milwaukee: 20855 Watertown Rd, Suite 170 Waukesha, Wisconsin 53186 **T** 262.901.0626

Project Name

BUCHNER PARK POOL



City of Waukesha 223 Oakland Ave. Waukesha, WI 53186

Drawn By: Checked By: Issued For:

Review Issue Date: 03.11.2020 Project No. 52-0684.00

Sheet Title

TITLE SHEET




Sheet Number

Project Location Sheet No. Sheet Title Sheet No. Sheet Title

> MECHANICAL, ELECTRICAL & PLUMBING HENNEMAN ENGINEERING, INC. 20855 WATERTOWN RD, STE 170 WAUKESHA, WI 53186 262-901-0626

> > Dial or (800) 242-8511

www.DiggersHotline.com

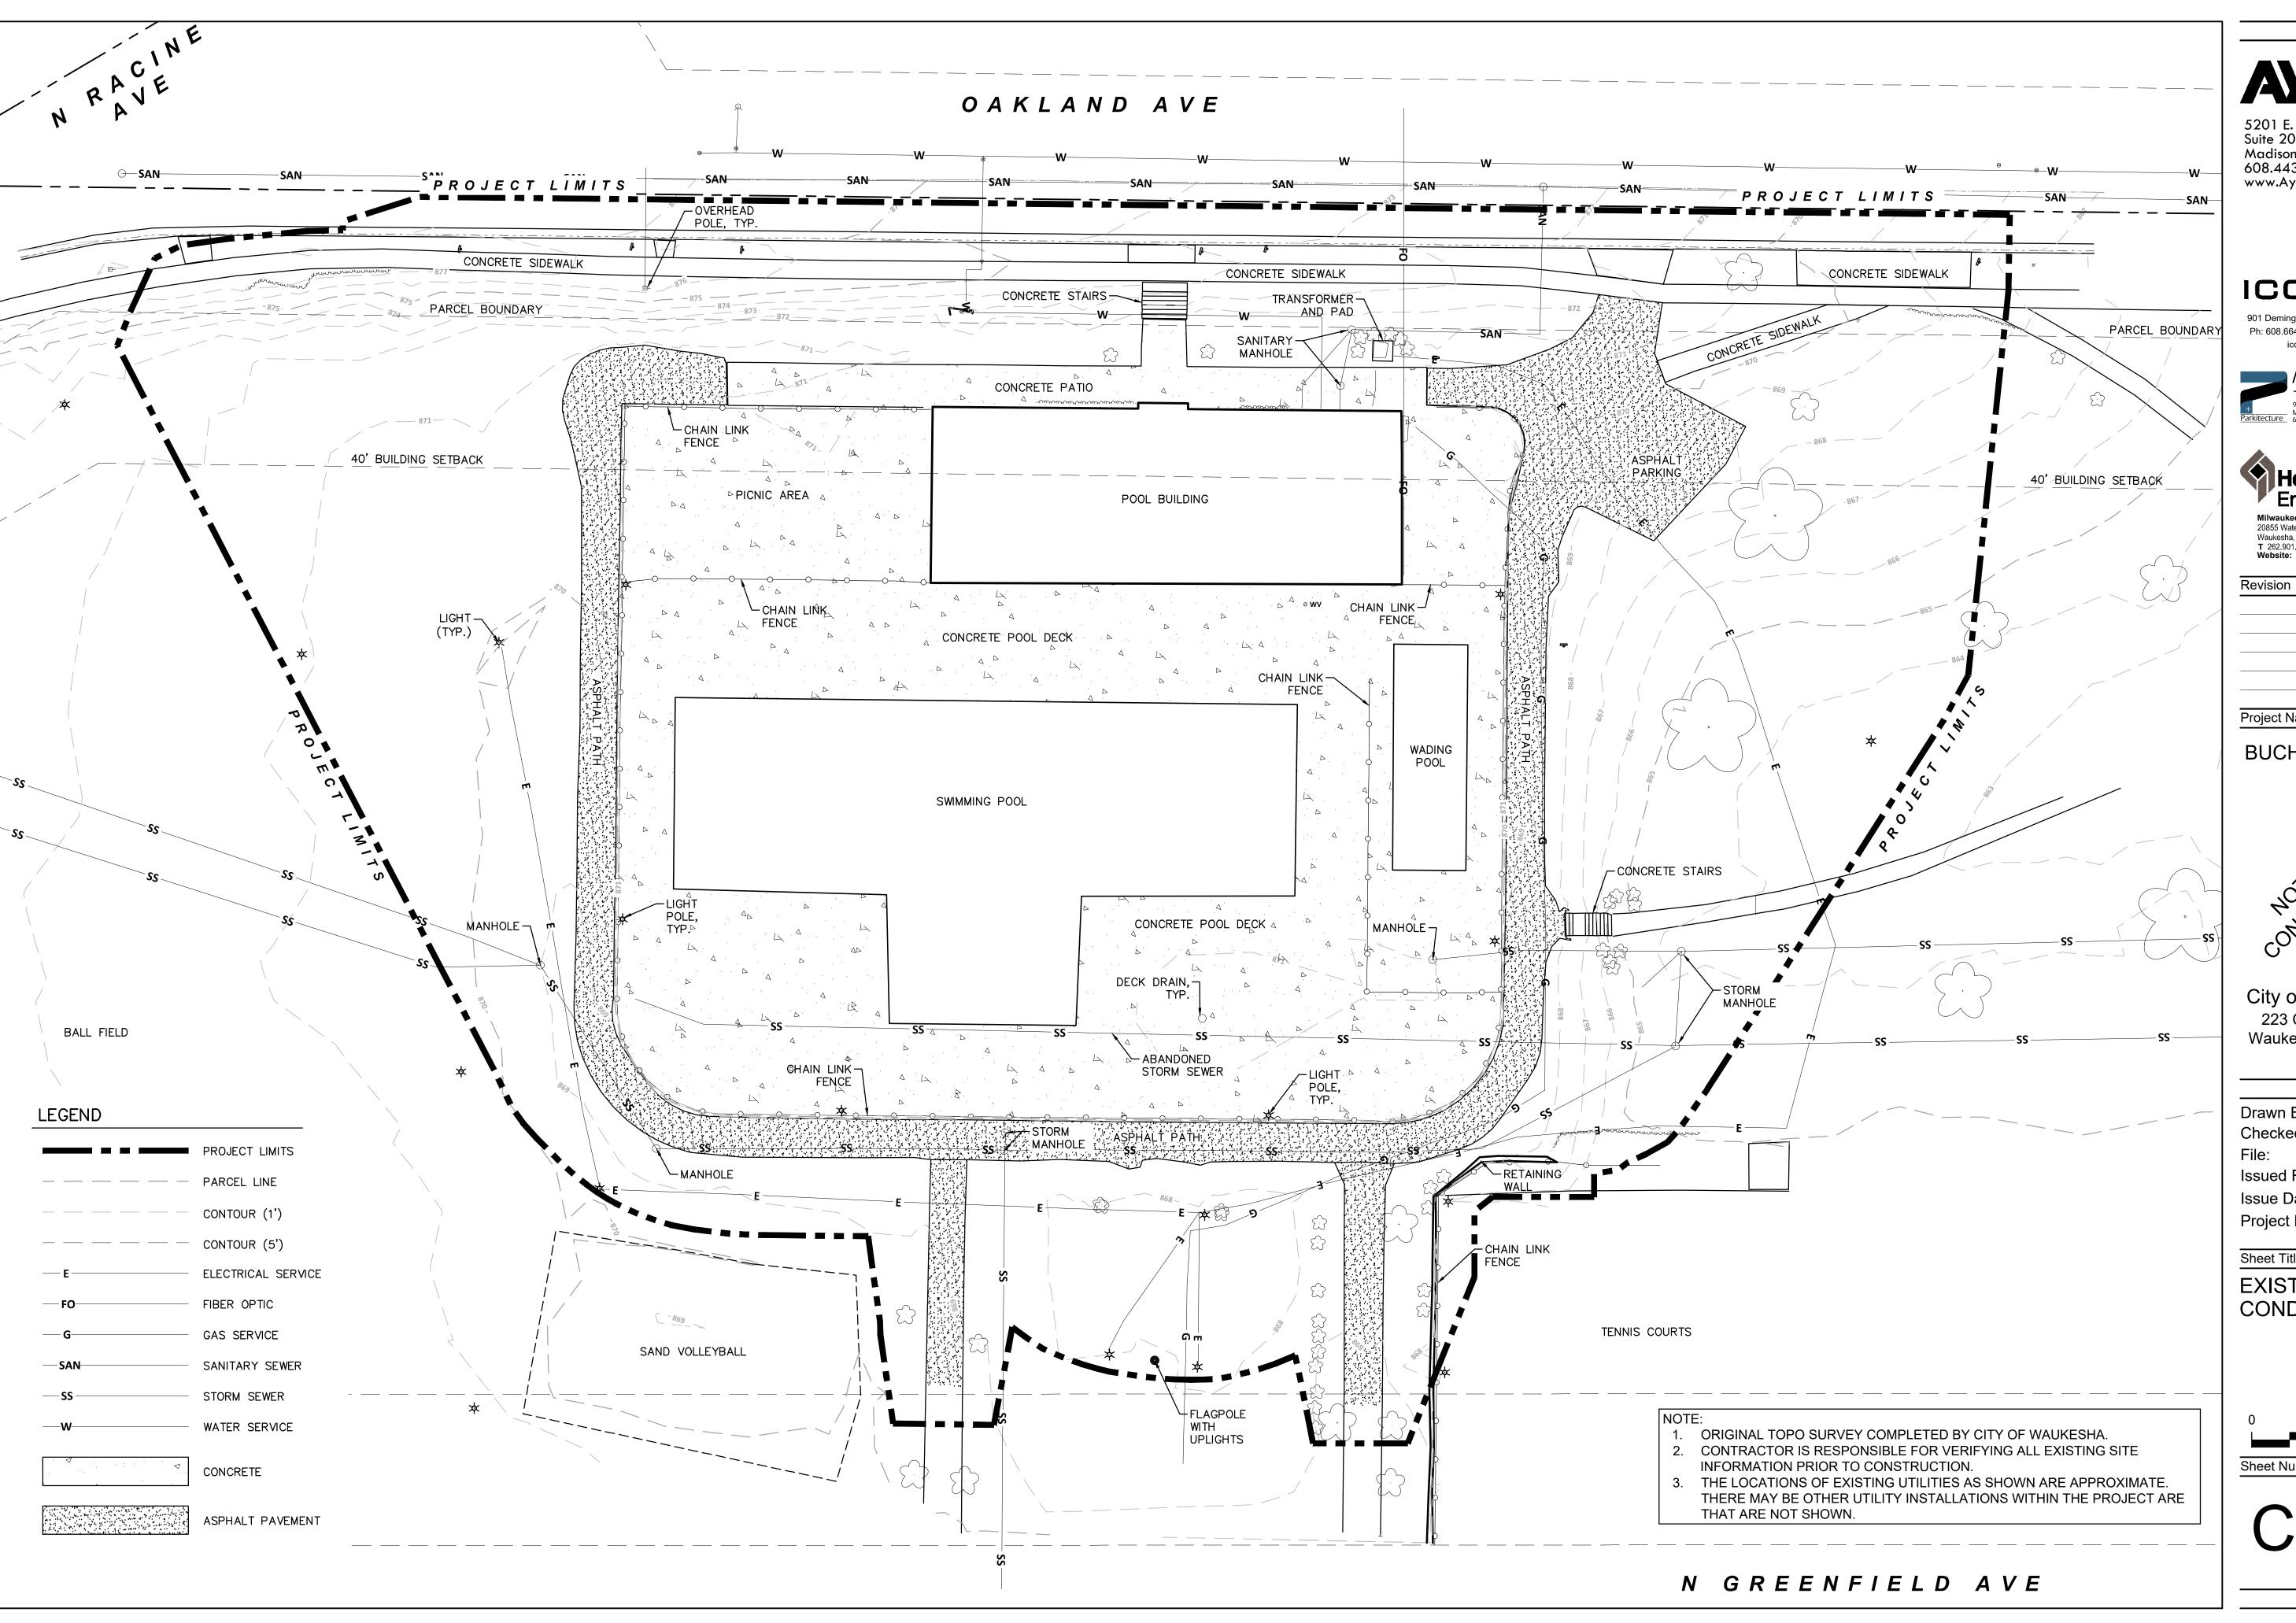



ICONICA

901 Deming Way // Madison, WI 53717 Ph: 608.664.3500 // Fx: 608.664.3535





Milwaukee: 20855 Watertown Rd, Suite 170 Waukesha, Wisconsin 53186 T 262.901.0626
Website: http://www.henneman.com

Project Name

BUCHNER PARK POOL


City of Waukesha 223 Oakland Ave. Waukesha, WI 53186

Drawn By: Checked By: BM P-EX Review Issued For: Issue Date: 03.11.2020 Project No. 52-0684.00

Sheet Title

EXISTING CONDITIONS



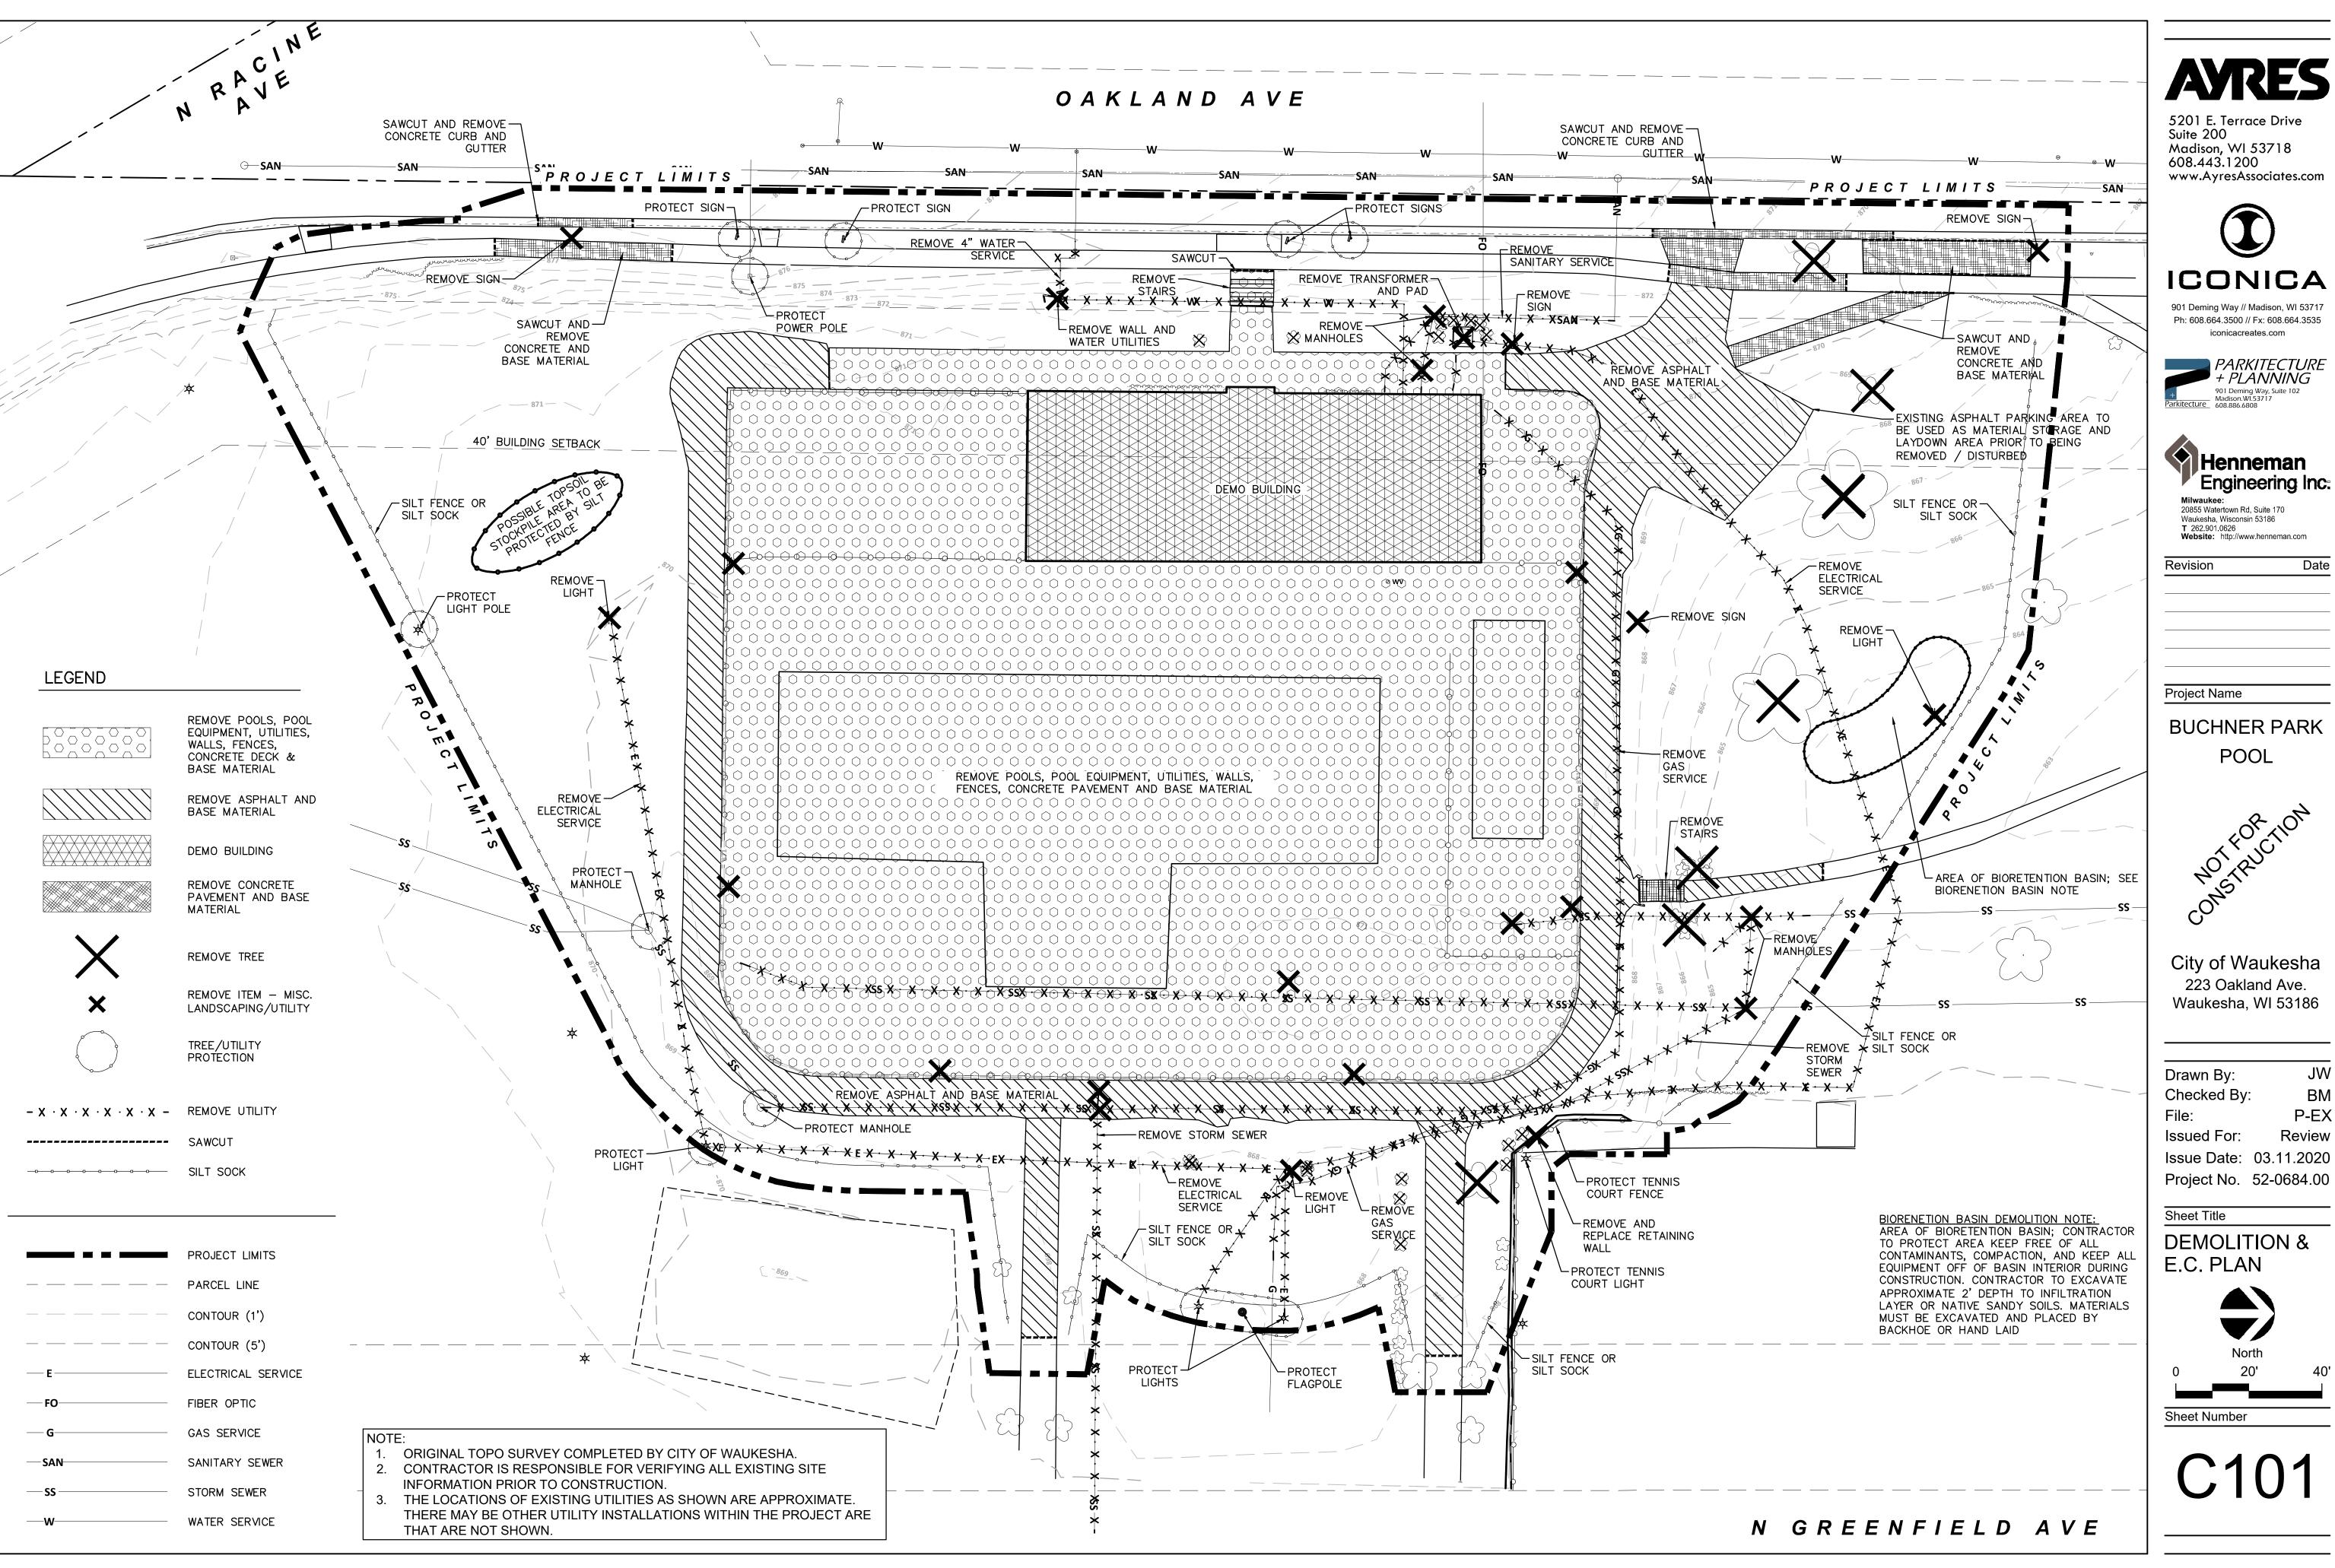



ICONICA

901 Deming Way // Madison, WI 53717 Ph: 608.664.3500 // Fx: 608.664.3535 iconicacreates.com





Milwaukee: 20855 Watertown Rd, Suite 170 Waukesha, Wisconsin 53186 **T** 262.901.0626

BUCHNER PARK POOL



City of Waukesha 223 Oakland Ave. Waukesha, WI 53186

Checked By: P-EX Review Issued For: Issue Date: 03.11.2020

Sheet Title

DEMOLITION & E.C. PLAN



GENERAL DEMOLITION NOTES;

- . CONTRACTOR SHALL CONTACT DIGGERS HOTLINE A MINIMUM OF 3 WORKING DAYS PRIOR TO THE START OF CONSTRUCTION.
- 2. CONTRACTOR SHALL CONTACT APPROPRIATE UTILITY COMPANIES TO FIELD VERIFY UTILITIES PRIOR TO ANY CONSTRUCTION.
- 3. PERFORM ALL WORK IN ACCORDANCE WITH THE CITY OF MARSHFIELD STANDARD SPECIFICATIONS, LATEST EDITION.
- 4. SEE EXISTING CONDITIONS PLAN FOR LEGEND OF EXISTING FEATURES.
- 5. CONTRACTOR TO PHASE THE CONSTRUCTION SO THAT THE MINIMUM AMOUNT OF DISTURBED SOIL IS EXPOSED AT ONE TIME.
- 6. A TRACKING PAD OR TRACKOUT CONTROL PRACTICES MUST BE PRESENT AT THE SITE ENTRY AT ALL TIMES. LOCATION TO BE DETERMINED BY THE CONTRACTOR.
- 7. THE CONTRACTOR IS RESPONSIBLE FOR REPLACING IN-KIND ANY PAVED OR LAWN AREAS DAMAGED DURING CONSTRUCTION THAT WERE SHOWN TO REMAIN IN PLACE.
- 8. CONTRACTOR SHALL ENSURE THAT ALL DIRT AND TRACKED MUD BEYOND THE PROJECT LIMIT
- LINES IS CLEANED UP AT THE END OF EACH DAY.
- INSTALL INLET PROTECTION ON ALL PROPOSED STORM INLETS AS THEY ARE INSTALLED, TO BE REMOVED AT PROJECT COMPLETION.
 REMOVE ANY EXISTING SITE ELEMENT THAT CONFLICTS WITH THE PROPOSED CONSTRUCTION
- INCLUDING, BUT NOT LIMITED TO, SIGNS, FENCING, ELECTRICAL, PLUMBING, STORM SEWER, POOL VESSEL, LANDSCAPING, PAVEMENTS, AND CURB AND GUTTER.

 11. DELINEATED STORMWATER MANAGEMENT AREAS TO BE PROTECTED FROM SEDIMENT AND

EROSION CONTROL GENERAL NOTES:

COMPACTION DURING CONSTRUCTION.

- 1. CONTRACTOR MUST HAVE A COPY OF THE WDNR WPDES PERMIT, LOCAL PERMITS, AND APPROVED PLANS AVAILABLE AT THE PROJECT SITE AT ALL TIMES UNTIL THE PROJECT IS COMPLETE.
- 2. CONTRACTOR SHALL ALLOW ACCESS TO THE PROJECT SITE DURING REASONABLE HOURS TO ANY LOCAL, COUNTY, OR STATE EMPLOYEE WHO IS INVESTIGATING THE PROJECT'S CONSTRUCTION, OPERATION, MAINTENANCE, OR PERMIT COMPLIANCE.
- 3. ALL SITE EROSION CONTROL MEASURES SHALL BE MAINTAINED BY CONTRACTOR AND SHALL BE REPAIRED OR REPLACED AS NEEDED TO SERVE INTENDED FUNCTION. ADDITIONAL EROSION CONTROL MEASURES MAY BE REQUESTED BY OWNER OR ENGINEER.
- 4. CONTRACTOR SHALL EMPLOY EROSION CONTROL METHODS AS SHOWN AND SPECIFIED IN THE WISCONSIN DEPARTMENT OF NATURAL RESOURCES CONSTRUCTION SITE TECHNICAL STANDARDS AND THE WISDOT EROSION CONTROL PRODUCT ACCEPTABILITY LISTS (PAL).
- 5. ALL EROSION CONTROL MEASURES SHALL BE ADJUSTED TO MEET FIELD CONDITIONS AT THE TIME OF CONSTRUCTION AND SHALL BE INSTALLED PRIOR TO ANY GRADING OR DISTURBANCE OF EXISTING SURFACE MATERIAL ON THE SITE.
- 6. ALL EROSION AND SEDIMENT CONTROL MEASURES WILL BE CHECKED FOR STABILITY AND OPERATION AFTER A RAINFALL OF 0.5 INCHES OR MORE BUT NOT LESS THAN ONCE EVERY WEEK. ANY NEEDED REPAIRS WILL BE MADE IMMEDIATELY. WRITTEN REPORTS WILL BE KEPT OF ALL EROSION AND SEDIMENT CONTROL INSPECTIONS AS REQUIRED BY THE WISCONSIN DEPARTMENT OF NATURAL RESOURCES (WDNR).
- 7. SEDIMENT SOCK OR SILT FENCE SHALL BE INSTALLED IN THE LOCATIONS SHOWN ON THE CONSTRUCTION PLANS PER THE INSTALLATION DETAILS. SEDIMENT DEPOSITS SHALL BE REMOVED FROM BEHIND THE SILT SOCK OR SILT FENCE WHEN DEPOSITS REACH A DEPTH OF 6 INCHES. THE SILT SOCK OR SILT FENCE SHALL BE REPAIRED OR REPLACED AS NECESSARY TO MAINTAIN A
- 8. EROSION CONTROL MEASURES SHALL BE MAINTAINED ON A CONTINUING BASIS UNTIL THE SITE IS PERMANENTLY STABILIZED. SITE STABILIZATION INVOLVING SEEDING WHICH IS NOT COMPLETED PRIOR TO SEPTEMBER 15 SHALL BE COMPLETED WITH DORMANT SEEDING BY NOVEMBER 1.
- 9. EROSION CONTROL MEASURES MUST BE IN PLACE AT THE END OF EACH WORK DAY.
- 10. ALL OFF-SITE SEDIMENT DEPOSITS OCCURRING AS A RESULT OF CONSTRUCTION WORK OR A STORM EVENT SHALL BE CLEANED UP BY THE END OF EACH DAY. FLUSHING SHALL NOT BE ALLOWED.
- 11. WHERE CONSTRUCTION ACTIVITIES HAVE PERMANENTLY CEASED OR HAVE BEEN TEMPORARILY SUSPENDED FOR MORE THAN FOURTEEN DAYS, OR WHEN FINAL GRADES ARE REACHED IN ANY PORTION OF THE SITE, STABILIZATION SHALL BE IMPLEMENTED WITHIN SEVEN DAYS. TEMPORARY STABILIZATION PRACTICES SUCH AS MULCH/TACKIFIER, EROSION MAT, OR WISDOT TYPE B SOIL STABILIZER SHALL BE APPLIED TO THE SOIL SURFACE WHEN THE SITE IS NOT READY FOR PERMANENT RESTORATION. WHEN STABILIZATION IS NOT POSSIBLE DUE TO SNOW COVER, STABILIZATION MEASURES SHALL BE INITIATED AS SOON AS POSSIBLE.
- 12. ALL EXCESS MATERIAL SHALL BE STOCKPILED AT LOCATIONS APPROVED BY THE ENGINEER PRIOR TO PLACEMENT OF ANY MATERIAL. STOCKPILES SHALL BE ENCLOSED WITH SILT FENCE/SILT SOCK UNTIL TEMPORARY OR PERMANENT VEGETATIVE COVER IS ESTABLISHED.
- 13. DUST CONTROL SHALL BE IMPLEMENTED THROUGHOUT CONSTRUCTION AND SHALL UTILIZE THE METHODS OUTLINED IN WDNR TECH STD. 1068
- 14. THE REMOVAL OF VEGETATIVE COVER AND EXPOSURE OF THE BARE GROUND MUST BE RESTRICTED TO THE MINIMUM AMOUNT NECESSARY FOR CONSTRUCTION. AREAS WHERE SOIL IS EXPOSED MUST BE PROTECTED FROM EROSION BY SEEDING AND MULCHING, SODDING, DIVERSION OF SURFACE RUNOFF, INSTALLATION OF STRAW BALES OR SILT SCREENS, CONSTRUCTION OF SETTLING BASINS, OR SIMILAR METHODS AS SOON AS POSSIBLE AFTER REMOVAL OF THE ORIGINAL GROUND COVER AS DESCRIBED IN THE WISCONSIN DNR TECHNICAL STANDARDS. ANY STOCKPILE THAT REMAINS OVER 7 DAYS MUST BE STABILIZED WITH MIXTURE NO. 20 FROM THE WISDOT SECTION 630.
- 15. STORM WATER AND GROUND WATER PUMPED FROM EXCAVATIONS AND/OR DEWATERING WELLS SHALL BE DISPOSED OF IN ACCORDANCE WITH THE WISCONSIN STATUTES. SEDIMENT BASINS, SEDIMENT TRAPS, AND/OR POLYMERS TO CONTROL SEDIMENT SHALL BE UTILIZED AND MEET THE REQUIREMENTS OF THE WISCONSIN WDNR TECHNICAL STANDARDS.
- 16. AFTER THE SITE IS UNIFORMLY STABILIZED ACROSS 80% OF THE SITE AREA, OR PRIOR TO AT THE DIRECTION OF THE ENGINEER, ALL TEMPORARY EROSION CONTROL MEASURES MUST BE REMOVED AND DISPOSED OF PROPERLY. THE CONTRACTOR SHALL MAKE ALL REPAIRS OF LAWNS AND LANDSCAPED AREAS FOLLOWING THE REMOVAL OF SILT SOCKS AND STAKES.

ANTICIPATED CONSTRUCTION SCHEDULE:


- 1. INSTALL CONSTRUCTION FENCE, TRACKING PAD, SILT FENCE OR SILT SOCKS, AND OTHER EROSION CONTROL AS DETAILED ON THE PLANS.
- 2. DEMOLISH AND REMOVE EXISTING POOL VESSEL AND POOL DECK.
- 3. DEMOLISH EXISTING POOL BUILDING.
- 4. REPLACE EXISTING UTILITY LATERALS, INSTALL POOL PLUMBING.
- 5. BEGIN PROPOSED POOL BUILDING CONSTRUCTION.
- 6. CONSTRUCT POOL VESSELS.
- 7. CONSTRUCT CONCRETE POOL DECK, SIDEWALKS, AND NEW ASPHALT PARKING LOT.
- 8. TOPSOIL AND RESTORE ALL DISTURBED AREAS WITH SEED AND MULCH OR SOD.
- 9. REMOVE EROSION CONTROL DEVICES ONCE THE SITE REACHES 80% VEGETATIVE COVER.


TEMPORARY RESTORATION NOTES

- 1. FILL SLOPES AROUND THE NEW POOL AREA MUST BE TEMPORARILY OR PERMANENTLY STABILIZED IMMEDIATELY AFTER GRADING IS COMPLETED, AND BEFORE OCTOBER 15TH SO THEY DO NOT REMAIN OPEN TO EROSIVE ACTIVITY OVER THE WINTER MONTHS. PERMANENT RESTORATION IS PREFERRED IF THE CONSTRUCTION SCHEDULE AND WEATHER ALLOWS. INSTALL SLOPE INTERRUPTION DEVICES (SILT SOCK) HORIZONTALLY ALONG THE SLOPES PER WDNR TECHNICAL STANDARD 1071 AND AS SHOWN ON THE GRADING PLAN.
- 2. DISTURBED AREAS SHALL BE STABILIZED PRIOR TO WINTER WITH TEMPORARY SEEDING OR OTHER APPROVED METHODS. TEMPORARY SEED MIXES SHALL BE AS SHOWN. CONTRACTOR MAY NEED TO WATER RESTORED AREAS TO ENSURE GROWTH. WATERING SHALL BE INCIDENTAL.
 - *SEEDING RATES ARE AS FOLLOWS:
 - -CONTRACTOR TO USE WINTER WHEAT OR CEREAL RYE AT A RATE OF 131 LBS/ACRE.
 - -CONTRACTOR TO USE ANNUAL RYE AT A RATE OF 80 LBS/ACRE.

AFTER SEPTEMBER 15TH, A COOL WEATHER SEEDING COVER CROP MUST BE APPLIED (I.E. OATS)
AFTER OCTOBER 15TH, A DORMANT SEEDING COVER CROP MUST BE APPLIED (I.E. WINTER WHEAT)
AFTER NOVEMBER 15TH, A DORMANT SEEDING MUST BE APPLIED WITH AN ACCEPTABLE SOIL
STABILIZER. (POLYACRYLIMIDE).



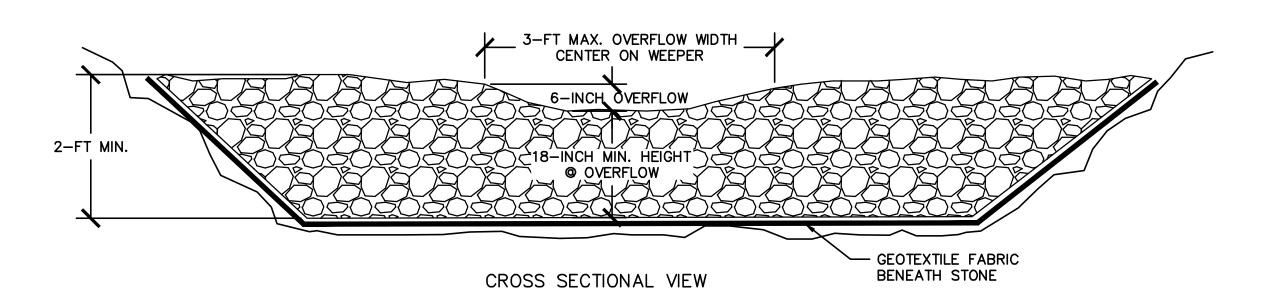

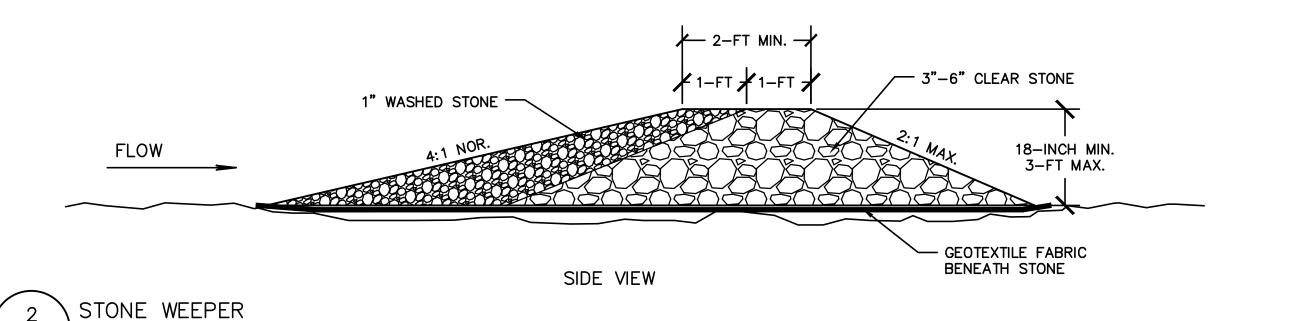


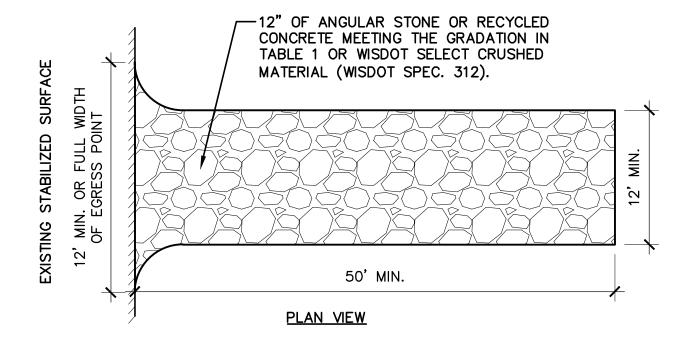


TABLE 1				
SIEVE SIZE	PERCENT PASSING BY WEIGHT			
3"	100			
2 1/2"	90 - 100			
1 1/2"	25 - 60			
3/4"	0 - 20			
3/8"	5/1/2000			

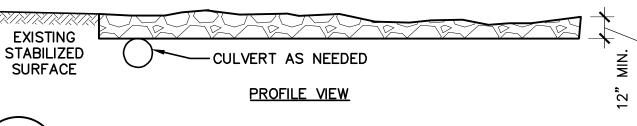

1 STONE TRACKING PAD

C102

C102

NTS

NTS



5201 E. Terrace Drive Suite 200 Madison, WI 53718 608.443.1200 www.AyresAssociates.com



ICONICA

901 Deming Way // Madison, WI 53717 Ph: 608.664.3500 // Fx: 608.664.3535 iconicacreates.com





Milwaukee:
20855 Watertown Rd, Suite 170
Waukesha, Wisconsin 53186
T 262.901.0626
Website: http://www.henneman.com

Project Name

Revision

BUCHNER PARK POOL



City of Waukesha 223 Oakland Ave. Waukesha, WI 53186

Drawn By: JW
Checked By: BM
File: P-EX
Issued For: Review

Project No. 52-0684.00

Sheet Title


GENERAL NOTES





Sheet Number

C102

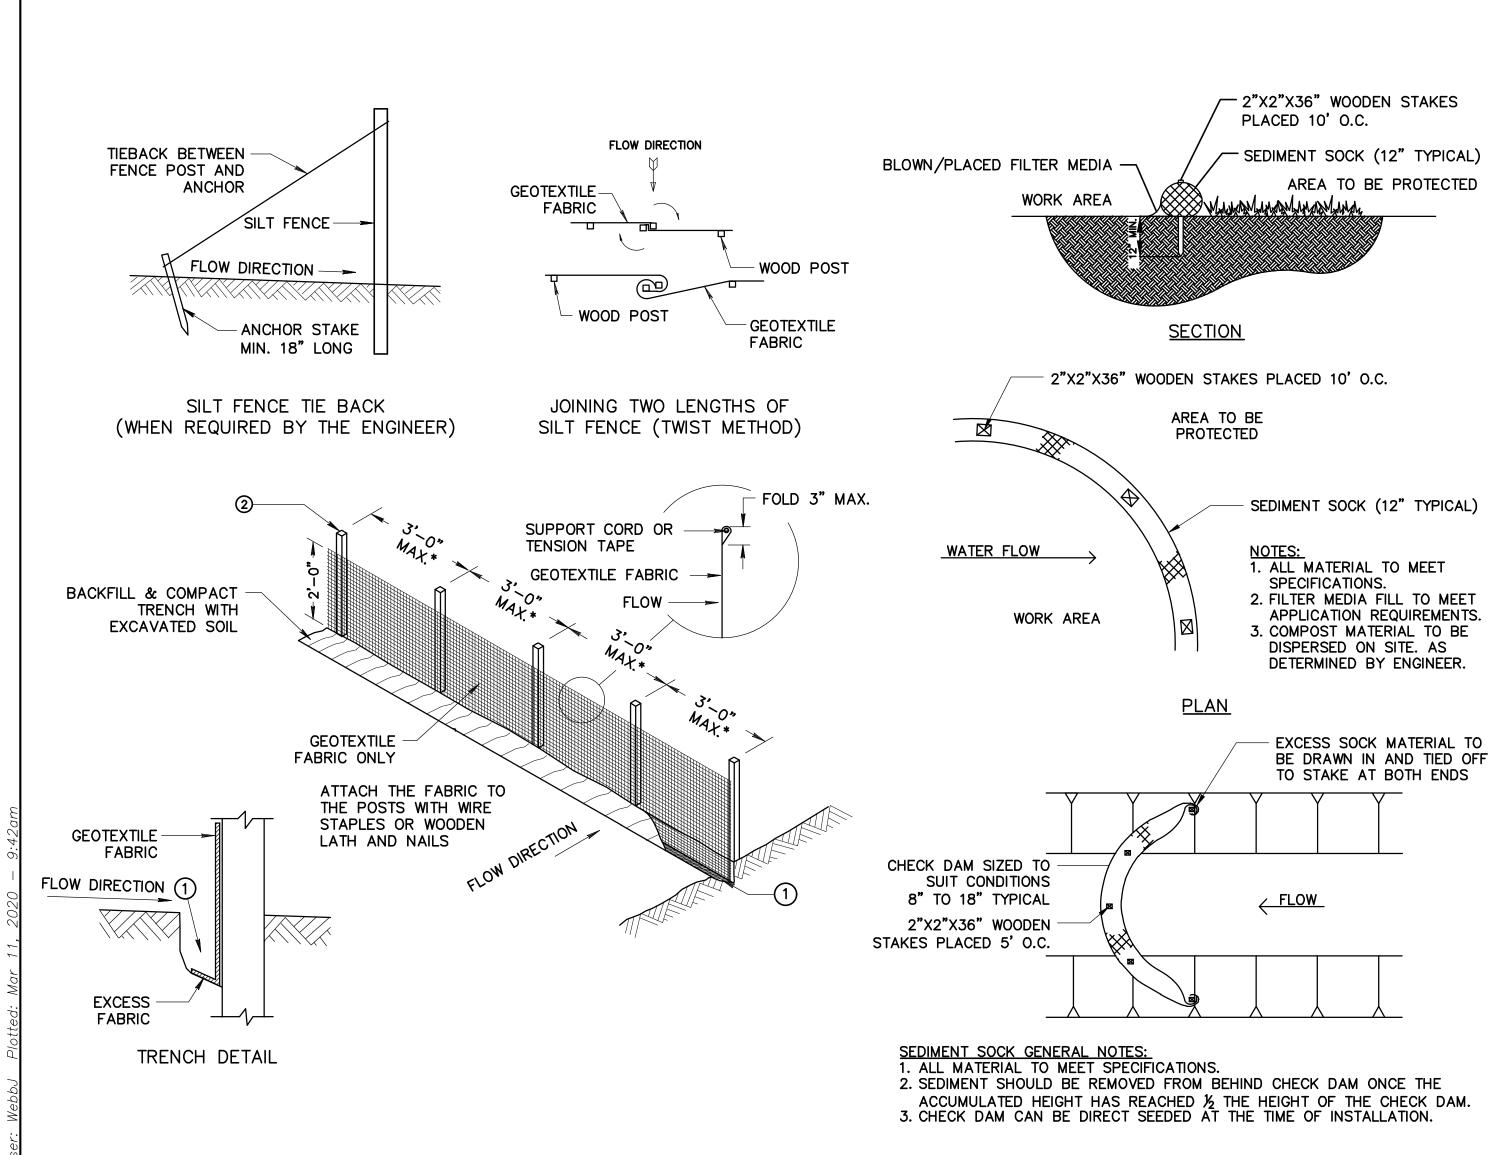

SILT FENCE GENERAL NOTES:

- (1) FOR MANUAL INSTALLATIONS THE TRENCH SHALL BE A MINIMUM OF 4" WIDE & 6" DEEP TO BURY AND ANCHOR THE GEOTEXTILE FABRIC. FOLD MATERIAL TO FIT TRENCH AND BACKFILL & COMPACT TRENCH WITH EXCAVATED SOIL.
- (2) WOOD POSTS SHALL BE A MINIMUM SIZE OF 3' LENGTH OF OAK OR HICKORY
- (3) ADDITIONAL POST DEPTH OR TIE BACKS MAY BE REQUIRED IN UNSTABLE SOILS
- (4) DETAILS OF CONSTRUCTION NOT SHOWN ON THIS DRAWING SHALL CONFORM TO THE PERTINENT REQUIREMENTS OF THE STANDARD SPECIFICATIONS AND APPLICABLE SPECIAL PROVISIONS.
- (5) THE MAXIMUM SPACING OF POSTS FOR WOVEN FABRIC SILT FENCE SHALL BE 8 FEET AND FOR NON-WOVEN FABRIC, 3 FEET.
- (6) 8" OF FENCE FABRIC REQUIRED BELOW GRADE IN TRENCH PER DNR TECH STD. 1056
- (7) MANUFACTURED ALTERNATIVES APPROVED AND LISTED ON THE WDOT PRODUCT ACCEPTABILITY LIST MAY BE SUBSTITUTED.
- (8) FINISHED SIZE, INCLUDING FLAP POCKETS WHERE REQUIRED, SHALL EXTEND A MINIMUM OF 10" AROUND THE PERIMETER TO FACILITATE MAINTENANCE OR REMOVAL.
- (9) FLAP POCKETS SHALL BE LARGE ENOUGH TO ACCEPT WOOD 2"X4".
- (10) EROSION CONTROL SHALL BE PROVIDED IN ACCORDANCE WITH WDNR TECHNICAL STANDARD.
- (11) CROSS BRACE WITH 2" X 4" WOODEN FRAME OR EQUIVALENT AT TOP OF POSTS AS DIRECTED BY THE ENGINEER.
- (12) MINIMUM 14 GAUGE WIRE REQUIRED, FOLD FABRIC 3" OVER THE WIRE AND STAPLE OR PLACE WIRE RINGS ON 12" C.C.
- (13) WIRE SUPPORT FENCE SHALL BE 14 GAUGE MINIMUM WOVEN WIRE WITH A MAXIMUM MESH SPACING OF 6". SECURE TOP OF GEOTEXTILE FABRIC TO TOP OF FENCE WITH STAPLES OR WIRE RINGS AT 12" C.C. (TYPE B)
- (14) GEOTEXTILE FABRIC SHALL BE REINFORCED WITH AN INDUSTRIAL POLYPROPYLENE NETTING WITH A MAXIMUM MESH SPACING OF 3/4" OR EQUAL. A HEAVY DUTY NYLON TOP SUPPORT CORD OR EQUIVALENT IS REQUIRED. (TYPE A)
- (15) STEEL POSTS SHALL BE STUDDED "TEE" OR "U" TYPE WITH A MINIMUM WEIGHT OF 1.28 LBS./LIN. FT. (WITHOUT ANCHOR) FIN ANCHORS SUFFICIENT TO RESIST POST MOVEMENT ARE REQUIRED. WOOD POSTS SHALL BE A MINIMUM SIZE OF 1 1/8" X 1 1/8" OF OAK OR HICKORY.
- (16) CONSTRUCT SILT FENCE FROM A CONTINUOUS ROLL, IF POSSIBLE, BY CUTTING LENGTHS TO AVOID JOINTS. IF A JOINT IS NECESSARY, USE ONE OF THE FOLLOWING TWO METHODS: A.) TWIST METHOD -- OVERLAP THE END POSTS AND TWIST, OR ROTATE, AT LEAST 180 DEGREES, B:) HOOK METHOD -- HOOK THE END OF EACH SILT FENCE LENGTH.

NTS

ONSITE CONCRETE WASHOUT STRUCTURE

GENERAL NOTES: CONSTRUCT PER WDNR TECHNICAL STANDARD 1060 INLET PROTECTION DEVICES SHALL BE MAINTAINED OR REPLACED AT THE DIRECTION OF THE ENGINEER. INLET PROTECTION DEVICES SHALL BE MAINTAINED OR REPLACED AT THE


TYPE B

WHEN REMOVING OR MAINTAINING INLET PROTECTION, CARE SHALL BE TAKEN SO THAT THE SEDIMENT TRAPPED ON THE GEOTEXTILE FABRIC DOES NOT FALL INTO THE INLET. ANY MATERIAL FALLING INTO THE INLET SHALL BE REMOVED IMMEDIATELY

(1) FINISHED SIZE, INCLUDING FLAP POCKETS WHERE REQUIRED, SHALL EXTEND A MINIMUM OF 10" AROUND THE PERIMETER TO FACILITATE MAINTENANCE OR REMOVAL

INLET PROTECTION TYPE D SHALL BE INSTALLED ON ALL INLETS GREATER THAN 30" DEEP. USE INLET PROTECTION TYPE B ON SHALLOWER INLETS.

NLET PROTECTION TYPES B & D C103

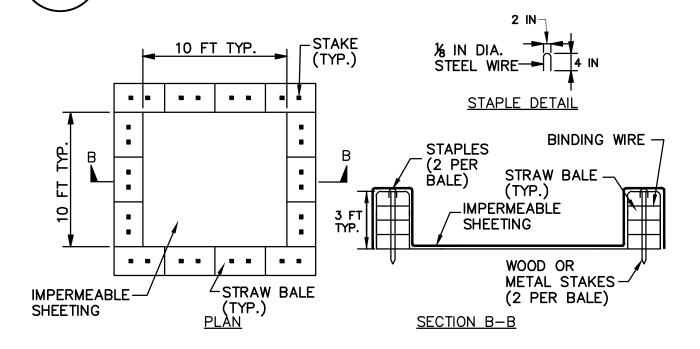

- INLET SPECIFICATIONS AS PER THE PLAN DIMENSION LENGTH AND

WHEN REMOVING OR MAINTAINING INLET PROTECTION. CARE SHALL BE

TAKEN SO THAT THE SEDIMENT TRAPPED ON THE GEOTEXTILE FABRIC

DOES NOT FALL INTO THE INLET. ANY MATERIAL FALLING INTO THE

EXTEND A MINIMUM OF 10" AROUND THE PERIMETER TO FACILITATE

(2) FOR INSTALLATION WITH CURB BOX, AN ADDITIONAL 18" OF FABRIC IS WRAPPED AROUND THE WOOD AND SECURED WITH STAPLES. THE WOOD

SHALL NOT BLOCK THE ENTIRE HEIGHT OF THE CURB BOX OPENING.

(1) FINISHED SIZE, INCLUDING FLAP POCKETS WHERE REQUIRED, SHALL

(3) FLAP POCKETS SHALL BE LARGE ENOUGH TO ACCEPT WOOD 2x4.

CONSTRUCT PER WDNR TECHNICAL STANDARD 1060.

FLAP POCKET

USE REBAR OR STEEL ─ ROD FOR REMOVAL

PLASTIC TIES

" X 6" OVAL HOLE

SHALL BE HEAT CUT

INTO ALL FOUR SIDE

PANELS.

FOR INLETS WITH CAST CURB

10" BEYOND GRATE WIDTH ON

BOTH SIDES, LENGTH VARIES.

BOX USE WOOD 2" X 4", EXTEND

SECURE TO GRATE WITH WIRE OR

WIDTH TO MATCH

GEOTEXTILE

POCKETS.

DIRECTION OF THE ENGINEER.

MAINTENANCE OR REMOVAL

INLET SHALL BE REMOVED IMMEDIATELY

FABRIC.

TYPE FF

FRONT, BACK, AND

BOTTOM TO BE MADE

FROM SINGLE PIECE

MINIMUM DOUBLE STITCHED

SEAMS ALL AROUND SIDE

OF FABRIC.

PIECES AND ON FLAP

GENERAL NOTES:

TYPE D

NOTE: CAN BE TWO STACKED BALES OR PARTIALLY EXCAVATED TO REACH 3 FT DEPTH

CONSTRUCTION SPECIFICATIONS

- 1. LOCATE WASHOUT STRUCTURE A MINIMUM OF 50 FEET AWAY FROM OPEN CHANNELS, STORM DRAIN INLETS, SENSITIVE AREAS, WETLANDS, BUFFERS AND WATER COURSES AND AWAY FROM CONSTRUCTION TRAFFIC.
- 2. SIZE WASHOUT STRUCTURE FOR VOLUME NECESSARY TO CONTAIN WASH WATER AND SOLIDS AND MAINTAIN AT LEAST 4 INCHES OF FREEBOARD. TYPICAL DIMENSIONS ARE 10 FEET X 10 FEET X 3 FEET DEEP.
- 3. PREPARE SOIL BASE FREE OF ROCKS OR OTHER DEBRIS THAT MAY CAUSE TEARS OR HOLES IN THE LINER. FOR LINER, USE 10 MIL OR THICKER UV RESISTANT, IMPERMEABLE SHEETING, FREE OF HOLES AND TEARS OR OTHER DEFECTS THAT COMPROMISE IMPERMEABILITY OF THE MATERIAL.
- 4. PROVIDE A SIGN FOR THE WASHOUT IN CLOSE PROXIMITY TO THE FACILITY.
- 5. KEEP CONCRETE WASHOUT STRUCTURE WATER TIGHT. REPLACE IMPERMEABLE LINER IF DAMAGED (E.G., RIPPED OR PUNCTURED). EMPTY OR REPLACE WASHOUT STRUCTURE THAT IS 75 PERCENT FULL, AND DISPOSE OF ACCUMULATED MATERIAL PROPERLY. DO NOT REUSE PLASTIC LINER. WET-VACUUM STORED LIQUIDS THAT HAVE NOT EVAPORATED AND DISPOSE OF IN AN APPROVED MANNER. PRIOR TO FORECASTED RAINSTORMS, REMOVE LIQUIDS OR COVER STRUCTURE TO PREVENT OVERFLOWS. REMOVE HARDENED SOLIDS, WHOLE OR BROKEN UP, FOR DISPOSAL OR RECYCLING, MAINTAIN RUNOFF DIVERSION AROUND EXCAVATED WASHOUT STRUCTURE UNTIL STRUCTURE IS REMOVED.

EXISTING TREE MINIMUM 4'_ CONSTRUCTION FENCING **TYPICAL** 5' MIN. FENCE POST

NTS

- 1. NO ENTRY, NO STORAGE & NO TRENCHING IN TREE PROTECTION ZONE DURING ENTIRE SITE CONSTRUCTION.
- 2. FENCING TO BE LOCATED 2' BEYOND THE TREE'S DRIP LINE WHERE POSSIBLE.

TREE PROTECTION

GEOTEXTILE

FABRIC.

TYPE FF

5201 E. Terrace Drive Suite 200



Madison, WI 53718

www.AyresAssociates.com

608.443.1200

ICONICA 901 Deming Way // Madison, WI 53717

Ph: 608.664.3500 // Fx: 608.664.3535

iconicacreates.com





20855 Watertown Rd, Suite 170 Waukesha, Wisconsin 53186 **T** 262.901.0626 **Website:** http://www.henneman.com

Revision

Project Name

NTS

BUCHNER PARK POOL



City of Waukesha 223 Oakland Ave. Waukesha, WI 53186

Drawn By: Checked By: P-EX Review Issued For: Issue Date: 03.11.2020 Project No. 52-0684.00

Sheet Title


DEMOLITION & E.C. NOTES



Sheet Number

NTS

SILT FENCE AND SEDIMENT SOCK

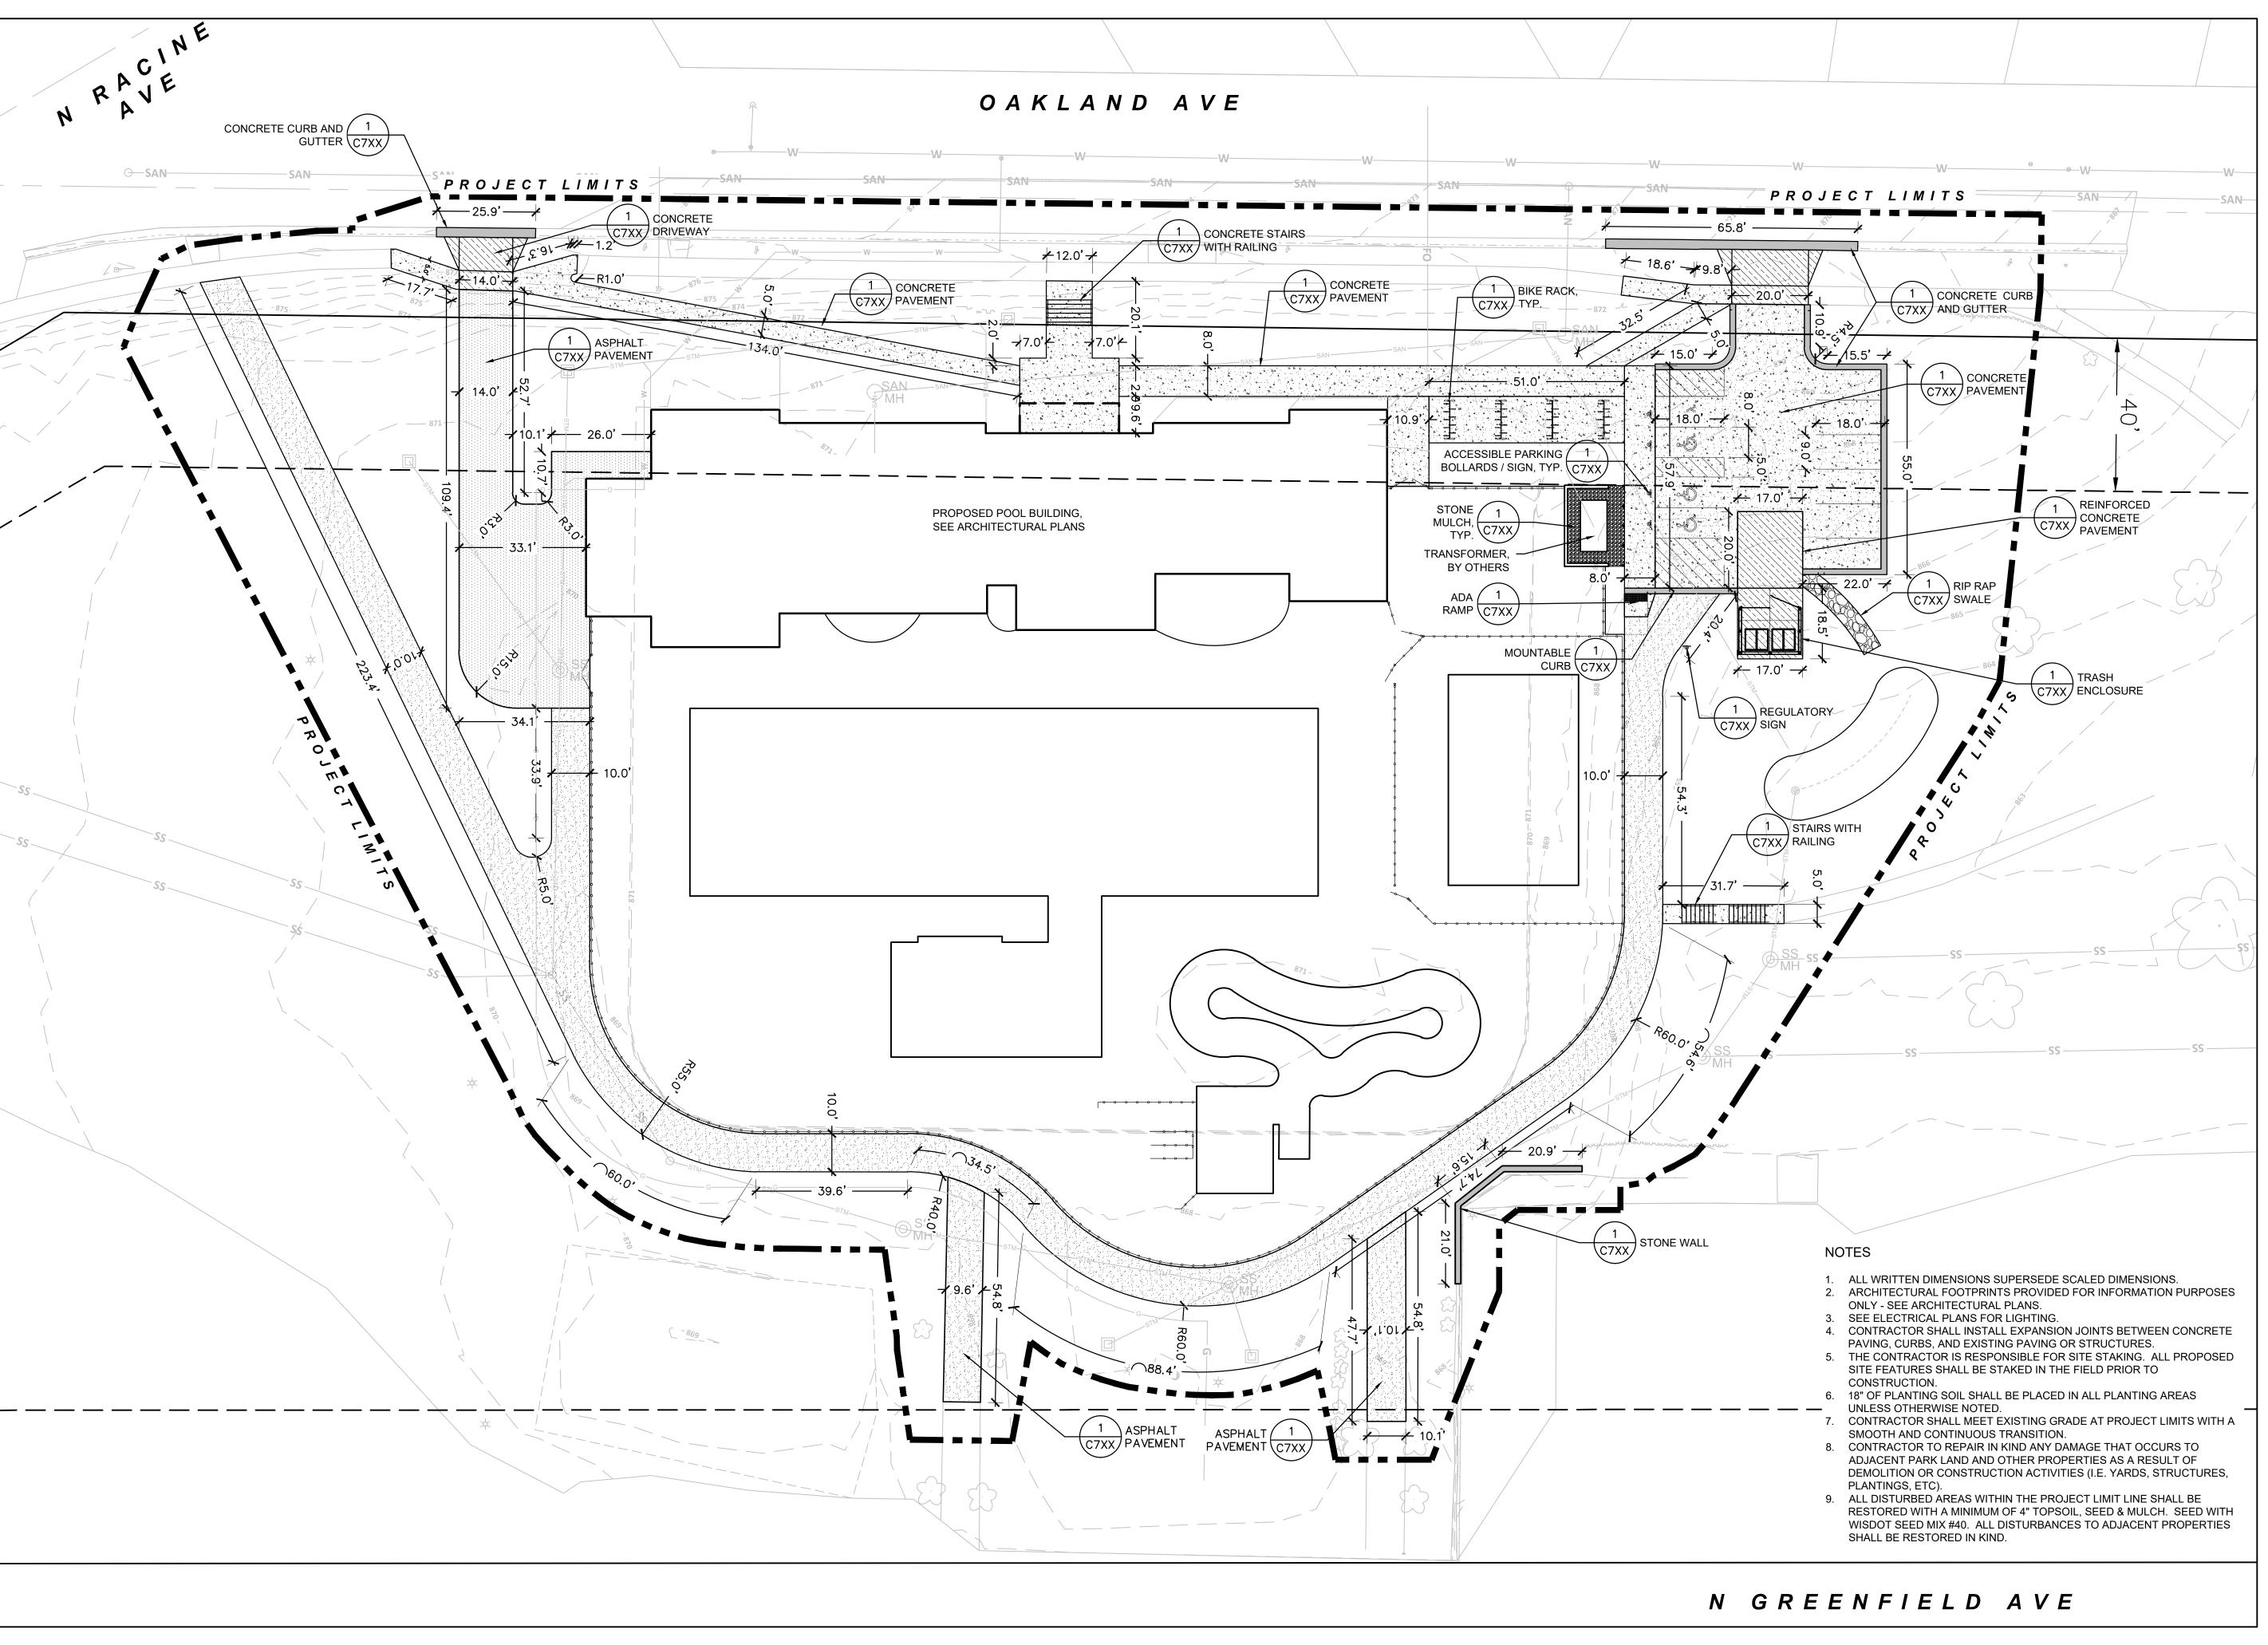

AYRES

5201 E. Terrace Drive Suite 200 Madison, WI 53718 608.443.1200 www.AyresAssociates.com



ICONICA

901 Deming Way // Madison, WI 53717 Ph: 608.664.3500 // Fx: 608.664.3535





Milwaukee:
20855 Watertown Rd, Suite 170
Waukesha, Wisconsin 53186
T 262.901.0626
Website: http://www.henneman.com

Revision Date

Project Name

BUCHNER PARK POOL

MOTFORTION

City of Waukesha 223 Oakland Ave. Waukesha, WI 53186

Drawn By: RS
Checked By: BM
File: P-SP
Issued For: Review

Issue Date: 03.11.2020 Project No. 52-0684.00

Sheet Title


SITE LAYOUT
PLAN



North 0 10' 20'

Sheet Number

C200

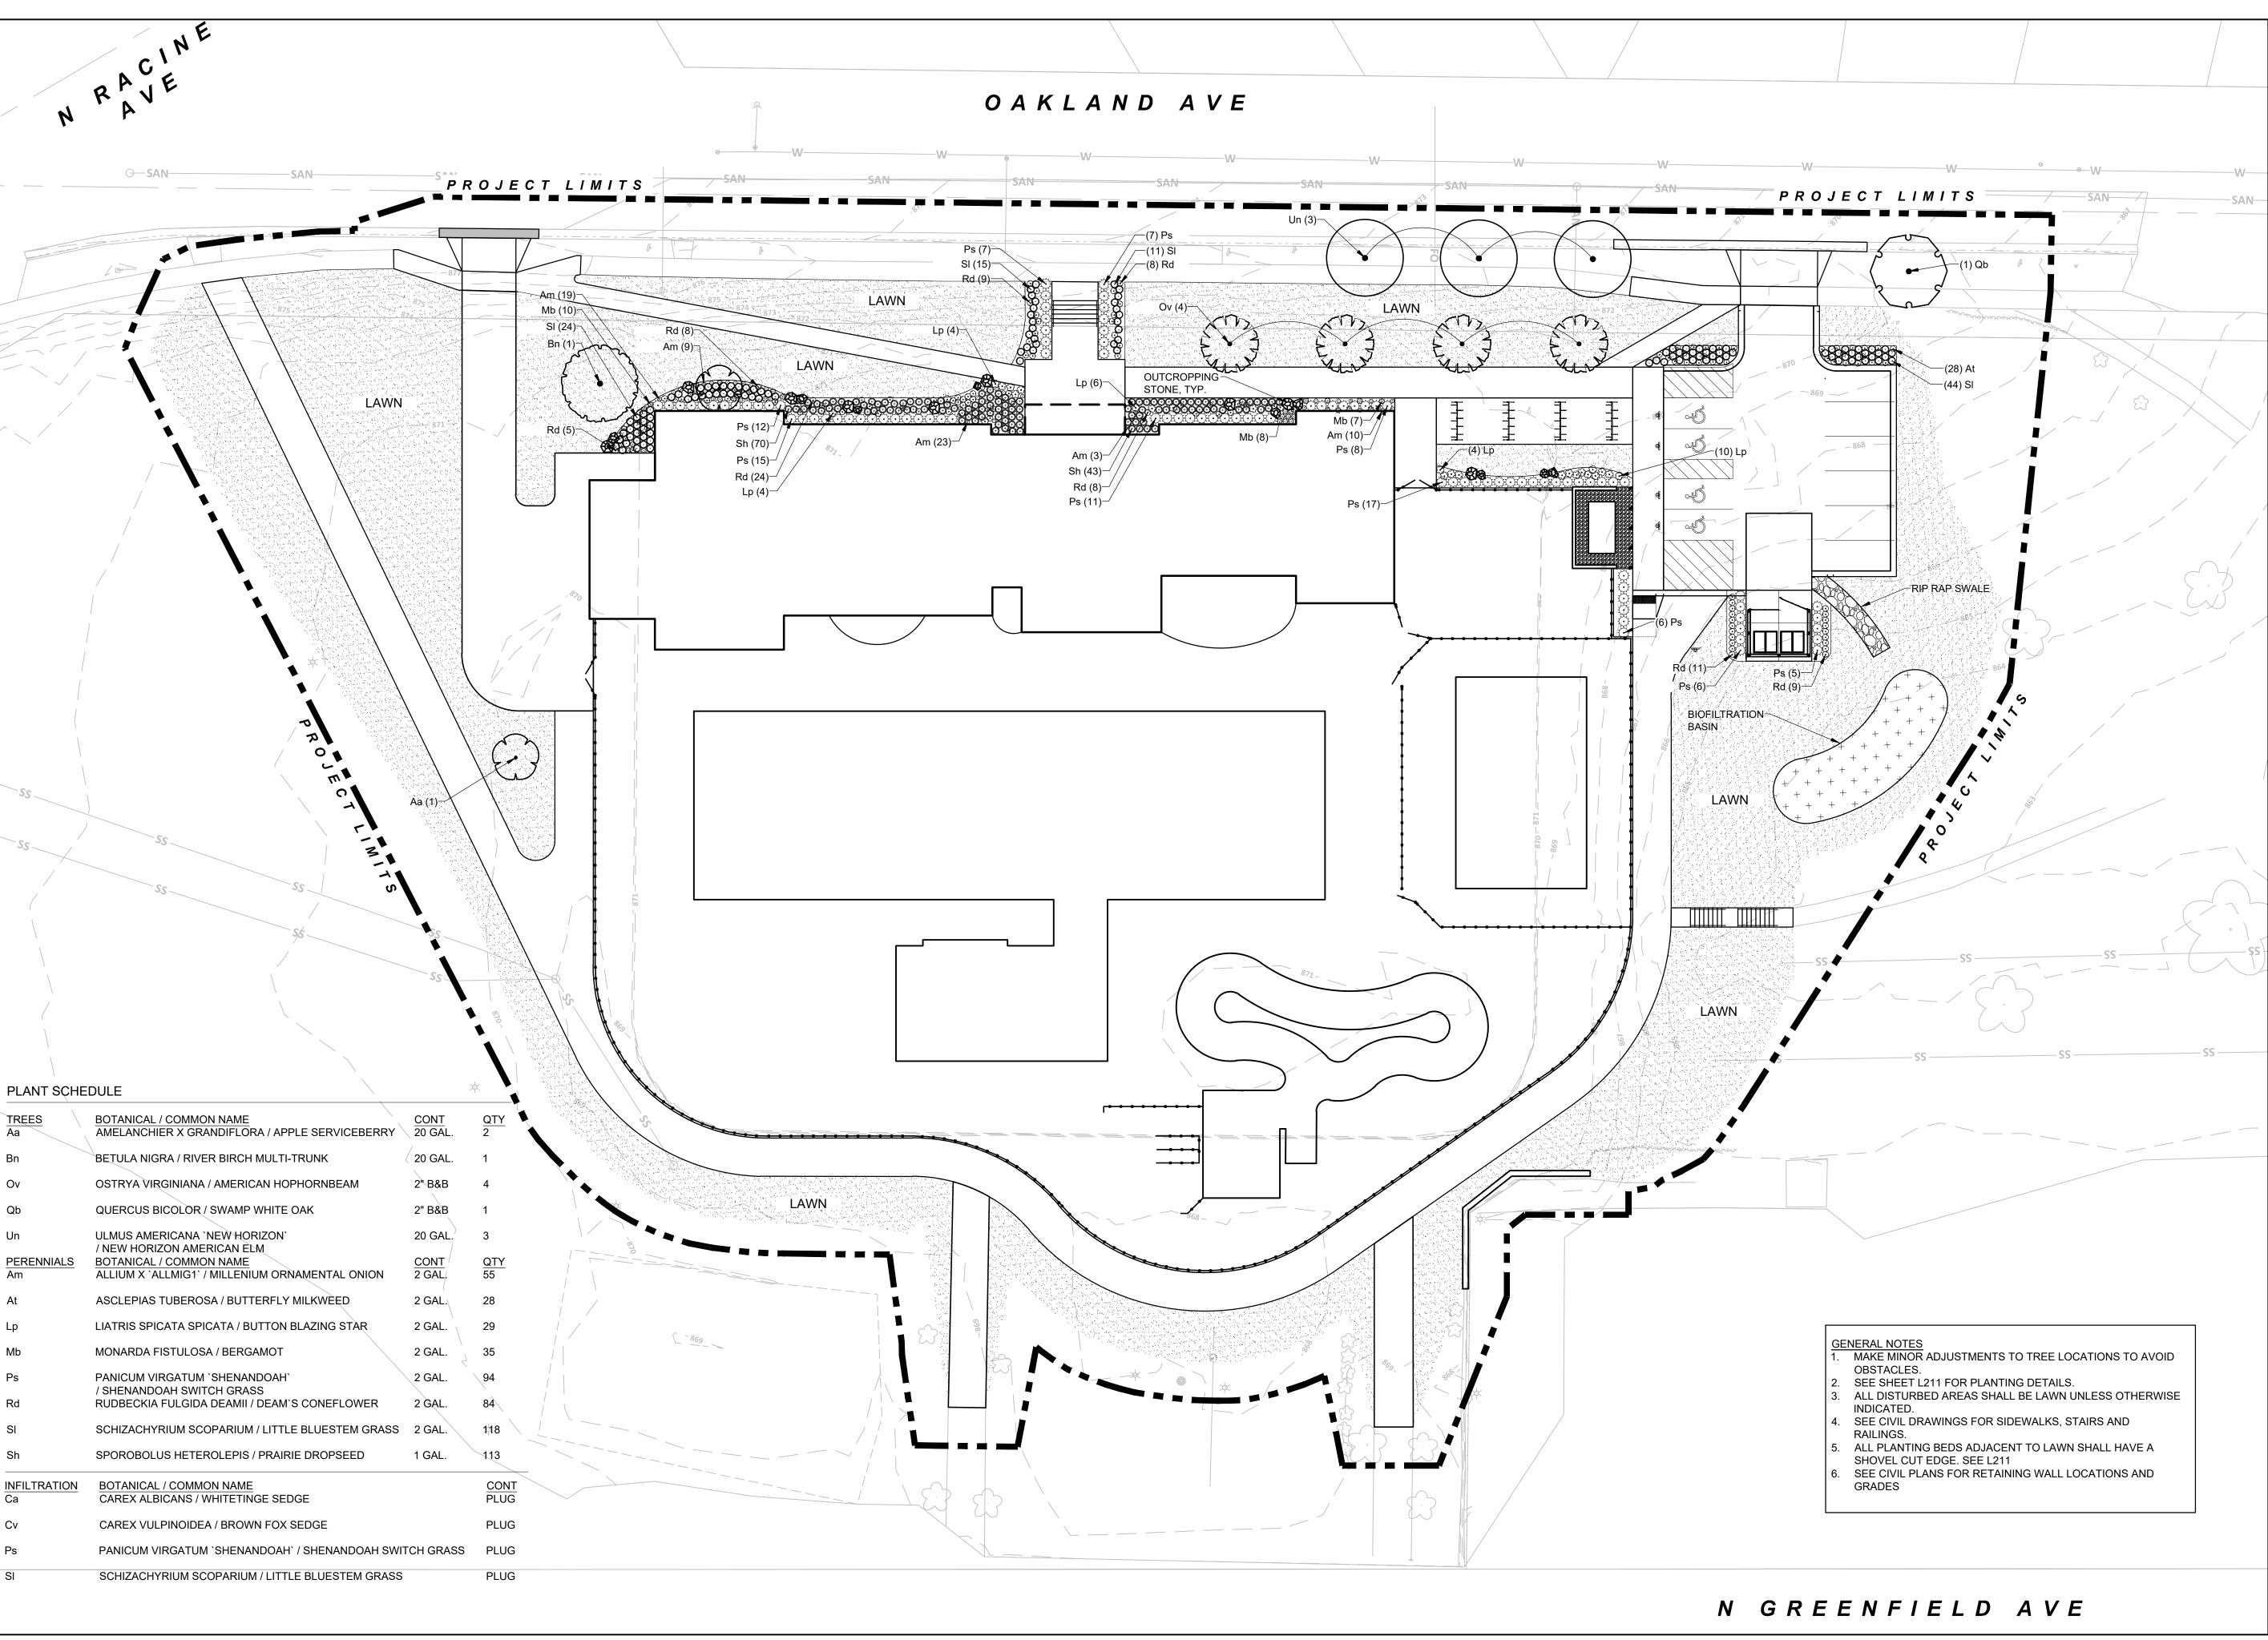

AYRES

5201 E. Terrace Drive Suite 200 Madison, WI 53718 608.443.1200 www.AyresAssociates.com



ICONICA

901 Deming Way // Madison, WI 53717 Ph: 608.664.3500 // Fx: 608.664.3535 iconicacreates.com





Milwaukee:
20855 Watertown Rd, Suite 170
Waukesha, Wisconsin 53186
T 262.901.0626
Website: http://www.henneman.com

Revision Date

Project Name

BUCHNER PARK POOL

NOTFORTION

City of Waukesha 223 Oakland Ave. Waukesha, WI 53186

Drawn By: RS
Checked By: BM
File: P-LS
Issued For: Review
Issue Date: 03.11.2020

Project No. 52-0684.00

Sheet Title

LANDSCAPE PLAN



North 20'

Sheet Number

C210

B&B TREE PLANTING DETAILS

C211

RESTORATION GENERAL NOTES:

- 1. CONTRACTOR MUST HAVE A COPY OF THE WDNR WPDES PERMIT, LOCAL PERMITS, AND APPROVED PLANS AVAILABLE AT THE PROJECT SITE AT ALL TIMES UNTIL THE PROJECT IS COMPLETE.
- 2. CONTRACTOR SHALL ALLOW ACCESS TO THE PROJECT SITE DURING REASONABLE HOURS TO ANY LOCAL, COUNTY, OR STATE EMPLOYEE WHO IS INVESTIGATING THE PROJECT'S CONSTRUCTION, OPERATION, MAINTENANCE, OR PERMIT COMPLIANCE.
- 3. EROSION CONTROL MEASURES SHALL BE MAINTAINED ON A CONTINUING BASIS UNTIL THE SITE IS PERMANENTLY STABILIZED. SITE STABILIZATION INVOLVING SEEDING WHICH IS NOT COMPLETED PRIOR TO SEPTEMBER 15 SHALL BE COMPLETED WITH DORMANT SEEDING BY NOVEMBER 1.
- 4. WHERE CONSTRUCTION ACTIVITIES HAVE PERMANENTLY CEASED OR HAVE BEEN TEMPORARILY SUSPENDED FOR MORE THAN FOURTEEN DAYS, OR WHEN FINAL GRADES ARE REACHED IN ANY PORTION OF THE SITE, STABILIZATION SHALL BE IMPLEMENTED WITHIN SEVEN DAYS. TEMPORARY STABILIZATION PRACTICES SUCH AS MULCH/TACKIFIER, EROSION MAT, OR WISDOT TYPE B SOIL STABILIZER SHALL BE APPLIED TO THE SOIL SURFACE WHEN THE SITE IS NOT READY FOR PERMANENT RESTORATION. WHEN STABILIZATION IS NOT POSSIBLE DUE TO SNOW COVER, STABILIZATION MEASURES SHALL BE INITIATED AS SOON AS POSSIBLE.
- 5. AFTER THE SITE IS UNIFORMLY STABILIZED ACROSS 80% OF THE SITE AREA, OR PRIOR TO AT THE DIRECTION OF THE ENGINEER, ALL TEMPORARY EROSION CONTROL MEASURES MUST BE REMOVED AND DISPOSED OF PROPERLY. THE CONTRACTOR SHALL MAKE ALL REPAIRS OF LAWNS AND LANDSCAPED AREAS FOLLOWING THE REMOVAL OF SILT SOCKS AND STAKES.

EROSION MAT NOTES

- 1. URBAN CLASS I, TYPE A OR B EROSION MAT IS REQUIRED ON ALL SLOPES GREATER THAN 3:1 OR AS REQUIRED BY THE ENGINEER. NO PHOTOBIODEGRADABLE MATERIALS WILL BE ACCEPTED.
- 2. EROSION MAT IS REQUIRED ALONG ALL CHANNEL BOTTOMS, MINIMUM 5-FT WIDTH. SUGGESTED LOCATIONS ARE SHOWN, ADDITIONAL AREAS AS REQUIRED BY THE ENGINEER. USE URBAN CLASS I, TYPE B ON CHANNELS LESS THAN 2% SLOPE; CLASS II, TYPE B OR C ON CHANNELS GREATER THAN 2% SLOPE.
- 3. EROSION MAT SHALL CONSIST ENTIRELY OF BIODEGRADABLE COMPONENTS. NO PHOTOBIODEGRADABLE MATERIALS WILL BE ACCEPTED.

PERMANENT RESTORATION NOTES

- 1. CONTRACTOR SHALL MEET EXISTING GRADE AT PROJECT LIMITS WITH A SMOOTH AND CONTINUOUS TRANSITION.
- 2. SEED/SOD PLACEMENT SHALL EXTEND TO THE LIMITS OF CONSTRUCTION DISTURBANCE.
- 3. ALL DISTURBED AREAS WITHIN THE PROJECT LIMIT LINE SHALL BE RESTORED WITH A MINIMUM OF 6" TOPSOIL AND HYDROMULCHED OR SODDED. SEED MIXES SHALL BE AS SHOWN. CONTRACTOR MAY NEED TO WATER RESTORED AREAS TO ENSURE A SUBSTANTIAL CATCH OF TURF GRASS, SOD, PLANTS, AND PLUGS. WATERING SHALL BE INCIDENTAL.

*SEEDING AND STABILIZATION INFORMATION & DEADLINES ARE AS FOLLOWS:

-CONTRACTOR TO USE GENERAL FARM NORTHERN SUNNY TURF MIX AT A RATE OF 6.0 LBS/1000 SF


- LXQ 330 BRAND CREEPING RED FESCUE 19.55%
- SR 2100 KENTUCKY BLUEGRASS 14.81%
- BLAZER 4 PERENNIAL RYEGRASS 14.81%FIELDER KENTUCKY BLUEGRASS 14.78%
- FIESTA 4 PERENNIAL RYEGRASS 14.78%
- WILD HORSE KENTUCKY BLUEGRASS 9.85%
- CHEWING FESCUE 9.82%

-CONTRACTOR TO USE ANNUAL SEEDING AT A RATE OF 2.0 LBS/1000 SF -CONTRACTOR TO APPLY FERTILIZER AT A RATE OF 2 LBS/1000 SF

AFTER SEPTEMBER 15TH, A COOL WEATHER SEEDING COVER CROP MUST BE APPLIED (I.E. OATS)

AFTER OCTOBER 15TH, A DORMANT SEEDING COVER CROP MUST BE APPLIED (I.E. WINTER WHEAT)

AFTER NOVEMBER 15TH, A DORMANT SEEDING MUST BE APPLIED WITH AN ACCEPTABLE SOIL STABILIZER (POLYACRYLIMIDE).

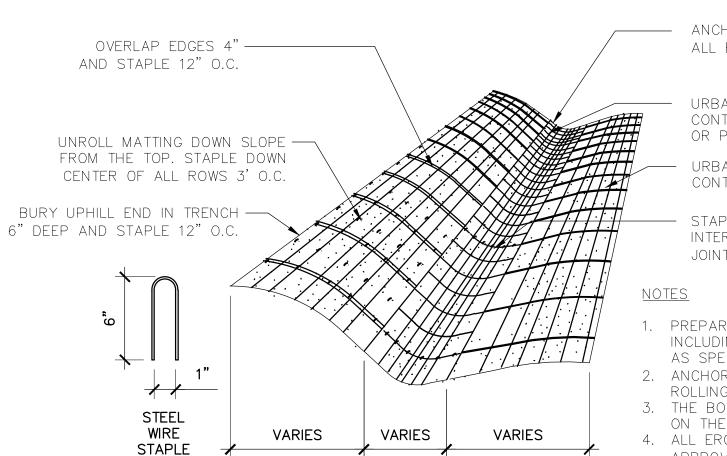

ANCHOR THE BEGINNING AND END OF ALL BLANKET AREAS IN A 6" TRENCH

URBAN CLASS I TYPE B EROSION CONTROL BLANKET IN BOTTOM OF SWALE, OR PER WISDOT CHANNEL MATRIX.

URBAN CLASS I TYPE A OR B EROSION CONTROL BLANKET ON SIDE SLOPES

- STAPLE CLASS I BLANKET AT 20 FT. INTERVALS; AND AT ALL OVERLAP JOINTS 24" O.C.

- 1. PREPARE SOIL BEFORE INSTALLING BLANKET INCLUDING ALL SOIL PREPARATION AND SEEDING AS SPECIFIED.
- 2. ANCHOR BLANKET IN 6" TRENCH PRIOR TO ROLLING DOWN SLOPE.
- 3. THE BOTTOM SECTION OF BLANKET SHOULD BE ON THE DOWNSTREAM SIDE OF ALL OVERLAPS.
 4. ALL EROSION MAT USED ON SITE MUST BE APPROVED BY THE DNR AS A "HERP-FRIENDLY"

VARIETT.

EROSION CONTROL MAT

NTS

AYRES

5201 E. Terrace Drive Suite 200 Madison, WI 53718 608.443.1200 www.AyresAssociates.com



901 Deming Way // Madison, WI 53717

Ph: 608.664.3500 // Fx: 608.664.3535

iconicacreates.com





Milwaukee:
20855 Watertown Rd, Suite 170
Waukesha, Wisconsin 53186
T 262.901.0626
Website: http://www.henneman.com

Project Name

Revision

BUCHNER PARK POOL



City of Waukesha 223 Oakland Ave. Waukesha, WI 53186

Drawn By: JW
Checked By: BM
File: P-EX
Issued For: Review

Issue Date: 03.11.2020 Project No. 52-0684.00

LANDSCAPE DETAILS & NOTES

Sheet Title



0 20'
Sheet Number

C211

NTS

OAKLAND AVE MATCH EXISTING ~ MATCH EXISTING ~ FLOW LINE PROJECT LIMITS FLOW LINE PROJECT LIMITS **EXISTING** WEST STAIR GRADING C871.27 4.2% C874.46 - 871 - R870.41 - R870.93 - MH 2.01 - C871.67 C872.06 TC871.26 C874.57 R871.00 C872.06 C872.09 C872.16. C872 30 P872.23'.34 FF = 872.35P872.20 P872.05 P872.20 P872.16 CURB 3 OPENING > OPENING PARKING LOT 1.5% ADA RAMP P872.34 GRADING R872.23 SS1 12" REVEAL P871.85 P872.20 P871.91 P872.35 APPROXIMATE -GRADING LIMITS P871.65 P871.85 ~6" REVEAL: P871.85 6" REVEAL TYPICAL **EXISTING** NORTH STAIR GRADING APPROXIMATE POOL DECK GRADING LIMITS FF = 872.25 P871.71 R872.01 SS SPOT ELEVATION ABBREVIATIONS: P = PROPOSED ASPHALT EG = EXISTING GRADE C = PROPOSED CONCRETE (-869 **GRADING NOTES** FS = FINISHED SURFACE FF = FINISHED FLOOR TC = TOP OF CURB1. CONTRACTOR SHALL FINE GRADE FOR GRADES AND SWALES AS TS = TOP OF STEPSHOWN AND SHALL OBTAIN 2% MINIMUM DRAINAGE, UNLESS BS = BOTTOM OF STEPOTHERWISE DIRECTED. TW = TOP OF WALLBW = BOTTOM OF WALL 2. CONTRACTOR SHALL MEET EXISTING GRADE AT PROJECT LIMITS IE = INVERT ELEVATION WITH A SMOOTH AND CONTINUOUS TRANSITION. R = RIM3. CONTOURS SHOWN ON FINISH SURFACE INDICATE FINAL GRADE. 2.0% → PROPOSED SLOPE **EXISTING** ¥ PROTECT EXISTING MATCH FLAG POLE AND 4. CONTOUR INTERVAL IS ONE (1) FOOT. FLOW DIRECTION EXISTING /

5. CONTOURS AND SPOT ELEVATIONS REPRESENT THE DESIGN INTENT OF FINISH GRADES AND FINISH SURFACES. SUBGRADES SHALL BE PER DETAIL DRAWINGS. THERE SHALL BE A MINIMUM OF

6" OF TOPSOIL IN ALL LAWN AND LANDSCAPE AREAS.

LIGHTS

N GREENFIELD AVE



5201 E. Terrace Drive Suite 200 Madison, WI 53718 608.443.1200 www.AyresAssociates.com



ICONICA

901 Deming Way // Madison, WI 53717 Ph: 608.664.3500 // Fx: 608.664.3535





Milwaukee: 20855 Watertown Rd, Suite 170 Waukesha, Wisconsin 53186 **T** 262.901.0626

Revision

Project Name

BUCHNER PARK POOL




City of Waukesha 223 Oakland Ave. Waukesha, WI 53186

Drawn By: BM Checked By: P-SG Review Issued For: Issue Date: 03.11.2020 Project No. 52-0684.00

Sheet Title

SITE GRADING PLAN



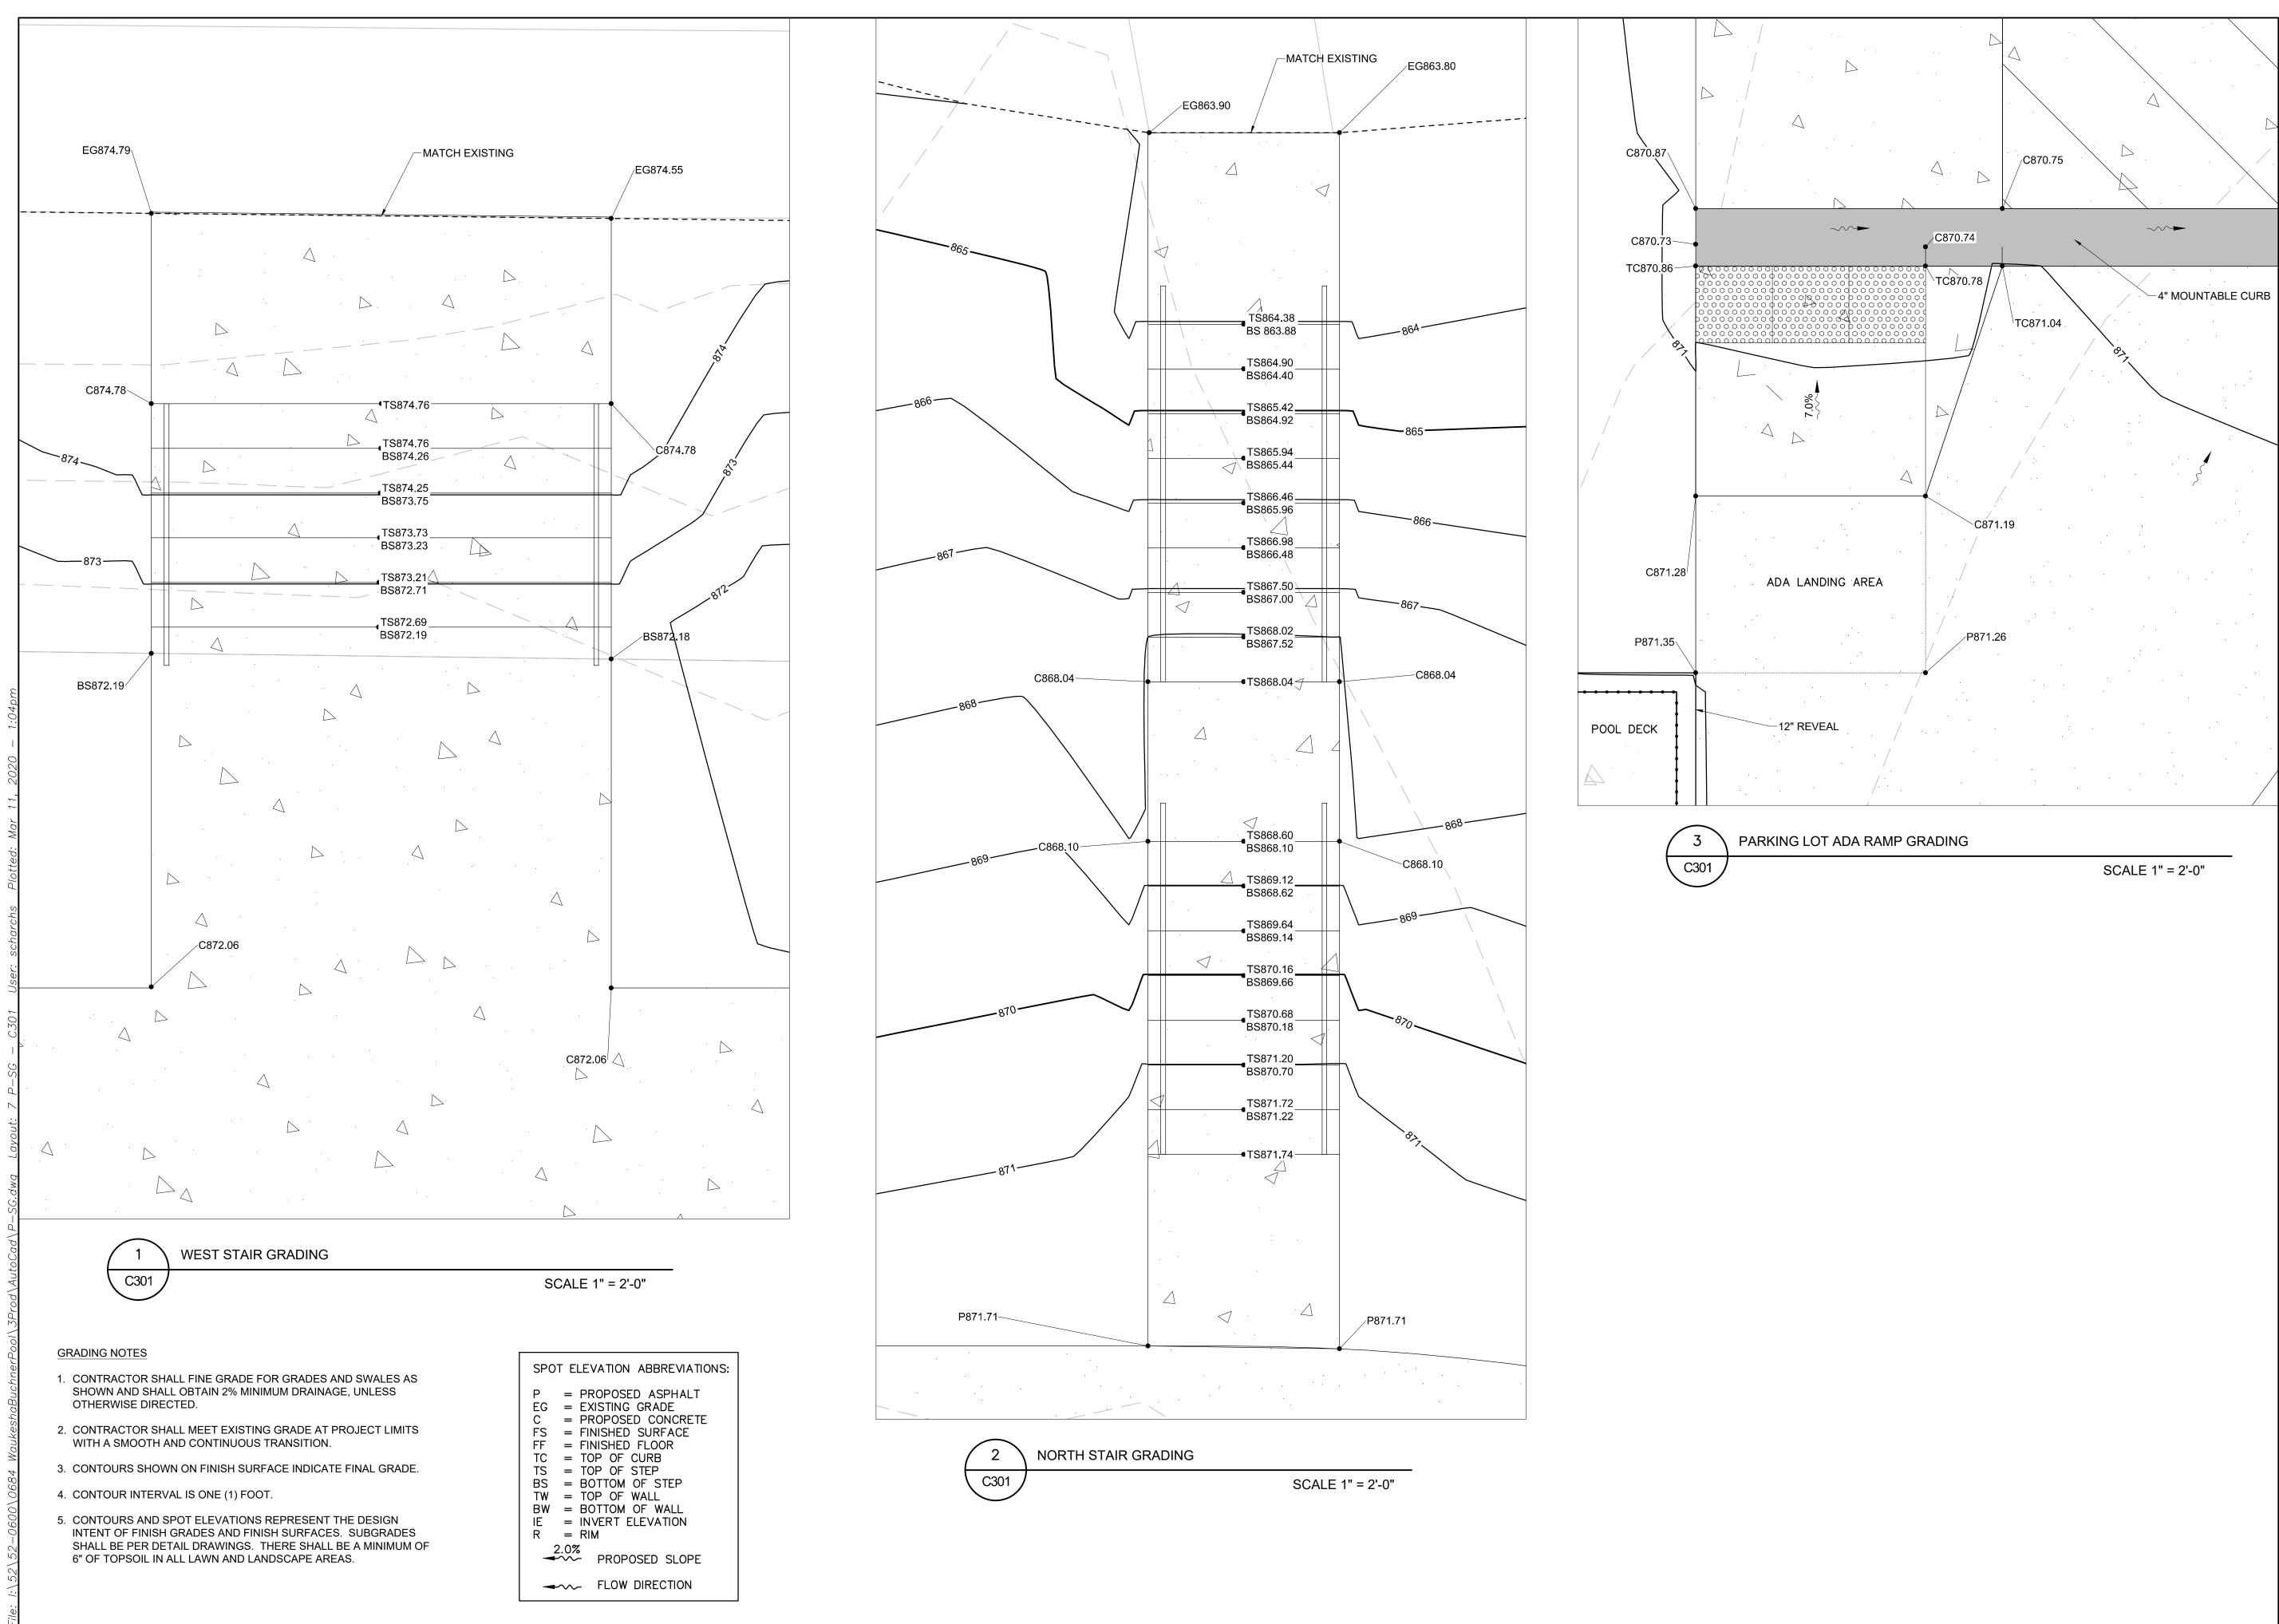

AYRES

5201 E. Terrace Drive Suite 200 Madison, WI 53718 608.443.1200 www.AyresAssociates.com



901 Deming Way // Madison, WI 53717 Ph: 608.664.3500 // Fx: 608.664.3535 iconicacreates.com





Milwaukee: 20855 Watertown Rd, Suite 170 Waukesha, Wisconsin 53186 T 262.901.0626 Website: http://www.henneman.com

Project Name

Revision

BUCHNER PARK POOL



City of Waukesha 223 Oakland Ave. Waukesha, WI 53186

Drawn By: JW
Checked By: BM
File: P-SG
Issued For: Review


Issue Date: 03.11.2020 Project No. 52-0684.00

Sheet Title

DETAILED GRADING PLAN

Sheet Number

C301

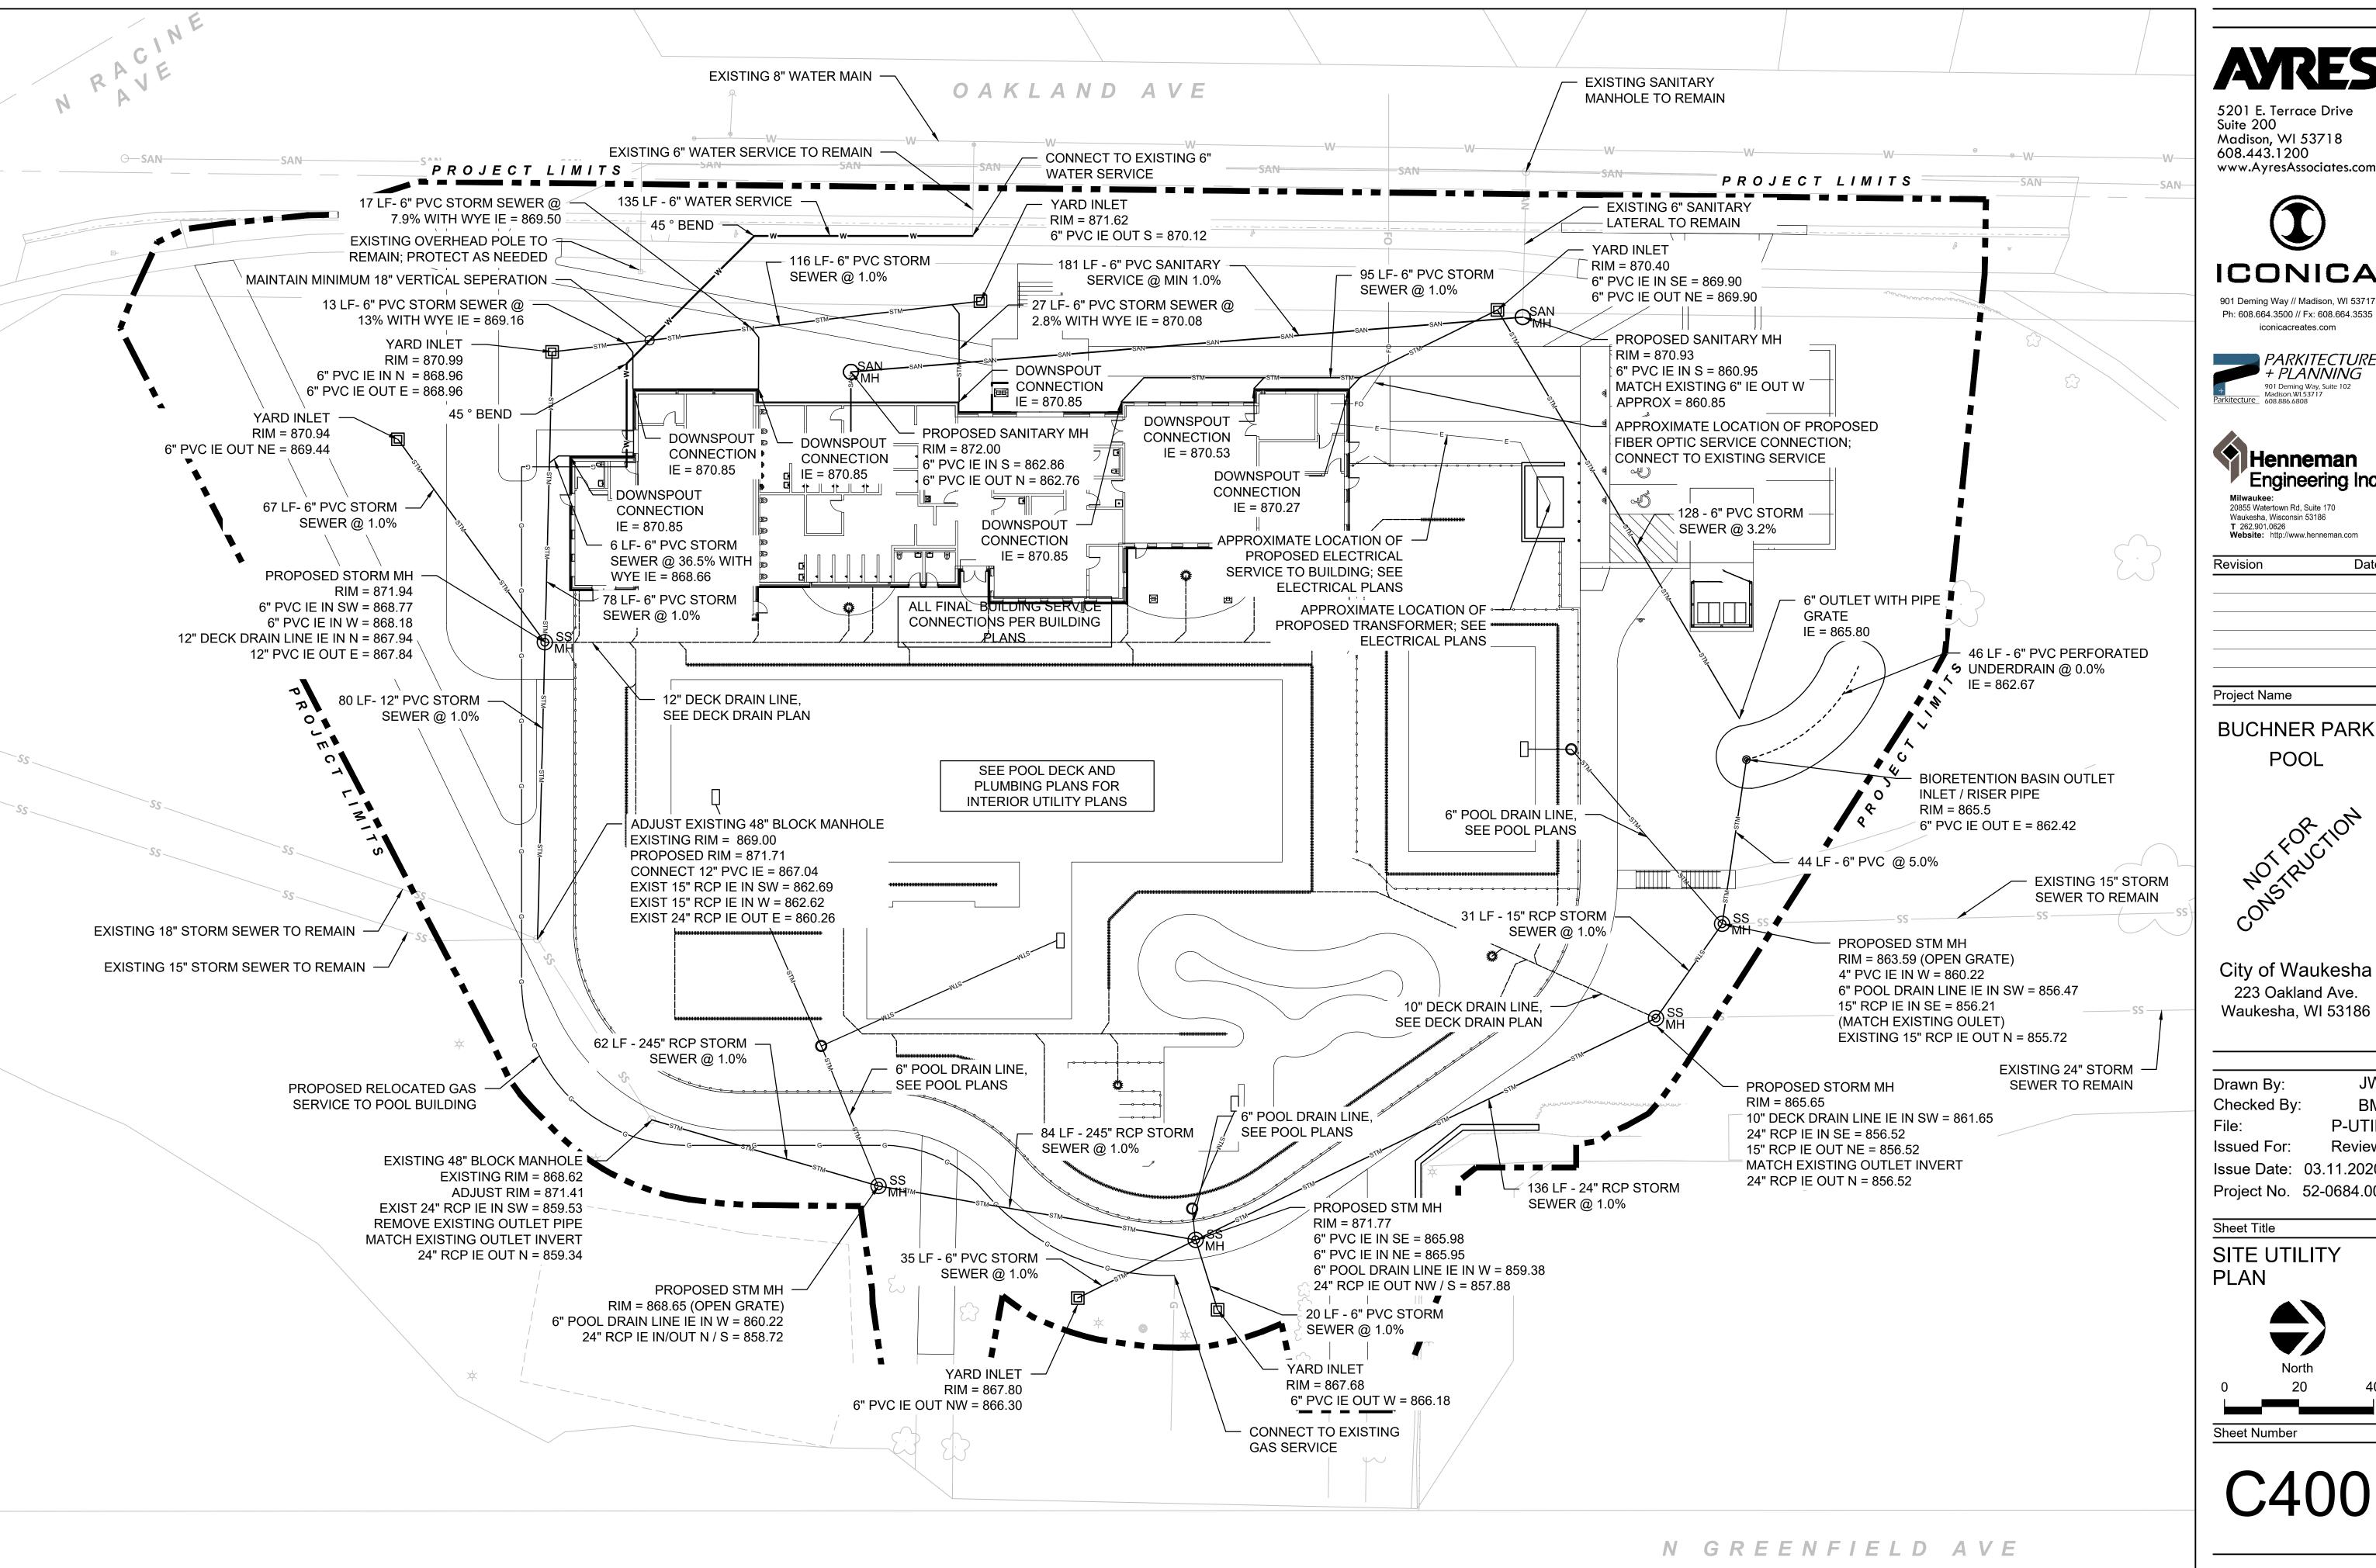



ICONICA

Ph: 608.664.3500 // Fx: 608.664.3535







20855 Watertown Rd, Suite 170 Waukesha, Wisconsin 53186 **T** 262.901.0626 Website: http://www.henneman.com

Revision

Project Name

BUCHNER PARK POOL




City of Waukesha 223 Oakland Ave. Waukesha, WI 53186

Drawn By: Checked By: BMP-UTIL Issued For: Review Issue Date: 03.11.2020 Project No. 52-0684.00

Sheet Title

SITE UTILITY PLAN




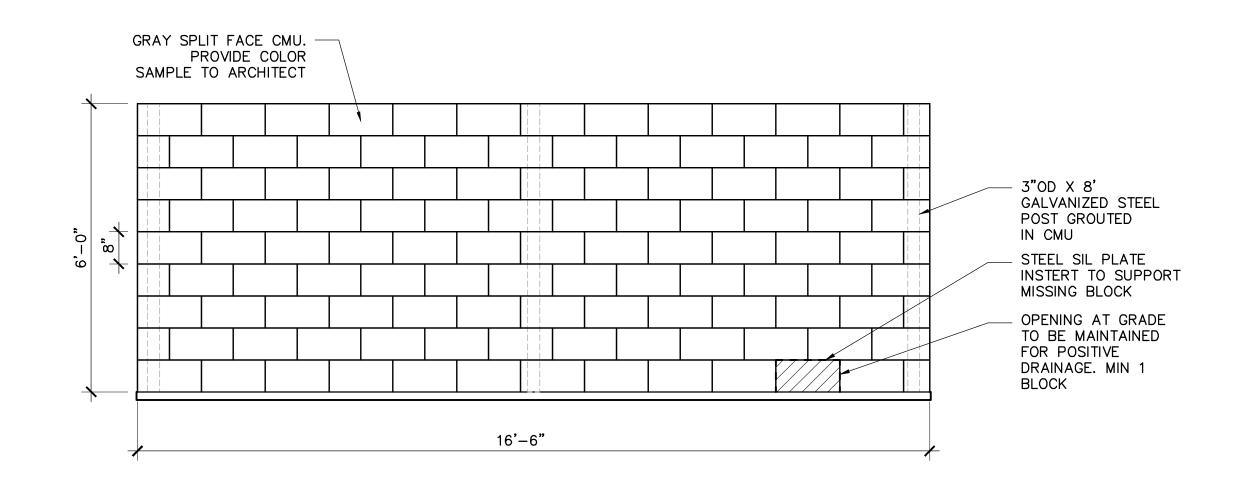

DUMPSTER ENCLOSURE WALL (EAST)


C700


SCALE 1" = 2'-0"

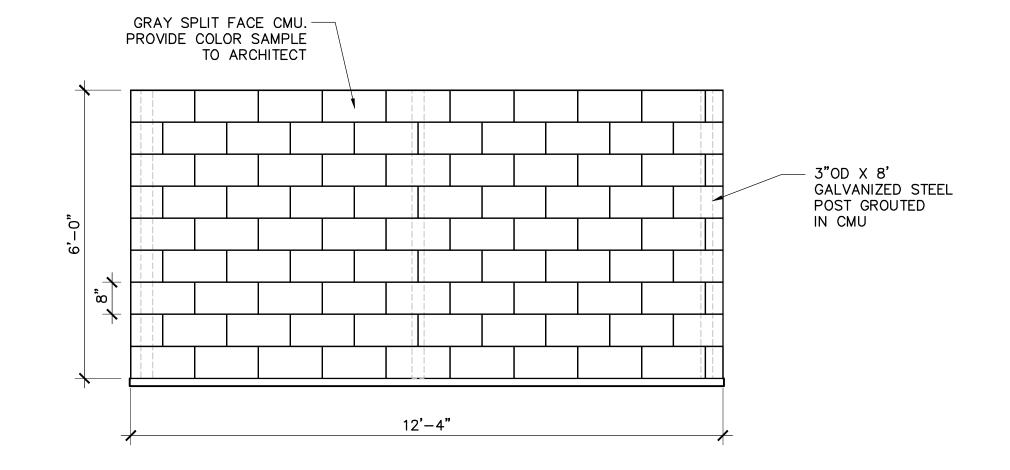

DUMPSTER ENCLOSURE WALL (NORTH) C700

SCALE 1" = 2'-0"

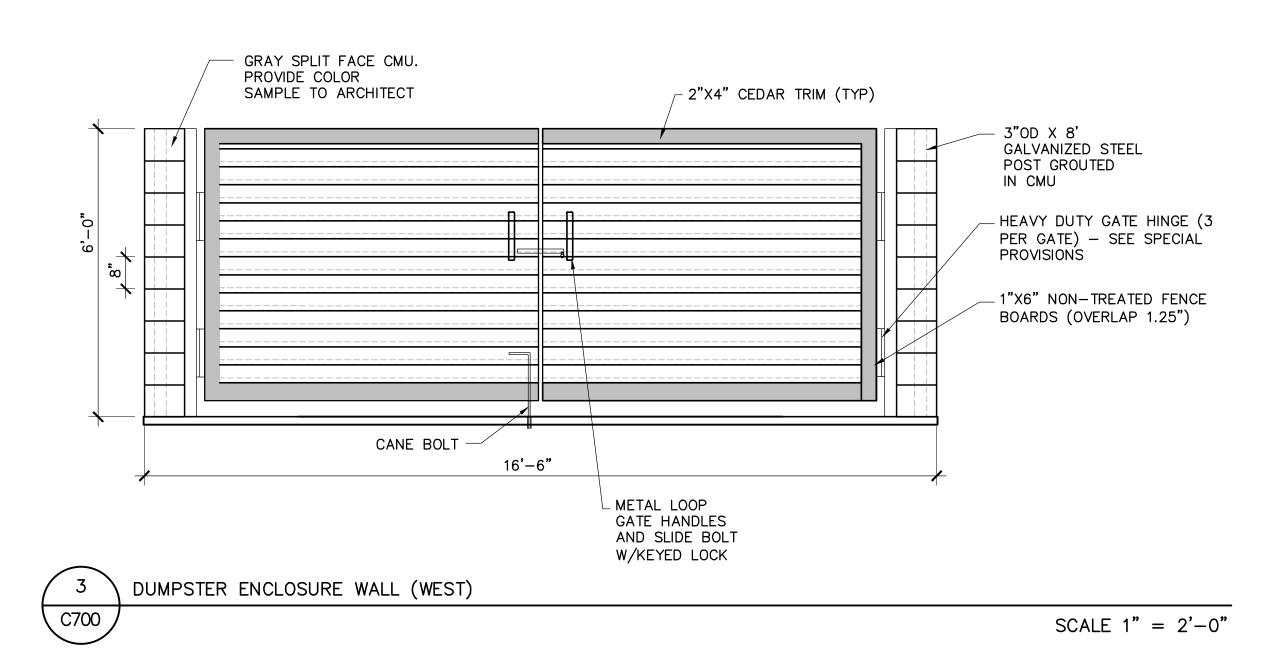

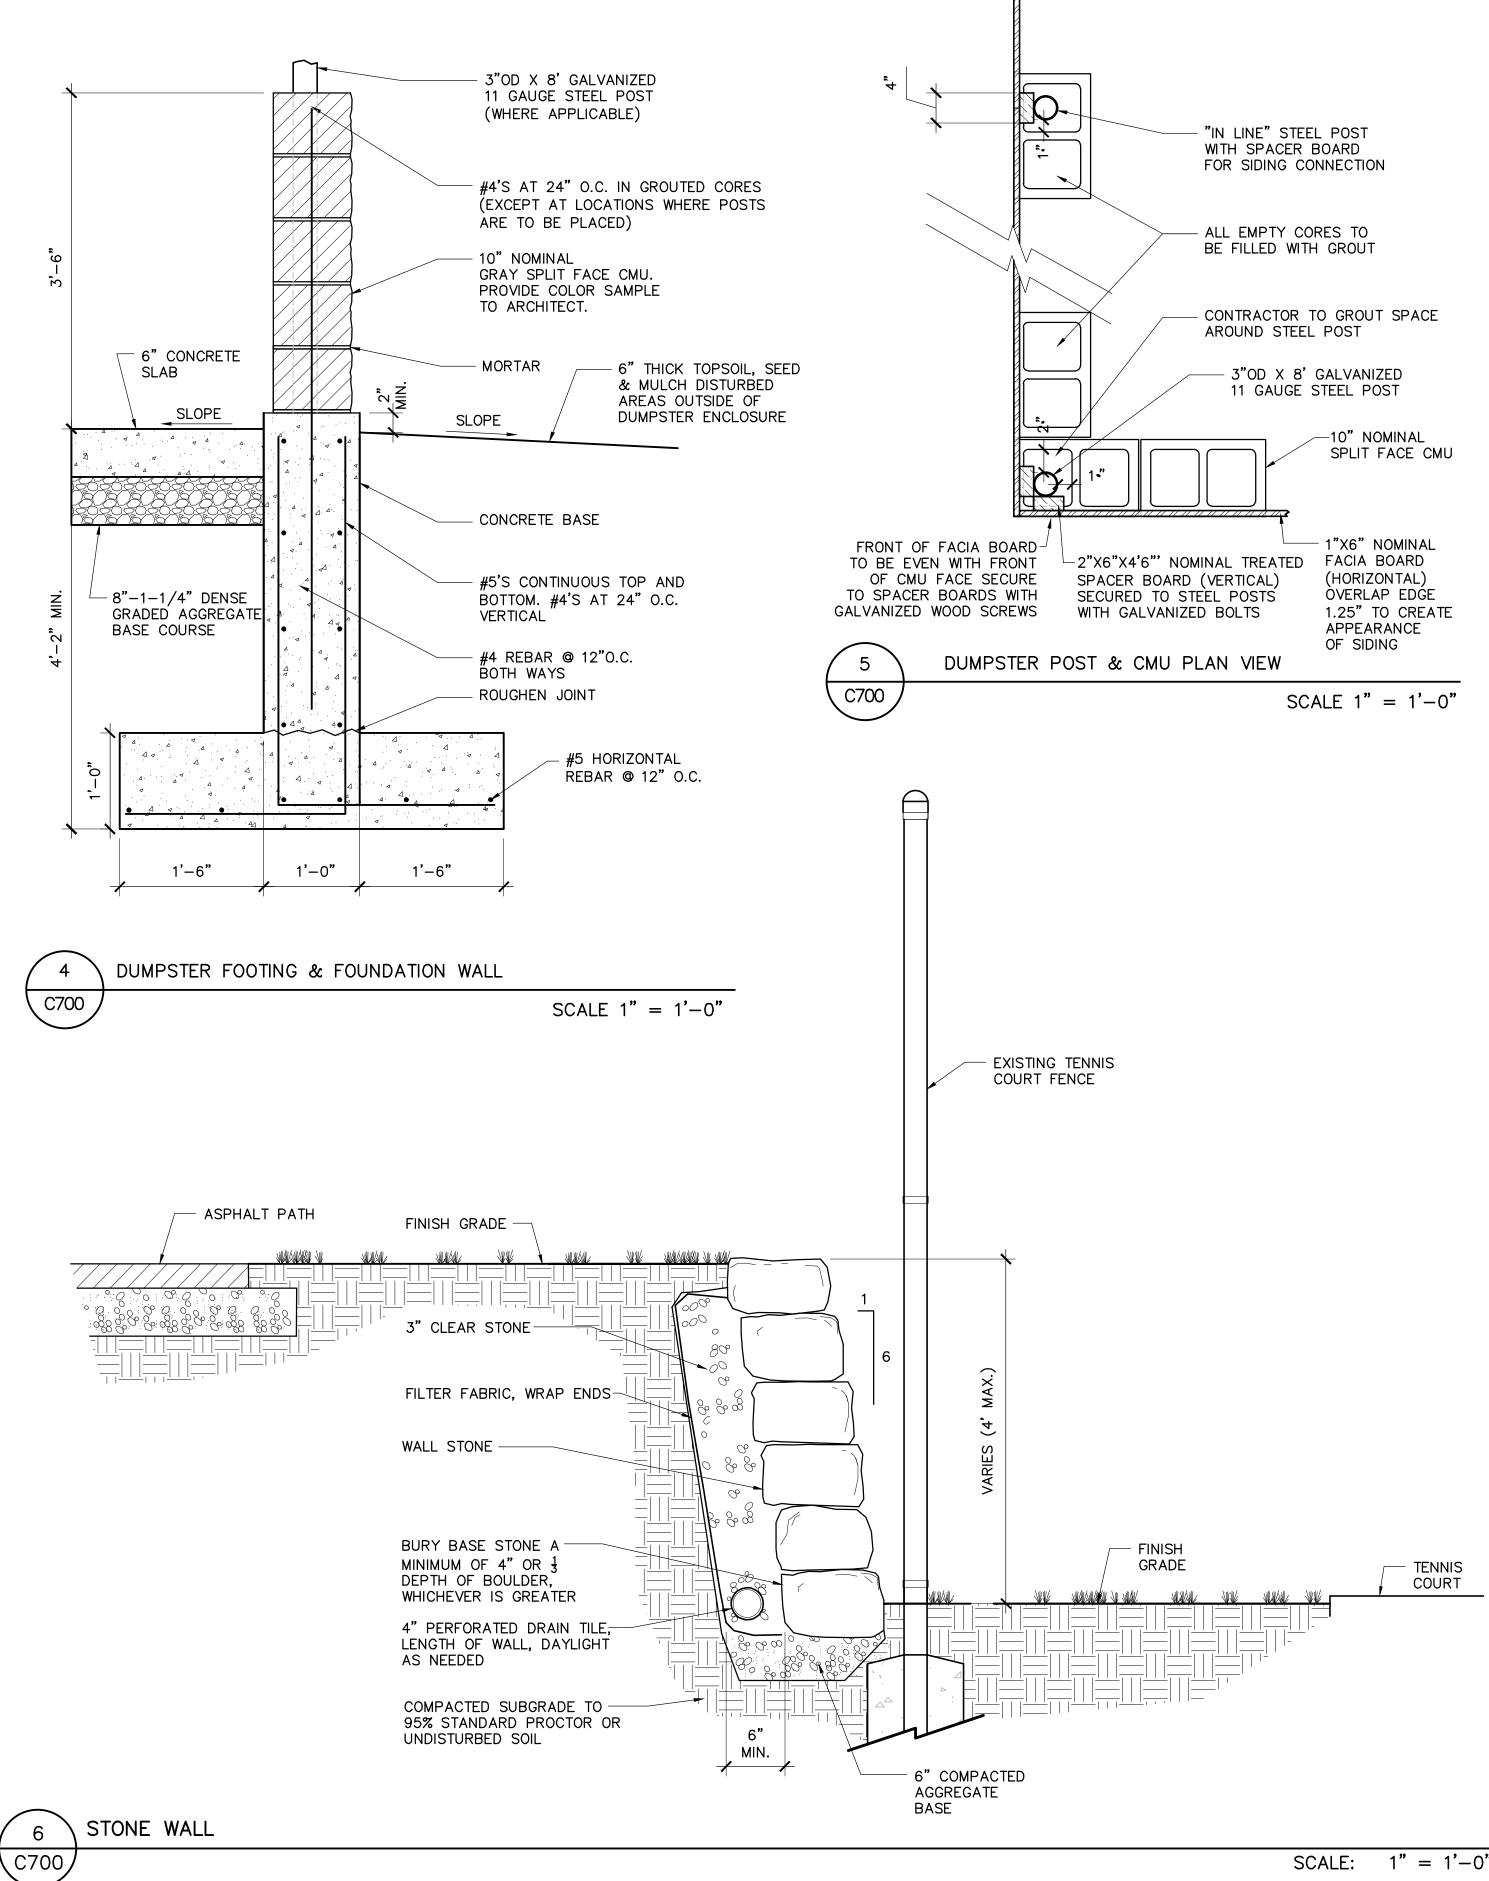

Suite 200 Madison, WI 53718 608.443.1200 www.AyresAssociates.com

5201 E. Terrace Drive



ICONICA

901 Deming Way // Madison, WI 53717

Ph: 608.664.3500 // Fx: 608.664.3535 iconicacreates.com





20855 Watertown Rd, Suite 170 Waukesha, Wisconsin 53186 **T** 262.901.0626 Website: http://www.henneman.com

Revision	Date

Project Name

BUCHNER PARK POOL




City of Waukesha 223 Oakland Ave. Waukesha, WI 53186

Drawn By:
Checked By


Issued For: Review Issue Date: 03.11.2020 Project No. 52-0684.00

Sheet Title

DETAILS

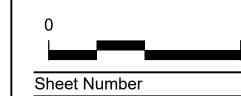



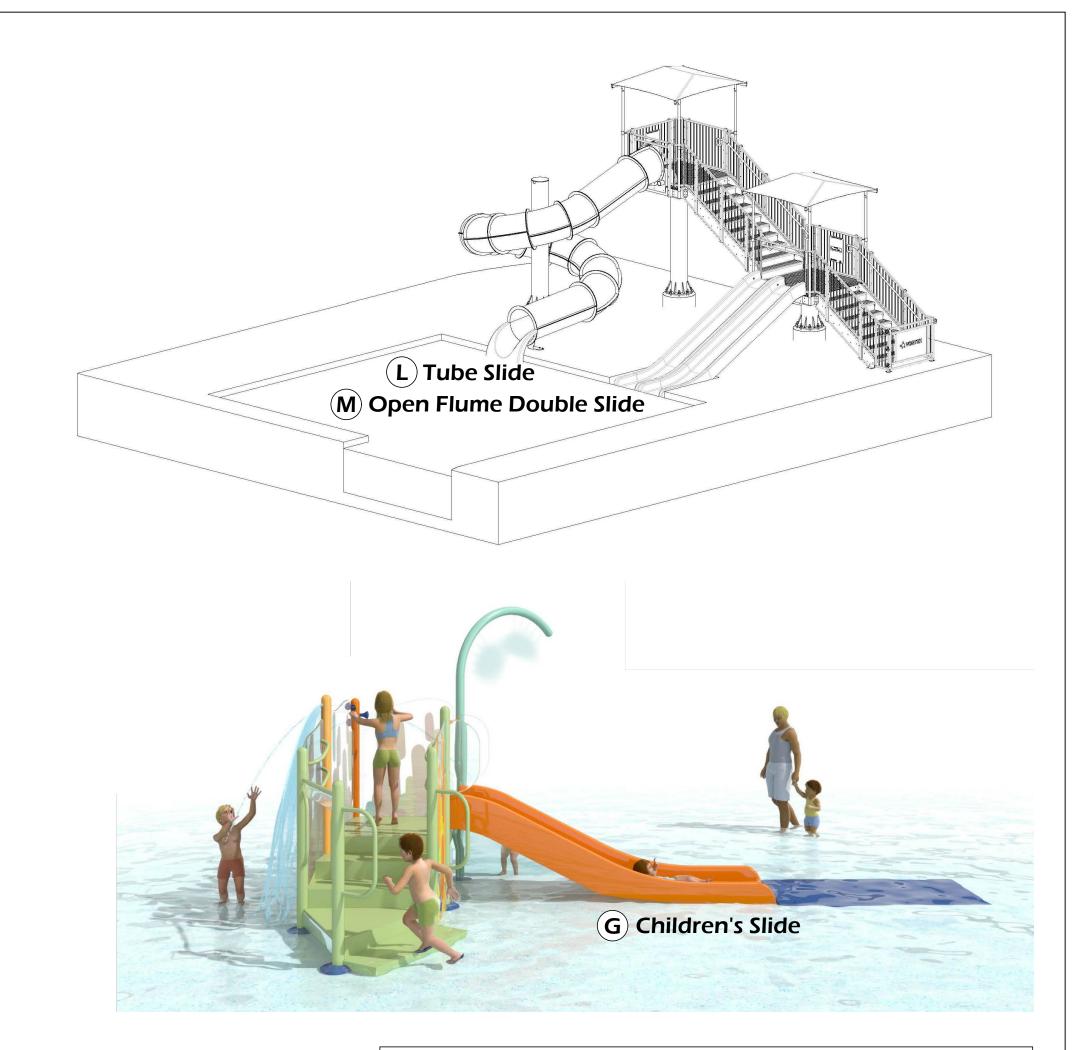

LEGEND

- A 50-Meter 7-Lane Lap Pool
- **B** ADA Ramp Entry
- (C) Bench
- (D) Wide Stairs
- **(E)** Wading Pool
- **F** Zero Depth Entry
- **G** Children's Slide
- (H) Basketball Hoop
- (I) Volleyball Net
- **J** Starting Block
- (K) Diving Board
- L Tube Slide
- (M) Open Flume Double Slide
- (N) Current Channel
- **O** Lifeguard Chair
- (P) Deck Chair
- **Q** Concessions Area
- (R) Exterior Shower
- S Light Pole

SITE STATISTICS			
Total Fenced Area	39,640 Square Feet		
Total Water Surface Area	14,213 Square Feet		
Total Concrete Deck Area	25,150 Square Feet		
Maximum Patron Load	895 Patrons		
Minimum Number of Lifeguards	5		
Number Lifeguards at Capacity	12		
Number Deck Chairs Shown	306		

POOL VESS	SEL STATISTICS			
LAI	PPOOL			
Water Surface Area	9,890 Square Feet			
Maximum Patron Load	606 Patrons			
Minimum Number of Lifeguards	2 (<60 Patrons i.e. during lessons)			
Number Lifeguards at Capacity	8			
Pool Depth Range	2'-6" - 12'-0"			
WADI	NG POOL			
Water Surface Area	1,870 Square Feet			
Maximum Patron Load	125 Patrons			
Minimum Number of Lifeguards	Lifeguards Not Required			
Pool Depth Range	0'-0" - 2'-0"			
CURRENT CHANNEL	& SLIDE PLUNGE POOL			
Water Surface Area	2,453 Square Feet			
Maximum Patron Load	164 Patrons			
Minimum Number of Lifeguards	3 (1 @ CC Entrance; 1 @ Slide Entrance)			
Number Lifeguards at Capacity	4 (1 @ Upper Slide Entrance)			
Pool Depth Range	3'-6"			

AYRES

5201 E. Terrace Drive Suite 200 Madison, WI 53718 608.443.1200 www.AyresAssociates.com



901 Deming Way // Madison, WI 53717 Ph: 608.664.3500 // Fx: 608.664.3535



iconicacreates.com



Milwaukee:
20855 Watertown Rd, Suite 170
Waukesha, Wisconsin 53186
T 262.901.0626
Website: http://www.henneman.com

Revision	Date

Project Name

BUCHNER PARK
COMMUNITY
POOL
& BUILDING

NOT FOR CONSTRUCTION

City of Waukesha 223 Oakland Ave. Waukesha, WI 53186


Drawn By: Checked By:


File:
Issued For: Review
Issue Date: 02.28.2020


Project No. 52-0684.00

Sheet Title

POOL DECK PLAN

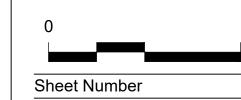

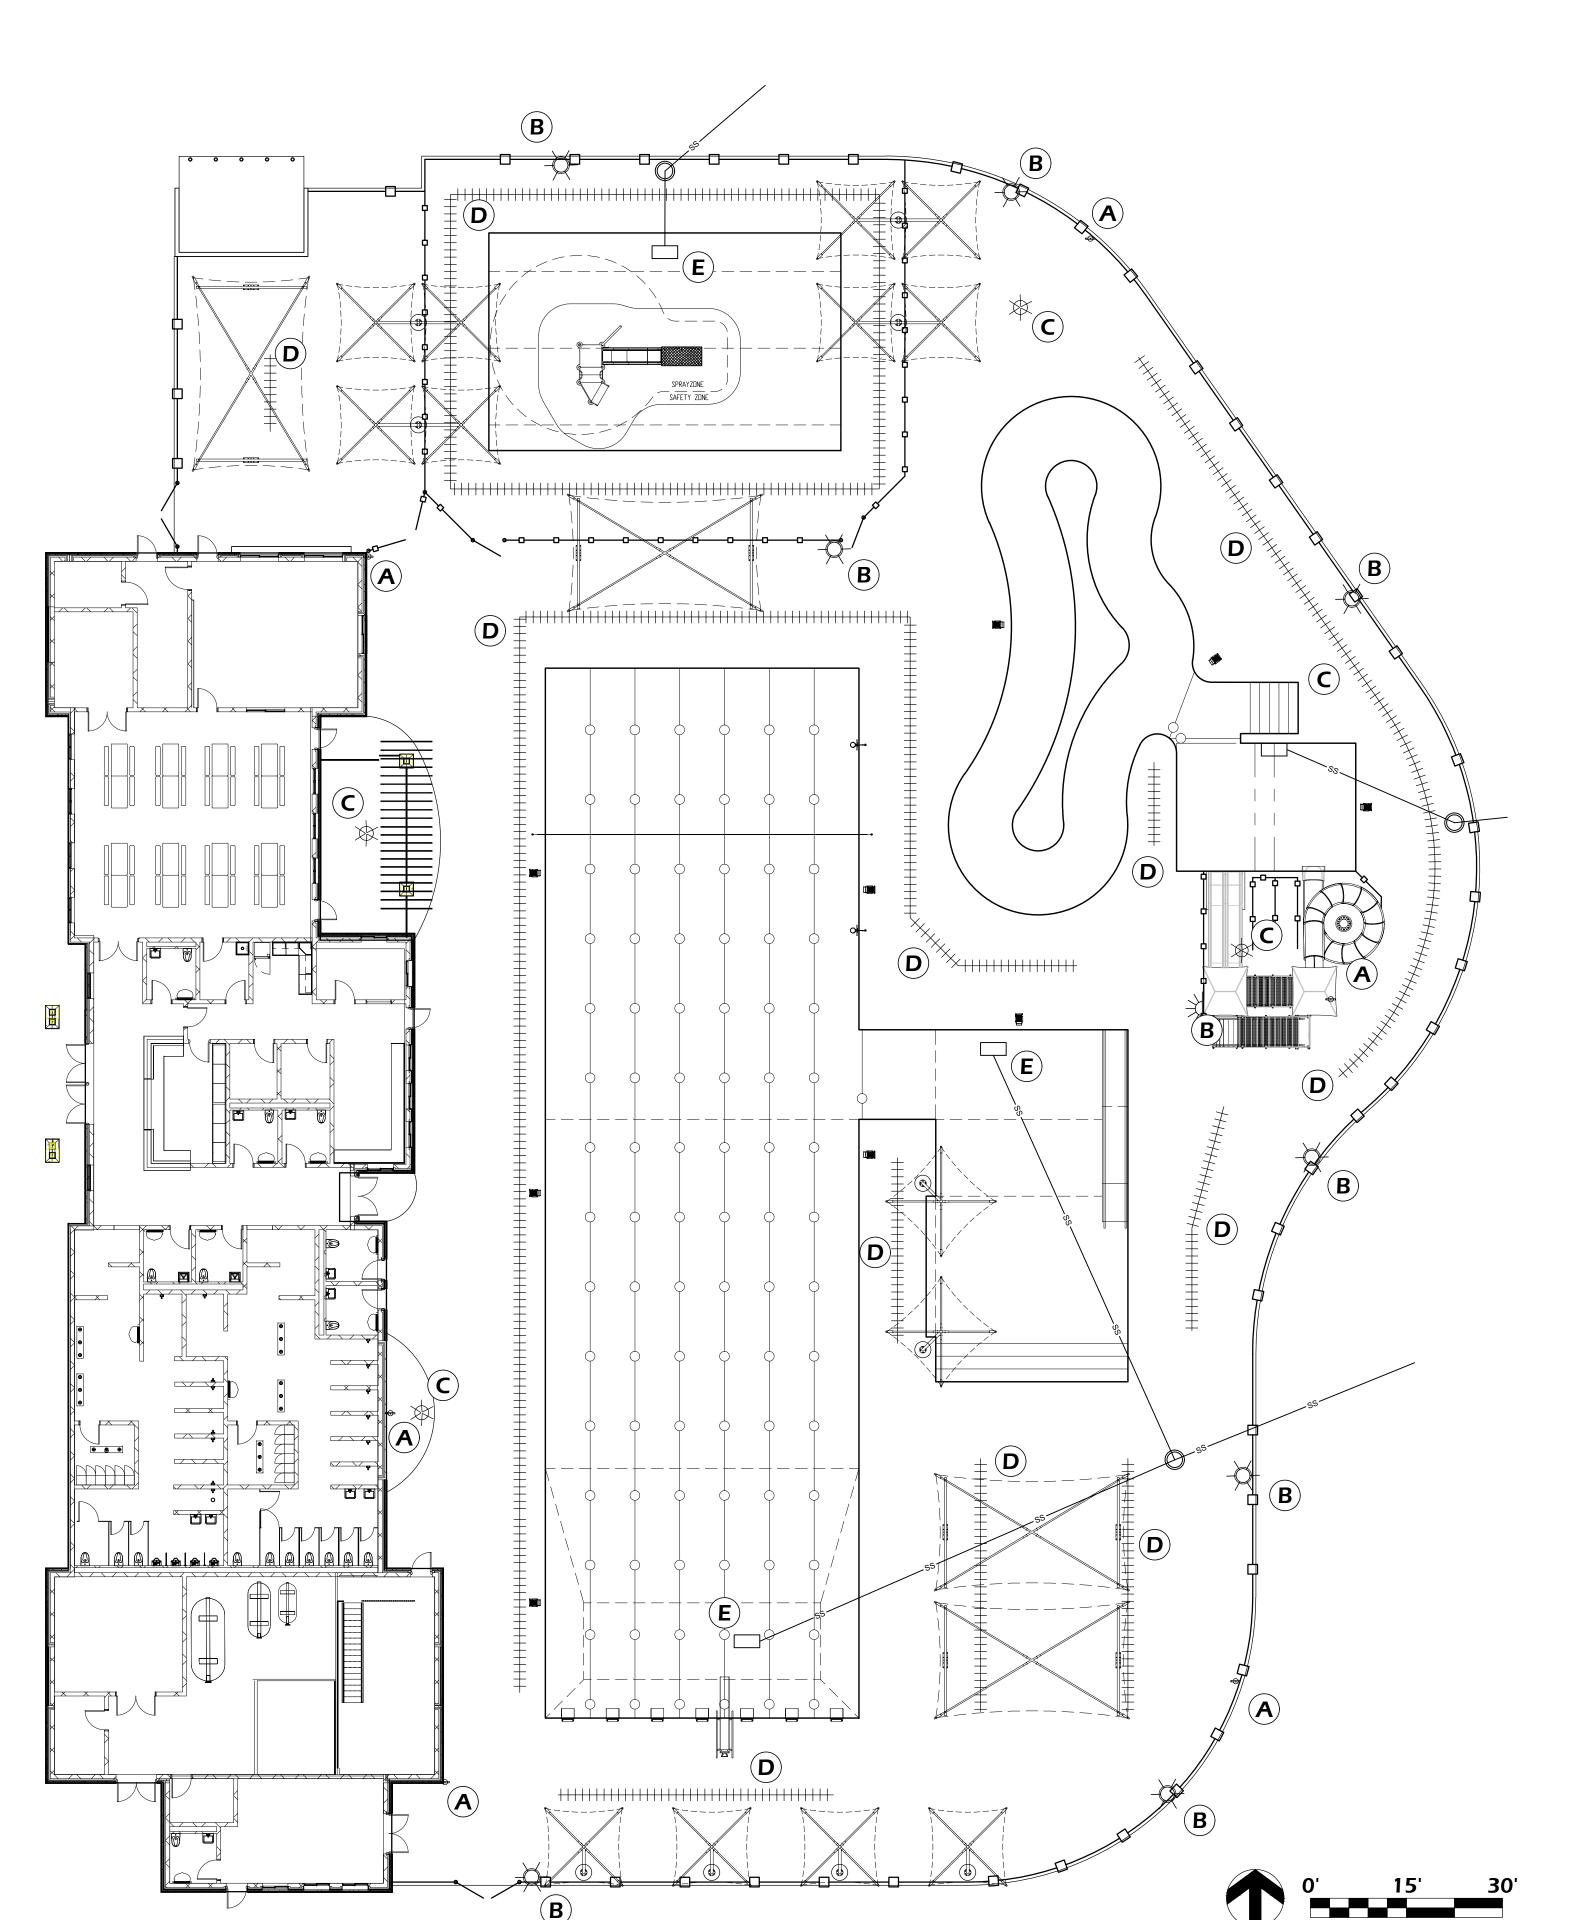


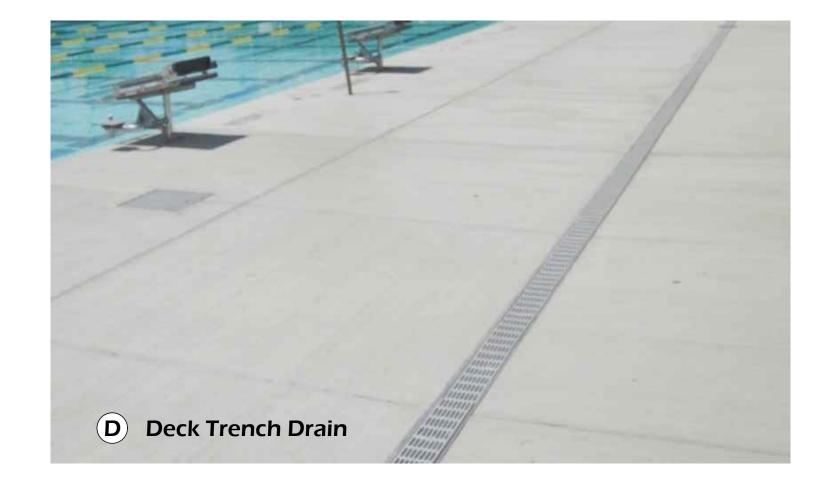



LEGEND

- **A** Water Hydrant
- **B** Light Pole
- (C) Deck Drain
- (D) Deck Trench Drain
- **(E)** Pool Winterization Drain

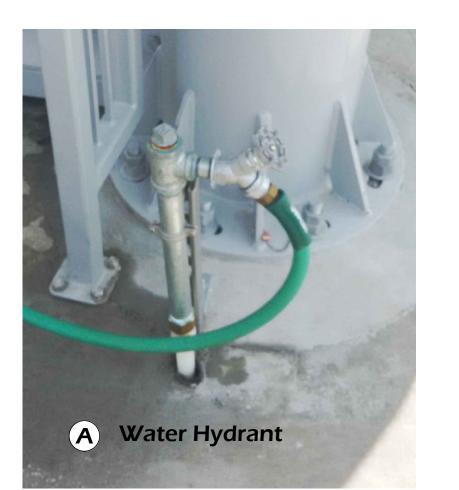



5201 E. Terrace Drive Suite 200 Madison, WI 53718 608.443.1200 www.AyresAssociates.com



901 Deming Way // Madison, WI 53717 Ph: 608.664.3500 // Fx: 608.664.3535

iconicacreates.com





Milwaukee:
20855 Watertown Rd, Suite 170
Waukesha, Wisconsin 53186
T 262.901.0626
Website: http://www.henneman.com

Revision Date

Project Name

BUCHNER PARK
COMMUNITY
POOL
& BUILDING

NOT FOR CONSTRUCTION

City of Waukesha 223 Oakland Ave. Waukesha, WI 53186

Drawn By: Checked By:


Issued For: Review Issue Date: 02.28.2020

Project No. 52-0684.00

Sheet Title

POOL DECK UTILITY LOCATION PLAN



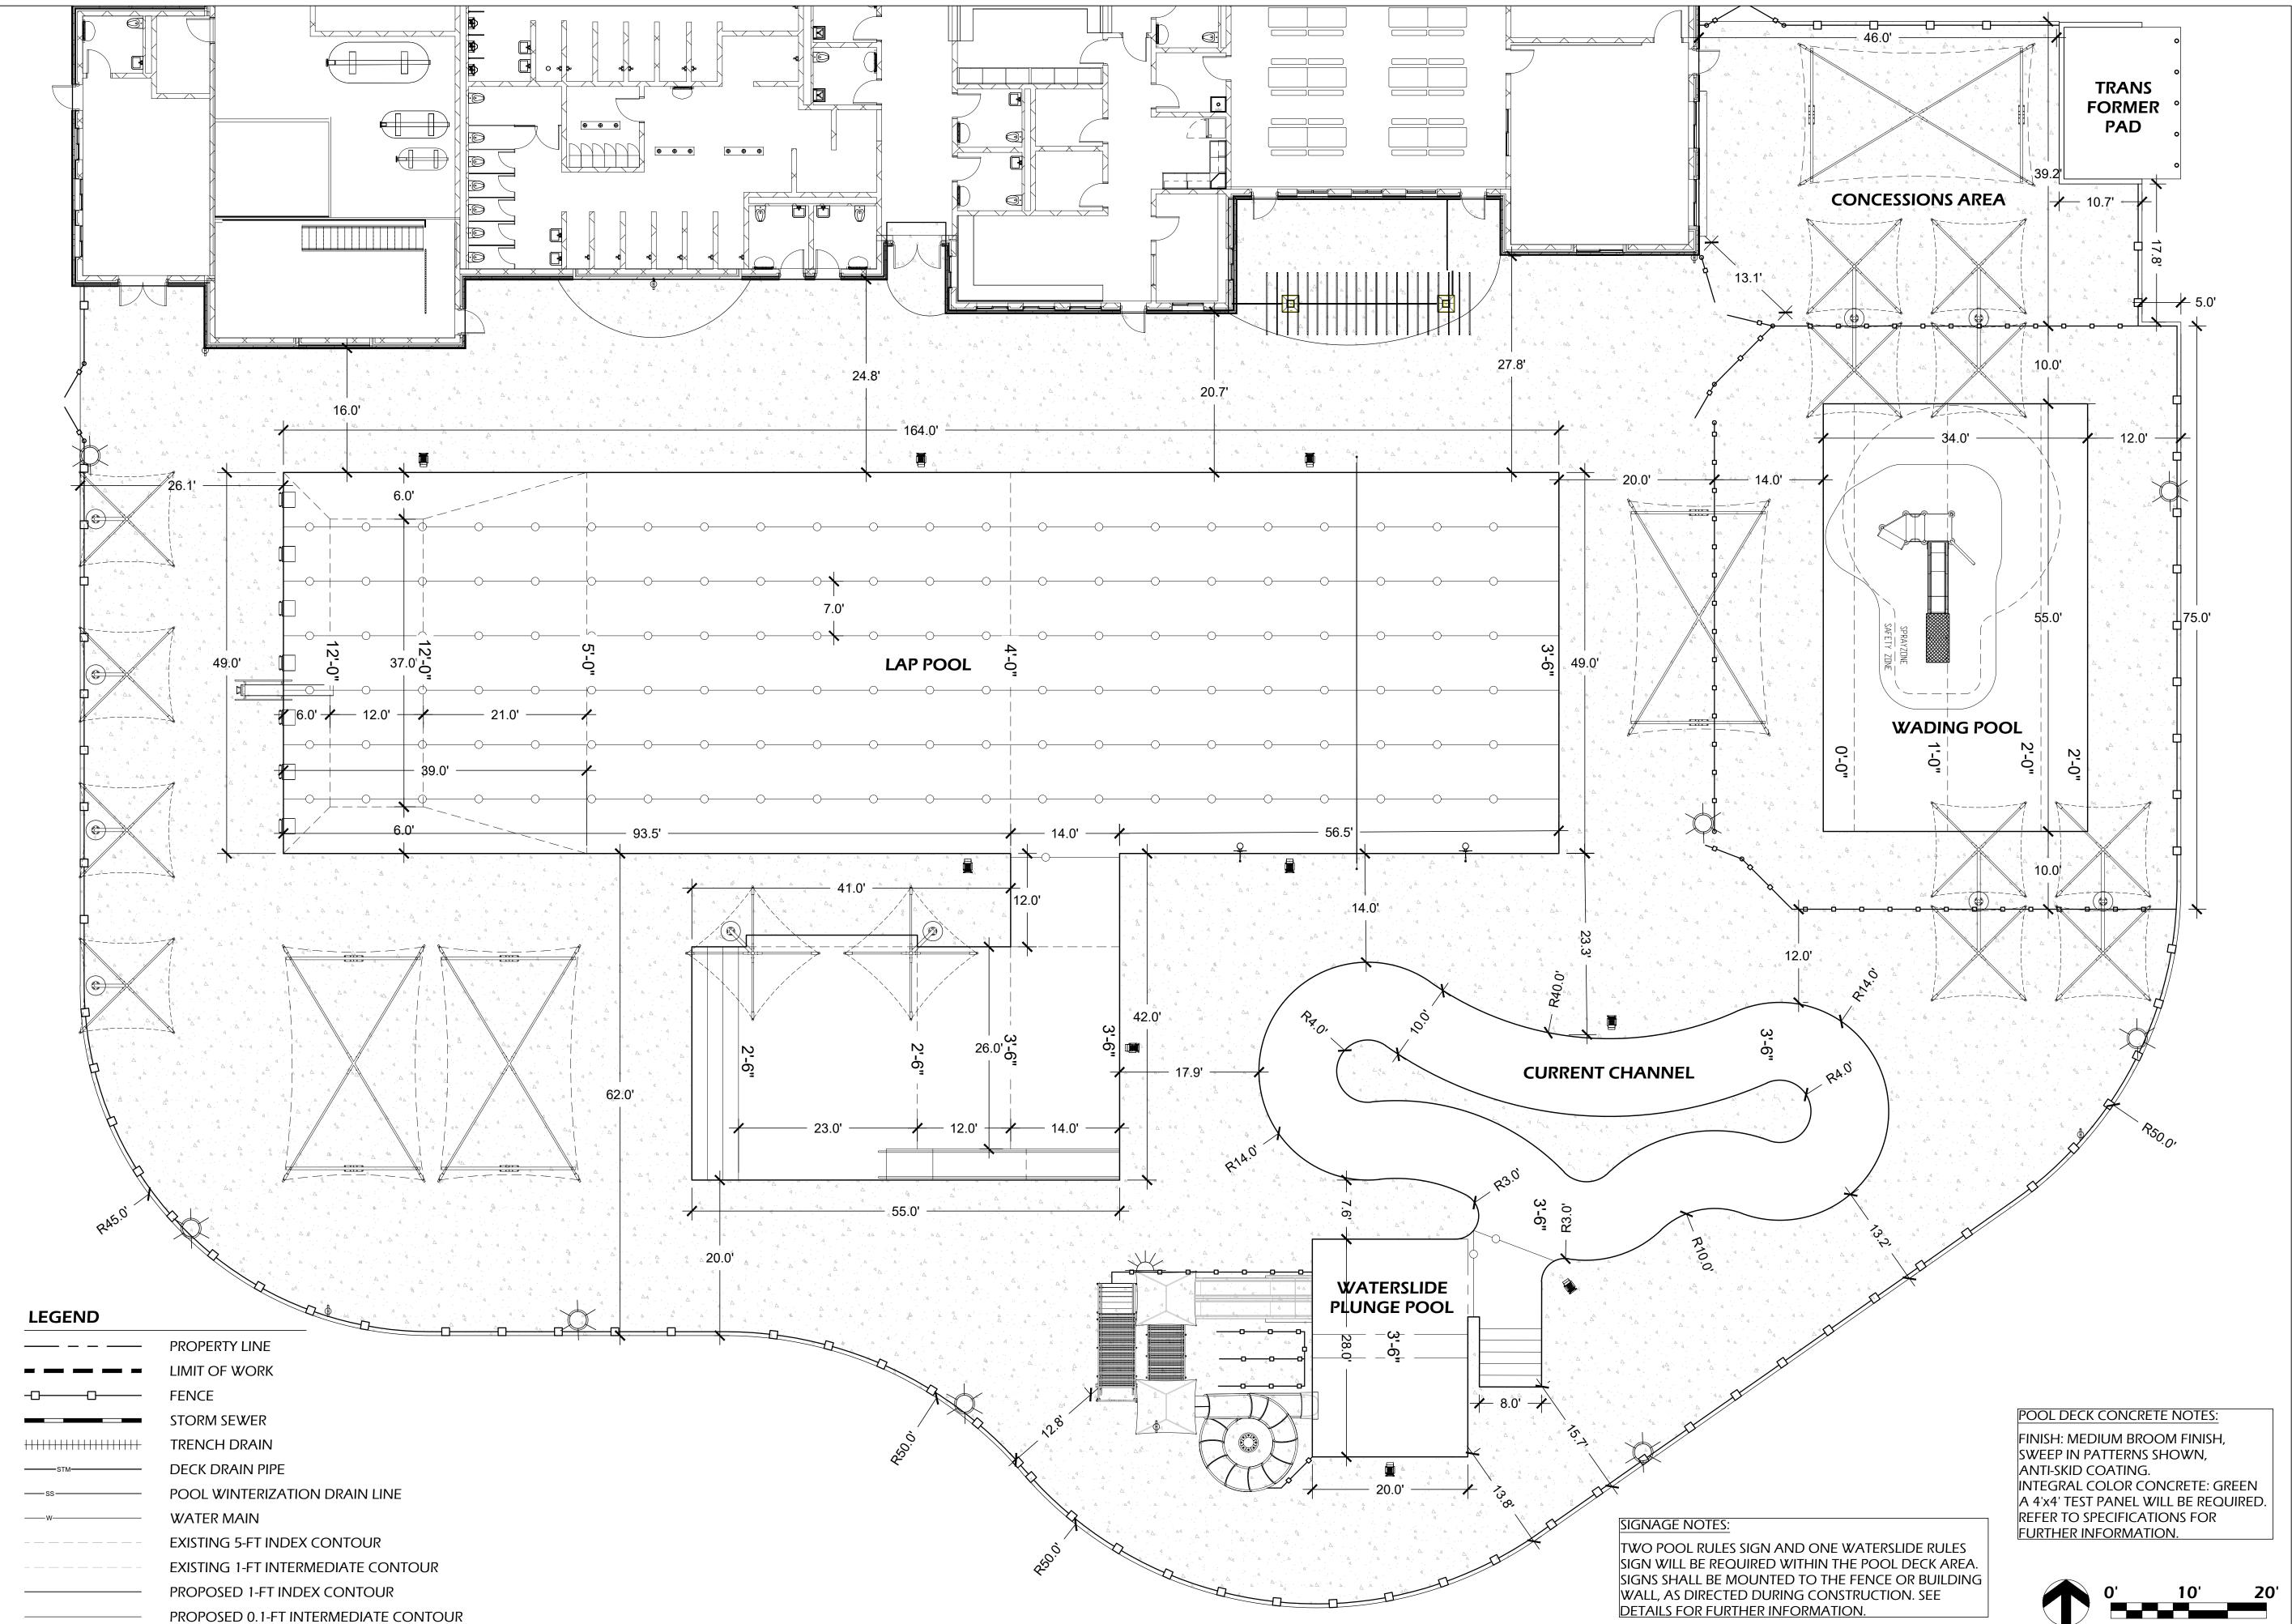



901 Deming Way // Madison, WI 53717 Ph: 608.664.3500 // Fx: 608.664.3535

iconicacreates.com





Milwaukee: 20855 Watertown Rd, Suite 170 Waukesha, Wisconsin 53186 T 262.901.0626
Website: http://www.henneman.com

Revision

Project Name

BUCHNER PARK COMMUNITY

& BUILDING

POOL

NOT FOR CONSTRUCTION

City of Waukesha 223 Oakland Ave. Waukesha, WI 53186

Drawn By: Checked By:

File:


Issued For: Issue Date: 02.28.2020

Project No. 52-0684.00

Sheet Title

POOL DECK LAYOUT PLAN

Sheet Number

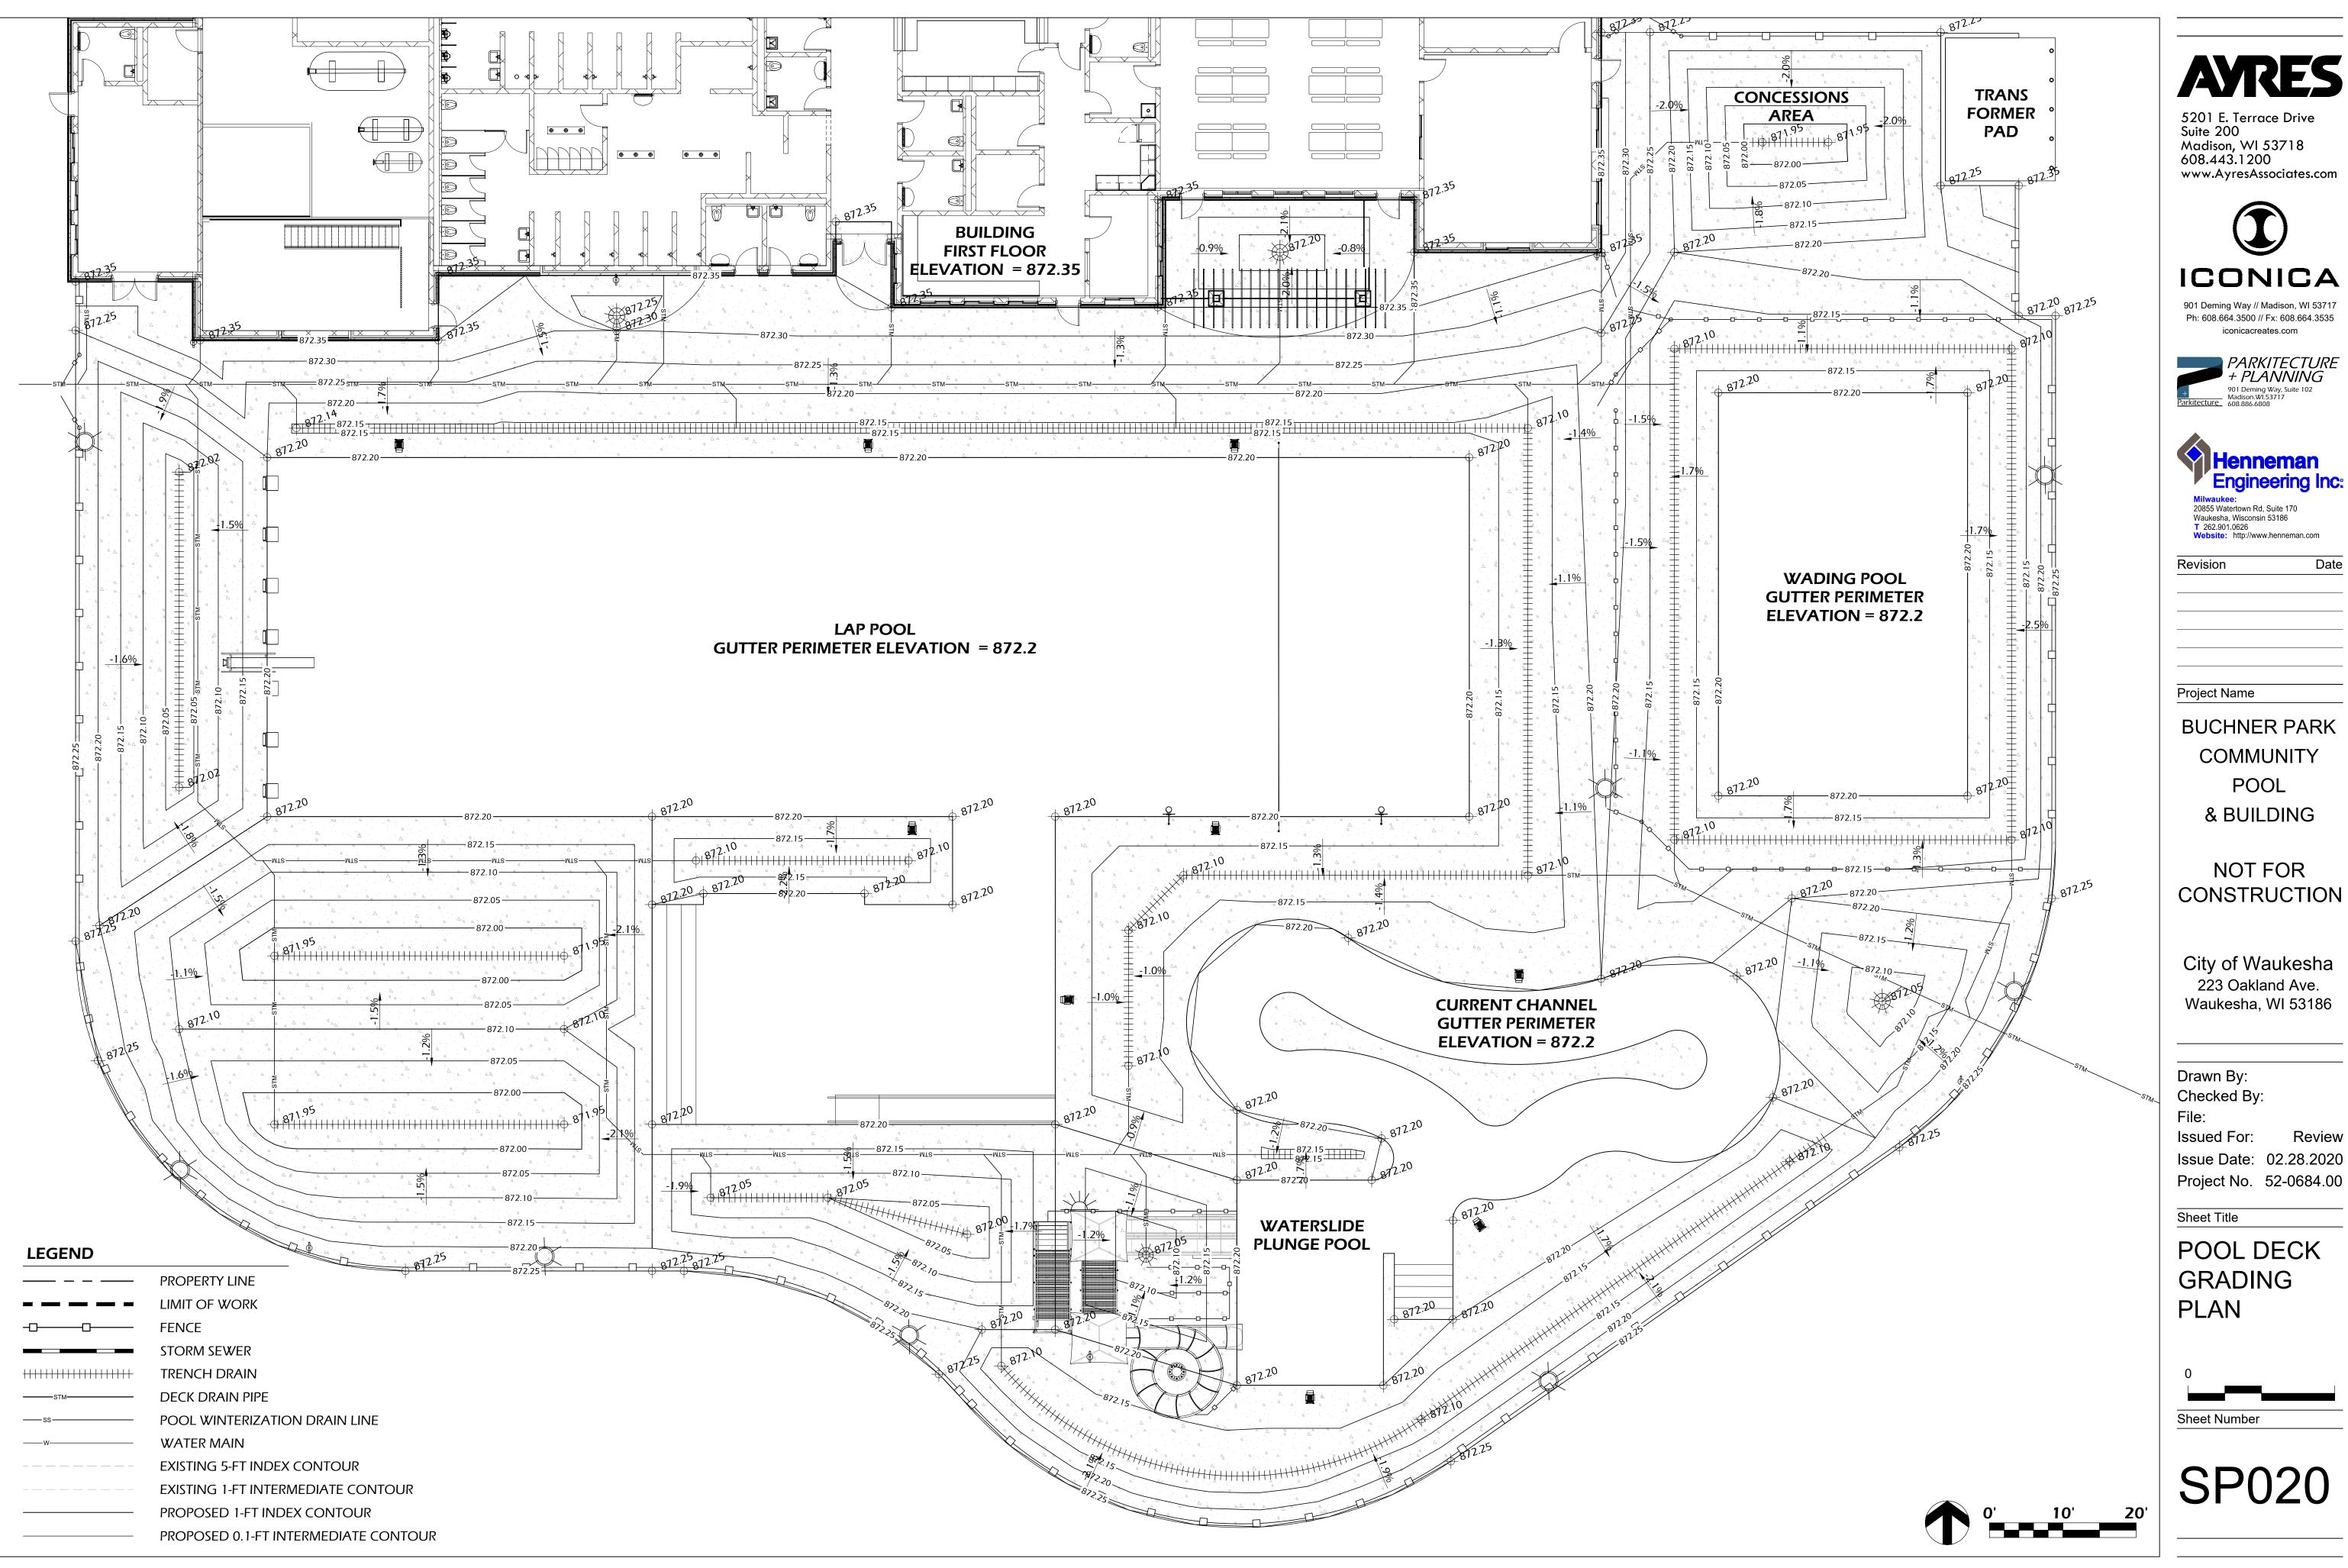

AYRES

5201 E. Terrace Drive Suite 200 Madison, WI 53718 608.443.1200 www.AyresAssociates.com



901 Deming Way // Madison, WI 53717 Ph: 608.664.3500 // Fx: 608.664.3535

iconicacreates.com





Milwaukee: 20855 Watertown Rd, Suite 170 Waukesha, Wisconsin 53186 T 262.901.0626
Website: http://www.henneman.com

Revision

Project Name

BUCHNER PARK COMMUNITY POOL

NOT FOR CONSTRUCTION

& BUILDING

City of Waukesha 223 Oakland Ave. Waukesha, WI 53186


Drawn By: Checked By:

Issued For: Review Issue Date: 02.28.2020

Sheet Title

POOL DECK GRADING PLAN

Sheet Number

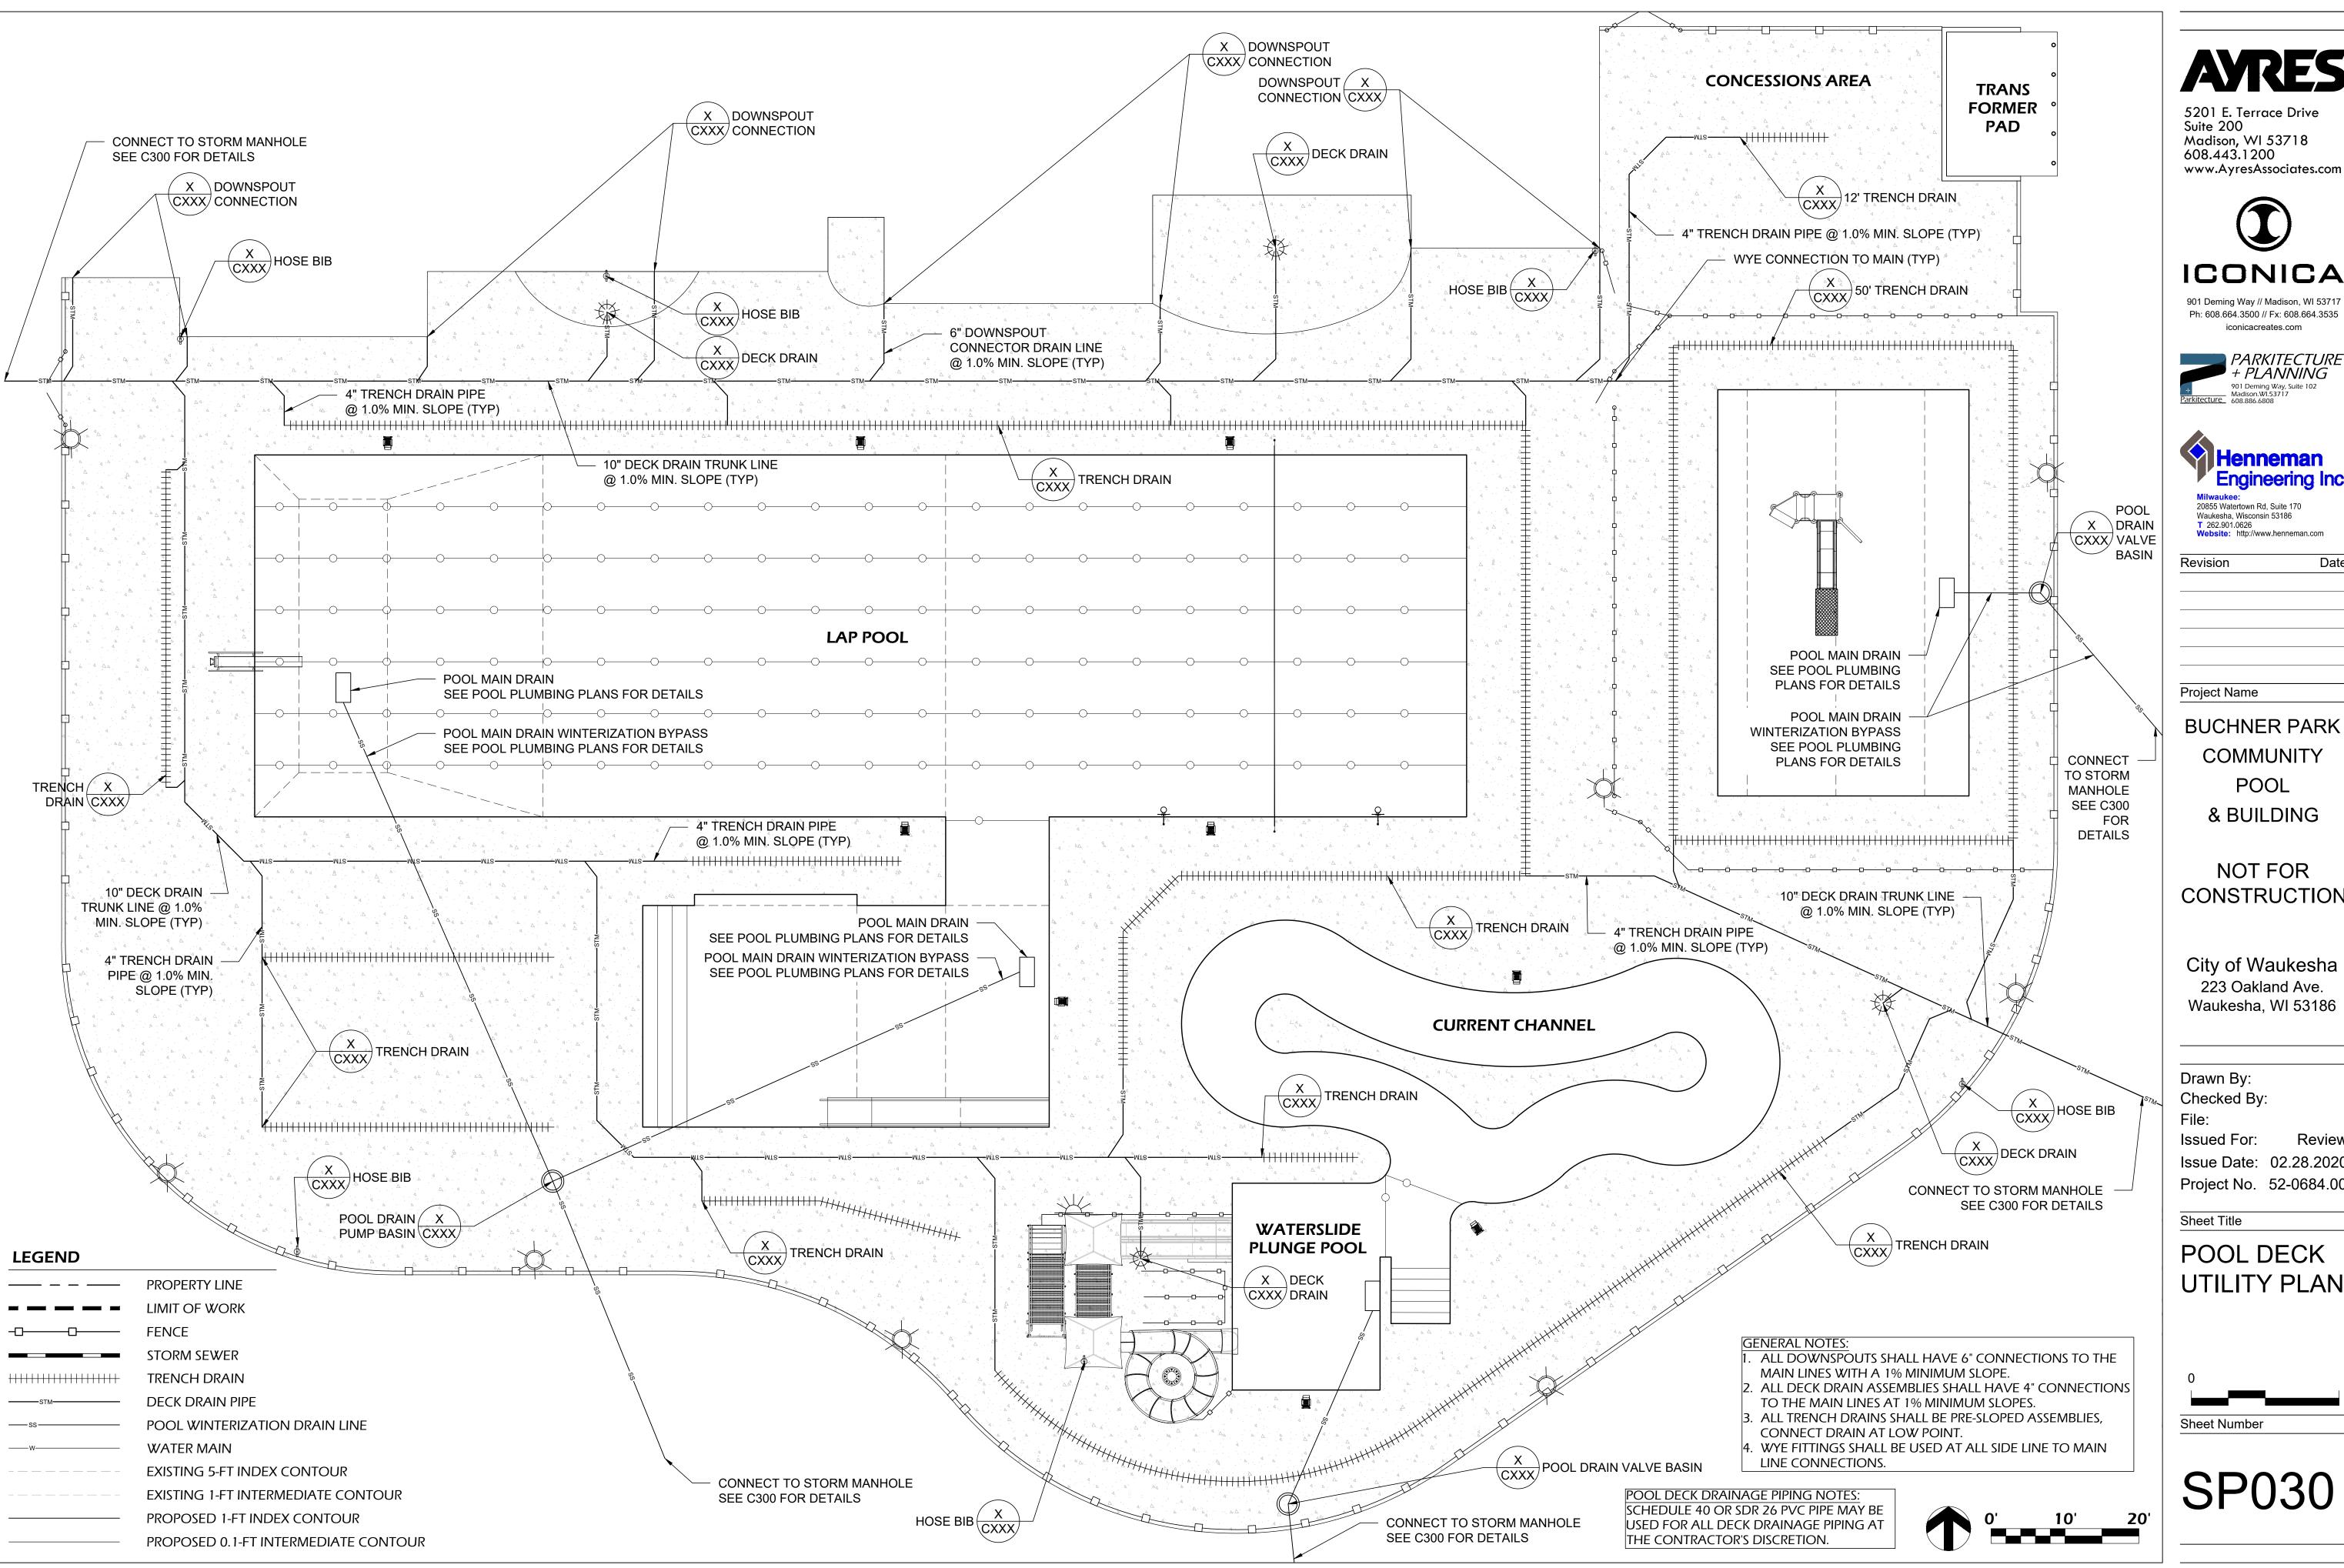



ICONICA



iconicacreates.com



Engineering Inc: Milwaukee: 20855 Watertown Rd, Suite 170 Waukesha, Wisconsin 53186

T 262.901.0626

Date Revision

Project Name

COMMUNITY

POOL & BUILDING

NOT FOR

CONSTRUCTION

City of Waukesha 223 Oakland Ave. Waukesha, WI 53186

Drawn By: Checked By:


Issued For: Review Issue Date: 02.28.2020

Project No. 52-0684.00

Sheet Title

POOL DECK **UTILITY PLAN**



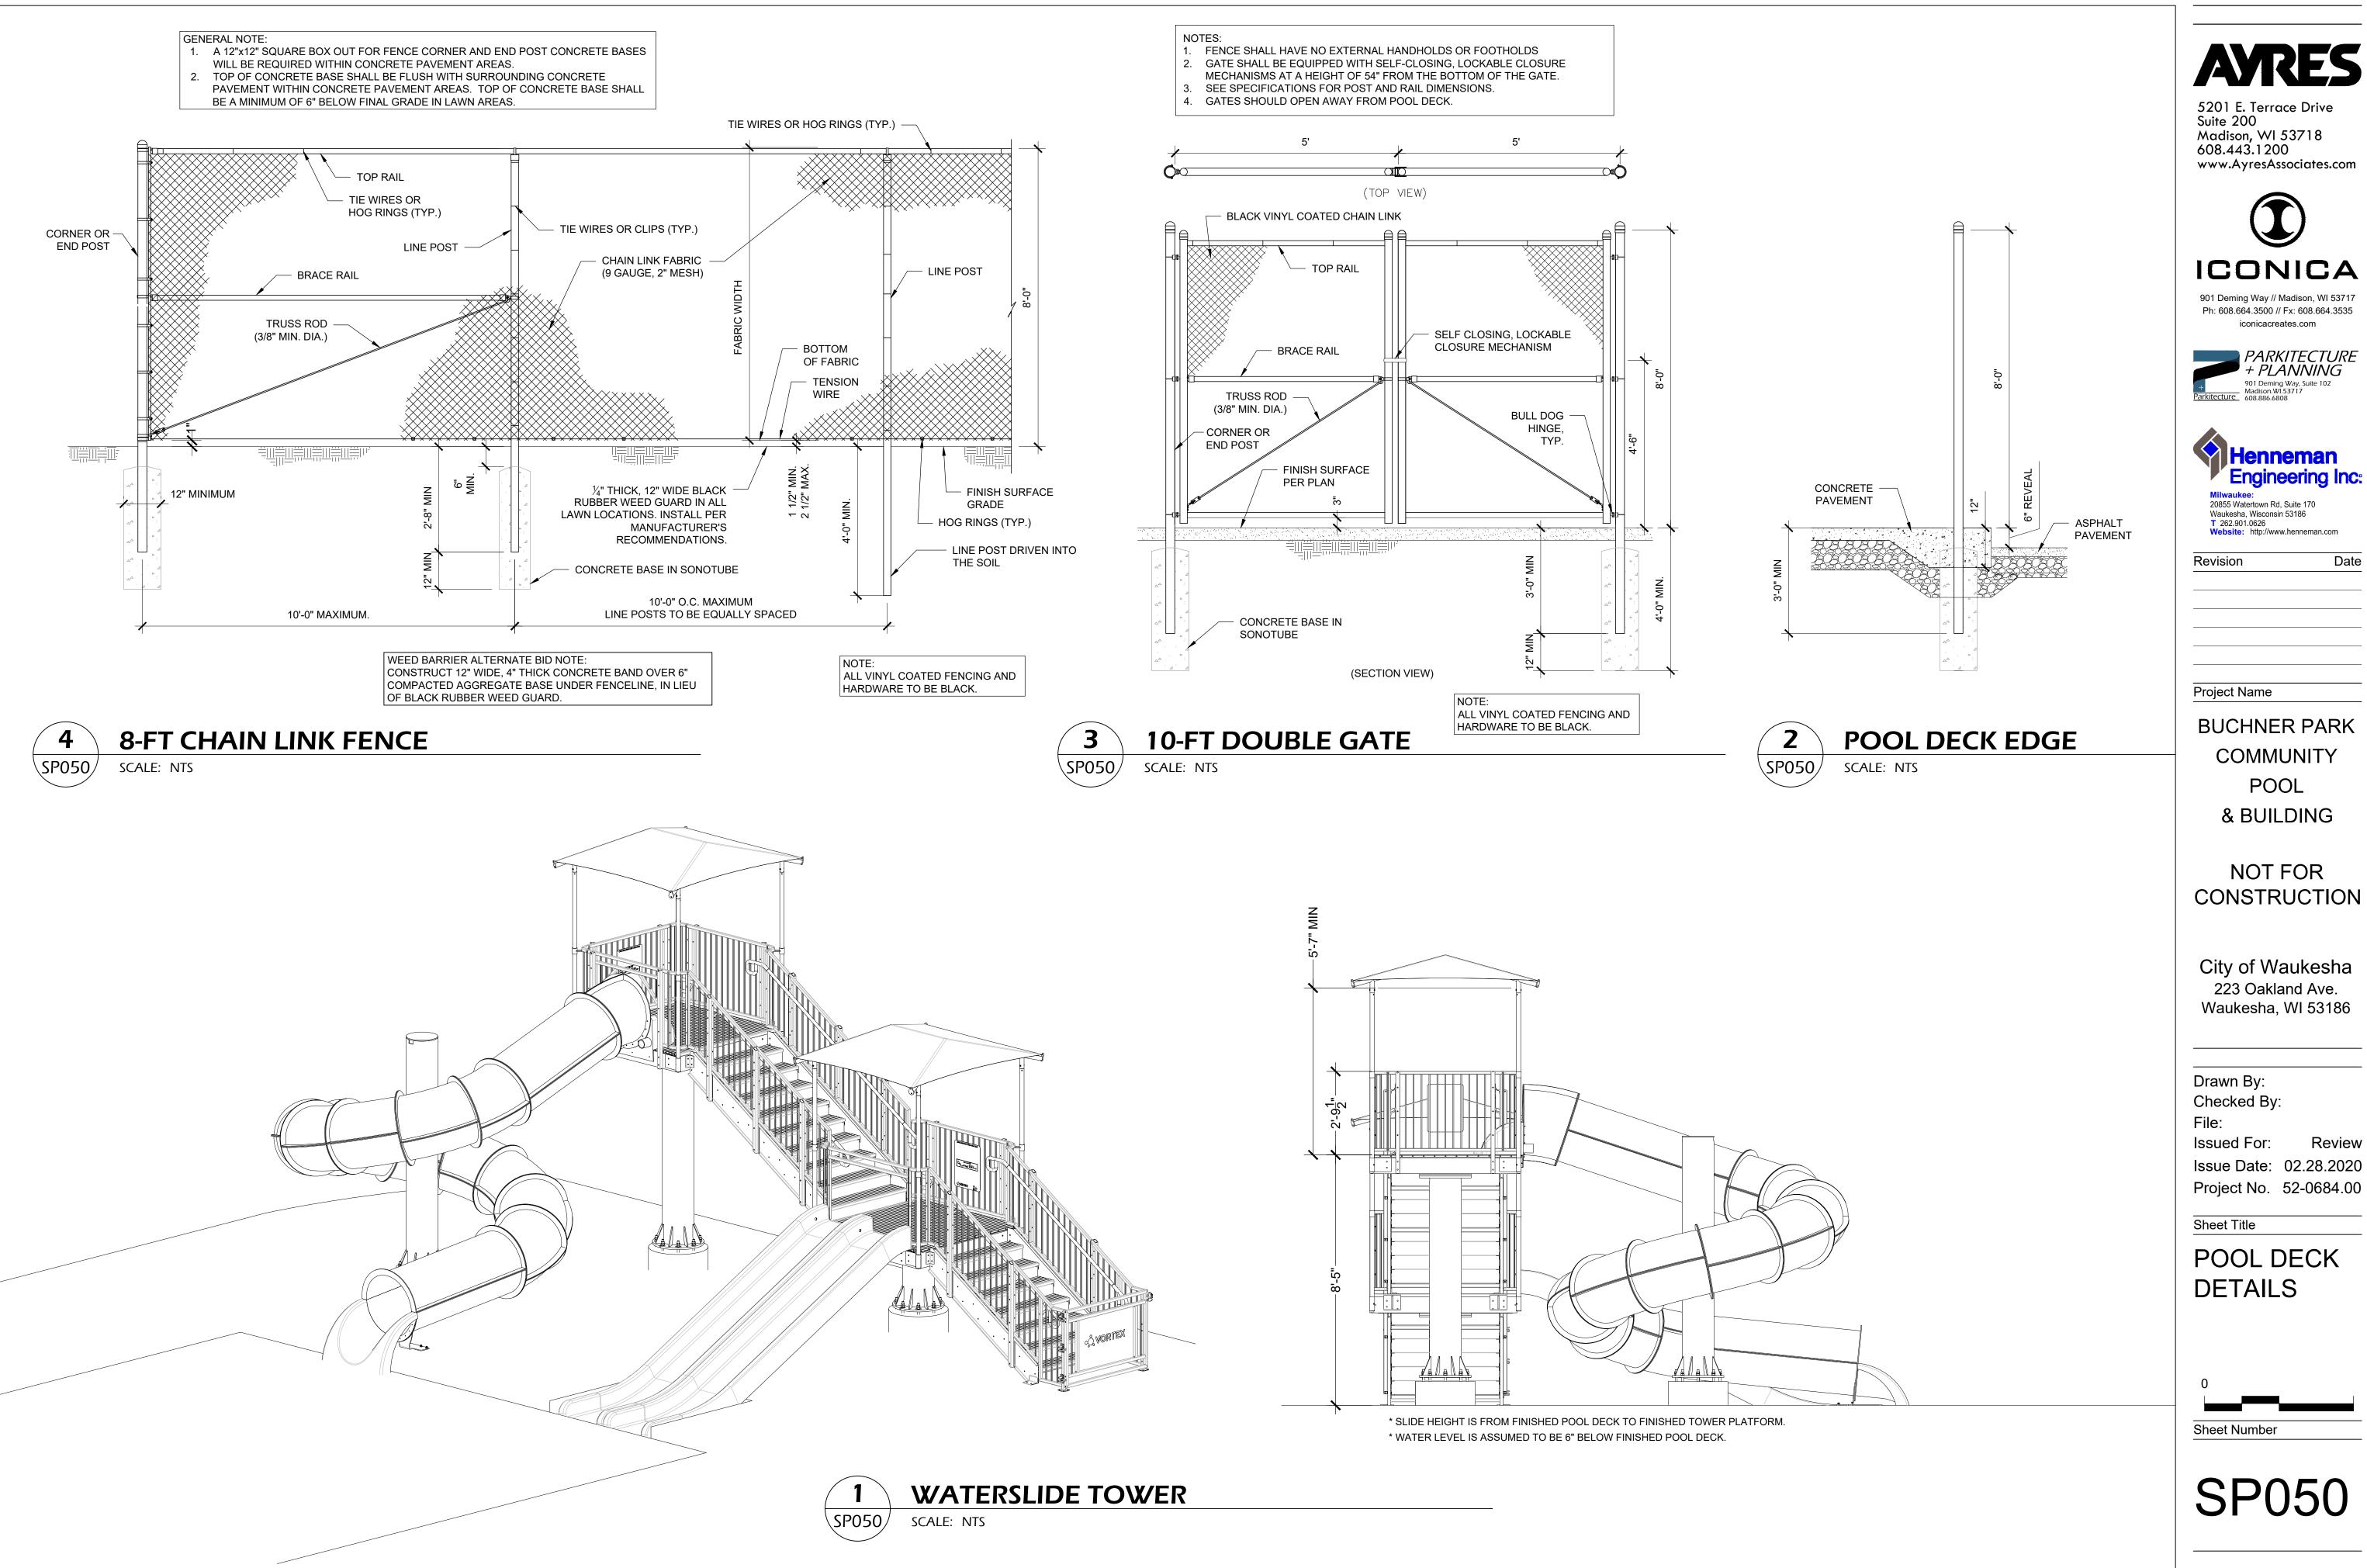



901 Deming Way // Madison, WI 53717 Ph: 608.664.3500 // Fx: 608.664.3535 iconicacreates.com





Milwaukee: 20855 Watertown Rd, Suite 170 Waukesha, Wisconsin 53186 T 262.901.0626

Website: http://www.henneman.com Date

Project Name

BUCHNER PARK COMMUNITY POOL & BUILDING

NOT FOR CONSTRUCTION


City of Waukesha 223 Oakland Ave. Waukesha, WI 53186


Drawn By: Checked By:

Issued For: Issue Date: 02.28.2020

Sheet Title

POOL DECK DETAILS

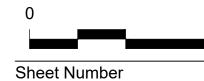

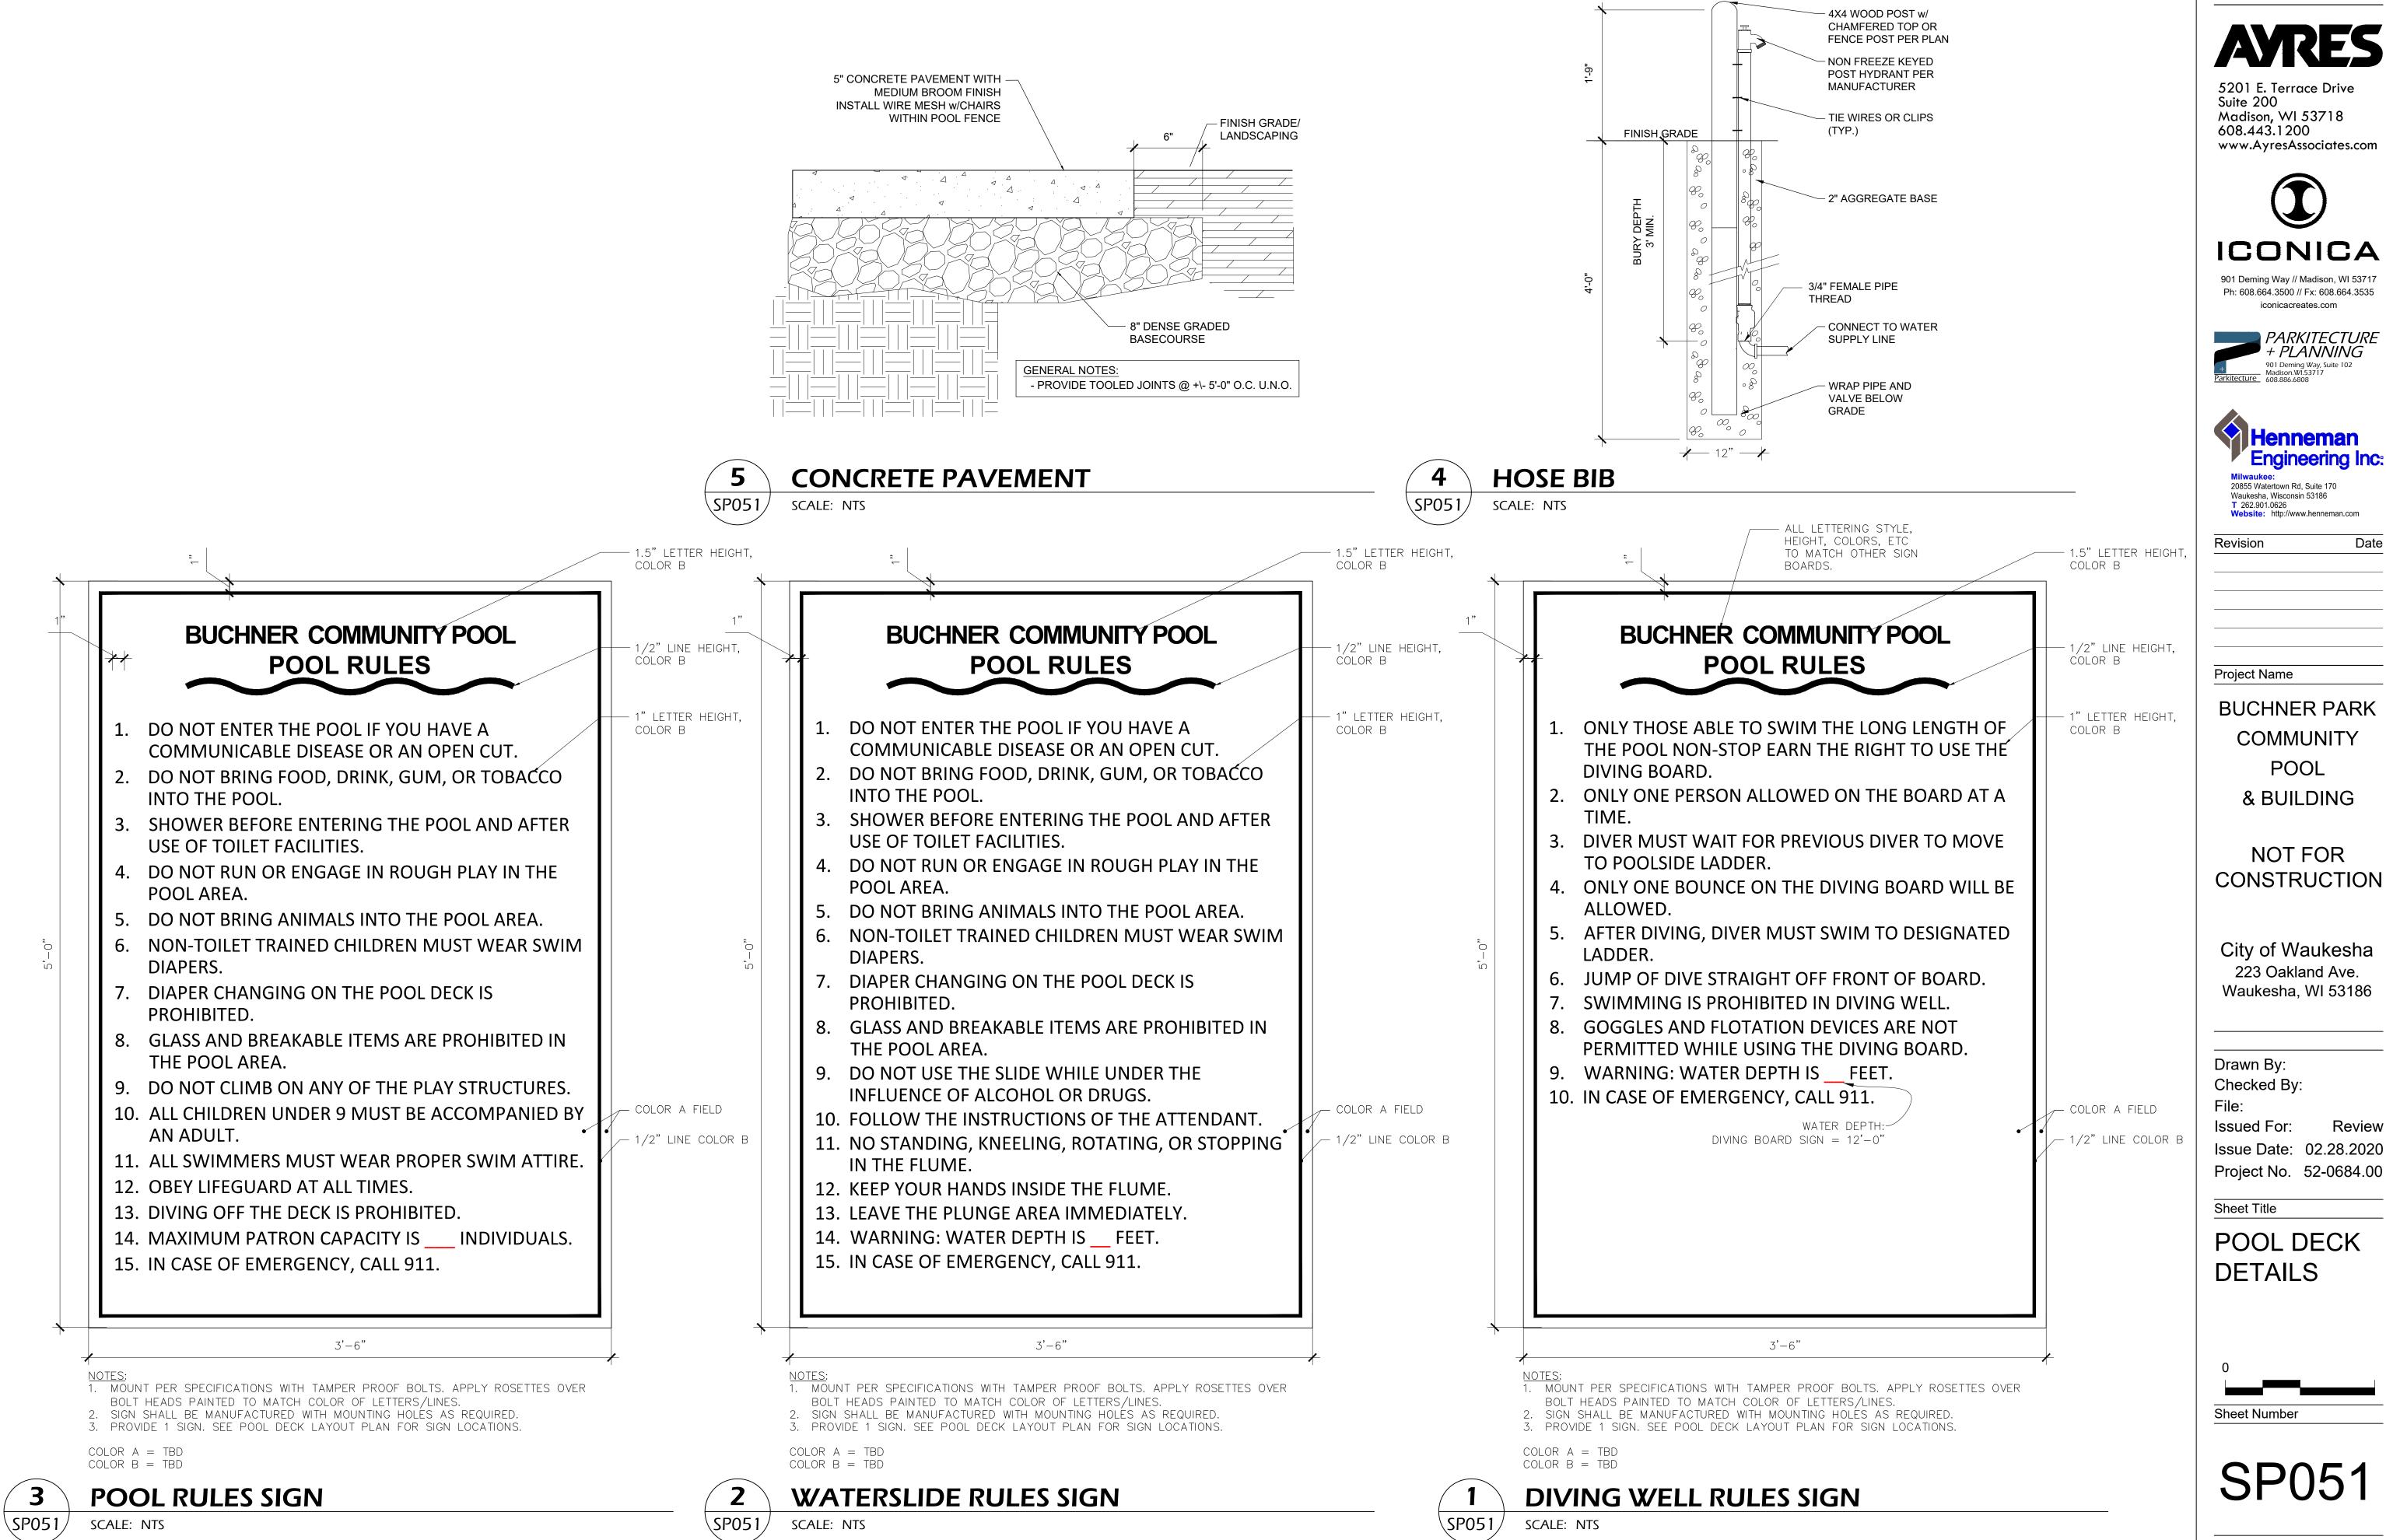



ICONICA 901 Deming Way // Madison, WI 53717





Milwaukee: 20855 Watertown Rd, Suite 170 Waukesha, Wisconsin 53186 T 262.901.0626

Project Name

BUCHNER PARK COMMUNITY POOL

& BUILDING

NOT FOR CONSTRUCTION

City of Waukesha 223 Oakland Ave. Waukesha, WI 53186


Drawn By: Checked By:


Issued For: Review Issue Date: 02.28.2020


Sheet Title

POOL DECK **DETAILS**


Sheet Number

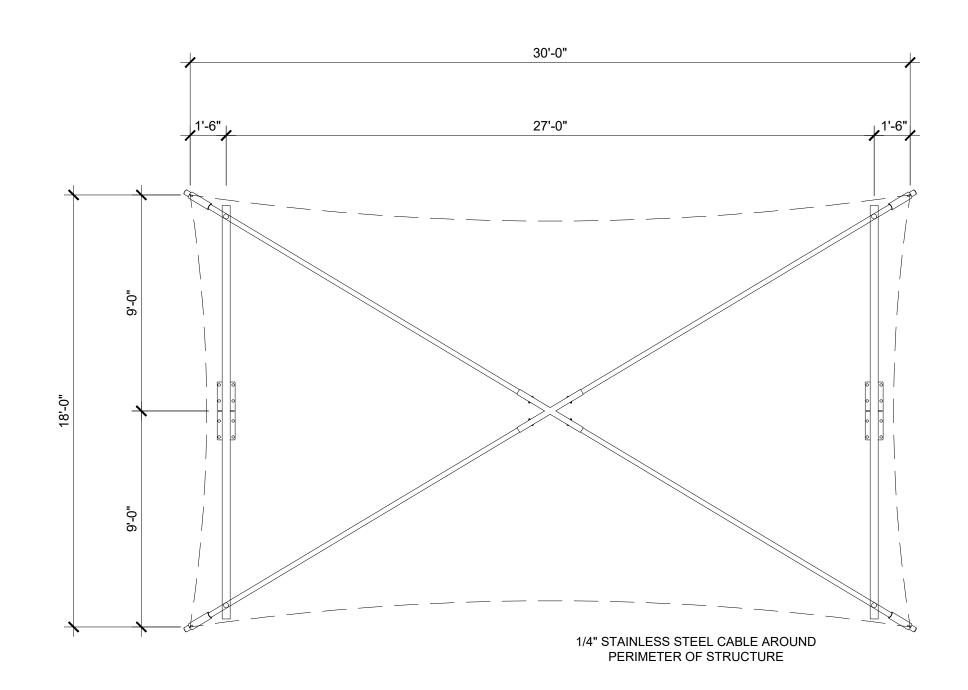

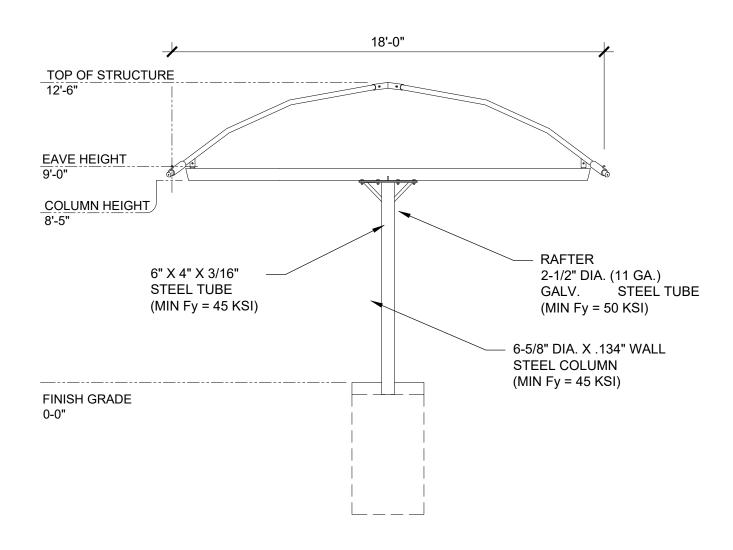


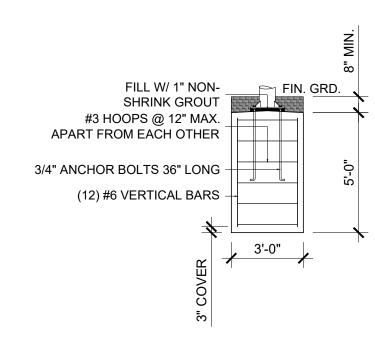




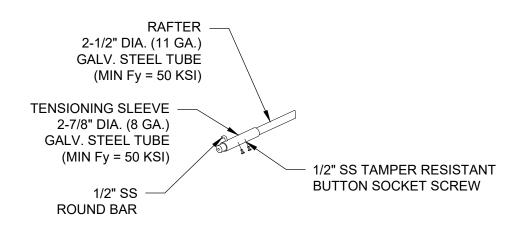


TOP CORNER DETAIL

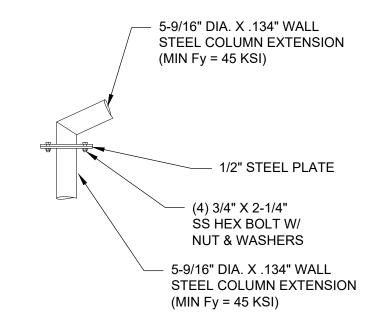

POST TO OFFSET DETAIL

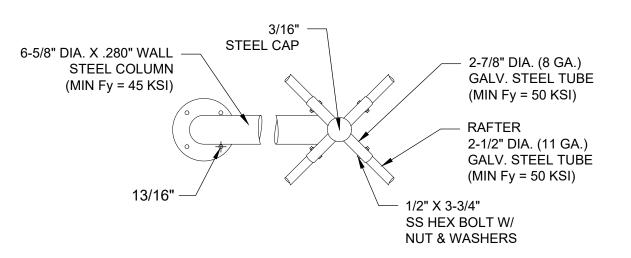

RAFTER TO POST CONNECTION

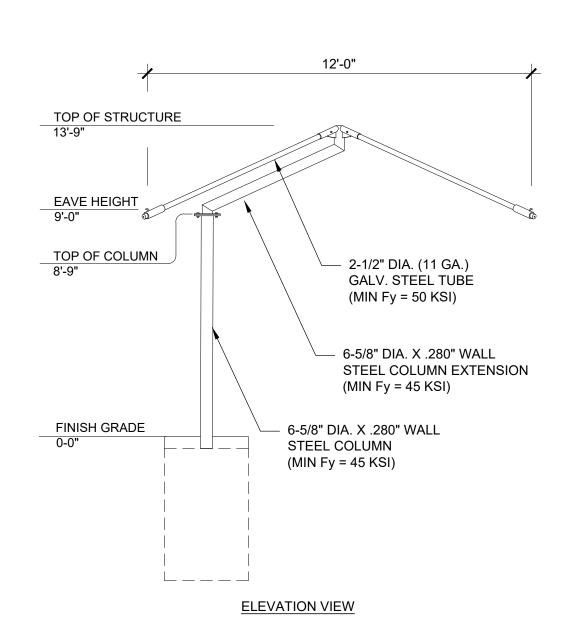



1. 'SHADE SYSTEMS' MODEL OSP121209 OR EQUAL

- 2. ALL FASTENERS SHALL BE STAINLESS STEEL.
- ASSEMBLE AND PLACE PER MANUFACTURER RECOMMENDATIONS.
- 4. IF MANUFACTURER RECOMMENDATIONS DIFFER FROM THIS DETAIL, MANUFACTURER RECOMMENDATIONS SHALL PREVAIL.
- 5. CONTRACTOR SHALL SUBMIT ENGINEER SEALED DRAWINGS AND CALCULATIONS FOR SHADE STRUCTURES AND FOOTINGS.


NOTE: FOOTING DIMENSIONS SHOWN SHALL BE USED FOR BID ESTIMATING ONLY. CONTRACTOR SHALL SUBMIT ENGINEER SEALED DRAWINGS AND CALCULATIONS FOR SHADE STRUCTURES AND

FOOTINGS. FINAL FOOTING DIMENSIONS WILL VARY.

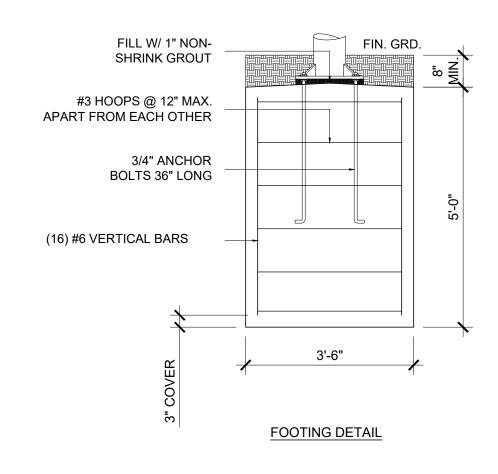

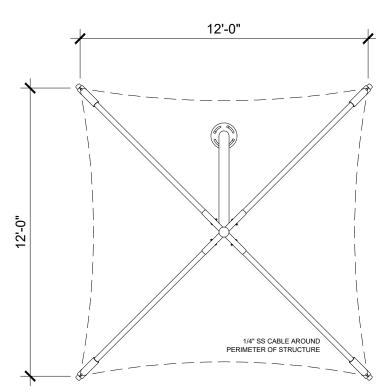

PLAN VIEW

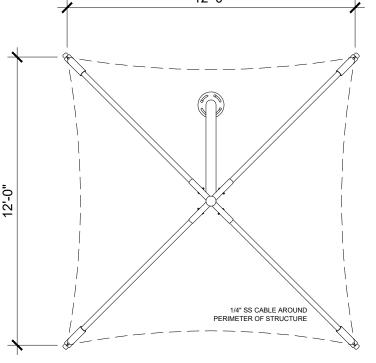



SHADE STRUCTURE - OFFSET SINGLE POST

Sheet Number

5201 E. Terrace Drive

Madison, WI 53718 608.443.1200

www.AyresAssociates.com

ICONICA

901 Deming Way // Madison, WI 53717 Ph: 608.664.3500 // Fx: 608.664.3535 iconicacreates.com

901 Deming Way, Suite 102 Madison.Wl.53717 608.886.6808

Milwaukee: 20855 Watertown Rd, Suite 170

Website: http://www.henneman.com

BUCHNER PARK

COMMUNITY

POOL

& BUILDING

NOT FOR

CONSTRUCTION

City of Waukesha

223 Oakland Ave. Waukesha, WI 53186

Issue Date: 02.28.2020

Project No. 52-0684.00

POOL DECK

DETAILS

Drawn By:

File:

Checked By:

Issued For:

Sheet Title

Waukesha, Wisconsin 53186

T 262.901.0626

Revision

Project Name

PARKITECTURE + PLANNING

Engineering Inc:


Date


Suite 200


SP052




SCALE: NTS

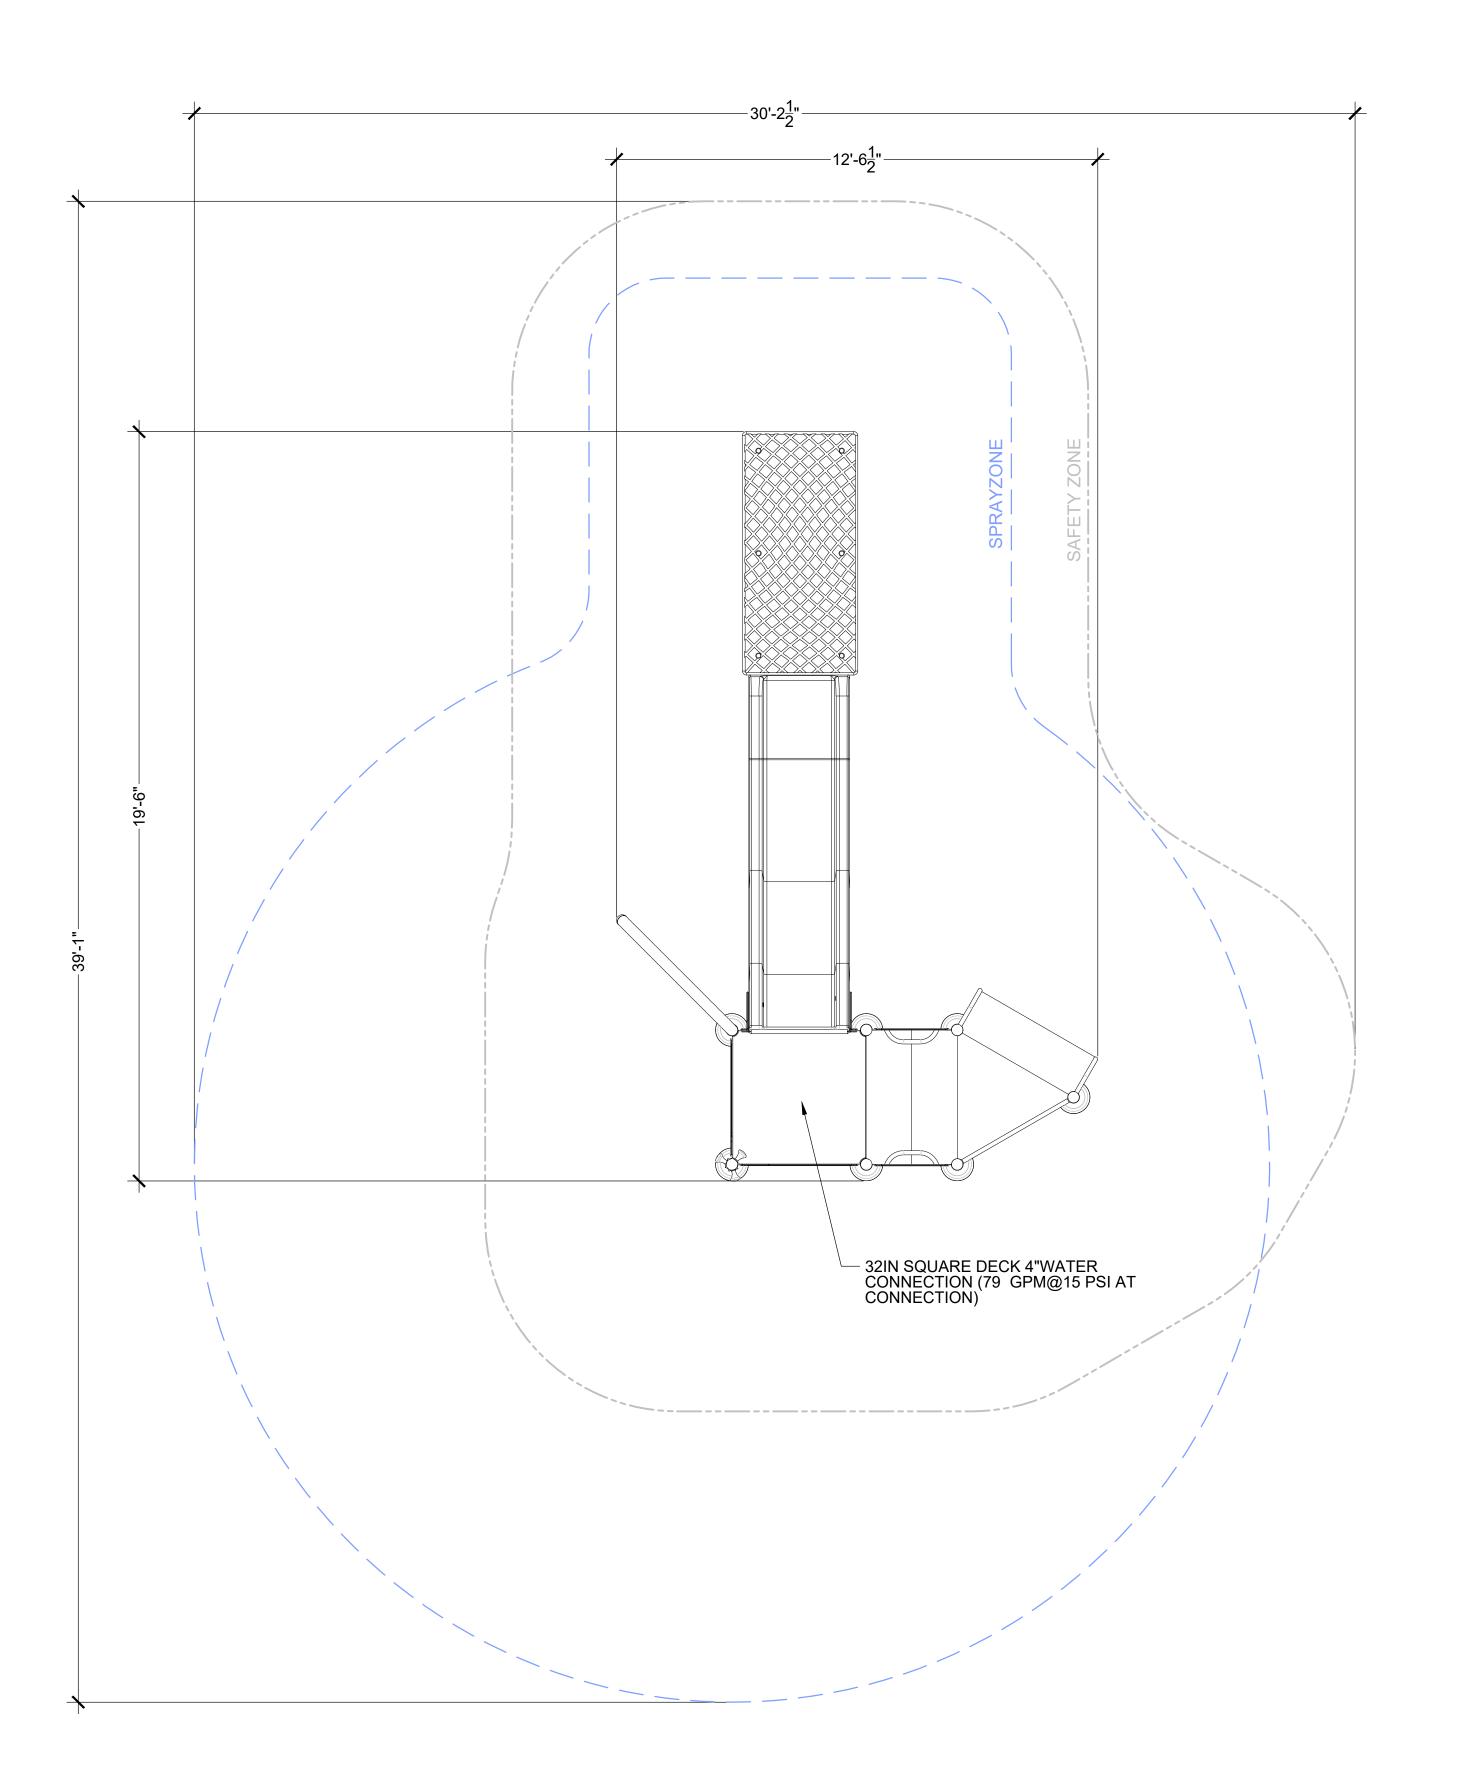

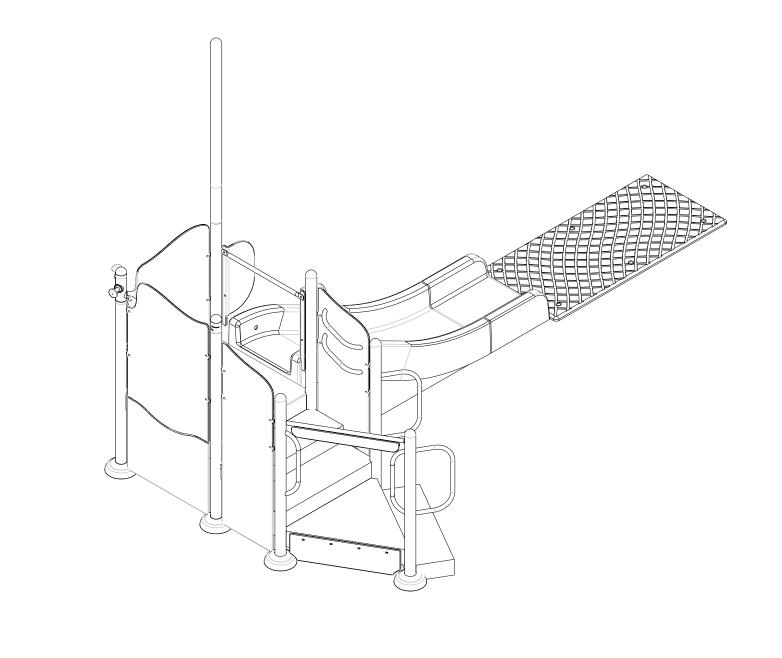

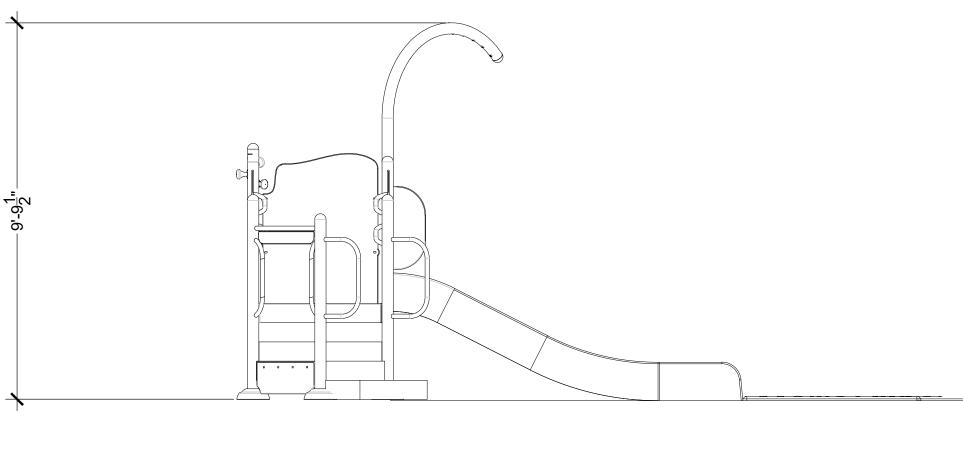

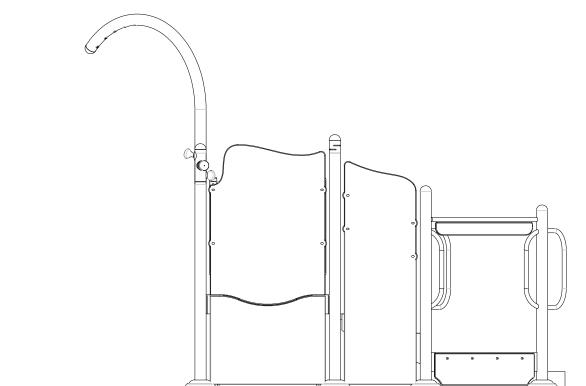



WADING POOL ACTIVITY STRUCTURE

SP053 SCALE: NTS

ALF: NITS



5201 E. Terrace Drive Suite 200 Madison, WI 53718 608.443.1200 www.AyresAssociates.com



901 Deming Way // Madison, WI 53717 Ph: 608.664.3500 // Fx: 608.664.3535 iconicacreates.com





Milwaukee:
20855 Watertown Rd, Suite 170
Waukesha, Wisconsin 53186
T 262.901.0626
Website: http://www.henneman.com

Revision Date

Project Name

BUCHNER PARK
COMMUNITY
POOL
& BUILDING

NOT FOR CONSTRUCTION


City of Waukesha 223 Oakland Ave. Waukesha, WI 53186


Drawn By: Checked By:

Issued For: Review
Issue Date: 02.28.2020
Project No. 52-0684.00

Sheet Title

POOL DECK DETAILS

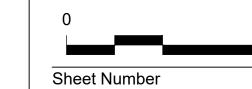

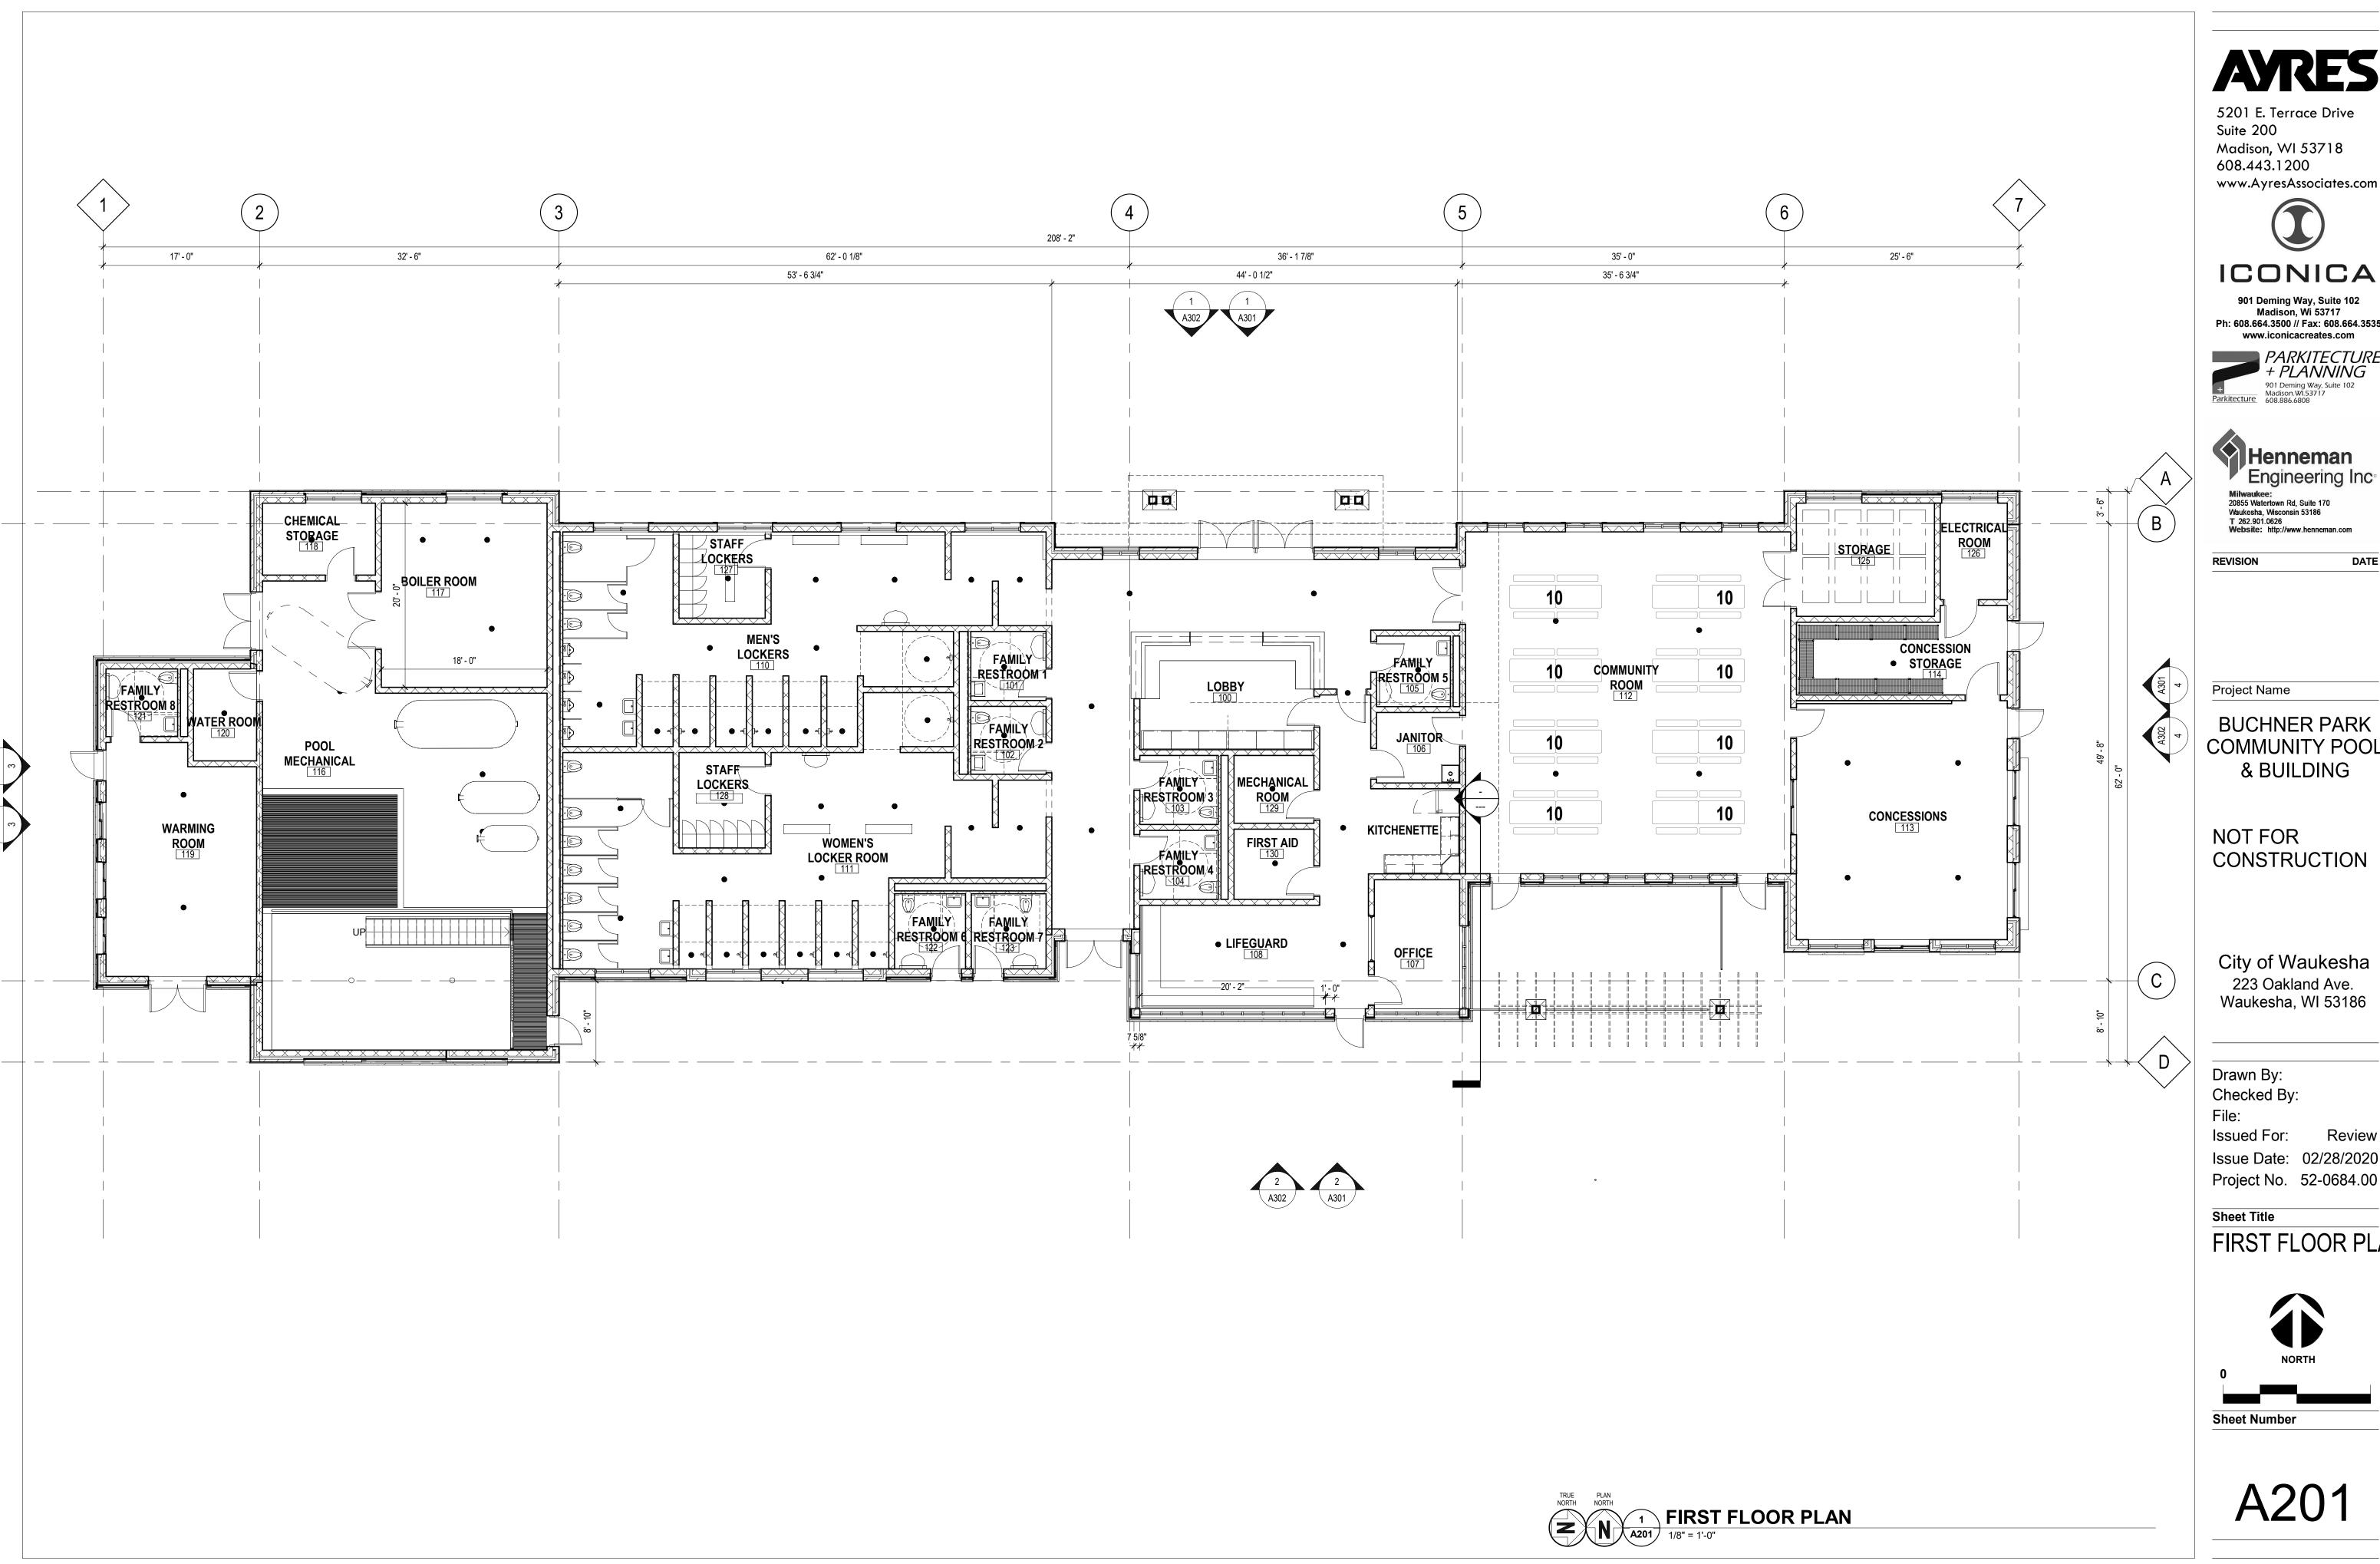



ICONICA

901 Deming Way, Suite 102 Madison, Wi 53717 Ph: 608.664.3500 // Fax: 608.664.3535 www.iconicacreates.com





Waukesha, Wisconsin 53186 T 262.901.0626


BUCHNER PARK COMMUNITY POOL & BUILDING

CONSTRUCTION

City of Waukesha 223 Oakland Ave. Waukesha, WI 53186

Issue Date: 02/28/2020 Project No. 52-0684.00

FIRST FLOOR PLAN

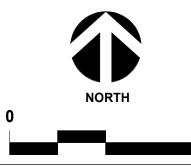

A201





- EXTERIOR FINISH SCHEDULE NOTES

 1. COLOR SELECTED FROM LP SIDING, SMARTSIDE AVAILABLE COLORS. 2. SEALANT COLORS SELECTED FROM TREMCO, DYAMONIC SERIES STANDARD
- 3. ALL EXTERIOR GUTTER, SOFFIT, FASCIA, AND DRIP EDGE MATERIAL TO BE PAINTED KYNAR 500 "CHARCOAL".
- 4. MORTAR FOR MASONRY TO BE TYPE-N GRAY.
- 5. MASONRY COLOR SELECTED FROM COUNTY MATERIALS, SPLITFACE SERIES
- AVAILABLE COLORS. 6. LP SARTSIDE SIDING WITH 30YR FINISH.
- 7. COLOR SELECTED FROM KAWNEER PERMACOAT STANDARD COLORS. 8. FINAL COLOR SELECTIONS SHALL BE MADE BY ARCHITECT DURING SUBMITTAL REVIEW PROCESS. ALL FINAL COLOR SELECTIONS SHALL BE MADE FROM
- RESPECTIVE MANUFACTURER'S STANDARD COLOR CHARTS. 9. COLOR SELECTED FROM OWENS CORNING "DURATION" SERIES STANDARD COLORS.
- 10. COLOR SELECTED FROM SHERWIN WILLIAMS STANDARD COLORS. FINISH =
- SEMI-GLOSS. 11. CUSTOM COLOR TO MATCH SHERWIN WILLIAMS "URBAN JUNGLE (SW 9117).



EAST ELEVATION - COLORED A302 1/8" = 1'-0"





5201 E. Terrace Drive

Madison, WI 53718

Suite 200

608.443.1200 www.AyresAssociates.com

ICONICA

901 Deming Way, Suite 102 Madison, Wi 53717 Ph: 608.664.3500 // Fax: 608.664.3535 www.iconicacreates.com





Milwaukee: 20855 Watertown Rd, Suite 170 Waukesha, Wisconsin 53186 T 262.901.0626

REVISION

Project Name

BUCHNER PARK COMMUNITY POOL & BUILDING

NOT FOR CONSTRUCTION

City of Waukesha 223 Oakland Ave. Waukesha, WI 53186


Drawn By: Checked By:

Issued For: Issue Date: 02/28/2020 Project No. 52-0684.00

Sheet Title

BUILDING **ELEVATIONS**



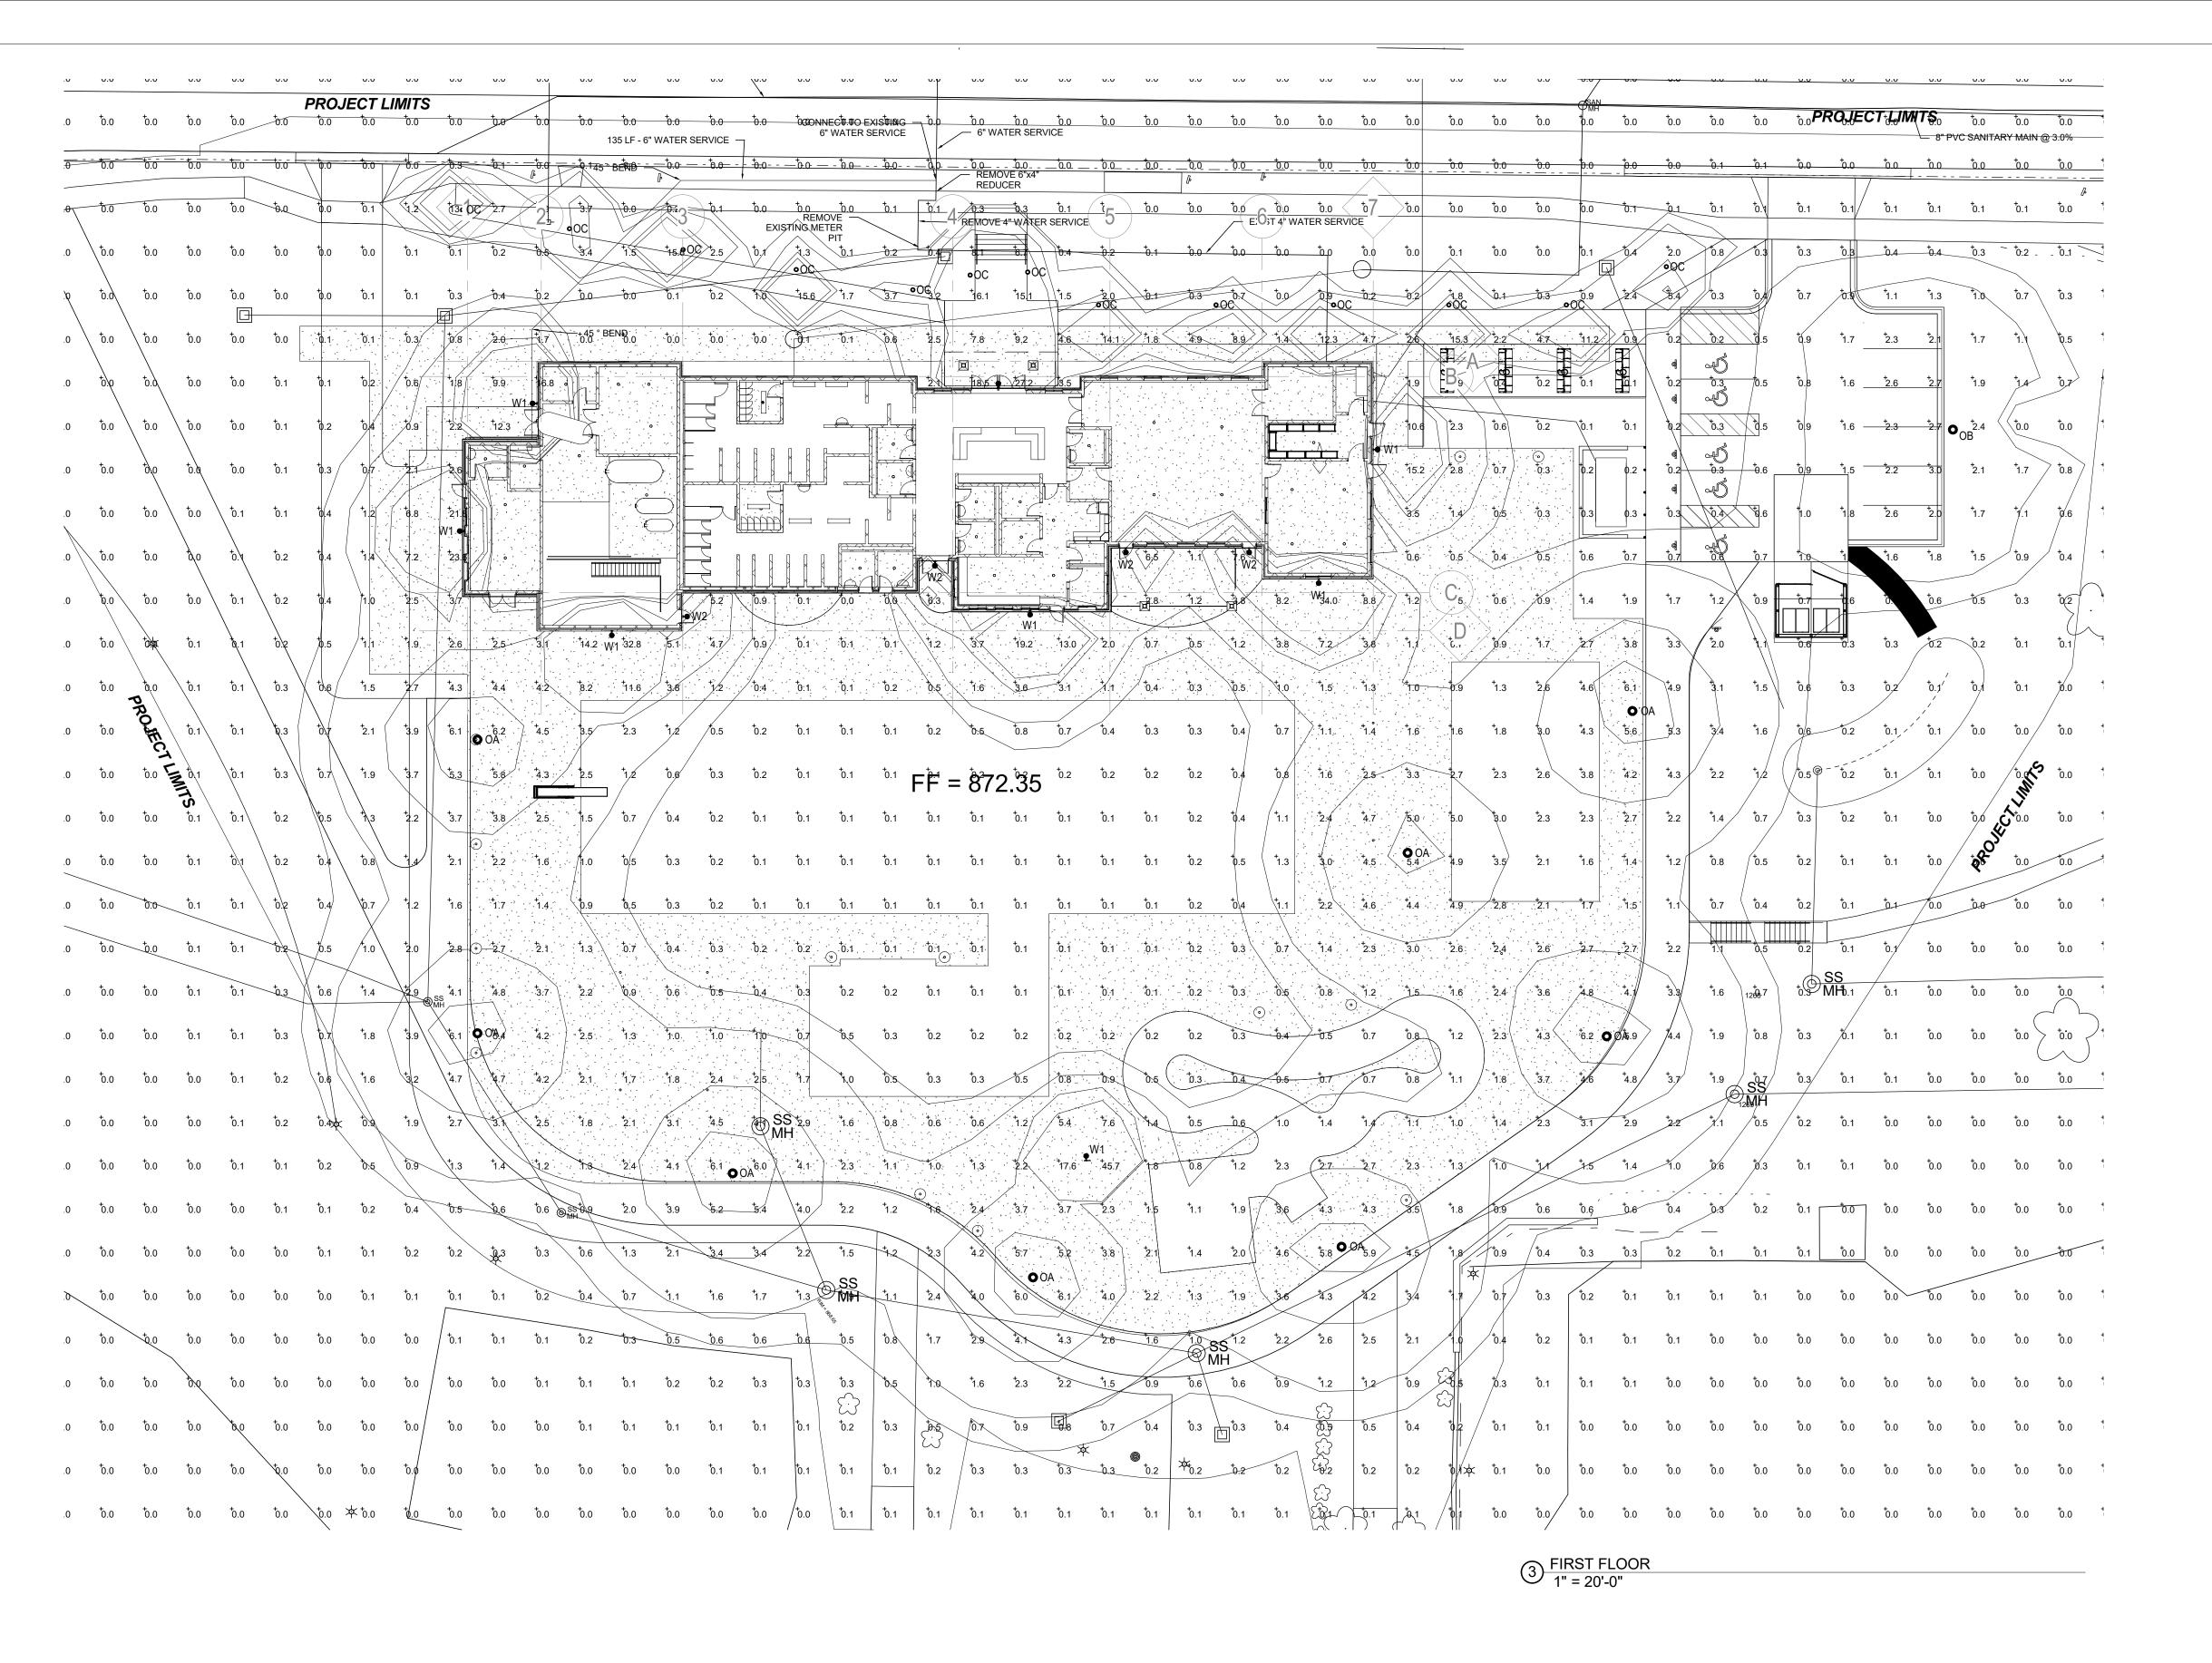

Symbol	Qty	Label	Arrangement	Total Lamp Lumens	LLF	Description
W1	8	C-WP-A-ARFC-LG-8L-40K-DB IES	SINGLE	8917.85	0.900	C-WP-A-ARFC-LH-8L-40K-DB
OA	8	ARE-EDG-5M-xx-06-E-UL-xx-700-	SINGLE	N.A.	0.900	ARE-EDG-5M-xx-06-E-UL-xx-700-xxxx-40K
OB	1	ARE-EDG-4M-xx-06-E-UL-xx-525-	SINGLE	N.A.	0.900	ARE-EDG-4M-xx-06-E-UL-xx-525-xxxx-40K
W2	4	rab04264mod50	SINGLE	N.A.	0.900	SLIM12
OC	13	PWY-EDG-2M-xx-02-E-UL-350-40K	SINGLE	N.A.	0.950	PWY-EDG-2M-xx-02-E-UL-350-40K _ BXBPx218E-UH7





ICONICA

901 Deming Way, Suite 102 Madison, Wi 53717 Ph: 608.664.3500 // Fax: 608.664.3535 www.iconicacreates.com





Milwaukee: 20855 Watertown Rd, Suite 170 Waukesha, Wisconsin 53186 T 262.901.0626 Website: http://www.henneman.com

REVISION

Project Name

BUCHNER PARK COMMUNITY POOL & BUILDING

NOT FOR CONSTRUCTION

City of Waukesha 223 Oakland Ave. Waukesha, WI 53186

Drawn By: Checked By:

Issued For: Review
Issue Date: 02/28/2020

Sheet Title

SITE PHOTOMETRICS

Project No. 52-0684.00



0