# PHASE I - COMMERCIAL ALTERATION & ADDITION

EAST COAST HAIR DESIGNS LLC - 425 E. BROADWAY, WAUKESHA, WI 53186

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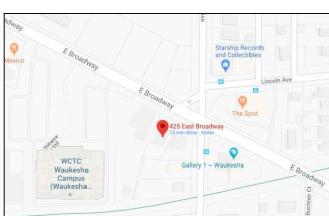
## ZONING INFO:

I. LOT AREA: 8.142 SQ. FT.

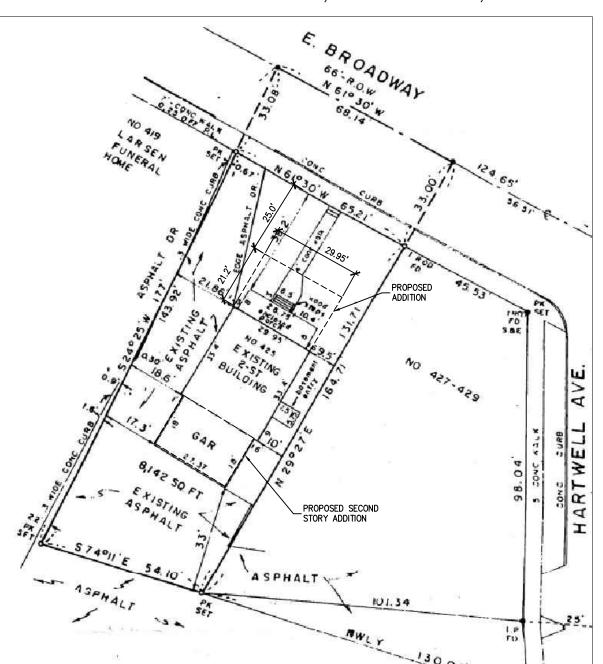
II. ZONING DISTRICT: B-3 GENERAL BUSINESS

III. SETBACKS - FRONT/SIDE/REAR: 25'/10'/33'

IV. LOT COVERAGE: 26.1%



MAP LOCATION



SITE PLAN SCALE: 1/32" = 1'-0"

VM ENGINEERING

VM Engineering LTD Vince Matarrese, PE License #E-45530 PHONE: (262) 364–8744 EMAIL: VINCE@VMPROENG.COM



COMMERCIAL REMODEL

OWNER: EAST COAST HAIR DESIGN LLC

PROPERTY ADDRESS: 425 E. BROADWAY WAUKESHA, WI 53186

SHEET TITLE TITLE PAGE

PROJECT NO. 20-008

6/17/2020

AS NOTED

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### **GENERAL NOTES**

GENERAL BUILDING COL

### The State of Wisconsin Uniform Building Code

- DESIGN AND CONSTRUCTION TO ALSO COMPLY WITH ANY JURISDICTION CODES THEIR RESPECTIVE COUNTY, CITY, VILLAGE OR TOWNSHIP AND TH PROVISIONS AND ORDINANCES.
- CONTRACTOR SHALL VERIFY ALL DIMENSIONS AND ELEVATIONS PRIOR TO CONSTRUCTION, ANY DISCREPANCIES SHALL BE BROUGHT TO THE IMMEDIATE ATTENTION OF THE STRUCTURAL ENGINEER.
- DRAWINGS REPRESENT THE FINISHED STRUCTURAL SYSTEM AND DO NOT NDICATE THE METHOD OF CONSTRUCTION. UNLESS SPECIFIC NOTES ARE PROVIDED ON DRAWINGS. THE CONTRACTOR SHALL BE SOLELY RESPONSIBLE FOR CONSTRUCTION MEANS AND METHODS, TECHNIQUES, SEQUENCES PROCEDURES, LAGGING, SHORING, BRACING, FORM WOR, ETC. AS REQUIRED FOR THE PROTECTION AND SAFETY OF LIFE AND PROPERTY DURING
- IN NO CASE SHALL STRUCTURAL ALTERATIONS, MODIFICATIONS OR WORK AFFECTING STRUCTURAL MEMBERS BE MADE WOUT WRITTEN APPROVAL OF T STRUCTURAL ENGINEER.
- IF ANY ERRORS OR OMISSIONS APPEAR IN THESE DRAWINGS, SPECFICATIONS OR OTHER DOCUMENTS, THE CONTRACTOR SHALL NOTIFY THE ARCHITECT OR STRUCTURAL ENGINEER IN WRITING PRIOR TO PROCEEDING W/ WORK.
- CONTRACTOR IS RESPONSIBLE FOR WATERPROOFING AND MOISTURE

### DESIGN CRITERIA

- FLOOR LIVE AND DEAD LOADS
- 40 PSF LIVE
- 15 PSF DEAD FOR WOOD, LINOLEUM AND CARPET FLOORING
- MINIMUM DEFLECTION CRIT ROOF LIVE AND SNOW LOADS
- GROUND SNOW 30 PSF
- FLAT ROOF 24 PSF FLAT ROOF DEAD 15 PSF

### STUCTURAL STEEL

- FABRICATION AND ERECTION OF STRUCTURAL STEEL SHALL CONFORM TO THE AMERICAN INSTITUTE OF STEEL CONSTRUCTION, "MANUAL OF STEEL CONSTRUCTION (LATEST ED).
- ALL STEEL DETAILS AND CONNECTIONS SHALL BE IN ACCORDANCE WITH THE REQUIREMENTS OF THE AISC "SPECIFICATION FOR STRUCTURAL STEEL STEEL MATERIALS SHALL CONFORM TO THE FOLLOWING UNLESS STATED THERWISE ON THE DRAWINGS:
- ALL CONNECTION MATERIAL AND BASE PLATES SHALL CONFORM TO ASTM STANDARD A-36 (36 KSI), WITH 50 KSI STEEL PLATE WHERE NOTED.
- ALL BOLTS SHALL CONFORM TO ASTM A325 OR A490, NUTS SHALL CONFORM T ASTM A563 AND WASHERS SHALL CONFORM TO ASTM A-F436.
- ALL CONNECTION MATERIAL AND BASE PLATES SHALL CONFORM TO ASTM STANDARD A-36 (36 KSI), WITH 50 KSI STEEL PLATE WHERE NOTED.
- ALL ANCHOR BOLTS/RODS SHALL CONFORM TO ASTM F-1554 GRADE 36 WITH WELD ABILITY SUPPLEMENT S1, UNLESS OTHERWISE NOTED. SUBMIT GRADE CERTIFICATIONS FOR RECORD. STEEL SUPPLIER SHALL SUPPLY RIGID STEEL ALL SHOP OR FIELD BOLTED CONNECTIONS, SHALL BE BOLTED CONNECTIONS
- USING 3/4 INCH DIAMETER A325 N BOLTS IN STANDARD HOLES, UNLESS SPECIFICALLY NOTED OTHERWISE OVERSIZED OR SLOTTED HOLES SHALL NOT BE USED FOR ANY CONNECTIONS
- UNLESS SPECIFICALLY INDICATED ON THE DRAWINGS OR APPROVED IN WRITING
- ALL BUTT AND FULL PENETRATION WELDS SHALL BE MADE USING RUN OFF ABS WHICH SHALL BE REMOVED AND GROUND SMOOTH AFTER WELD IS
- ALL WELD BACK UP BARS SHALL BE REMOVED AND GROUND SMOOTH AFTER WELD IS COMPLETED, UNLESS NOTED OTHERWISE.

  ALL WELDS INDICATED SHALL MEET THE MINIMUM WELD SIDE SPECIFIED BY THE
- AISC MANUAL OF STEEL DESIGN. (SINGLE PASS AS REQUIRED) · ALL WELDS SHALL BE PERFORMED BY QUALIFIED WELDERS IN ACCORDANCE
- WITH A.W.S. SPECIFICATIONS, LATEST EDITIONS. ALL WELDING ELECTRODES SHALL CONFORM TO A.W.S. A5.1 GRADE E-70. BARE ELECTRODES AND GRANU FLUX SHALL CONFORM TO A.W.S. A5.17, F70 A.W.S. FLUX CLASSIFICATION
- ALTERNATE CONNECTIONS WILL BE ACCEPTED ONLY WITH THE WRITTEN APPROVAL OF THE ENGINEER. HOWEVER, THE ENGINEER SHALL BE THE SOLE JUDGE OF THE ACCEPTABILITY AND THE CONTRACTOR'S BID SHALL ANTICIPATE THE USE OF THOSE SPECIFIC DETAILS SHOWN ON THE DRAWINGS. IN ANY EVEN HE CONTRACTOR SHALL BE RESPONSIBLE FOR THE DESIGN OF SUCH
- SHOP AND FIELD CONNECTIONS NOT SPECIFICALLY DETAILED ON THE DRAWINGS SHALL BE BOLTED OR WELDED.
- WHEN NOT SPECIFICALLY DETAILED ELSEWHERE ON THE DRAWINGS, ALL BEAN TO BEAM AND BEAM TO COLUMN CONNECTIONS SHALL BE DETAILED AS SHOWN IN THE TYPICAL BEAM CONNECTION DETAILS.

  • ALL BEAM AND GIRDERS SHALL BE CONNECTED FOR 115% OF THE REACTION
- DENOTED BY THE SYMBOL V ON THE PLAN. PROVIDE A MINIMUM 2 BOLT
- ALL BEAM AND GIRDER CONNECTIONS SHALL BE AT LEAST CAPABLE OF DEVELOPING THE UNIFORMLY DISTRIBUTED LOAD CAPACITY OF THE MEMBER USING THE REACTION FROM THE ALLOWABLE LOAD OF BEAM AS TABULATED IN THE AISC MANUAL OF STEEL CONSTRUCTION LATEST EDITION UNLESS NOTED THERWISE. FOR COMPOSITE BEAMS MULTIPLY THE REACTION BY THE RATIO Str/S WHERE Str = SECTION MODULUS OF THE TRANSFORMED COMPOSITE CROS SECTION WITH RESPECT TO THE BOTTOM FLANGE, AND S= SECTION MODULUS OF THE STRUCTURAL STEEL ALONE.
- THE STRUCTURAL STEEL ACONE.

  THE STRUCTURAL STEEL CONTRACTOR SHALL COORDINATE THE BOTTOM OF BASE PLATE ELEVATION WITH THE TOP OF CONCRETE ELEVATION.

  ALL STRUCTURAL STEEL EXPOSED TO WEATHER SHALL BE GALVANIZED.
- ALL TUBE & PIPE SECTIONS EXPOSED TO WEATHER SHALL HAVE OPEN ENDS
- TEMPORARY BRACING OF STRUCTURAL STEEL ELEMENTS IS THE RESPONISIBILITY OF THE CONTRACTOR STRUCTURAL STABILITY SHALL BE MAINTAINED AT ALL TIMES DURING THE ERECTION PROCESS.

### POURED CONCRETE / FOUNDATION

- CONCRETE CONSTRUCTION SHALL BE IN ACCORDANCE W/ ACL 318 "BUILDING CODE REQUIREMENTS FOR STRUCTURAL CONCRETE" AND ACI 301 SPECIFICATIONS FOR STRUCTURAL CONCRETE."
- CONCRETE MIXING OPERATION SHALL CONFORM TO ASTM C94
- CONCRETE DESIGN STRENGTHS PER IRC TABLE R402 2:
- BASEMENT AND INTERIOR FLOOR SLABS 2,500 PS BASEMENT AND FOUNDATION WALLS 3,000 PSI
- PORCHES, CARPORTS AND GARAGE FLOOR SLABS 3,500 PSI MINIMUM ASSUMED SOIL BEARING CAPACITY IS 2,000 PSF
- FOUNDATION WALLS ENCLOSING BASEMENTS OR OTHER HABITABLE SPACE SHALL BE DAMP-PROOFED PER IRC SECTION 4406 - WHERE A HIGH WATER TABLE OR OTHER SEVERE WATER CONDITION EXISTS, THE WALLS SHALL BE NATERPROOFED.
- PROVIDE A MINIMUM 4" PERFORATED DRAW IN AROUND USABLE SPACE BELOW GRADE OR OTHER EQUIVALENT MATERIALS PER IRC SECTION 405.1. THE PIPE SHALL BE COVERED WITH NOT LESS THAN 6" OF WASHED GRAVEL OR CRUSHED ROCK. THE DRAIN SHALL DAYLIGHT TO THE EXTERIOR BELOW THE FLOOR LEVEL OR TERMINATE IN A MIN. 20 GAL SUMP PIT.
- ALL POURED CONCRETE WALLS TO BE BACKFILLED WITH SANDY TYPE SOIL AND
  BE WELL BRACED UNTIL CONCRETE IS THOROUGHLY CURED AND ADDITIONAL WEIGHT OF THE BUILDING IS IN PLACE
- ALL POURED CONCRETE FOOTINGS TO BE A MINIMUM OF 3'-6" BELOW FINISHED GRADE BEARING ON UNDISTURBED VIRGIN SOIL WITH A MINIMUM BEARING. CAPACITY OF 2000 PSF. VERIFICATION OF THE BEARING STRATUM FOR SLAB-ON-GRADES AND FOUNDATIONS SHALL BE SUPERVISED AND APPROVED BY A QUALIFIED GEOTECHNICAL ENGINEER
- UNEXCAVATED GARAGE SLAB SHALL COMPLY W/ IRC TABLE 402.2 4" CONCRET SLAB MIN. 3.500 SPECIFIED COMPRESSIVE STRENGTH OF CONCRETE ON 4" MIN WELL COMPACTED SAND OR GRAVEL BASE.

  CONTRACTOR IS TO KEEP EXCAVATIONS DRY AT ALL TIMES DURING
- FOUNDATION CONSTRUCTION. ALL FOUNDATION CONCRETE SHALL BE PLACED IN . TIMELY MANNER AFTER EXCATIONS ARE OPENED. NO FOUNDATION SHALL BE PLACED IN STANDING WATER CONTRACTOR SHALL PROVIDE MEANS FOR DEWATERING EXCAVATIONS AS REQUIRED TO ACHEIVE DRY EXCAVATIONS ALL FOOTING EXCAVATIONS SHALL BE INSPECTED PRIOR TO CONCRETE
- WHERE COMPACTION OF FILL IS REQUIRES, COMPACTION OF FILL MATERIAL SHALL BE MINIMUM 95% OF MAXIMUM DRY DENSITY
- ALL CONTINUOUS FOOTINGS SHALL BE CENTERED UNDER WALLS AND ALL PEIRS AND SPREAD FOOTINGS SHALL BE CENTERED UNDER COLUMNS OR PIERS UNLESS NOTED OTHERWISE.

  CONCRETE REINFORCEMENT SHALL BE PLACED ACCORDING TO THE CRSI
- "RECOMMENDED PRACTICE FOR PLACING REINFORCING BARS"

  CONCRETE REINFORCING BARS SHALL CONFORM TO ASTM 1615 (GR. 60).
- CLEAR COVER REQUIREMENTS FOR CONCRETE REINFORCEMENT SHALL
- CONFORM TO THE FOLLOWING UNLESS SPECIFICALLY NOTED OTHERWISE - CONCRETE CAST AGAINST AND PERMANELTY EXPOXED TO EARTH 3'
  - CONCRETE EXPOSED TO EARTH OR WEATHER
- #5 AND SMALLER 1-1/2" #6 THROUGH #18 2"
- CONCRETE NOT EXPOSED TO WEATHER OR IN CONTACT W/ GROUND - SLABS, WALLS, JOISTS: #11 AND SMALLER 3/4" - BEAMS, COLUMNS: PRIMARY, TIES, STIRRUPS OR SPIRALS 1-1/2"
- UNLESS OTHERWISE DETAILED, PROVIDE (2) #5 BARS AROUND ALL OPENINGS AND (2) #5 DIAGONAL BARS AT ALL OPENINGS AND RE-ENTRANT CORNERS. BARS SHALL EXTEND A MINIMUM OF 30" PAST OPENING.
- BASE PLATE GROUT SHALL BE NON-SHRINK, NON-METALLIC W/ A MINIMUM COMPRESSIVE STRENGTH OF 8,000 PSI.
- CONTRACTOR IS RESPONSIBLE FOR REPAIR OF IRREGULATITIES OR DEFECTS IN CONCRETE WORK PRIOR TO PLACEMENT OF FINISH MATERIALS. ALL SPLICES IN COCNRETE REINFORCEMENT SHALL BE CLASS BLAP SPLICES
- JNLESS NOTED OTHERWISE. ADJACENT SPLICES SHALL BE STAGGERED A MINIMUM OF 3'-0" UNLESS DETSILED OTHERWISE. REFER TO LAP SPLICE AND DEVELOPMENT LENGTH SCHEDULE.

  • PROVIDE CORNER BARS AT ALL CORNERS AND WALL INTERSECTIONS.
- SLAB-ON-GRADE CONTROL JOINTS IS THE RESPONSIBILITY OF THE CONTRACTOR
- WELDED WIRE FABRIC SHALL CONFORM TO ASTM A 1064, WELDED WIRE FABRI
  SHALL BE LAPPED ONE WIRE SPACE PLUS 2" FOR PLAIN WIRE AND 8" FOR

### WOOD FRAMING

- DESIGN. FABRICATION AND CONSTRUCTION SHALL CONFORM TO THE "NATIONAL DESIGN SPECIFICAITON (NDS) FOR WOOD CONSTRUCTION" BY THE AMERICAL WOOD COUNCIL
- ALL LUMBER SHALL BE PROPERLY IDENTIFIED W/ A GRADE MARK OF A LUMBE INSPECTION AGENCY COMPLYING W/ DOC PS20 "AMERICAN SOFTWOOD LUMBE STANDARD."
- WOOD MEMBERS DIRECTLY EXPOSED TO MOISTURE OR BEARING ON CONCRETE OR MASONRY THAT IS IN DIRECT CONTACT W/ EARTH SHALL BE
- PRESERVATIVE TREATED.

  ATTACHMENTS NOT SPECIFICALLY DETAILED SHALL CONFORM TO THE FASTENING SCHEDULE LISTED IN IRC TABLE R602.3(1).
  • PROVIDE PRESSURE TREATED SILL PLATE ON SILL SEALER WITH 1/2" DIA
- ANCHOR BOLTS @ 6'-0" O.C. AND LOCATED NOT MORE THAN 12" AND NOT LESS THAN 3 1/2" FROM THE ENDS OF EACH PLATE SECTION.

  • WOOD 2x FRAMING MEMBERS SHALL HAVE 1x3 X-BRIDGING OR 2x BLOCKING
- MEMBERS AT 8'-0" O.C. MAXIMUM. BOLTS AND LAGS SHALL CONFORM TO ASTM A307 UNLESS NOTED OTHERWISE HARDENED STEEL WASHERS SHALL BE USED BETWEEN THE BOLT OR LAG HEAD
- TEMPORARY BRACING SHALL BE PROVIDED AND REMAIN IN PLACE UNTIL THE STRUCTURE IS COMPLETELY STABILZED WISHEATHING ON AT LEAST ONE SIDE O THE WALL. TO RESIST BUCKLING OF LOAD BEARING STUDS, CONTRACTOR SHALL AT A MINIMUM USE A CONTINUOUS 2x MEMBER ATTACHED TO THE STUD WALLS A MID HEIGHT. TEMPRARY X-BRACING TO RESIST LATERAL LOADS SHALL BE USED. TEMPORARY BRACING IS THE RESPONSIBILITY OF THE CONTRACTOR
- ROOF TRUSS DESIGNED BY THE TRUSS MANUFACTURER TO CONFORM TO ALL MINIMUM DESIGN LOAD REQUIREMENTS. BRACE ROOF TRUSSES AS RECOMMENDED BY MANUFACTURER. ROOF TRUSS MANUFACTURER SHOULD INDICATE TO THE ARCHITECT PRIOR TO FABRICATION, ANY CHANGE IN BEARING CONDITION. THE ROOF TRUSS MANUFACTURER TO FURNISH SHOP DRAWINGS TO THE DESIGNER PRIOR TO FABRICATION OF THE TRUSSES.
- TRUSS MANUFACTURER TO PROVIDE TRUSS DESIGN DRAWINGS IN COMPULANCE
- 1 SLOPE OR DEPTH, SPAN, BEARING LOCATIONS AND SPACING 2 LOCATION OF ALL JOINTS

(MAX SPAN)

6'-0"

10'-0"

- 3 REQUIRED BEARING WIDTHS 4 DESIGN LOADS (DL, LL, CONCENTRATED LOADS)

MEMBER SIZE

(3) 2x 12

(2) 1.75"x9.25"

(2) 1.75"x11.25

FLOOR SYSTEM TO TRANSFER VERTICAL LOADS

3) 1 75"v11 25

ALL MICROLLAM BEAMS TO BE JOINED TOGETHER PER MANUFACTURER'S

WOOD HEADER SCHEDULE

<u>NOTES:</u> I - HEADER LUMBER TO BE NO. 2 DOUGLAS FIR-LARCH, HEM-FIR, SOUTHER PINE, OR SPRUCE-PINE-FIR, UNLESS NOTED OTHERWISE

- WOOD POSTS/BEARING STUDS SHALL RUN CONTINUOUS TO LOWEST SUPPORT LEVEL. PROVIDE EQUIVALENT SIZE BLOKCING IN THE

- MULTIPLE PLY STUDS SHALL BE ATTACHED TOGETHER W/ (2) ROWS OF 16d NAILS AT 16" O.C. NAILS MUST PENETRATE AT LEAST 3/4

- PROVIDE ADDITIONAL STUDS UNDER GIRDER TRUSSES TO ENSURE COLUMN WIDTH IS AT LEAST EQUAL TO TRUSS WIDTH.

- UNLESS NOTES OTHERWISE. HEADERS SHALL BE ATTACHED TOGETHER W/ (2) ROWS OF 16d NAILS AT 16" O.C.

COMMENTS

MICROLLAM 2.0E LVL

MICROLLAM 2.0E LVL

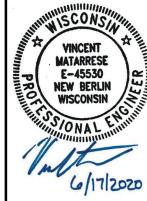
MICROLLAM 2 DE LV

### WINDOWS AND DOOR SCHEDULE ROUGH OPENING MARK FRAME SIZE W1 2'-5 1/2" x3'-11 3/4" 2'-6 1/2" x 4'-0 1/4" DBL HUNG W2 SLIDING 2'-11 1/2"x3'-11 1/2" 3'-0" x 4'-0" W3 DBI HUNG 8'-8"x6'-0" W4 DBL HUNG 6'-8"x6'-0" D1 PRE-HUNG INTERIOR DOOF 3/0x6/8x1-3/8 D2 STEEL ENTRY DOOR 3/0x6/8x1-3/4 DBL ENTRY STORE FRONT GLASS DOOR D3 6'-8"x7'-2"



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REVISIONS



COMMERCIAL REMODEL

EAST COAST HAIR DESIGN LLC

PROPERTY ADDRESS: 425 E. BROADWAY WAUKESHA, WI 53186

SHEET TITLE GENERAL NOTES

PROJECT NO 20-008

6/17/2020

AS NOTED

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Excavation, Erosion Control, Drainage General Notes:

- AT A MINIMUN BEARING STUDS SHOUD BE FOUND TO PLIES OF HEADER

ANY PERSON MAKING OR CAUSING AN EXCAVATION WHICH MAY AFFECT THE LATERAL SOIL SUPPORT OF ADJOINING PROPERTY OR BUILDINGS SHALL PROVIDE AT LEAST 30 DAYS WRITTEN NOTICE TO ALL OWNERS OF ADJOINING BUILDINGS OF THE INTENTION TO EXCAVATE, THE NOTICE SHALL STATE THAT ADJOINING BUILDINGS MAY REQUIRE PERMANENT PROTECTION. THE 30 DAY TIME LIMIT FOR WRITTEN NOTIFICATION MAY BE WAIVED IF SUCH WAIVER IS SIGNED BY THE OWNER(S) OF THE ADJOINING PROPERTIES

SHOULDER STUDS

(2) 2x

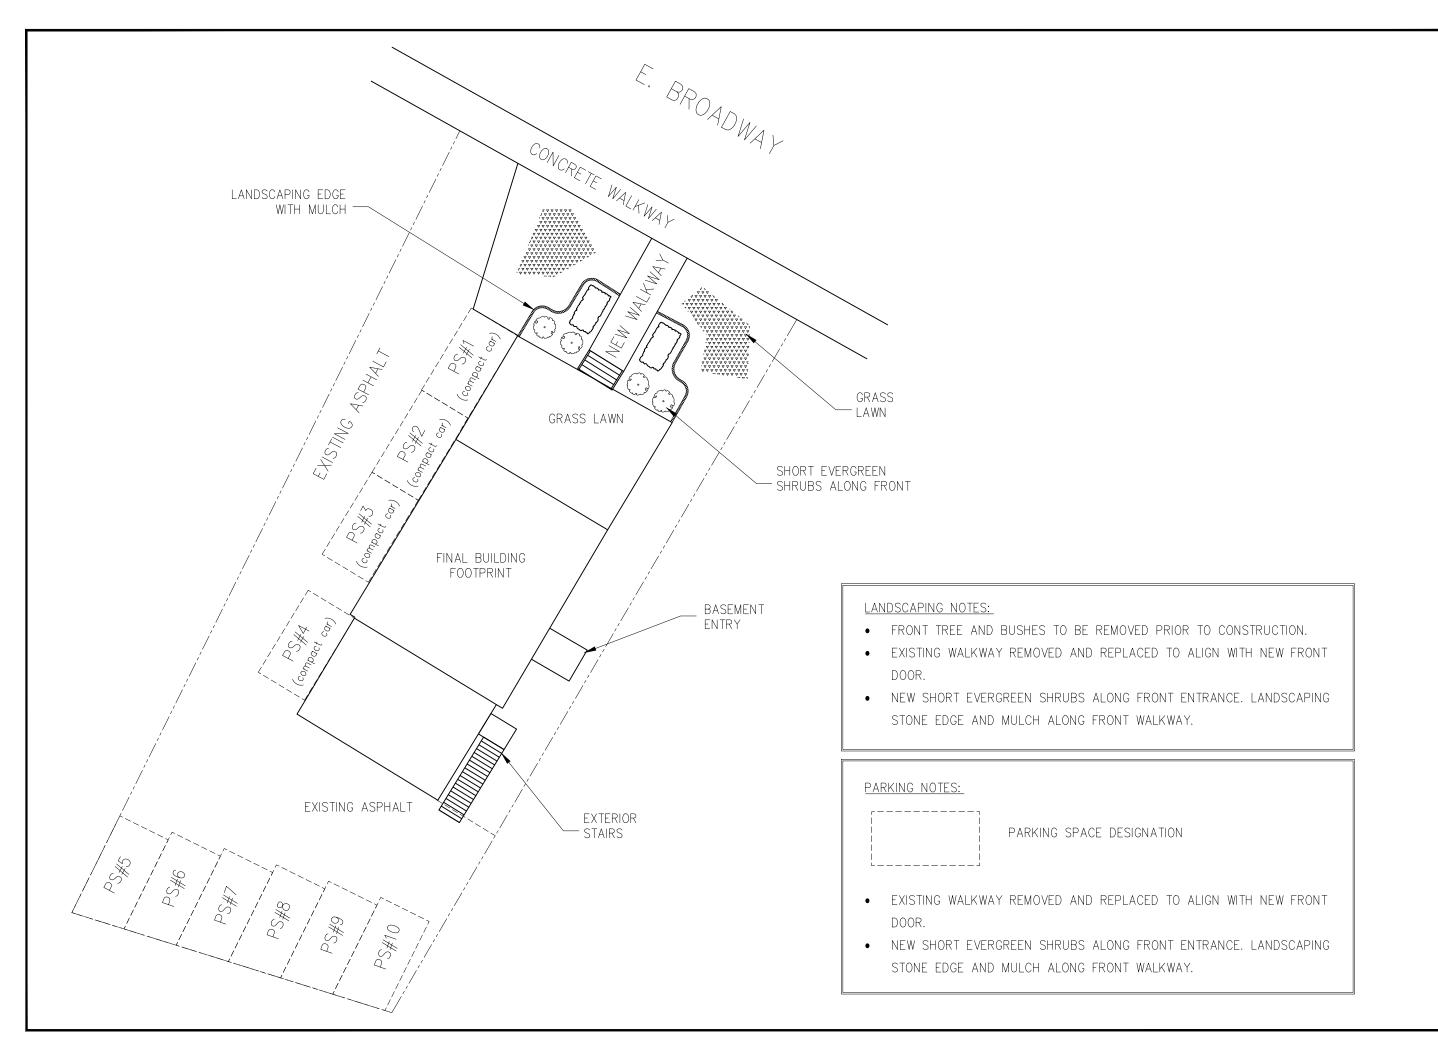
(2) 2x

(2) 2x

- THE FINISHED GRADE OF THE SOIL SHALL SLOPE AWAY FROM THE DWELLING AT A RATE OF AT LEAST 1/2" PER FOOT FOR A MINIMUM DISTANCE OF 10 FEET, OR TO THE LOT LINE, WHICHEVER IS LESS
- 3. WHERE LAND DISTURBING CONSTRUCTION ACTIVITY IS TO OCCUR EROSION CONTROL AND SEDIMENT CONTROL PRACTICES SHALL BE EMPLOYED, AS NECESSARY, AND MAINTAINED TO PREVENT OR REDUCE THE POTENTIAL DEPOSITION OF SOIL OR SEDIMENT TO ADJACENT PROPERTIES, INCLUDING:
  - ONTO STREETS BY VEHICLES
  - FROM DISTURBED AREAS INTO ONSITE STORM WATER INLETS
- FROM DISTURBED AREAS INTO ONSITE STORM WATER INLETS
   INTO ABUTTING WATERS
   DRAINAGE WAYS THAT FLOW OFF THE SITE
   DISCHARGE FROM DE-WATERING ACTIVITIES
   DISCHARGE FROM SOIL STOCKPILES EXISTING FOR MORE THAN 7 DAYS
  4. LAND DISTURBING CONSTRUCTION ACTIVITIES, EXCEPT THOSE ACTIVITIES NECESSARY
  TO IMPLEMENT EROSION OR SEDIMENT CONTROL PRACTICES, MAY NOT BEGIN UNTIL THE
  SEDIMENT CONTROL PRACTICES ARE IN PLACE.
  5. EROSION AND SEDIMENT CONTROL PRACTICES SHALL BE MAINTAINED UNTIL THE
  INSTITUTED AREAS ARE STABILIZED. THE DISTURBED AREA SHALL BE CONSCIPERED.
- DISTURBED AREAS ARE STABILIZED. THE DISTURBED AREA SHALL BE CONSIDERED STABILIZED BY VEGITATION WHEN A PERENNIAL COVER HAS BEEN ESTABLISHED WITH A
- DENSITY OF AT LEAST 70%.

  6. OFFSITE SEDIMENT DEPOSITION RESULTING FROM THE FAILURE OF AN EROSION OR SEDIMENT CONTROL PRACTICE SHALL BE CLEANED UP BY THE END OF THE NEXT DAY.

  7. OFF-SITE SOIL DEPOSITION RESULTING FROM CONSTRUCTION ACTIVITY THAT CREATES A NUISANCE, SHALL BE CLEANED UP BY THE END OF THE WORK DAY
- 8. STORM WATER MANAGEMENT PRACTICES SHALL BE EMPLOYED IN ACCORDANCE WITH THE WISCONSIN DEPARTMENT OF NATURAL RESOURCES STATUTES FOUND IN NR151.12





REVISIONS



COMMERCIAL REMODEL

OWNER: EAST COAST HAIR DESIGN LLC

PROPERTY ADDRESS: 425 E. BROADWAY WAUKESHA, WI 53186

SHEET TITLE

LANDSCAPING AND PARKING PLAN

PROJECT NO.

20-008

6/17/2020

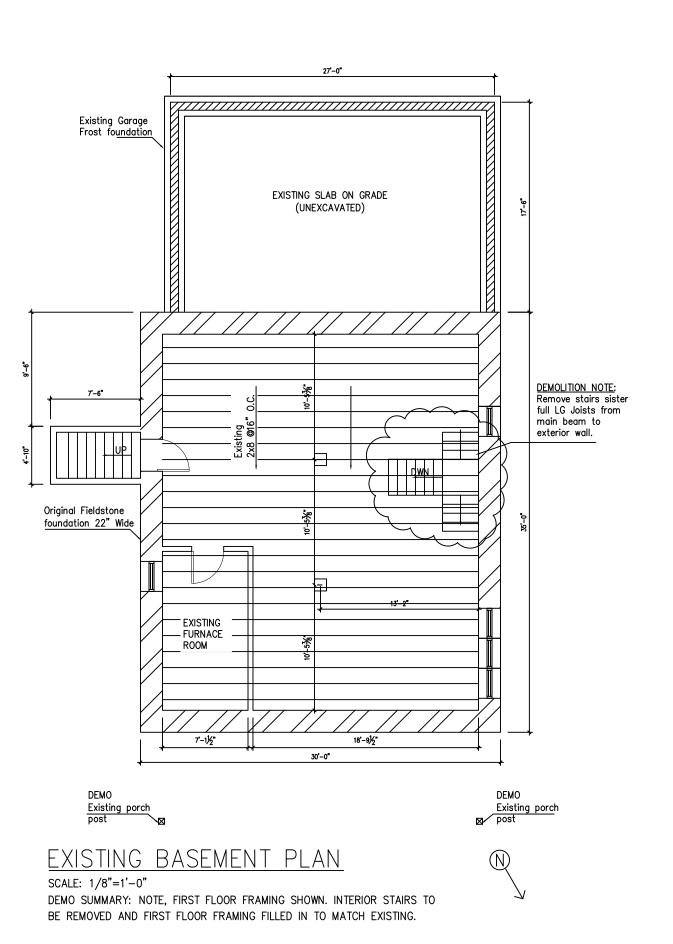
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SHEET TITLE EXISTING FLOOR LAYOUT AND DEMO NOTES

PROJECT NO. 20-008

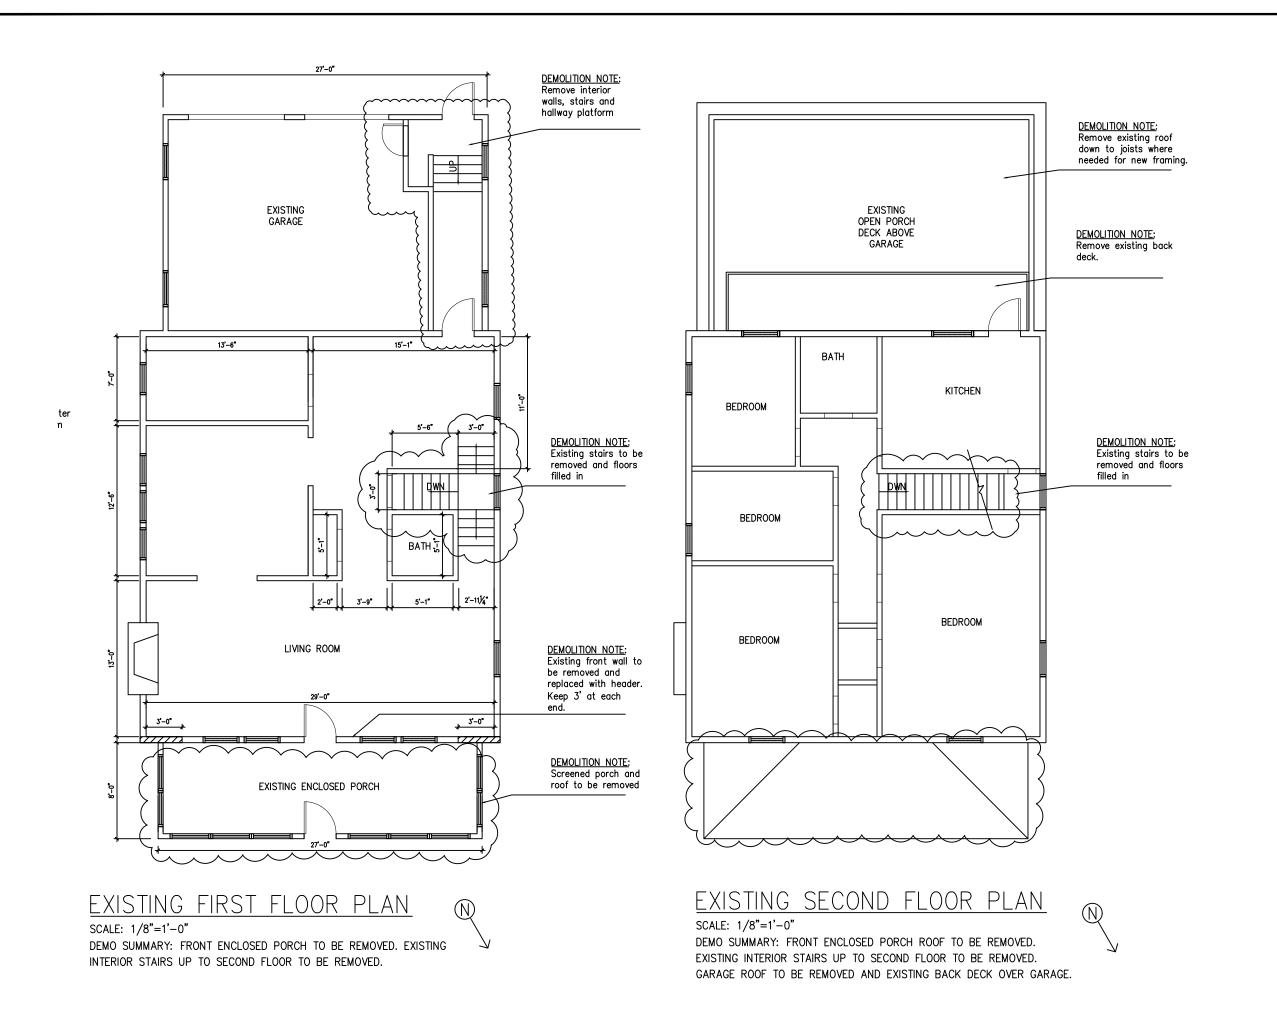
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EXISTING FLOOR LAYOUT AND DEMO NOTES

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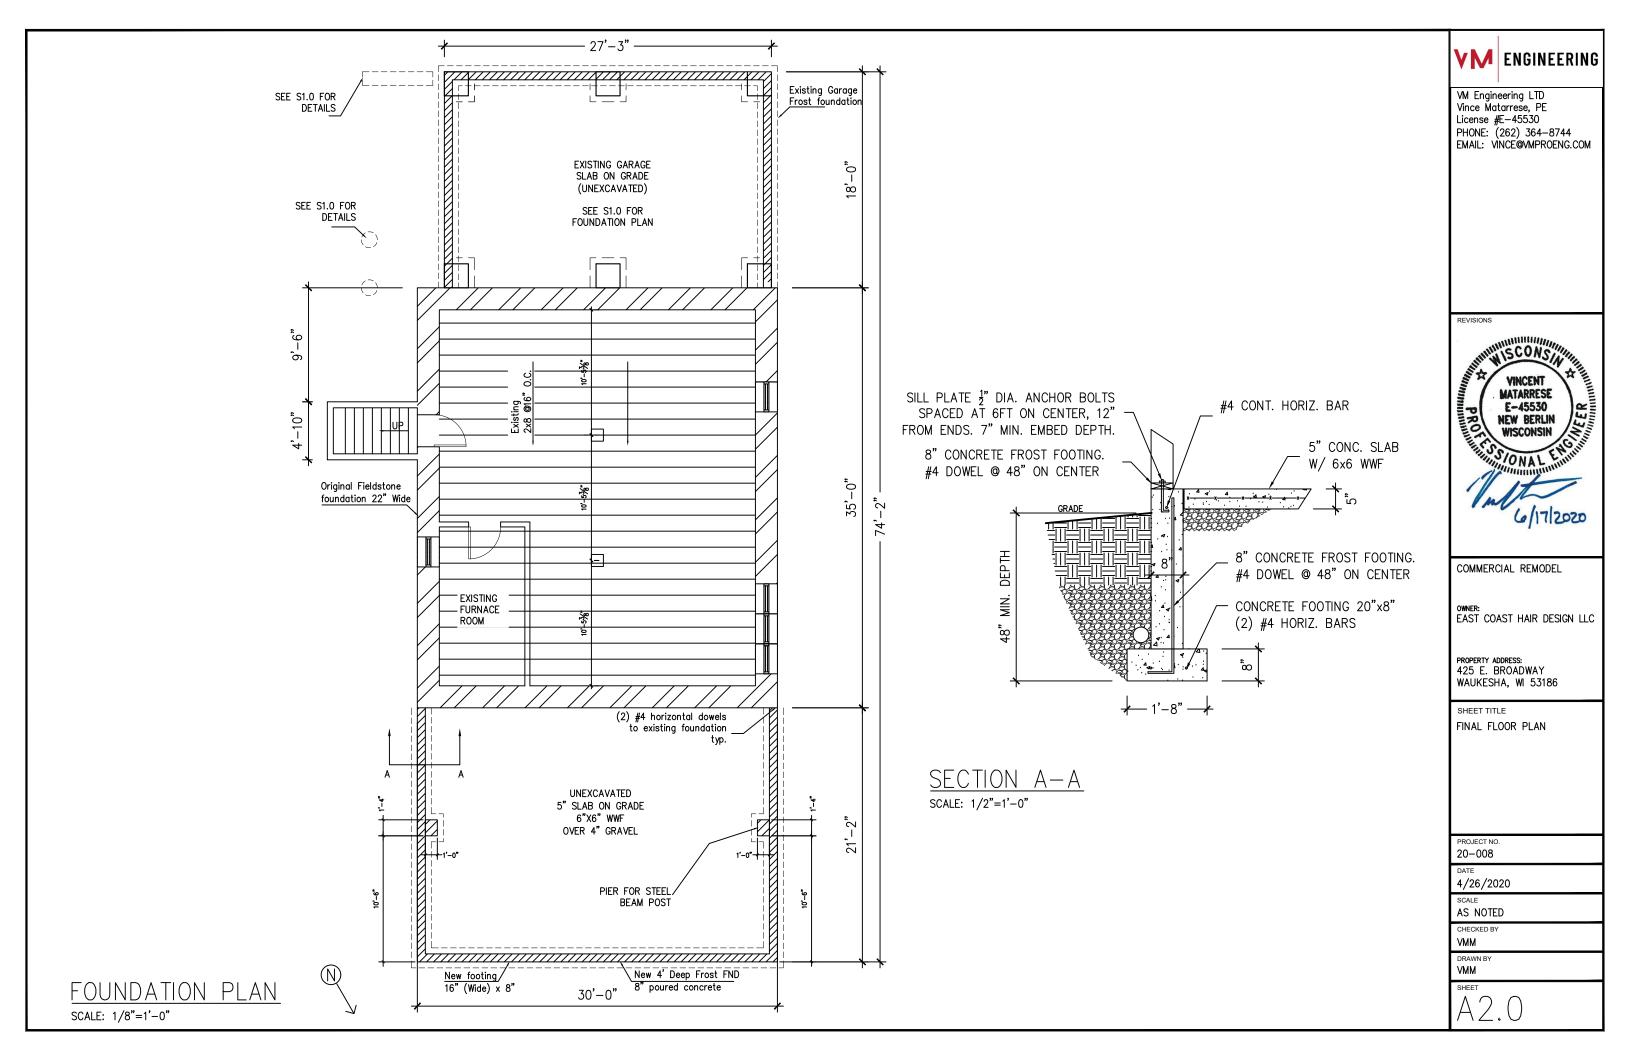
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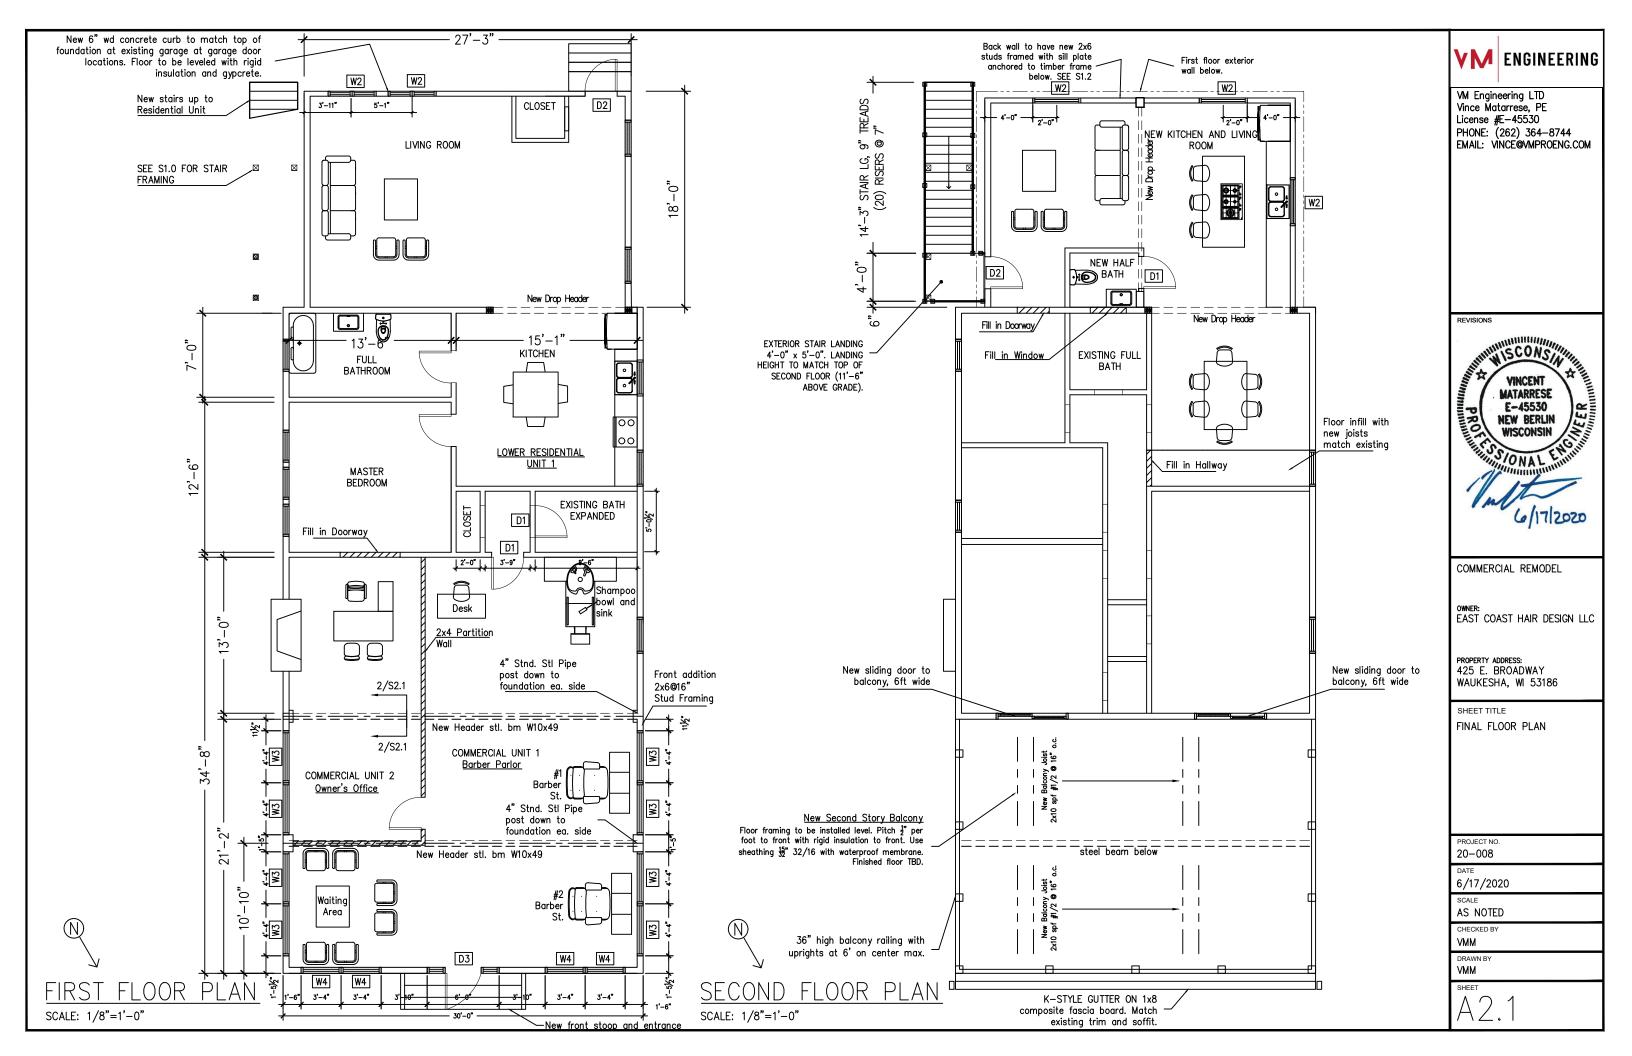
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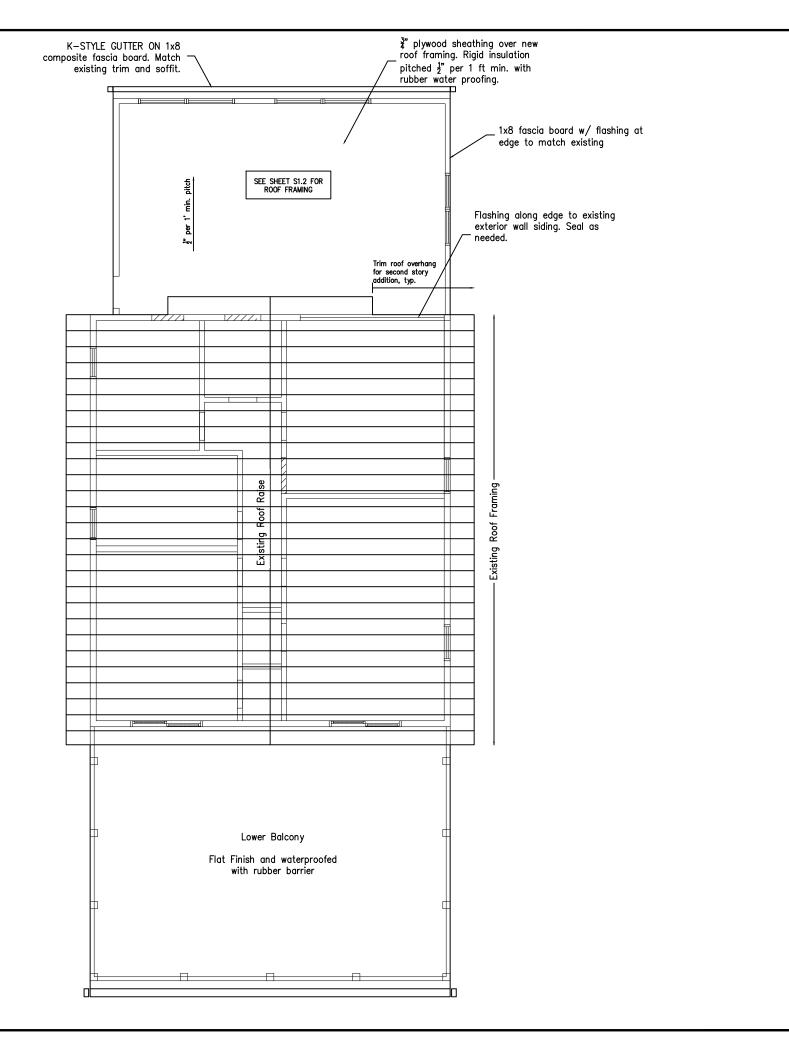
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SHEET









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COMMERCIAL REMODEL

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SHEET TITLE
FINAL ROOF PLAN

PROJECT NO. 20-008

4/26/2020

SCALE AS NOTED

CHECKED B

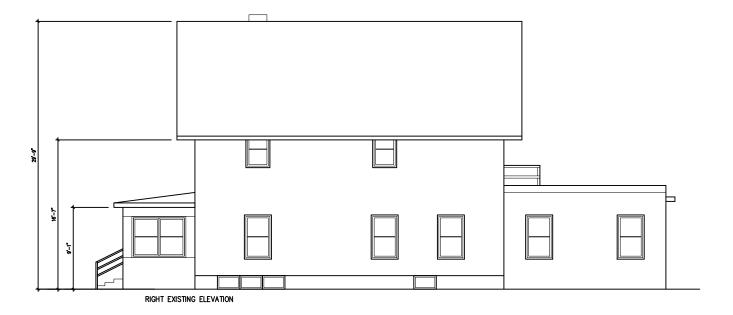
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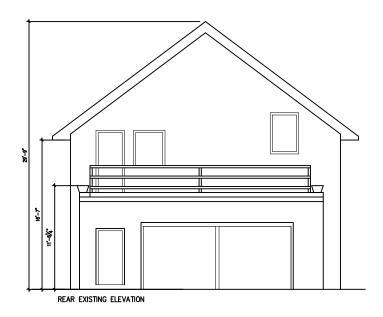
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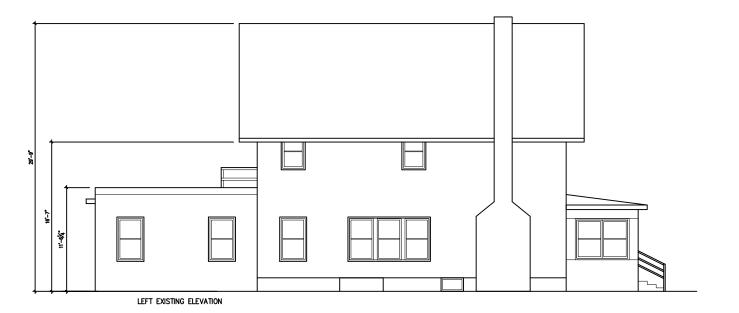
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**VM** ENGINEERING

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REVISIONS



COMMERCIAL REMODEL

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SHEET TITLE

EXISTING ELEVATIONS

PROJECT NO. 20-008

20-0

4/26/2020

SCALE AS NOTED

CHECKED BY

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**M** ET

A3.0

EXISTING ELEVATIONS

SCALE: 3/32"=1'-0"











REVISIONS



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SHEET TITLE
FINAL ELEVATIONS

PROJECT NO. 20-008

DATE

6/17/2020 SCALE

AS NOTED

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HEET

FINAL ELEVATIONS

SCALE: 3/32"=1'-0"



<u>FRONT VIEW - FINAL 3D RENDERINGS</u>

SCALE: N.T.S.



<u>REAR VIEW - FINAL 3D RENDERINGS</u>

SCALE: N.T.S.



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SHEET TITLE
FINAL RENDERINGS

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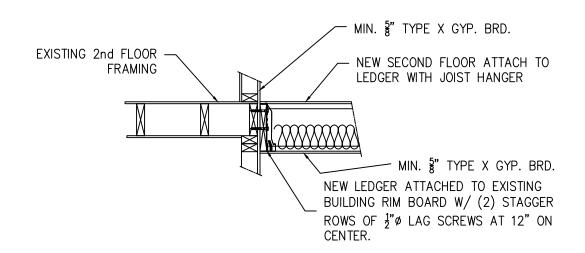
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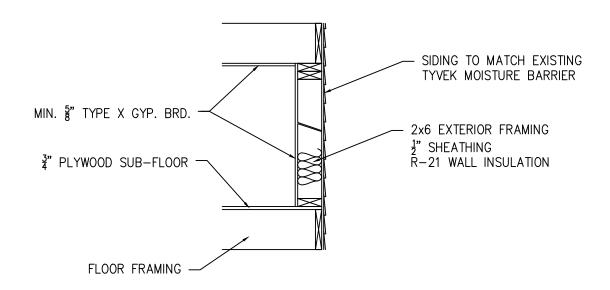
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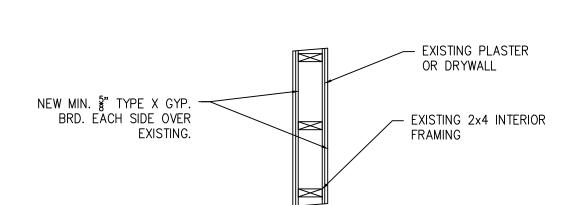
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1 ADDITION SECTION FLR FRAMING
A5.0 SCALE: 1/2"=1'-0"



2 NEW EXTERIOR WALL SECTION A5.0 SCALE: 1/2"=1'-0"



4 INTERIOR UNIT DIVIDING WALLS
A5.0 SCALE: 1/2"=1'-0"



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REVISIONS



COMMERCIAL REMODEL

OWNER: EAST COAST HAIR DESIGN LLC

PROPERTY ADDRESS: 425 E. BROADWAY WAUKESHA, WI 53186

SHEET TITLE
BUILDING SECTIONS
AND DETAILS

PROJECT NO. 20-008

DATE 6/17/2020

SCALE

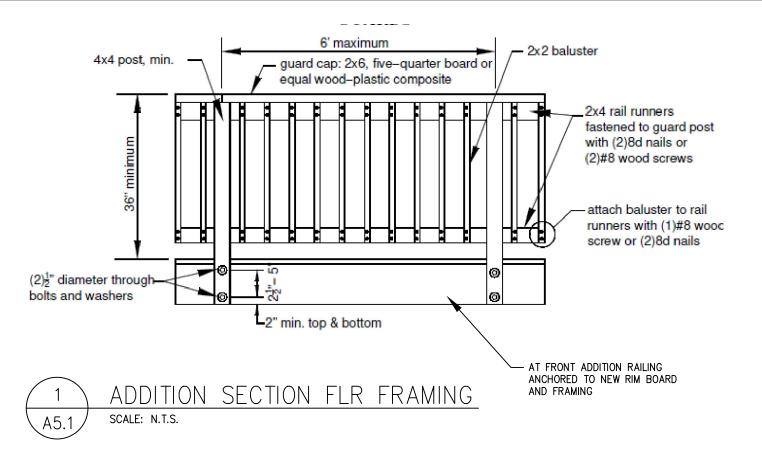
AS NOTED

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HEET

A5.0





REVISIONS



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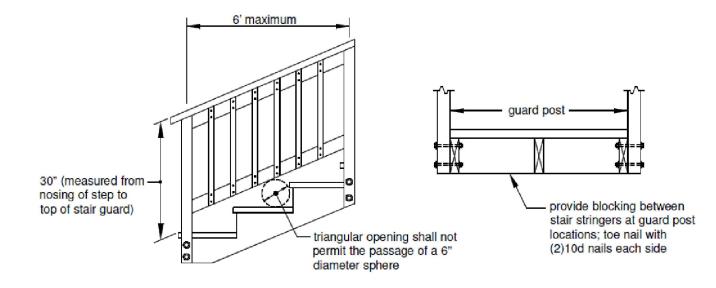
SCALE AS NOTED

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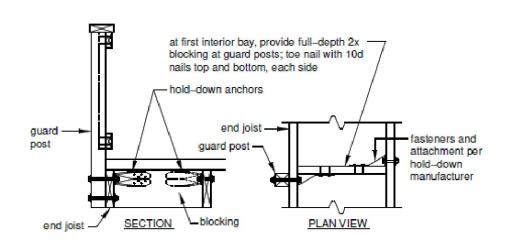
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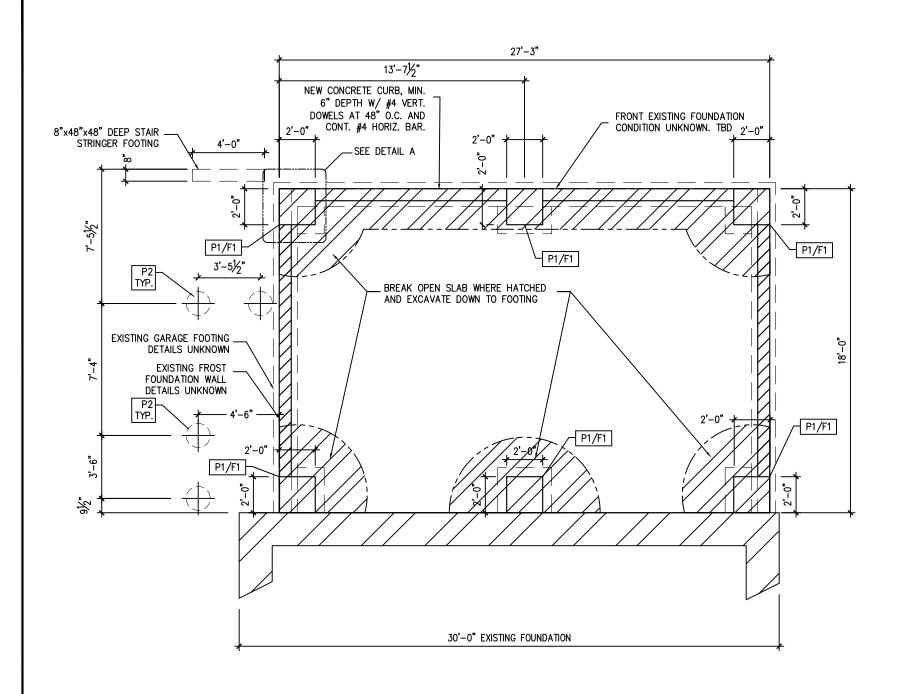
A5.1







2 GUARD POST TO END/RIM JOIST A5.1 SCALE: N.T.S.



## REAR FOUNDATION PLAN

SCALE: 3/16"=1'-0"

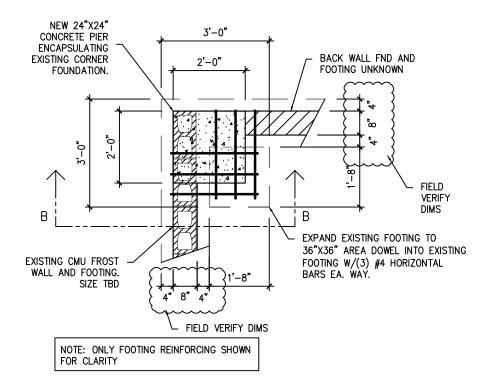
## PLAN NOTES:

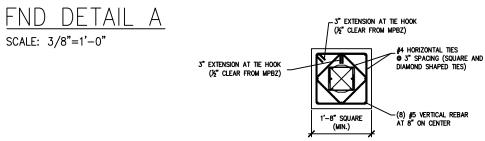
P1 - NEW CONCRETE PIER, 24"x24"x9" ABOVE EXISTING FOUNDATION, f'c=3,000psi, fs=60ksi

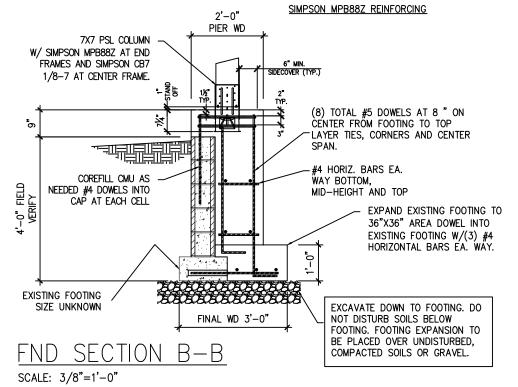
P2 - SONO TUBE PIER, 16" DIAMETER x 48" DEEP, f'c=3,000psi MIN.

F1 - NEW OR EXPANDED FOOTING, 36"x36"x12" MIN. 48" BELOW GRADE, f'c=3,000psi, fs=60ksi

• FRONT CURB TO ANCHORED TO EXISTING FOUNDATION WITH #4 DOWELS AT 48" ON CENTER AND (1) #4 HORIZONTAL CONTINUOUS BAR.









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SHEET TITLE

REAR FOUNDATION PLAN

PROJECT NO. 20-008

DATE

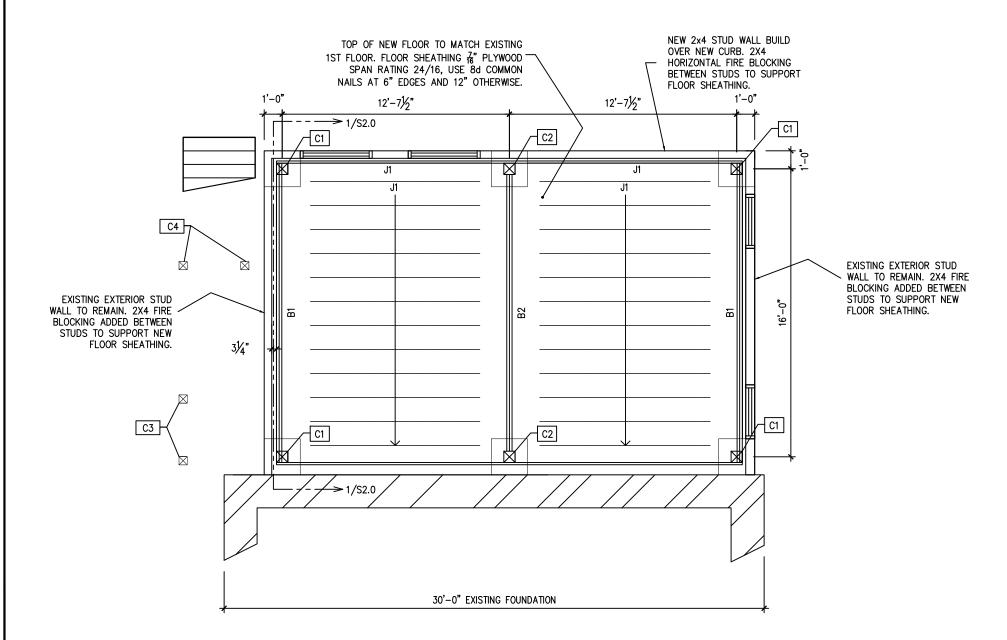
4/26/2020

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## GARAGE CONVERSION - 1ST FLOOR FRAMING PLAN

SCALE: 3/16"=1'-0" PLAN NOTES:

C1 - 7"x7" PARALLAM PSL 1.8E W/ SIMPSON MPB88Z BASE CONNECTION

C2 - 7"x7" PARALLAM PSL 1.8E W/ SIMPSON CB71-7 BASE CONNECTION

C3 - 6"x6" TIMBER COLUMN TREATED SYP #1 GRADE

C4 - 4"x4" TIMBER COLUMN TREATED SYP #1 GRADE

B1 - (2) 1.75"x11.25" 2.0E LVL, CONNECT TO COLUMNS W/SIMPSON HHUS48

B2 - (2) 1.75"x14" 2.0E LVL, CONNECT TO COLUMNS W/SIMPSON HGUS410

J1 - FLOOR JOISTS 2x10 @ 16" O.C. SPF #2 GRADE, ATTACH WITH JOIST HANGER

• EXISTING EXTERIOR STUD WALLS TO REMAIN. 2X FIRE BLOCKING TO BE ADDED BETWEEN STUDS TO SUPPORT NEW FLOOR SHEATHING.



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SHEET TITLE GARAGE CONVERSION 1ST FLOOR FRAMING PLAN

PROJECT NO. 20-008

02/20/20

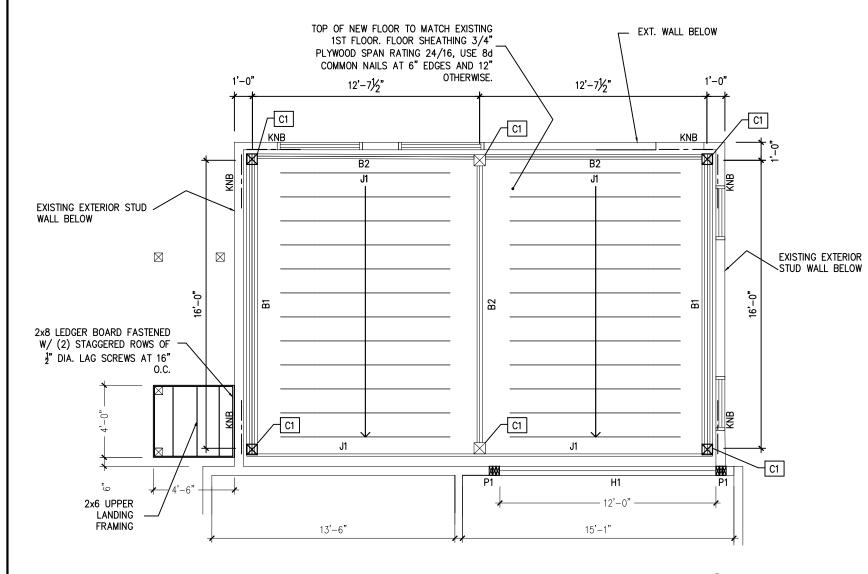
AS NOTED

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SHEET



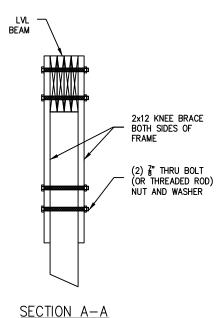
## REAR ADDITION - 2ND FLOOR FRAMING PLAN

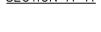
SCALE: 3/16"=1'-0"

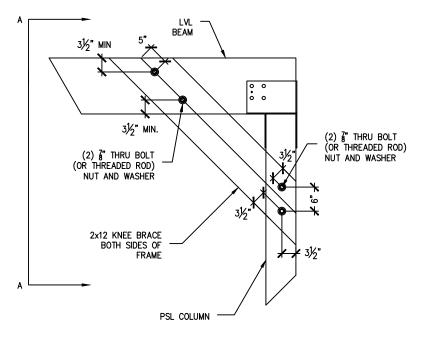
### PLAN NOTES:

C1 - 7"x7" PARALLAM PSL 1.8E

- H1 (2) 1.75"x9.25" 2.0E LVL
- P1 (3) 2x6 SHOULDER STUDS SPF #1/2
- B1 (4) 1.75"x14" 2.0E LVL, CONNECT TO COLUMNS W/SIMPSON SPECIAL ORDER ECC CAP
- B2 (2) 1.75"x14" 2.0E LVL, CONNECT TO COLUMNS W/SIMPSON SPECIAL ORDER ECC CAP
- KNB TIMBER FRAME KNEE BRACE 2x12 BOTH SIDES, SEE KNEE BRACE DETAIL
- J1 FLOOR JOISTS 2x10 @ 16" O.C. SPF #2 GRADE, ATTACH WITH JOIST HANGER
- EXISTING EXTERIOR STUD WALLS TO REMAIN. 2X FIRE BLOCKING TO BE ADDED BETWEEN STUDS TO SUPPORT NEW FLOOR SHEATHING.







FRAME KNEE BRACE DETAIL (KNB)



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SHEET TITLE REAR ADDITION 2ND FLOOR FRAMING PLAN

PROJECT NO.

20-008

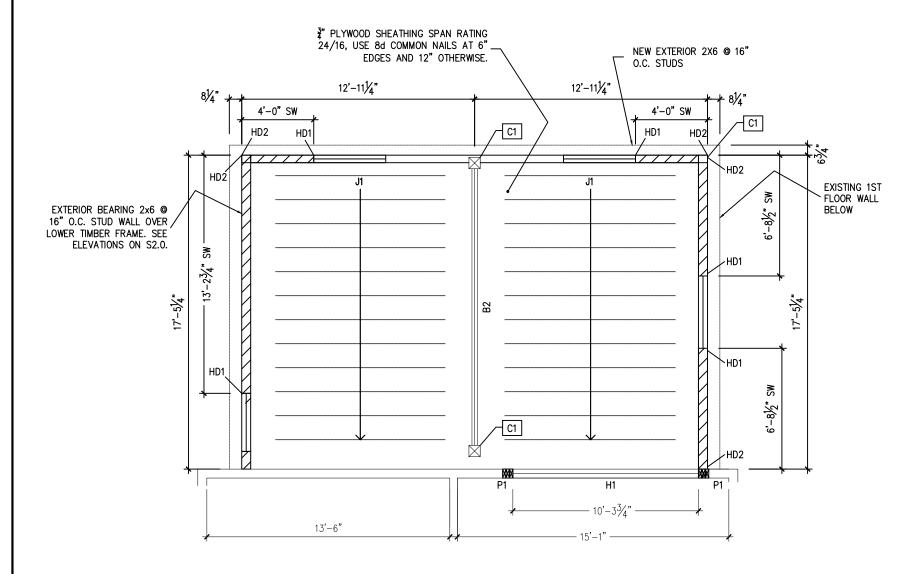
4/24/2020

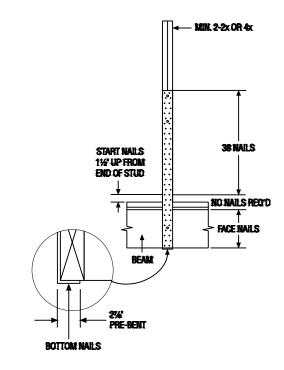
AS NOTED

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SIMPSON HD1 DETAIL SCALE: NTS

## REAR ADDITION - ROOF FRAMING PLAN

SCALE: 3/16"=1'-0"

## PLAN NOTES:

C1 7"x7" PARALLAM PSL 1.8E

H1 (2) 1.75"x9.25" 2.0E LVL

P1 (2) 2x6 SHOULDER STUDS SPF #1/2

B2 (2) 1.75"x14" 2.0E LVL, SEE CONNECTION DETAIL

J1 FLOOR JOISTS 2x10 @ 16" O.C. SPF  $\#^1_2$  GRADE, ATTACH WITH JOIST HANGER

SW - MIN.  $\frac{15}{32}$  STRUCT I SHEATHING, 10d NAILS AT 6" O.C. PANEL EDGES

HD1 USE SIMPSON STRAPS MSTC48B3 w/ (12) 0.148x3 NAILS TO BEAM FACE, (4) NAILS

TO BEAM BOTTOM AND (38) 0.148x3 NAILS TO STUDS.

HD2 USE SIMPSON STRAPS MSTC48 w/ (32) SINKER NAILS



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SHEET TITLE
REAR ADDITION
ROOF FRAMING PLAN

PROJECT NO. 20-008

20-0

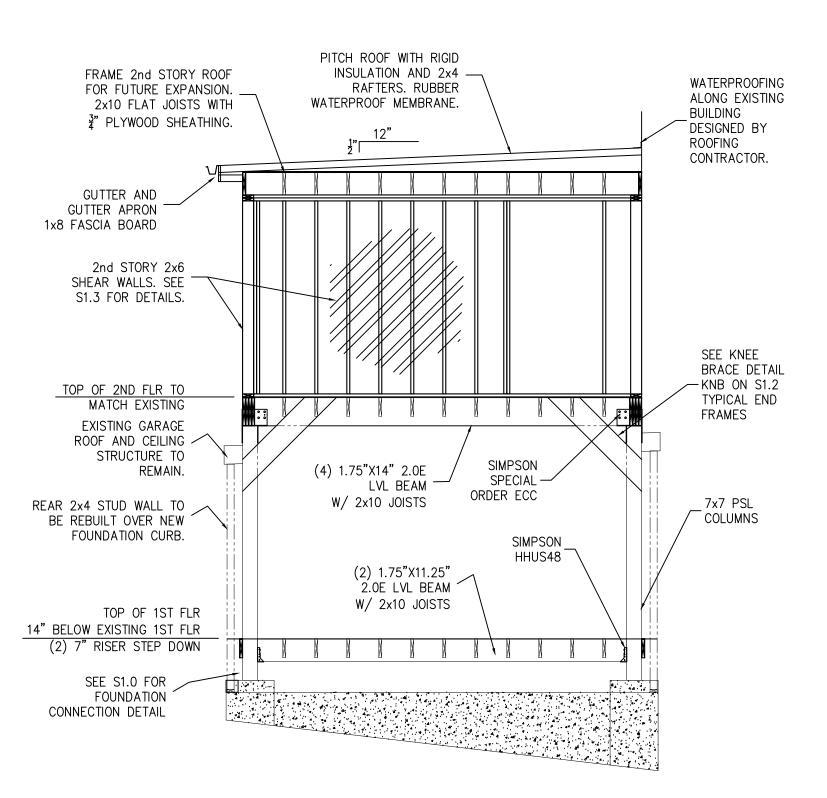
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1 REAR ADDITION ELEVATION
S2.0 SCALE: 1/4"=1'-0"

VM ENGINEERING

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SHEET TITLE
REAR ADDITION
ELEVATIONS

PROJECT NO. 20-008

DATE 4/26/2020

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SHEET TITLE
REAR ADDITION
ELEVATIONS

PROPERTY ADDRESS: 425 E. BROADWAY WAUKESHA, WI 53186

PROJECT NO. 20-008

DATE 4/26/2020

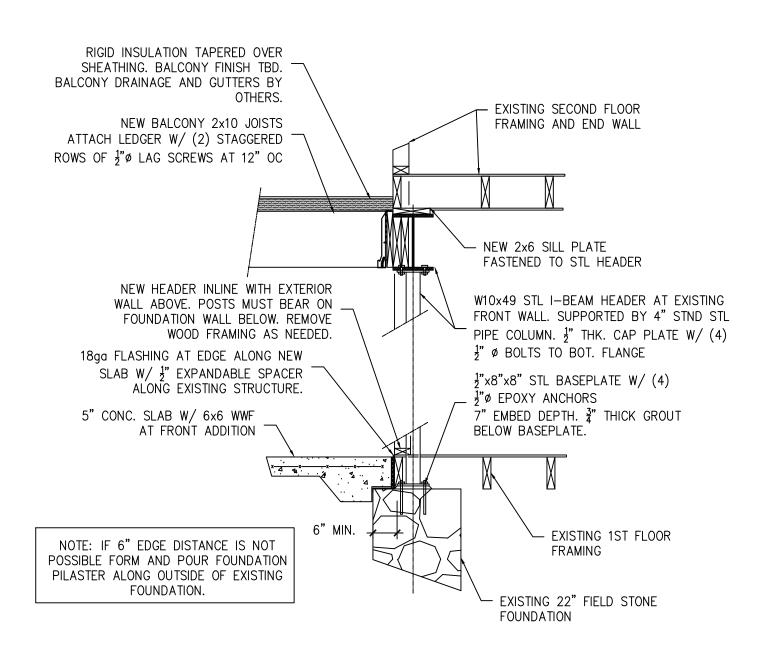
SCALE

AS NOTED

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FRONT STEEL BEAM

SCALE: NTS