





SERVING WAUKESHA SINCE

MAYOR

SHAWN N. REILLY

WATER UTILITY COMMISSION

JOSEPH J. PIATT JOAN FRANCOEUR ALDERMAN PETER BARTELS GERALD COURI TERRY THIEME PAUL YBARRA

COMMISSION PRESIDENT COMMISSION SECRETARY COMMISSIONER COMMISSIONER COMMISSIONER COMMISSIONER

WATER UTILITY GENERAL MANAGER

DAN DUCHNIAK, PE

WATER OPERATIONS MANAGER

KELLY ZYLSTRA, PE

TECHNICAL SERVICES MANAGER CHRIS WALTER, PE



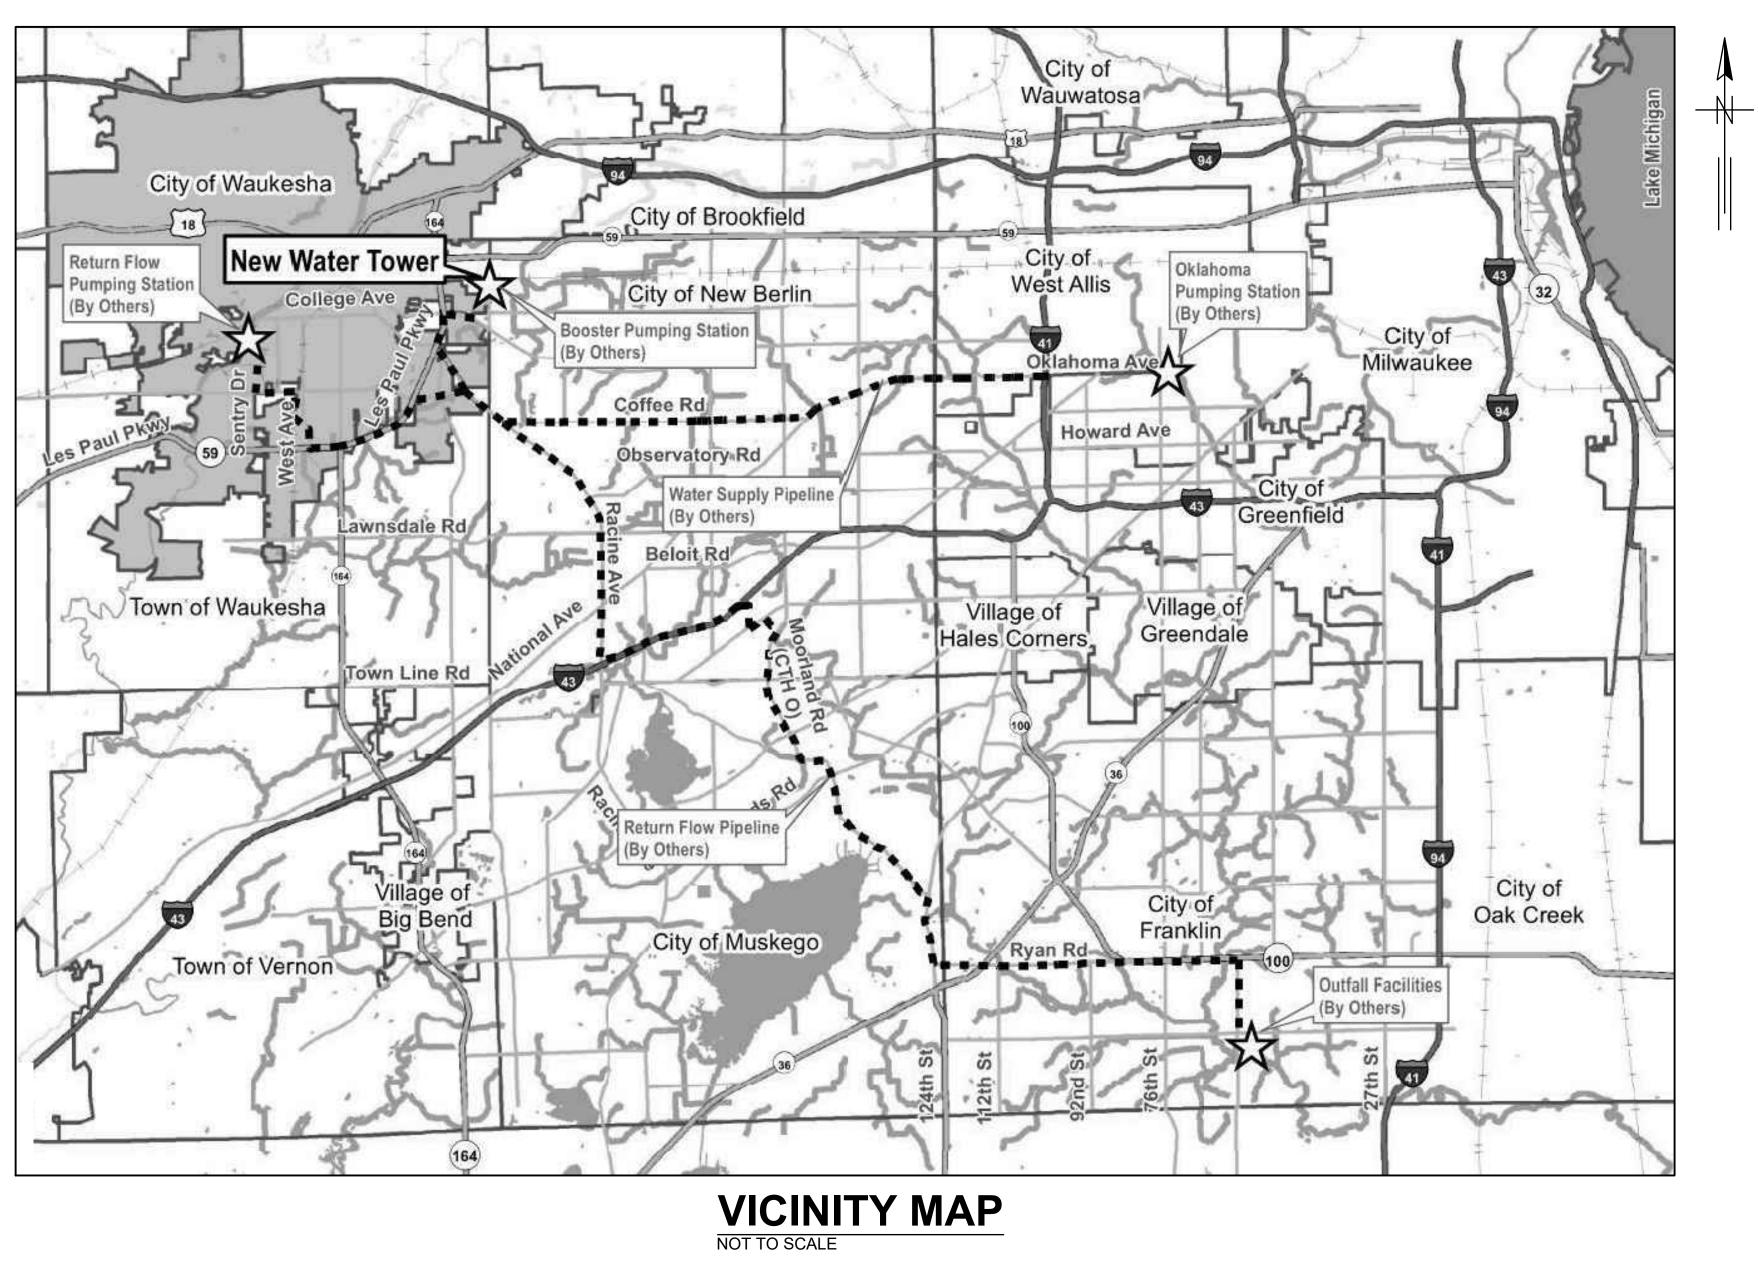
741 N. GRAND AVE, SUITE 308 WAUKESHA, WI 53186



DRAFT 95% PROGRESS DRAWINGS

WAUKESHA WATER UTILITY **GREAT LAKES WATER SUPPLY PROGRAM**

CONTRACT DRAWINGS: CONTRACT PACKAGE 3A WATER TOWER



SEPTEMBER 2020

ENGINEER SEALS AND SIGNATURES SHEET 1 OF 1



THE DRAWINGS LISTED AND BOUND HEREIN ARE PART OF THE CONTRACT FOR:

WAUKESHA WATER UTILITY **GREAT LAKES WATER SUPPLY PROGRAM CONTRACT PACKAGE 3A**

WATER TOWER

SEPTEMBER 2020

THOMAS H. POWELL E-44446-6 CHICAGO L EXP DATE: 07/31/22	
Thomas It Powell 09/18/20	
SIGNATURE: DATE:	
ASSOCIATE	
TITLE:	
GREELEY AND HANSEN LLC	
FIRM:	
DRAWING LIST: N1	

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SHEET NUMBER	DRAWING NUMBER	DESCRIPTION
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ELECTRICAL 8	E1	ELECTRICAL AND MECHANICAL PLANS AND SCHEDULES
INSTRUMENT 9	ATION N1	WATER TOWER - P&ID

ABBREVIATIONS

AIT	ANALYZER INDICATOR TRANSMITTER
AN	PHASE A TO NEUTRAL
BN	PHASE B TO NEUTRAL
BPS	BOOSTER PUMP STATION
CL EL	CENTERLINE ELEVATION
CN	PHASE C TO NEUTRAL
СР	CONTRACT PACKAGE
DN	DOWN
EUH	ELECTRIC UNIT HEATER
FD	FLOOR DRAIN
FFE	FINISH FLOOR ELEVATION
HWL	HIGH WATER LEVEL
I & C	INSTRUMENTATION AND CONTROL
INV EL	INVERT ELEVATION
LF	LINEAR FOOT
LWL	LOW WATER LEVEL
NO	DWG NUMBER
PLC	PREVENTATIVE LOGIC CONTROL
SF	SILT FENCE
CITY OF WAU	KESHA NOTES:

CITY OF WAUKESHA NOTES:

ALL SITE IMPROVEMENTS AND CONSTRUCTION SHOWN ON THE DRAWINGS SHALL CONFORM TO THE CURRENT CITY OF WAUKESHA DESIGN AND CONSTRUCTION MANUAL. WHERE THE DRAWINGS DO NOT COMPLY, IT SHALL BE THE SOLE RESPONSIBILITY AND EXPENSE OF THE CONTRACTOR TO MAKE REVISIONS TO THE DRAWINGS AND/OR CONSTRUCTED INFRASTRUCTURE TO COMPLY.

DRAFT 95% PROGRESS DRAWINGS SEPTEMBER 2020

GENERAL NOTES:

- OF THE ENGINEER.
- CUT OR SHOWN OR THE DETAIL IS SHOWN.
- FACILITIES.
- SCALES.
- PREPARATION OF THESE DRAWINGS.

- OF THE CONTRACT DOCUMENTS.
- FOR SUCH COMPLIANCE.

- MAINTAIN PUMPING EQUIPMENT AS NEEDED.

1. THE ENGINEER ASSUMES NO RESPONSIBILITY FOR DAMAGES, LIABILITY, OR COSTS RESULTING FROM CHANGES OR ALTERATIONS MADE TO THESE DRAWINGS WITHOUT THE WRITTEN CONSENT

2. THE INFORMATION PROVIDED IN THESE DRAWINGS PERTAINING TO EXISTING CONDITIONS IS SOLELY TO ASSIST THE CONTRACTOR IN ASSESSING THE NATURE AND EXTENT OF THE CONDITIONS, WHICH MAY BE ENCOUNTERED DURING THE COURSE OF WORK. CONTRACTORS ARE DIRECTED, PRIOR TO BIDDING, TO CONDUCT WHATEVER INVESTIGATIONS THEY MAY DEEM NECESSARY TO ARRIVE AT THEIR OWN CONCLUSIONS REGARDING THE ACTUAL CONDITIONS THAT WILL BE ENCOUNTERED, AND UPON WHICH THEIR BIDS WILL BE BASED.

3. SECTIONS AND DETAILS ARE IDENTIFIED WITH A FRACTION. THE NUMERATOR IS THE SECTION OR DETAIL NUMBER AND THE DENOMINATOR IS THE DRAWING NUMBER ON WHICH THE SECTION IS

4. NEW WORK IS SHOWN USING HEAVIER LINES THAN THOSE USED FOR EXISTING CONDITIONS AND

5. THESE DRAWINGS MAY BE REDUCED IN SIZE FROM THE ORIGINALS. USE ONLY THE GRAPHIC

6. THE HORIZONTAL DATUM IS NORTH AMERICAN DATUM OF 1927 (NAD27) WISCONSIN STATE PLANE COORDINATE SYSTEM, SOUTH ZONE, IN U.S. SURVEY FEET. THE VERTICAL DATUM IS NATIONAL GEODETIC VERTICAL DATUM OF 1929 (NGVD29).

7. THE SURVEYS WERE TAKEN BETWEEN JANUARY 2020 TO JUNE 2020 AND UTILIZED IN THE

8. IMMEDIATELY NOTIFY THE RESIDENT PROJECT REPRESENTATIVE WHEN CONFLICTS BETWEEN THESE DRAWINGS AND ACTUAL CONDITIONS ARE DISCOVERED.

9. WHERE CONTOURS ARE NOT SHOWN ON PLAN, INVESTIGATE GRADE SURROUNDING WORK SITE PRIOR TO BIDDING. APPROXIMATE GRADE ABOVE PIPES SHOWN ON PROFILES REPRESENTS THE TOP OF PAVEMENT. GRAVEL. OR LANDSCAPED AREAS ABOVE THE CENTERLINE OF THE PIPE.

10. THE CONTRACTOR IS RESPONSIBLE TO FABRICATE, ERECT, CONSTRUCT, AND OTHERWISE INSTALL ALL NEW WORK CONNECTING TO EXISTING WORK AND MAKE ALL NECESSARY RELOCATIONS TO THE ARRANGEMENTS AND GENERAL DESIGN SHOWN. THE CONTRACTOR IS ALSO RESPONSIBLE TO MAKE ANY ADJUSTMENTS IN FABRICATION, ERECTION, CONSTRUCTION, AND INSTALLATION NECESSARY TO FIT NEW WORK AND RELOCATIONS TO EXISTING CONDITIONS TO CONFORM TO THE ARRANGEMENTS AND GENERAL DESIGN SHOWN. ADJUSTMENTS PROPOSED OR CONTEMPLATED BY THE CONTRACTOR SHALL CONFORM TO REQUIREMENTS AND STANDARDS

11. ALL SHOP AND WORKING DRAWING SUBMITTALS SHALL BE PREPARED BY THE CONTRACTOR TO INCORPORATE ALL REQUIREMENTS AND RESPONSIBILITIES OF THESE GENERAL NOTES.

12. IN COMPLYING WITH ALL RESPONSIBILITIES AND REQUIREMENTS UNDER THESE GENERAL NOTES, THE CONTRACTOR SHALL PROVIDE ALL DESIGNS, LABOR, EQUIPMENT, AND SERVICES NEEDED

13. ALL COSTS ASSOCIATED WITH COMPLIANCE WITH THESE GENERAL NOTES SHALL BE INCLUDED IN THE VARIOUS CONTRACT ITEMS AND NO SEPARATE PAYMENT WILL BE MADE THEREFORE.

14. THESE DRAWINGS DO NOT CONSTITUTE AN EROSION CONTROL PLAN. PROVIDE AN EROSION CONTROL PLAN IN ACCORDANCE WITH EACH AUTHORITY HAVING JURISDICTION AND THE WISCONSIN DEPARTMENT OF NATURAL RESOURCES.

15. THESE DRAWINGS DO NOT CONSTITUTE A STORMWATER MANAGEMENT PLAN. CONTRACTOR TO PROVIDE FOR THE DRAINAGE OF STORMWATER, WATER APPLIED, OR WATER DISCHARGED IN PERFORMANCE OF THE WORK. PROVIDE ADEQUATE DRAINAGE FACILITIES TO PREVENT DAMAGE TO THE WORK, THE SITE, AND ADJACENT PROPERTY, SUPPLEMENT EXISTING DRAINAGE CHANNELS, CONDUITS AND DIKES AS NECESSARY TO DIVERT AND CARRY THE EXISTING RUNOFF AND THE INCREASED RUNOFF DUE TO THE WORK. PROVIDE PONDING AS NECESSARY TO PREVENT DOWNSTREAM FLOODING. MAINTAIN EXCAVATION FREE OF WATER. PROVIDE, OPERATE, AND

16. SURVEY AND MARK WETLAND LIMITS CLEARLY PRIOR TO WORK IN THE AREA AND MAINTAIN WETLAND LIMIT MARKINGS UNTIL FINAL ACCEPTANCE OF RESTORATION. AFTER CONSTRUCTION. PLACE WETLAND RESTORATION SIGNS AT THE WETLAND BOUNDARIES. LOCATE DISCHARGE FROM DEWATERING OPERATIONS MORE THAN 100 FEET FROM WETLANDS, PREVENT SEDIMENTATION FROM ACCUMULATING WITHIN THE WETLAND, AND PREVENT EROSION DAMAGE TO THE WETLAND.

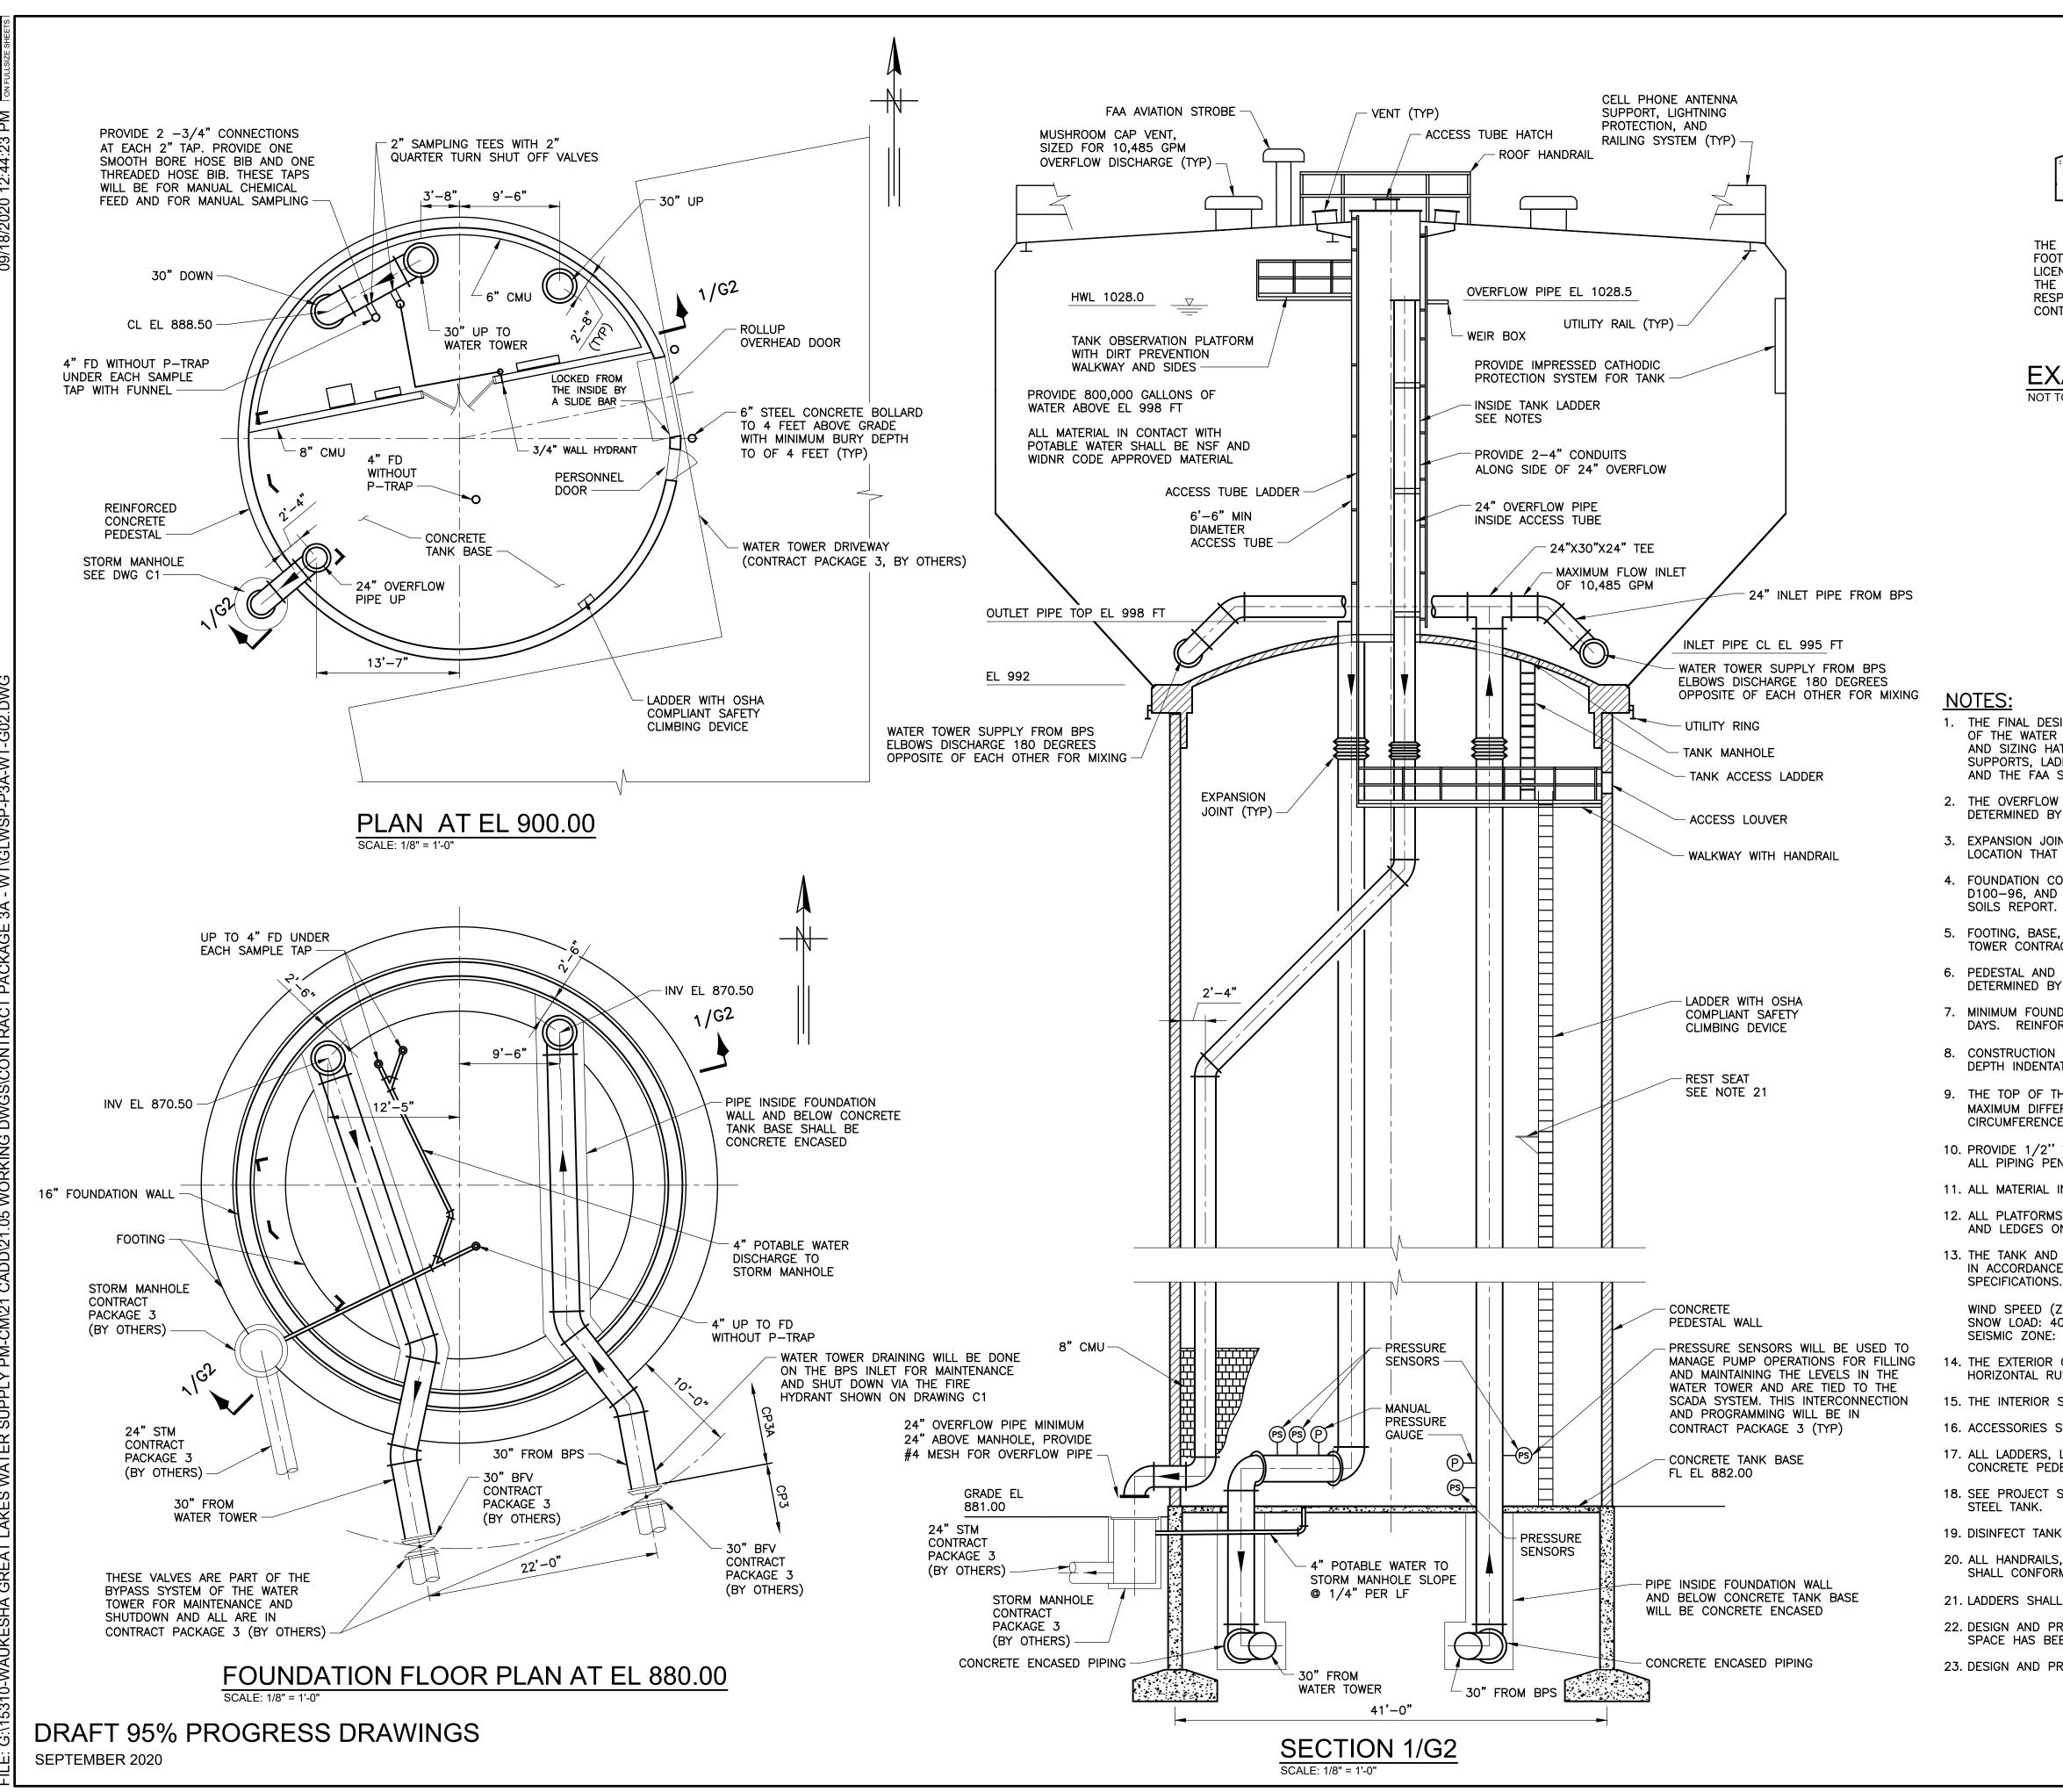
17. CALL DIGGERS HOTLINE AT (811) OR (800) 242-8511 THREE WORKING DAYS IN ADVANCE OF WORK TO OBTAIN THE LOCATION OF EXISTING UNDERGROUND UTILITIES. PROVIDE THREE WORKING DAYS NOTICE PRIOR TO THE START OF WORK IN THOSE AREAS TO A DESIGNATED LOCATING SERVICE, UTILITIES, GOVERNMENTAL AGENCIES, AND OTHERS REASONABLY ASSUMED TO HAVE ABOVE AND BELOW GROUND UTILITIES WITHIN THE LIMITS OF CONSTRUCTION. EXCAVATION WORK SHALL NOT COMMENCE IN ANY AREA WHERE UNDERGROUND UTILITIES HAVE NOT BEEN LOCATED.

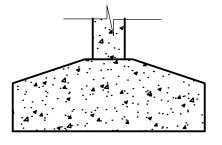
18. LOCATIONS, ELEVATIONS, AND DIMENSIONS OF EXISTING UTILITIES ARE SHOWN ACCORDING TO THE BEST INFORMATION AVAILABLE AT THE TIME OF PREPARATION OF THESE DRAWINGS. NOT ALL ELEVATIONS OF UTILITIES SHOWN IN THE PROFILE HAVE BEEN ESTABLISHED FROM ACTUAL FIELD CONDITIONS OR AS-BUILT INFORMATION. UTILITIES SUCH AS UNDERGROUND FIBER OPTIC, CABLE, TELEPHONE, ELECTRIC, PRIVATE WATER LATERALS, AND PRIVATE GAS LATERALS ARE SHOWN ONLY IN THE PLAN, DO NOT HAVE SIZES IDENTIFIED, AND ARE NOT SHOWN IN THE PROFILE. PRIVATE SANITARY LATERALS HAVE NOT BEEN LOCATED AND ARE NOT IDENTIFIED ON THE PLAN OR PROFILE. WHEN WORKING IN AN AREA WHERE EXISTING UTILITIES ARE ANTICIPATED, PROTECT EXISTING UTILITIES AND PROVIDE PROPER AND ADEQUATE SUPPORT DURING CONSTRUCTION TO AVOID DAMAGE OR BREAKAGE. REMOVE, REPLACE, RELOCATE, REPAIR, AND/OR SECURE ANY UTILITY OR STRUCTURE DAMAGED AS A DIRECT OR INDIRECT RESULT OF THE WORK AT NO ADDITIONAL COST TO THE OWNER. WHEN RELOCATING UTILITIES, GRAVITY UTILITIES TAKE PRECEDENT OVER PRESSURIZED UTILITIES.

- 19. EXCAVATE TRENCHES IN CONFORMITY WITH THE REQUIRE ON THESE DRAWINGS. FIELD CONDITIONS MAY NECESSITA DEVIATION FROM THE DESIGN TO AVOID OBSTACLES. MAKE ADJUSTMENTS TO THE PIPES, AS REQUIRED, TO ACCOMMO ADJUSTMENTS SHALL BE APPROVED BY THE RESIDENT PR INCIDENTAL TO THE CONTRACT PRICE. INSTALL NEW PIPE ON THESE DRAWINGS WITH NO INTERMEDIATE HIGH OR LC OF INFLECTION. ACCURATELY ANNOTATE FIELD ADJUSTME
- 20. PROVIDE SHEETING, SHORING, AND BRACING NEEDED TO PROPERTY, UTILITIES, PAVEMENT, ETC., AND PROVIDE SAF ACCORDANCE WITH OCCUPATIONAL SAFETY AND HEALTH .
- 21. LIMIT JOINT DEFLECTIONS FOR RESTRAINED JOINT DUCTIL MAXIMUM DEFLECTIONS PUBLISHED BY THE PIPE MANUFAC NON-RESTRAINED JOINT DUCTILE IRON PIPE SHALL BE LIMI RECOMMENDED MAXIMUM DEFLECTIONS PUBLISHED BY TH
- 22. RESTORE ROUGH GRADING TO ALLOW FINAL GRADING, PA BE DONE BY OTHERS. RESTORE ALL GRADE ABOVE PIPE AN GRADE, PROVIDE TOE OF SLOPE, CUTS, AND TOP EDGE OF PROVIDE POSITIVE DRAINAGE OF ROUGH GRADING AWAY OPEN DRAINAGE DITCH OR OTHER STORM SEWER CONVE
- 23. AT THE SITE KEEP AND MAINTAIN ONE RECORD COPY OF A REFERENCE DOCUMENTS, AND ALL TECHNICAL DOCUMEN DRAFTING SYMBOLS AND STANDARDS CONSISTENT WITH CONTRACT DRAWINGS TO SHOW ALL CHANGES MADE DUR ANNOTATED DRAWINGS WITH CURRENT FIELD CHANGES A RESIDENT PROJECT REPRESENTATIVE AND ENGINEER FOR COMPLETION OF THE CONTRACT AND BEFORE FINAL PAYM RESIDENT PROJECT REPRESENTATIVE AND ENGINEER ONI REPRODUCIBLE CONTRACT DRAWINGS REFLECTING CHAN
- 24. AN ASTERISK (*) AT NEW CONSTRUCTION DENOTES LOCAT OTHER INFORMATION DEPENDENT ON THE CONTRACTOR'S INFORMATION MARKED WITH AN ASTERISK (*) ON SUBMITT INFORMATION FOR ALL ASTERISKS (*) WITHIN OR INTERFAC BETWEEN SUBMITTALS. THIS REQUIREMENT ALSO EXTEND WHERE A LOCATION, DIMENSION, ELEVATION, OR OTHER I AFTER FINAL SELECTION OF EQUIPMENT AND/OR APPURTE ASTERISK (*) AND EQUIPMENT/APPURTENANCES SITUATION RESPONSIBILITY OF THE CONTRACTOR TO DEVELOP AND A COMPLETE, COORDINATED, AND TROUBLE-FREE OPERA
- 25. CONTRACTOR SHALL BE RESPONSIBLE FOR COORDINATING SITE SPECIFIC PERMITS WITH THE STATE OR LOCAL REGUL

ED ALIGNMENT AND PROFILE AS SHOWN ATE SLIGHT ALIGNMENT AND GRADE KE HORIZONTAL AND VERTICAL MODATE FIELD CONDITIONS. ROJECT REPRESENTATIVE AND ARE TO THE ELEVATION AND SLOPES SHOWN OW POINTS BETWEEN VERTICAL POINTS IENTS ON THE RECORD DRAWINGS.		REVISION
FE WORKING CONDITIONS IN HADMINISTRATION REQUIREMENTS. LE IRON PIPE TO THE RECOMMENDED ACTURER. JOINT DEFLECTIONS FOR MITED TO ONE DEGREE LESS THAN THE THE PIPE MANUFACTURER.		APPD
PAVEMENT, SEEDING WORK WHICH WILL AND IN DISTURBED AREA TO PREEXISTING OF BACKSLOPES OF ROUGH GRADING TO Y FROM STRUCTURE AND TOWARD AN EYANCE SYSTEM.		NO. DATE
ALL THE CONTRACT DOCUMENTS, NTS SUBMITTED IN GOOD ORDER. USING THE ORIGINAL DOCUMENTS, ANNOTATE RING THE CONSTRUCTION PERIOD. ARE TO BE MADE AVAILABLE TO THE OR REFERENCE AT ALL TIMES. AT MENT IS MADE, DELIVER TO THE JE SET OF CLEARLY READABLE, NGES MADE DURING CONSTRUCTION. TIONS, ELEVATIONS, DIMENSIONS, AND 'S SUBMITTALS. DEVELOP AND SHOW THE	A Waukesha Water Utility	GREELEY AND HANSEN 741 N. GRAND AVE, SUITE 308 WAUKESHA, WI 53186
TALS AND DEVELOP AND PROVIDE SUCH ACING WITH ANY SUBMITTALS AND DS TO CONDITIONS OR SITUATIONS ITEM IS INDICATED TO BE DETERMINED TENANCES. ALL INFORMATION FOR DNS DESCRIBED HEREIN ARE THE ASSURE COMPATIBLE INTERFACING FOR	۲ ۲	
ATING INSTALLATION. NG, OBTAINING, AND MAINTAINING ALL JLATORY AGENCY.	GREAT WATE	CT PACKAGE 3A: WATER TOWER ABBREVIATIONS AND GENERAL NOTES
	APPROVED	CONTRACT PACKAGE INDEX, ABBREVIA
	SEAL AFFIXED MONTH / DAY /	YEAR
	JOB NO.: 15310 DESGN GJ APPRV AJM SCALE:	BER 2020 CHCK CRV DRWN TK AS SHOWN G NUMBER
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THE DESIGN AND DIMENSIONS OF FOOTING WILL BE DESIGNED BY A LICENSED PROFESSIONAL ENGINEER IN THE STATE OF WISCONSIN AND IS THE RESPONSIBILITY OF THE WATER TOWER CONTRACTOR

EXAMPLE FOOTING SECTION

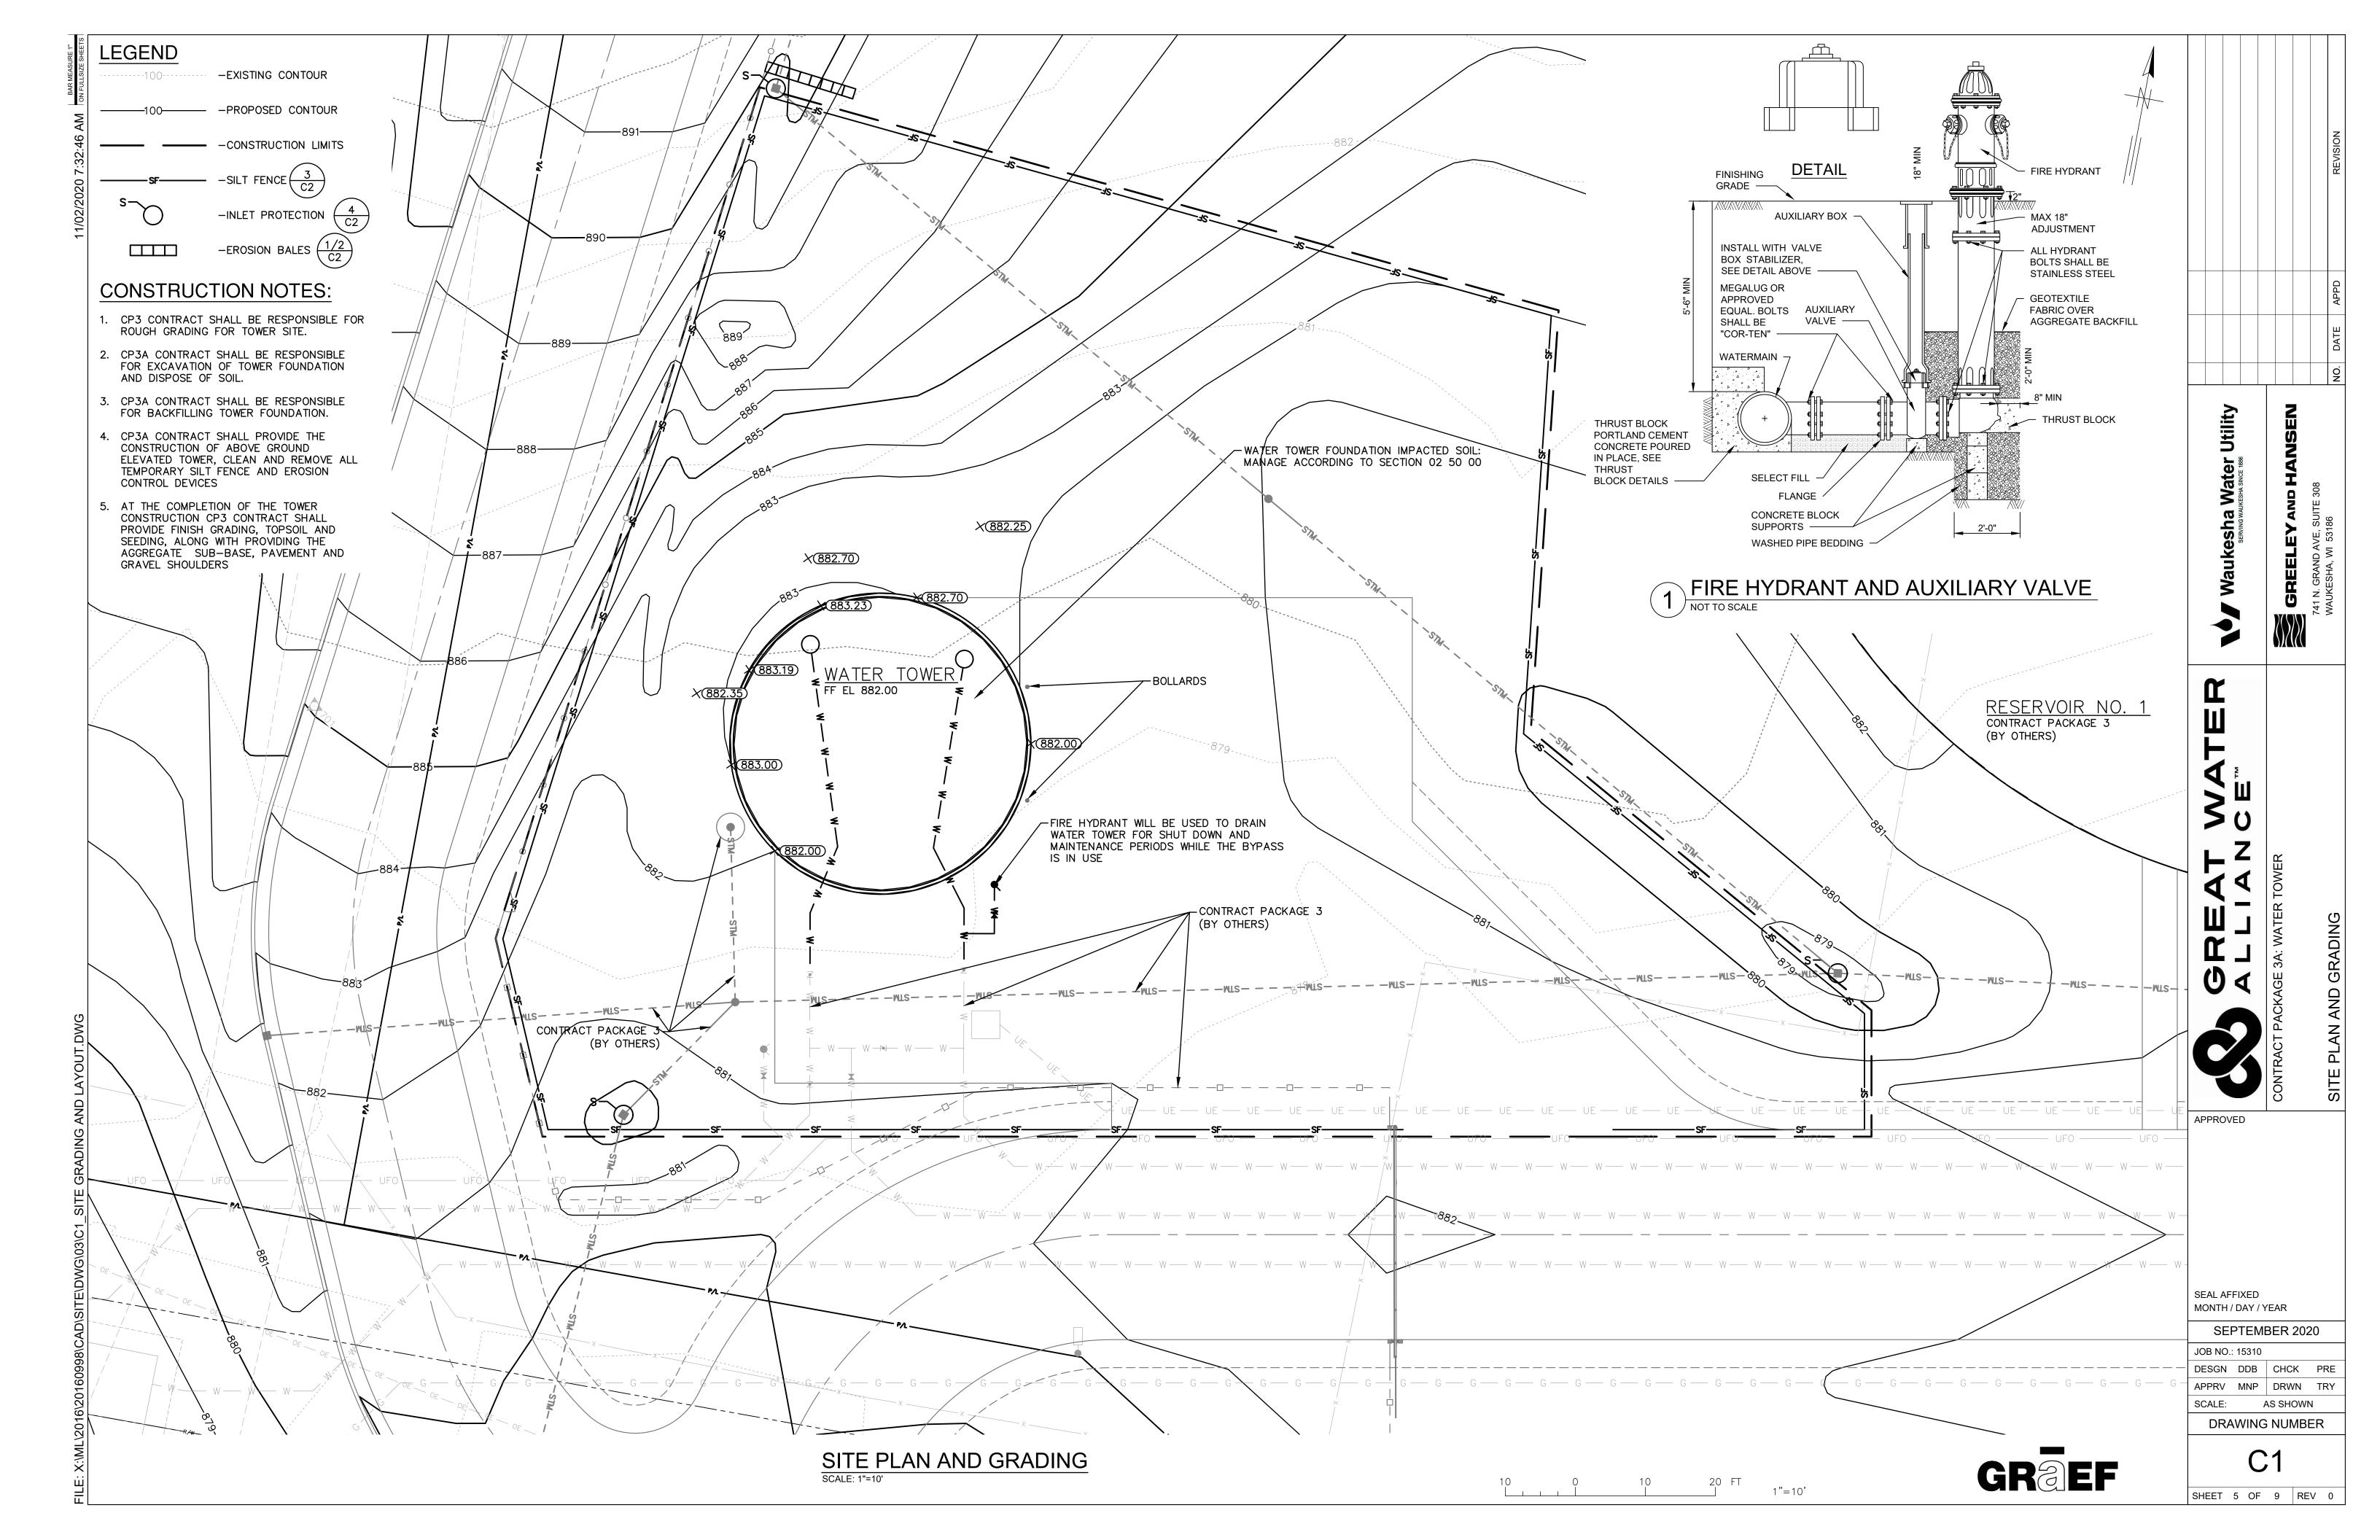
NOTES: 1. THE FINAL DESIGN OF ALL ASPECTS OF THE WORK SHOWN HERE IS THE RESPONSIBILITY

- OF THE WATER TOWER CONTRACTOR INCLUDING FREEZE PROOF VENT SIZING, LOCATING AND SIZING HATCHES AND VENTS, LOCATING AND SIZING THE ANTENNA AND RAIL SUPPORTS, LADDERS AND REST PLATFORMS, CODE COMPLIANT OBSERVATION PLATFORMS AND THE FAA STROBE SIGNAL.
- 2. THE OVERFLOW PIPE WILL BE INSIDE OF THE ACCESS TUBE, FINAL DIMENSIONS WILL BE DETERMINED BY THE WATER TOWER CONTRACTOR.
- 3. EXPANSION JOINTS WILL BE PROVIDED BY THE WATER TOWER CONTRACTOR IN A LOCATION THAT IS ACCESSIBLE FOR INSPECTION, REPLACEMENT AND REPAIR.
- 4. FOUNDATION CONSTRUCTION SHALL COMPLY WITH A.C.I. 318–99, A.C.I. 301–96, AWWA D100–96, AND APPLICABLE SECTIONS OF THE CONTRACT SPECIFICATIONS AND THE SOILS REPORT. GEOTECHNICAL SOILS REPORT IS INCLUDED FOR INFORMATION ONLY.
- 5. FOOTING, BASE, AND FOUNDATION DESIGN ARE THE RESPONSIBILITY OF THE WATER TOWER CONTRACTOR.
- 6. PEDESTAL AND FOOTING DIMENSIONS AND CONCRETE REINFORCEMENT SHALL BE DETERMINED BY THE WATER TOWER CONTRACTOR.
- 7. MINIMUM FOUNDATION CONCRETE COMPRESSIVE STRENGTH SHALL BE 4,000 P.S.I. AT 28 DAYS. REINFORCEMENT SHALL CONFORM TO ASTM A615 GR. 60.
- 8. CONSTRUCTION JOINTS SHALL BE ROUGHENED ACROSS ENTIRE FACE WITH 1/4" MINIMUM DEPTH INDENTATIONS.
- 9. THE TOP OF THE RINGWALL SHALL BE LEVEL WITHIN (\pm) 1/8" IN 30 FEET WITH A MAXIMUM DIFFERENTIAL OF (\pm) 1/4" BETWEEN ANY TWO POINTS ON THE CIRCUMFERENCE.
- 10. PROVIDE 1/2" THICK EXPANSION JOINT MATERIAL BETWEEN FLOOR AND WALL AND AT ALL PIPING PENETRATIONS.
- 11. ALL MATERIAL IN CONTACT WITH THE WATER SHALL BE NSF 61 APPROVED.
- 12. ALL PLATFORMS AND LADDERS INSIDE WATER TOWER TO HAVE DIRT PREVENTION FLOORS AND LEDGES ON THE EDGE TO PREVENT DIRT FROM ENTERING THE WATER.
- 13. THE TANK AND CONCRETE SUPPORT PEDESTAL SHALL BE DESIGNED AND CONSTRUCTED IN ACCORDANCE WITH AWWA D100-96, A.C.I. 318-99, A.C.I. 301-96 AND CONTRACT SPECIFICATIONS.
- WIND SPEED (ZONE III = 200 MPH) 90 MPH BASIC WIND SPEED SNOW LOAD: 40 PSF PLUS DRIFT SEISMIC ZONE: A
- 14. THE EXTERIOR OF THE CONCRETE PEDESTAL SHALL INCORPORATE VERTICAL AND HORIZONTAL RUSTICATION TO CREATE AN ARCHITECTURAL PATTERN.
- 15. THE INTERIOR SURFACES SHALL HAVE A SMOOTH AS-CAST FINISH.
- 16. ACCESSORIES SHOWN ON SECTION ARE ROTATED FOR CLARITY.
- 17. ALL LADDERS, LANDINGS AND ASSOCIATED COMPONENTS INSTALLED INSIDE THE CONCRETE PEDESTAL SHALL BE HOT-DIP GALVANIZED STEEL.
- 18. SEE PROJECT SPECIFICATIONS FOR SHOP AND FIELD PAINT REQUIREMENTS FOR THE STEFL TANK
- DISINFECT TANK IN ACCORDANCE WITH AWWA C652-92 AND CONTRACT SPECIFICATIONS.
 ALL HANDRAILS, PLATFORM LANDINGS, WALKWAYS, LADDERS AND SAFETY CLIMB DEVICES SHALL CONFORM WITH CURRENT OSHA STANDARDS.
- 21. LADDERS SHALL HAVE SWING-OUT REST SEATS AT 50'-0" MAXIMUM SPACING.22. DESIGN AND PROVIDE IMPRESSED CATHODIC PROTECTION SYSTEM FOR THE TANK.
- SPACE HAS BEEN RESERVED IN THE SAMPLING ROOM FOR THE SYSTEM COMPONENTS. 23. DESIGN AND PROVIDE A LIGHTNING PROTECTION SYSTEM.
- Utility I **G** esh > Ш ٩ Ó Ш $(\mathbf{1})$ APPROVED SEAL AFFIXED MONTH / DAY / YEAR SEPTEMBER 2020 JOB NO.: 15310 DESGN GJ CHCK CR DRWN TK APPRV AJM SCALE: AS SHOWN DRAWING NUMBER G2

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16 FT _____ 1∕8"=1'−0"

SHEET 4 OF 9 REV 0



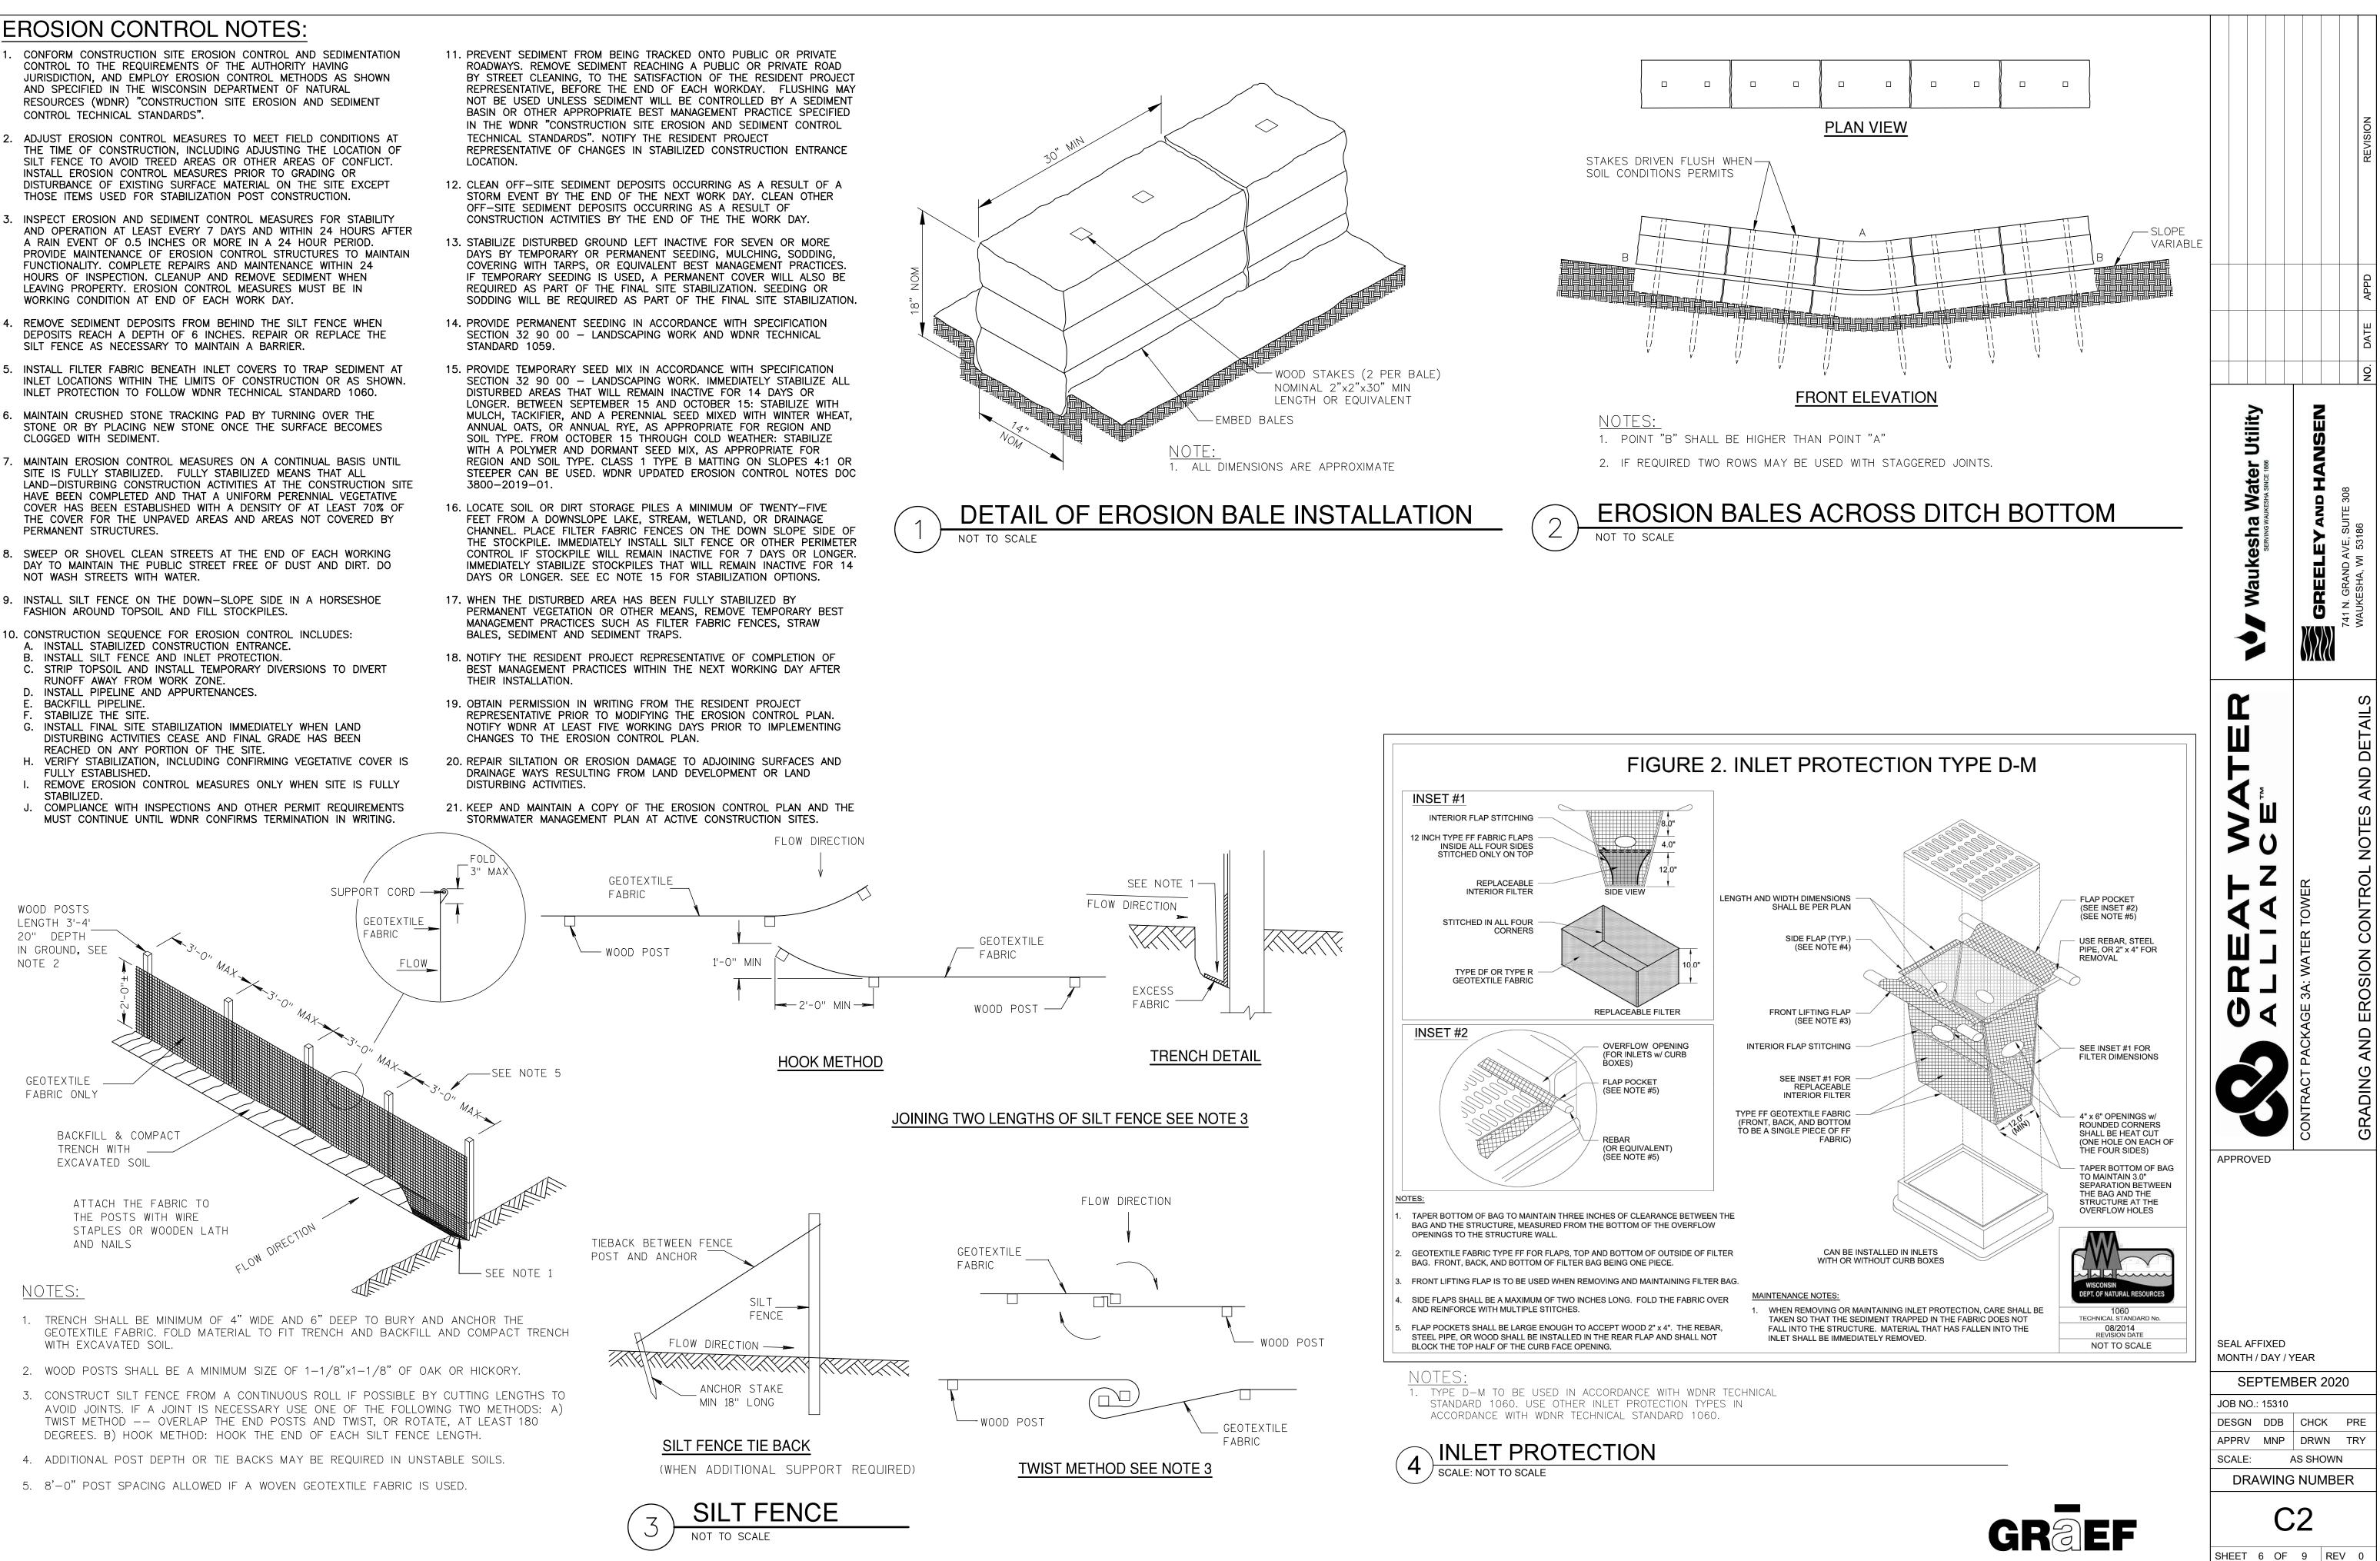
EROSION CONTROL NOTES:

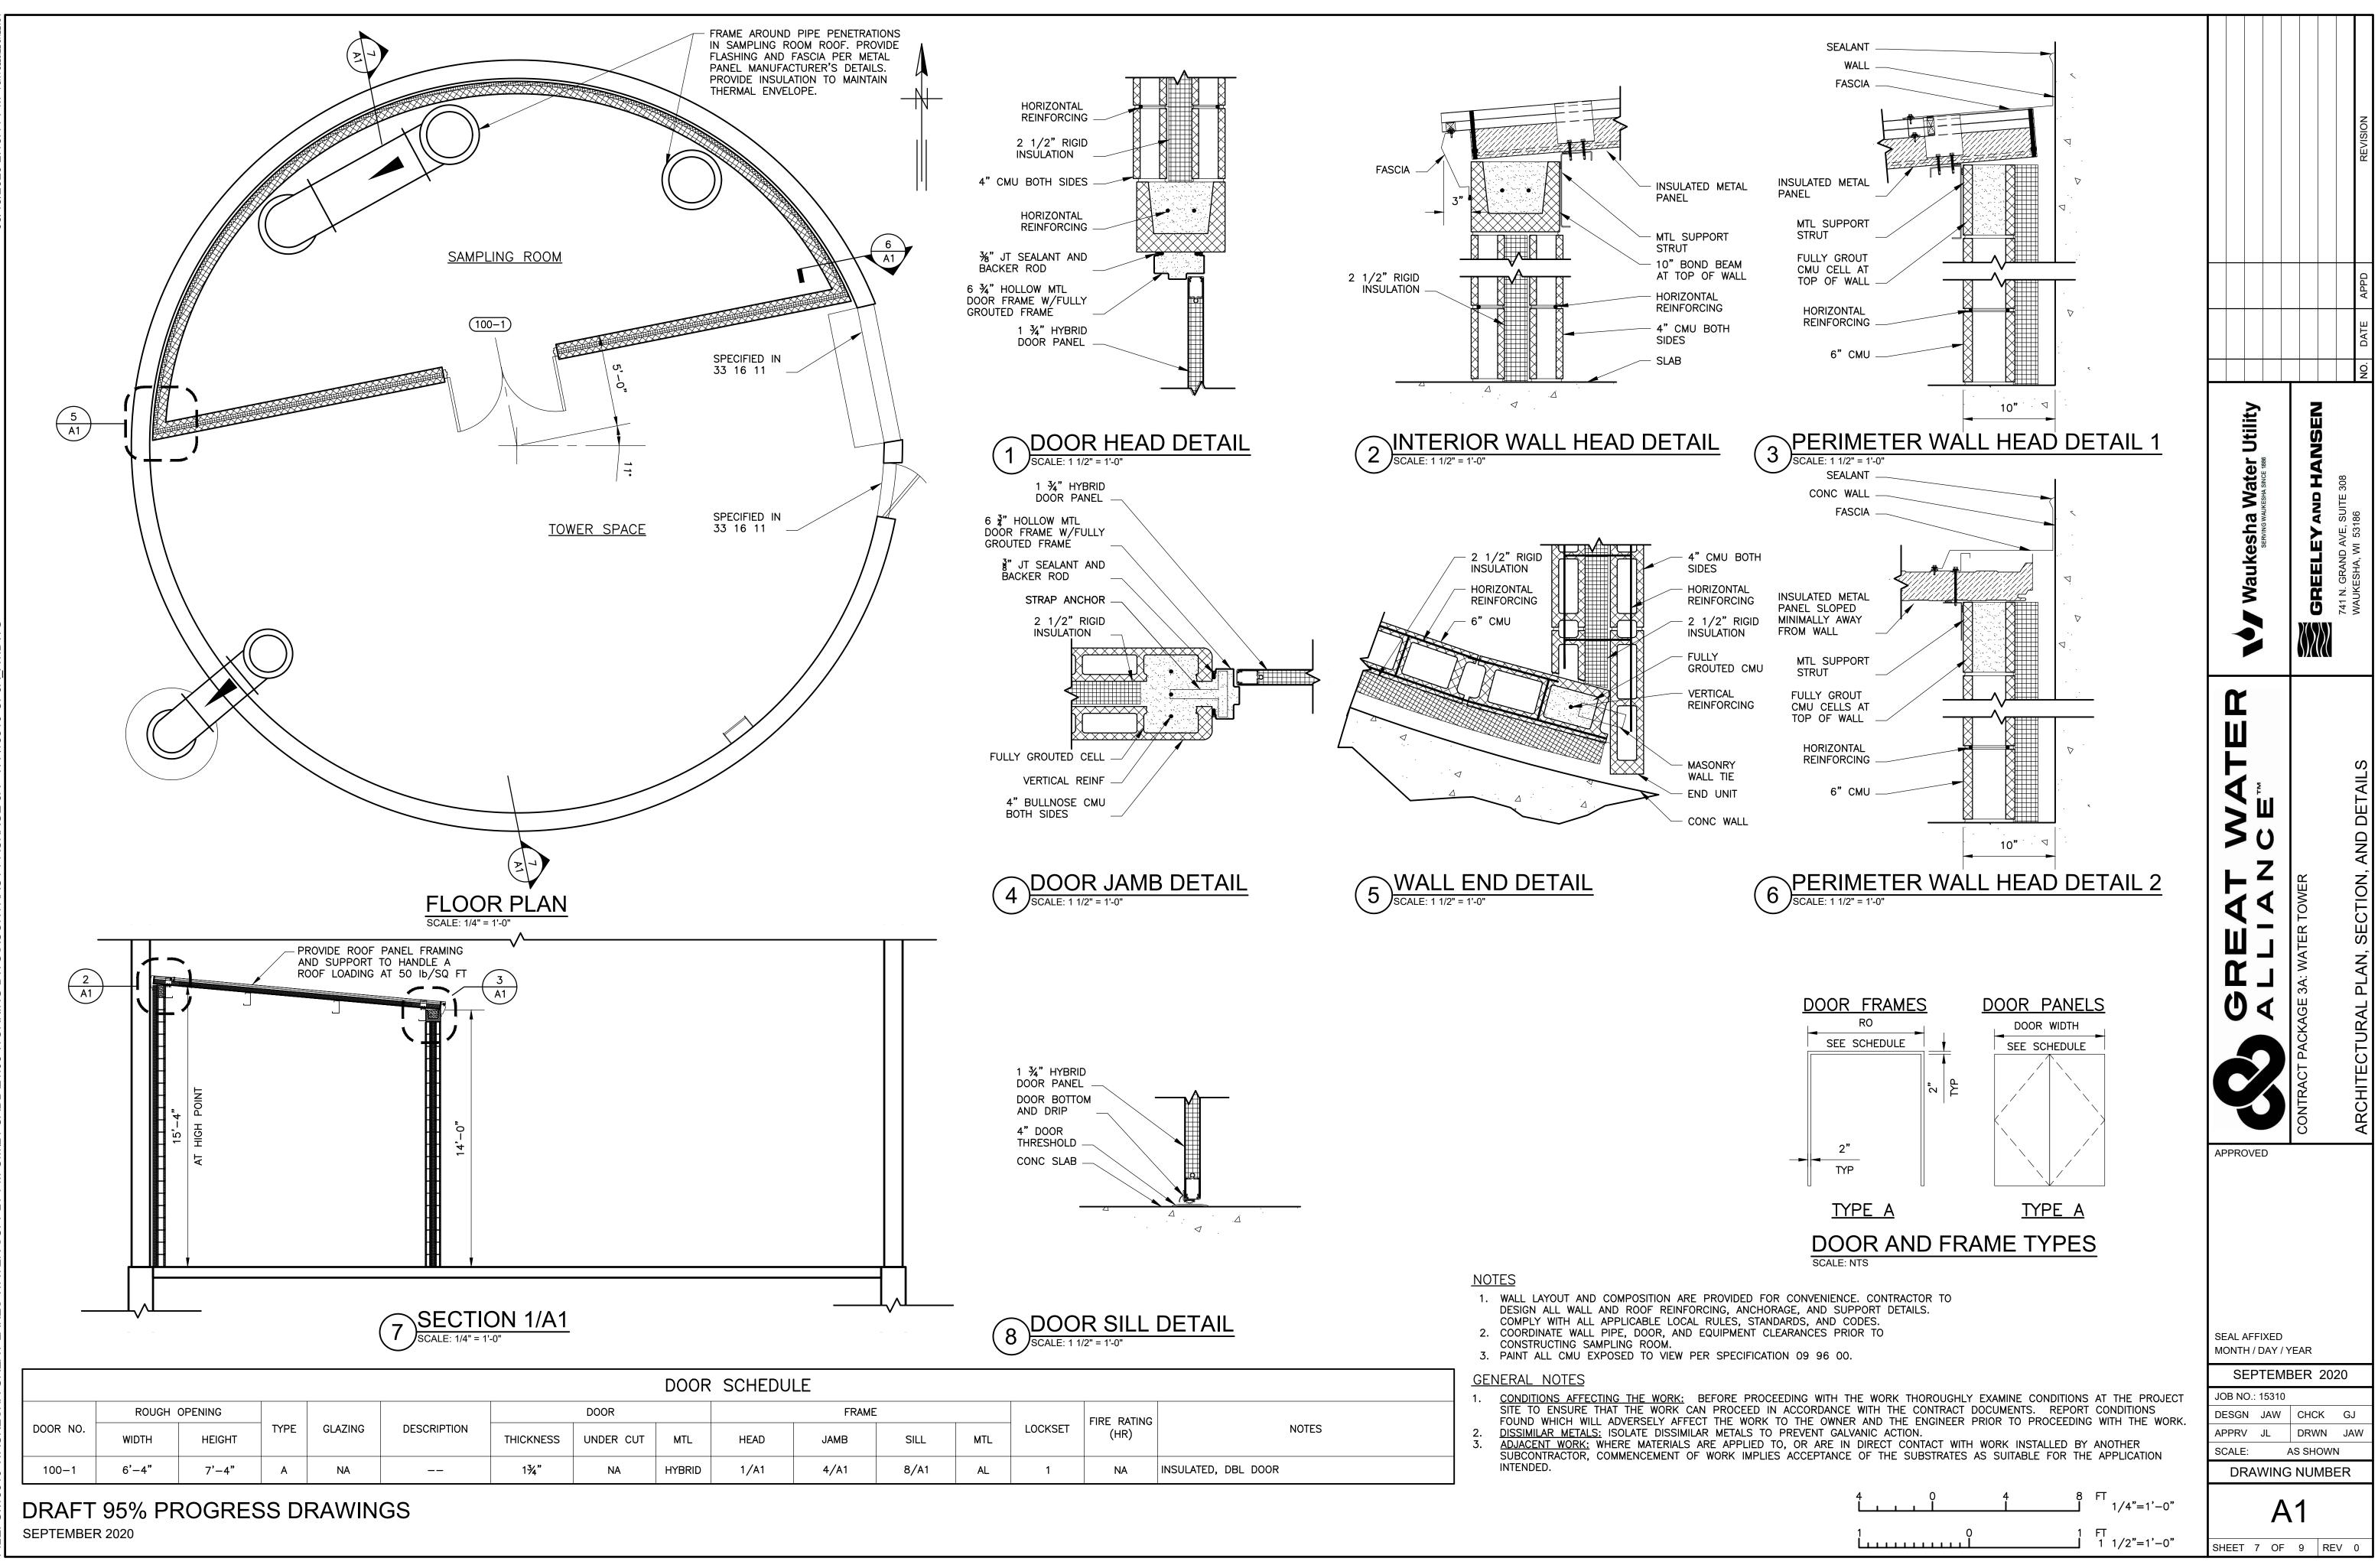
- CONTROL TO THE REQUIREMENTS OF THE AUTHORITY HAVING JURISDICTION. AND EMPLOY EROSION CONTROL METHODS AS SHOWN AND SPECIFIED IN THE WISCONSIN DEPARTMENT OF NATURAL RESOURCES (WDNR) "CONSTRUCTION SITE EROSION AND SEDIMENT CONTROL TECHNICAL STANDARDS".
- ADJUST EROSION CONTROL MEASURES TO MEET FIELD CONDITIONS AT SILT FENCE TO AVOID TREED AREAS OR OTHER AREAS OF CONFLICT. INSTALL EROSION CONTROL MEASURES PRIOR TO GRADING OR DISTURBANCE OF EXISTING SURFACE MATERIAL ON THE SITE EXCEPT THOSE ITEMS USED FOR STABILIZATION POST CONSTRUCTION.
- INSPECT EROSION AND SEDIMENT CONTROL MEASURES FOR STABILITY AND OPERATION AT LEAST EVERY 7 DAYS AND WITHIN 24 HOURS AFTER A RAIN EVENT OF 0.5 INCHES OR MORE IN A 24 HOUR PERIOD. PROVIDE MAINTENANCE OF EROSION CONTROL STRUCTURES TO MAINTAIN FUNCTIONALITY. COMPLETE REPAIRS AND MAINTENANCE WITHIN 24 HOURS OF INSPECTION. CLEANUP AND REMOVE SEDIMENT WHEN LEAVING PROPERTY. EROSION CONTROL MEASURES MUST BE IN WORKING CONDITION AT END OF EACH WORK DAY.
- REMOVE SEDIMENT DEPOSITS FROM BEHIND THE SILT FENCE WHEN SILT FENCE AS NECESSARY TO MAINTAIN A BARRIER.
- INLET PROTECTION TO FOLLOW WDNR TECHNICAL STANDARD 1060.
- STONE OR BY PLACING NEW STONE ONCE THE SURFACE BECOMES CLOGGED WITH SEDIMENT.
- MAINTAIN EROSION CONTROL MEASURES ON A CONTINUAL BASIS UNTIL SITE IS FULLY STABILIZED. FULLY STABILIZED MEANS THAT ALL LAND-DISTURBING CONSTRUCTION ACTIVITIES AT THE CONSTRUCTION SITE HAVE BEEN COMPLETED AND THAT A UNIFORM PERENNIAL VEGETATIVE COVER HAS BEEN ESTABLISHED WITH A DENSITY OF AT LEAST 70% OF THE COVER FOR THE UNPAVED AREAS AND AREAS NOT COVERED BY PERMANENT STRUCTURES.
- NOT WASH STREETS WITH WATER.
- FASHION AROUND TOPSOIL AND FILL STOCKPILES.

- RUNOFF AWAY FROM WORK ZONE.

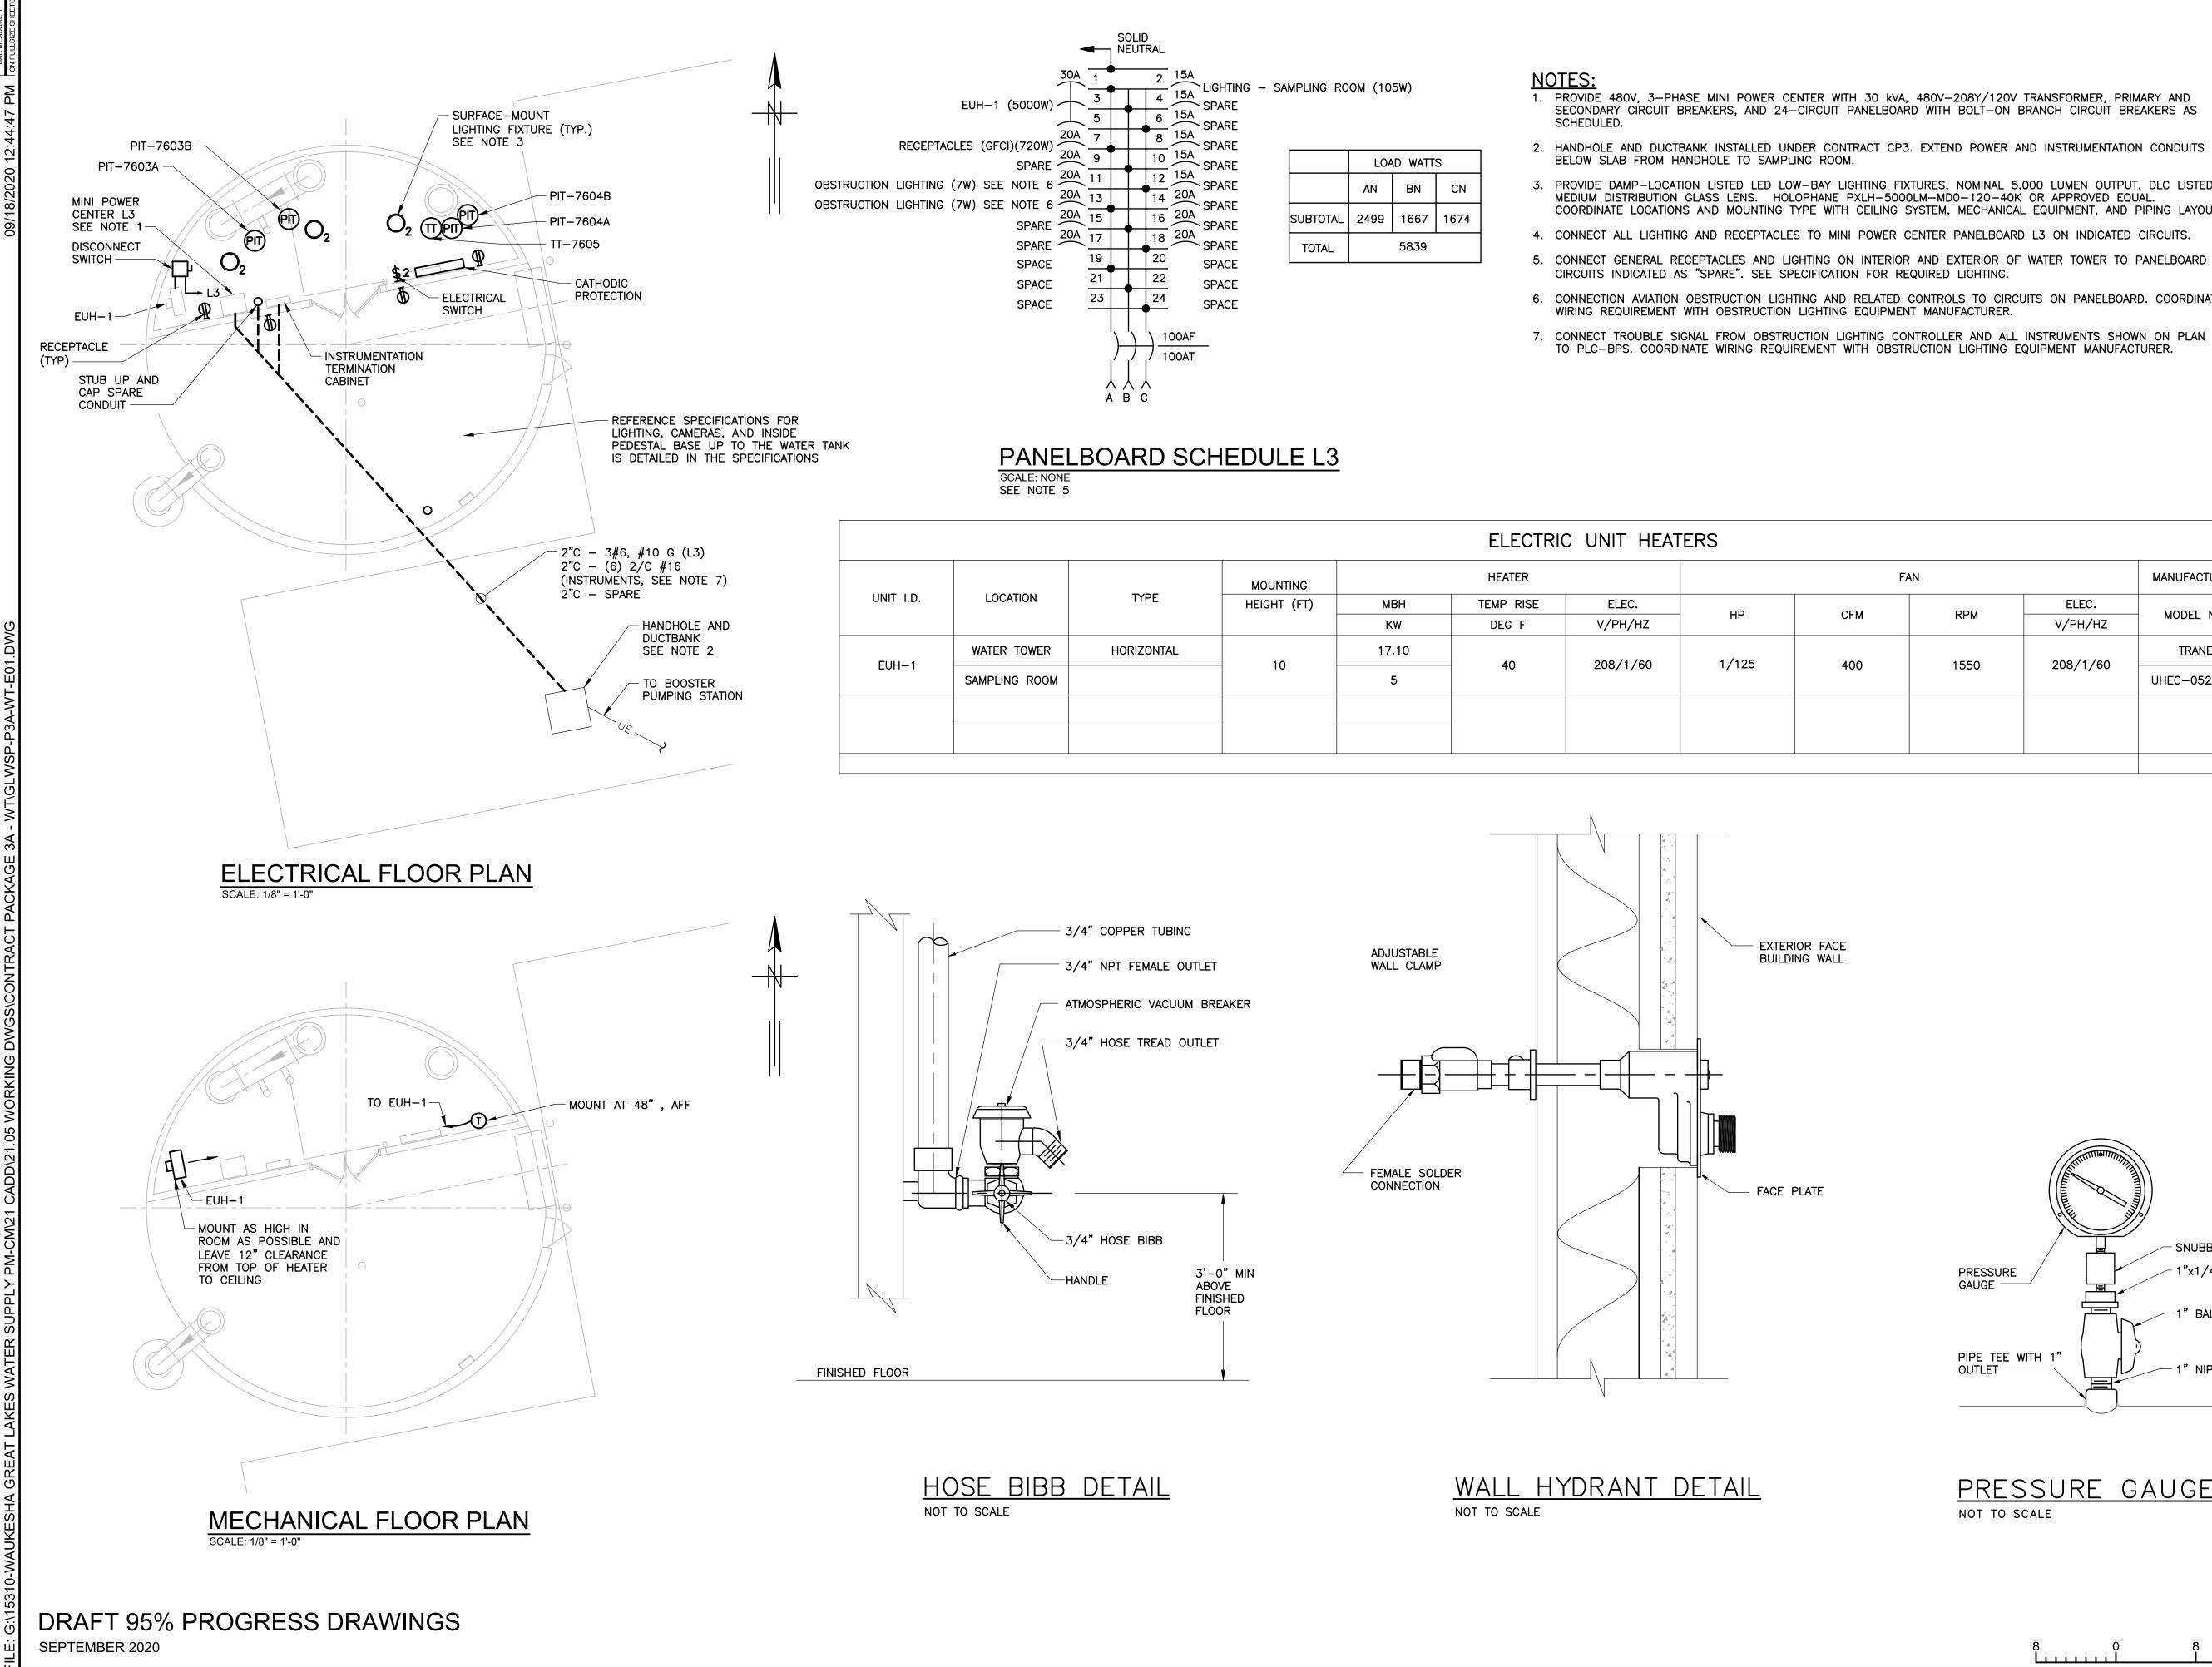
- DISTURBING ACTIVITIES CEASE AND FINAL GRADE HAS BEEN REACHED ON ANY PORTION OF THE SITE.
- FULLY ESTABLISHED.
- STABILIZED. MUST CONTINUE UNTIL WONR CONFIRMS TERMINATION IN WRITING.

- TECHNICAL STANDARDS". NOTIFY THE RESIDENT PROJECT LOCATION.
- OFF-SITE SEDIMENT DEPOSITS OCCURRING AS A RESULT OF CONSTRUCTION ACTIVITIES BY THE END OF THE THE WORK DAY.
- SECTION 32 90 00 LANDSCAPING WORK AND WDNR TECHNICAL STANDARD 1059.
- DISTURBED AREAS THAT WILL REMAIN INACTIVE FOR 14 DAYS OR WITH A POLYMER AND DORMANT SEED MIX, AS APPROPRIATE FOR 3800-2019-01.
- FEET FROM A DOWNSLOPE LAKE, STREAM, WETLAND, OR DRAINAGE DAYS OR LONGER. SEE EC NOTE 15 FOR STABILIZATION OPTIONS.
- MANAGEMENT PRACTICES SUCH AS FILTER FABRIC FENCES, STRAW BALES, SEDIMENT AND SEDIMENT TRAPS.
- THEIR INSTALLATION.
- CHANGES TO THE EROSION CONTROL PLAN.
- DRAINAGE WAYS RESULTING FROM LAND DEVELOPMENT OR LAND DISTURBING ACTIVITIES.





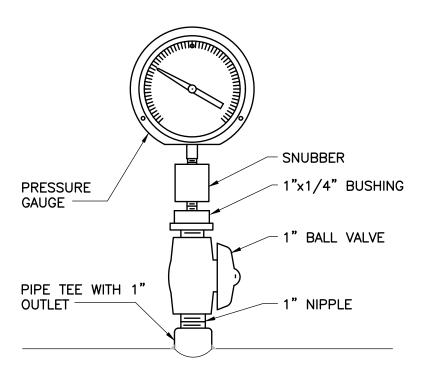
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	LOAD WATTS					
	AN	BN	CN			
SUBTOTAL	2499	1667	1674			
TOTAL		5839				

- 1. PROVIDE 480V, 3-PHASE MINI POWER CENTER WITH 30 kVA, 480V-208Y/120V TRANSFORMER, PRIMARY AND SECONDARY CIRCUIT BREAKERS, AND 24-CIRCUIT PANELBOARD WITH BOLT-ON BRANCH CIRCUIT BREAKERS AS
- 2. HANDHOLE AND DUCTBANK INSTALLED UNDER CONTRACT CP3. EXTEND POWER AND INSTRUMENTATION CONDUITS
- 3. PROVIDE DAMP-LOCATION LISTED LED LOW-BAY LIGHTING FIXTURES, NOMINAL 5,000 LUMEN OUTPUT, DLC LISTED, MEDIUM DISTRIBUTION GLASS LENS. HOLOPHANE PXLH-5000LM-MD0-120-40K OR APPROVED EQUAL. COORDINATE LOCATIONS AND MOUNTING TYPE WITH CEILING SYSTEM, MECHANICAL EQUIPMENT, AND PIPING LAYOUT.
- 4. CONNECT ALL LIGHTING AND RECEPTACLES TO MINI POWER CENTER PANELBOARD L3 ON INDICATED CIRCUITS.
- CIRCUITS INDICATED AS "SPARE". SEE SPECIFICATION FOR REQUIRED LIGHTING. 6. CONNECTION AVIATION OBSTRUCTION LIGHTING AND RELATED CONTROLS TO CIRCUITS ON PANELBOARD. COORDINATE
- 7. CONNECT TROUBLE SIGNAL FROM OBSTRUCTION LIGHTING CONTROLLER AND ALL INSTRUMENTS SHOWN ON PLAN TO PLC-BPS. COORDINATE WIRING REQUIREMENT WITH OBSTRUCTION LIGHTING EQUIPMENT MANUFACTURER.

		MOUNTING	HEATER		FAN			MANUFACTURER				
D.	LOCATION	TYPE	HEIGHT (FT)	MBH	TEMP RISE	ELEC.				ELEC.		REMARKS/NOTES
			KW	DEG F	V/PH/HZ	HP	CFM	RPM	V/PH/HZ	MODEL NO.		
1	WATER TOWER	HORIZONTAL	10	17.10	- 40	208/1/60	1/125	400	1550	208/1/60	TRANE	
1	SAMPLING ROOM		10	5	40	208/1/00	17125	400	1550 208/	2087 17 80 UHE(UHEC-052A0C0	
			_									



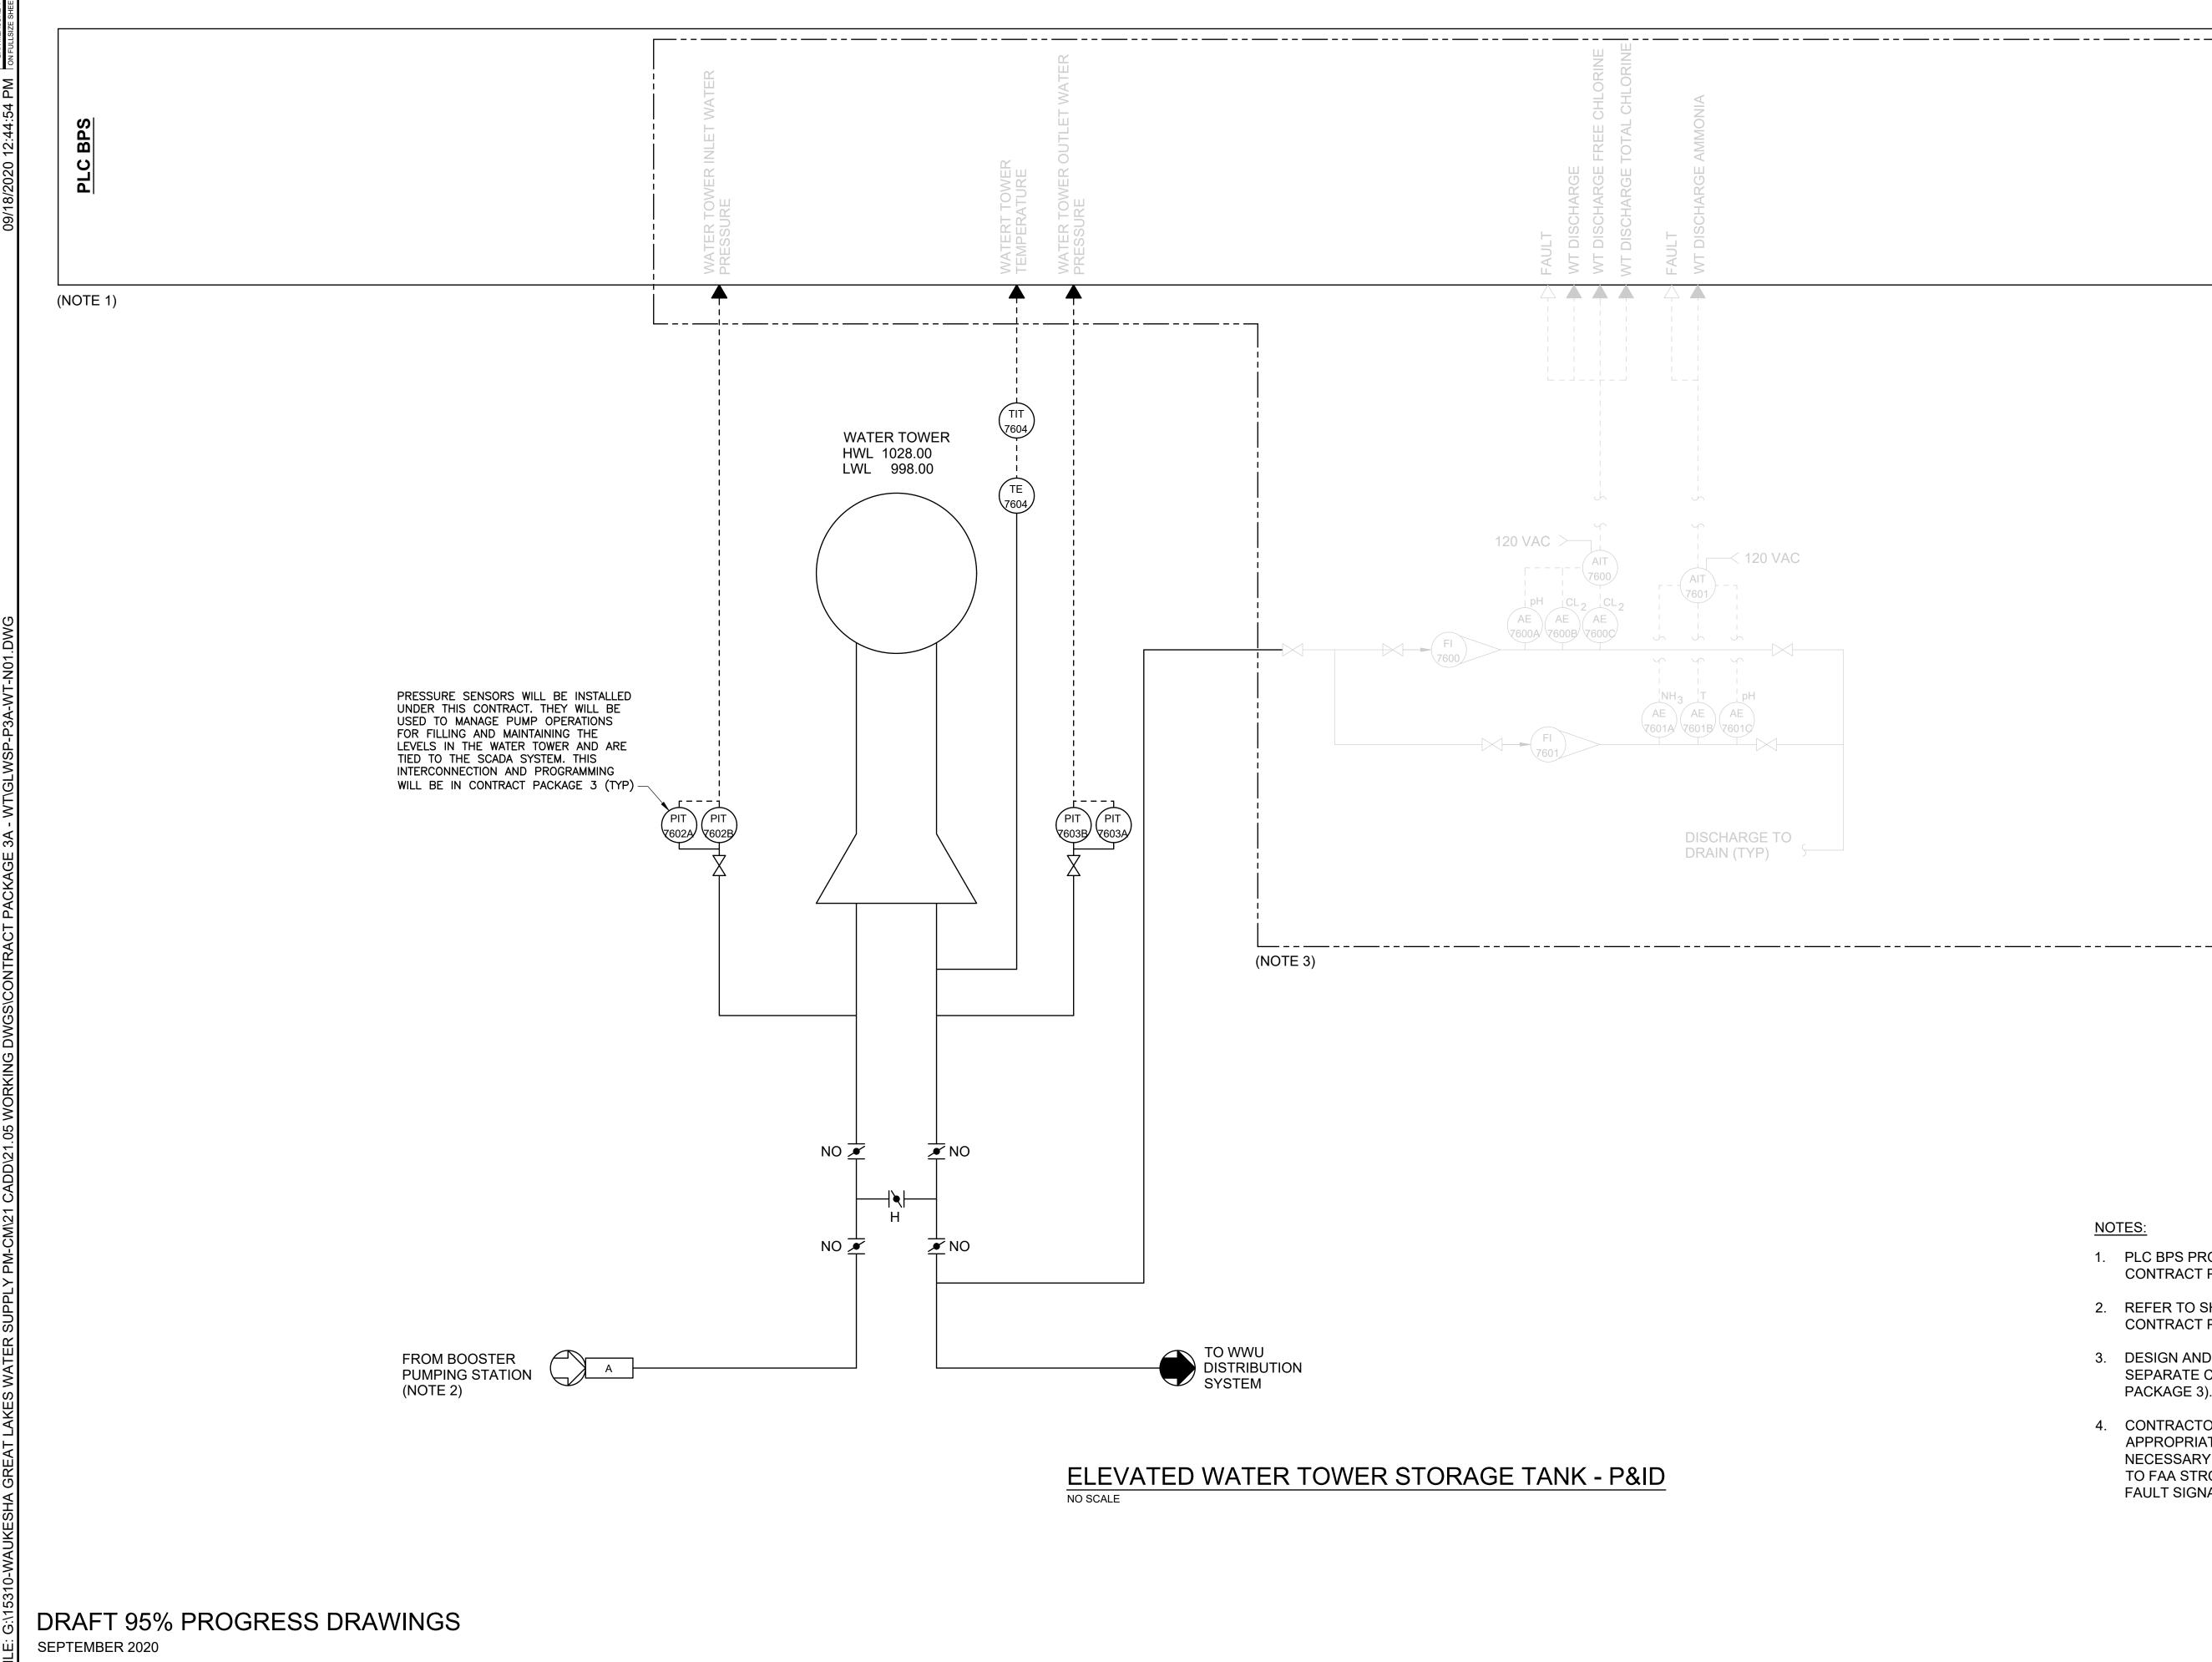
PRESSURE GAUGE DETAIL

NOT TO SCALE

0	8	16	FT
			1/8"=1'-0"
			.,

		REVISION
		APPD
		DATE
		O N
Vaukesha Water Utility	GREELEY AND HANSEN	741 N. GRAND AVE, SUITE 308 WAUKESHA, WI 53186
APPROVED	CONTRACT PACKAGE 3A: WATER TOWER	ELECTRICAL AND MECHANICAL PLANS, SCHEDULES AND DETAILS
SEAL AFFIXED MONTH / DAY / Y SEPTEME		020

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		REVISION
		APPD
		DATE
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	Vaukesha Water Utility SERVING WAUKESHA SINCE 1886	CREELEY AND HANSEN 741 N. GRAND AVE, SUITE 308 WAUKESHA, WI 53186
	GREAT WATER	CONTRACT PACKAGE 3A: WATER TOWER WATER TOWER - P&ID
OVIDED UNDER PACKAGE 3.	APPROVED	
SHEET BN1 UNDER PACKAGE 3.		
D INSTALLATION UNDER CONTRACT (CONTRACT).		
OR TO PROVIDE TE CABLE AND CONDUIT Y TO PROVIDE POWER	SEAL AFFIXED MONTH / DAY / `	YEAR
OBE LIGHT AND RELAY AL TO BPS PLC"	SEPTEMI JOB NO.: 15310 DESGN AG	BER 2020 CHCK THP
	APPRV THP	DRWN MV AS SHOWN
	DRAWING	S NUMBER
	N	1

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NOTES:

- 1. PLC BPS PRO CONTRACT I
- 2. REFER TO SH CONTRACT F
- 3. DESIGN AND SEPARATE (PACKAGE 3).
- 4. CONTRACTO APPROPRIAT NECESSARY TO FAA STRO FAULT SIGNA