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RESIDENCE FOR:

FOR HUMANITY

4 & 916 N. GRANDVIEW BOULEVARD WAUKESHA, WISCONSIN 53188

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PROPOSED
SITE & GRADING
PLAN


Revisions:

05/11/21

Job No. 21-108

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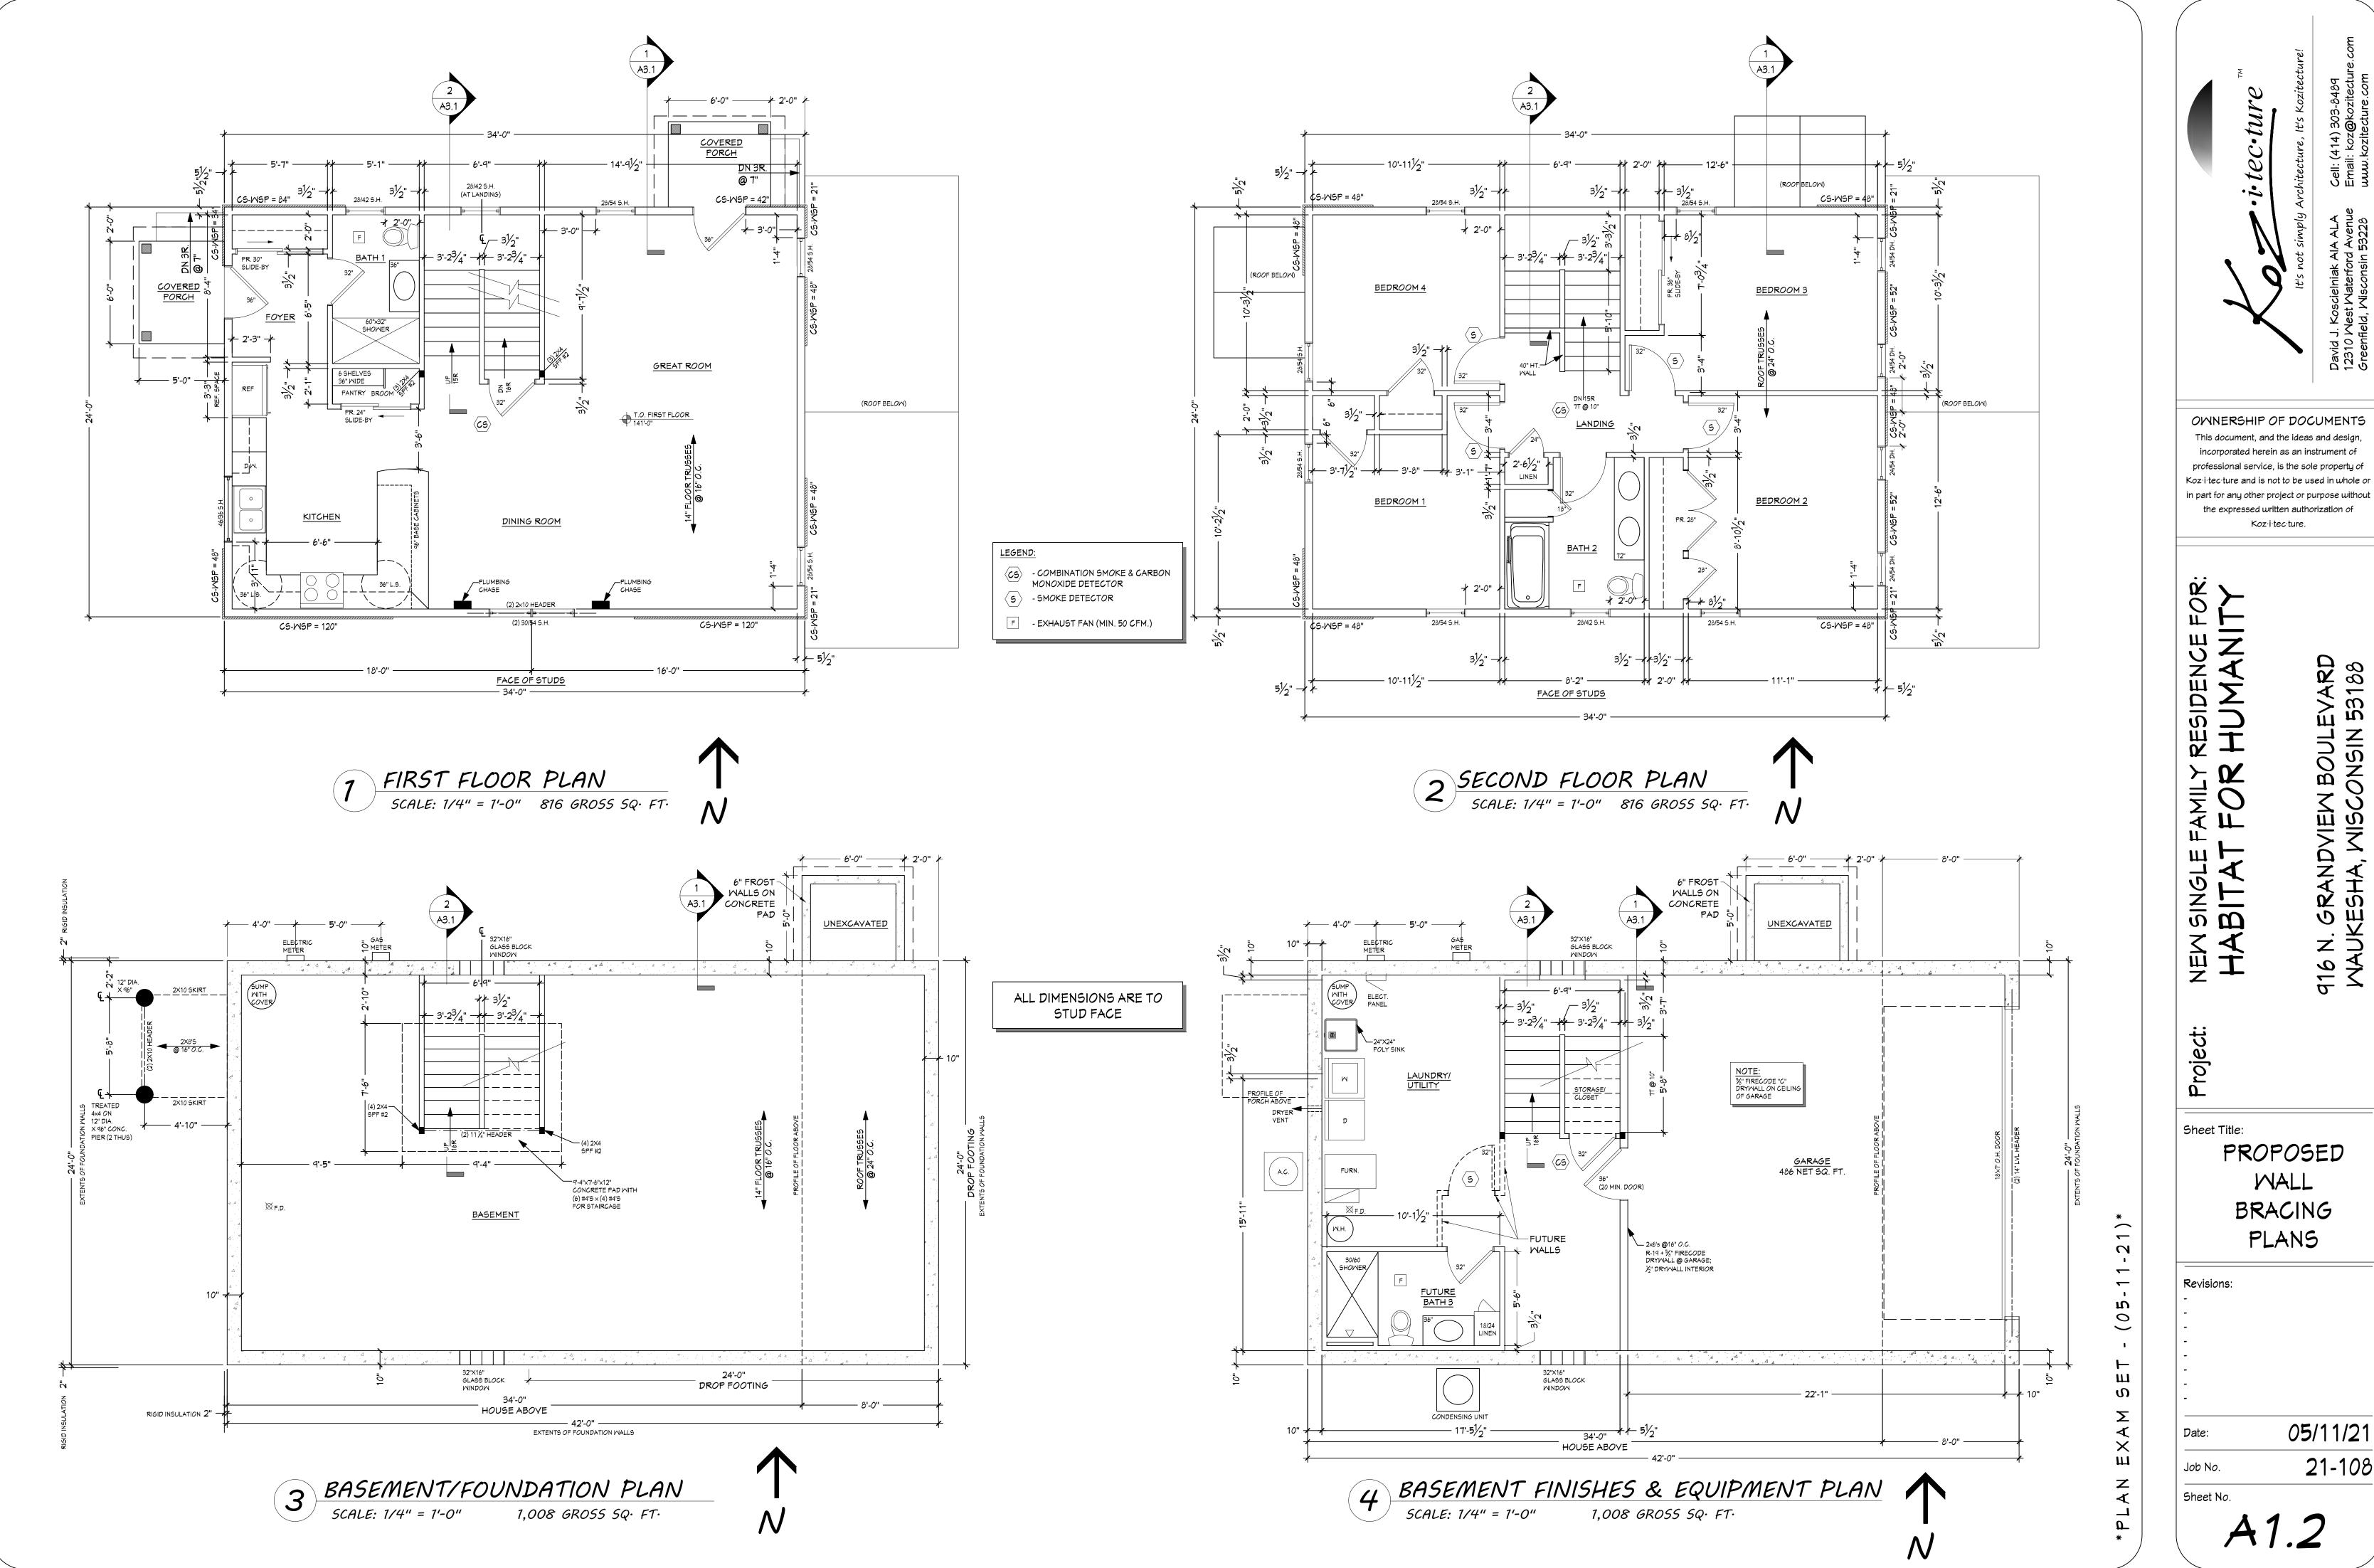
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> PROPOSED FLOOR PLANS

> > 05/11/21
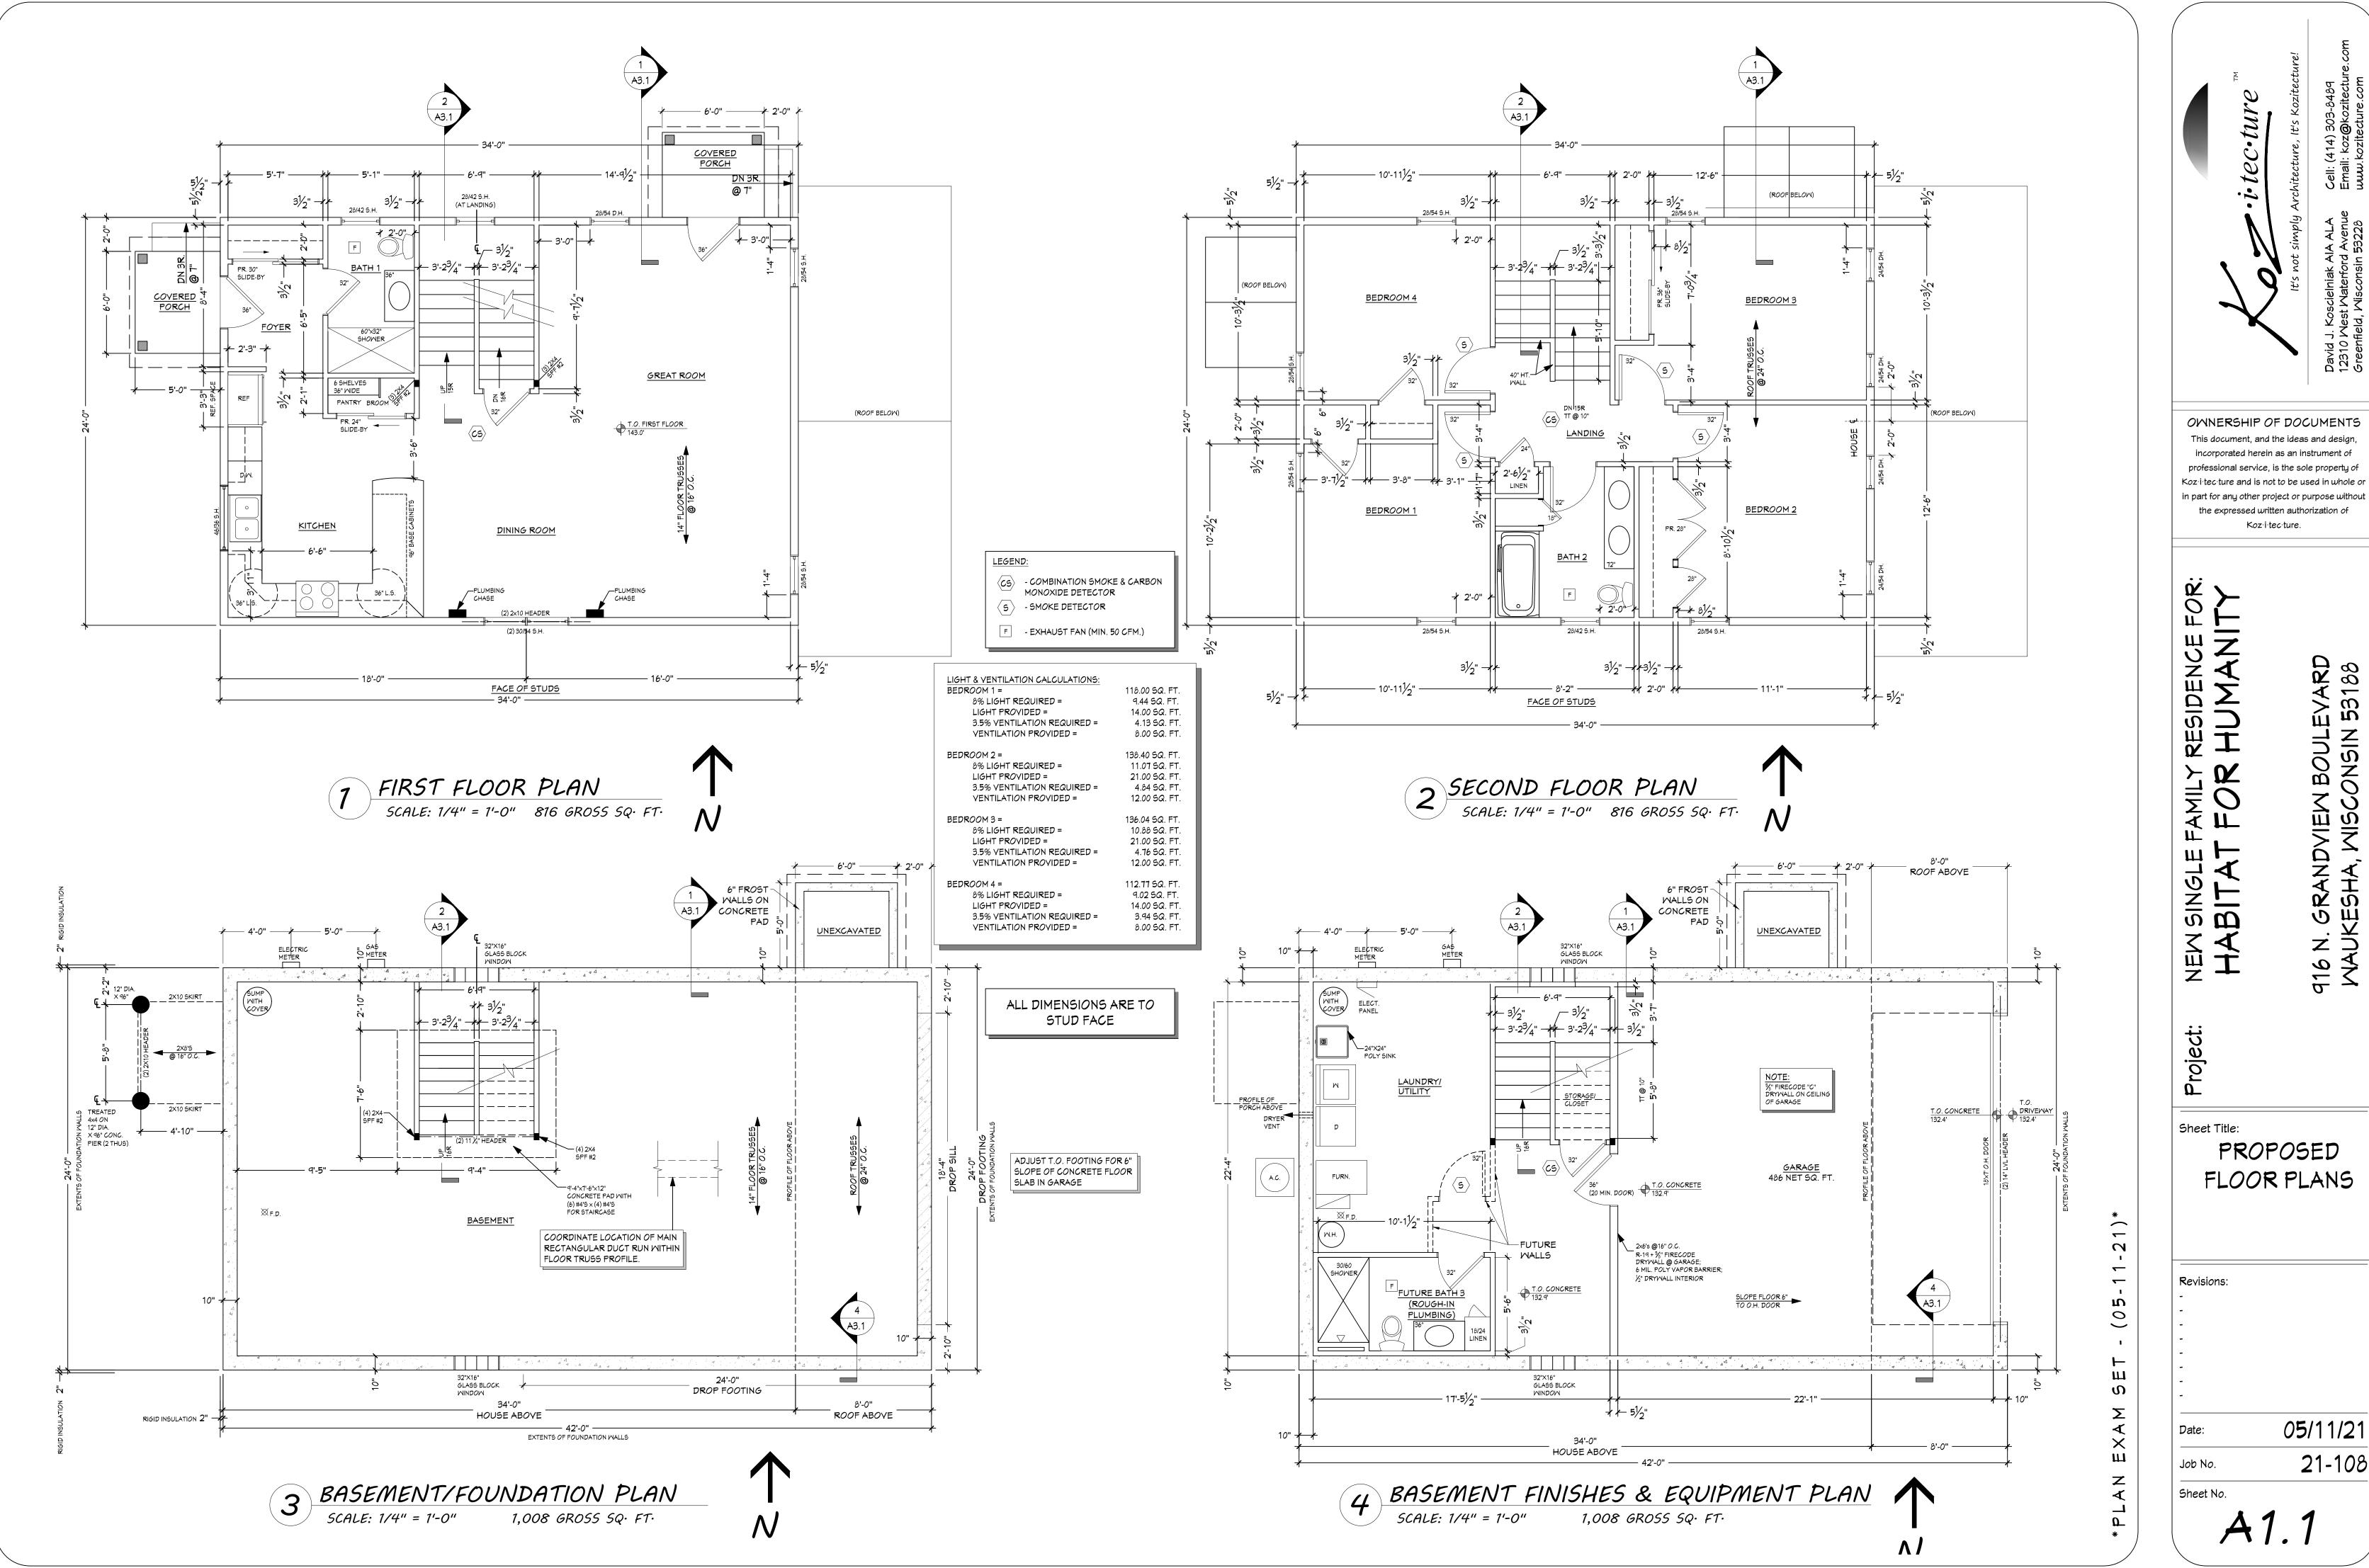
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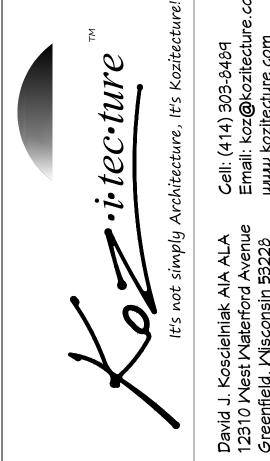
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PROPOSED MALL BRACING

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RESIDENCE HUMANI NEW SINGLE HABITAT

916 N. GRANDVIEW BOULEVARD WAUKESHA, MISCONSIN 53188

Sheet Title: PROPOSED ELEVATIONS

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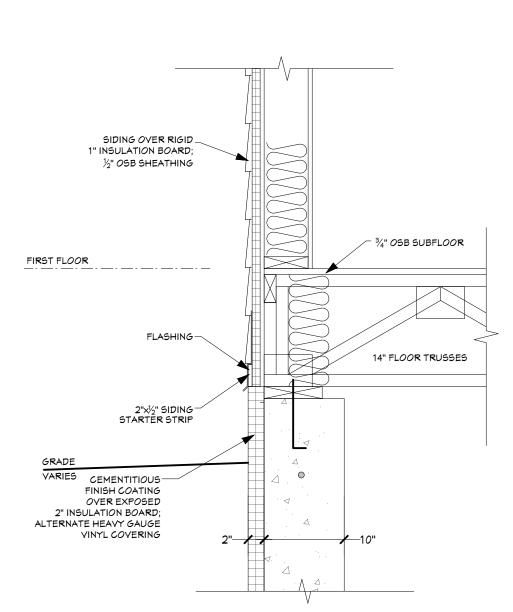
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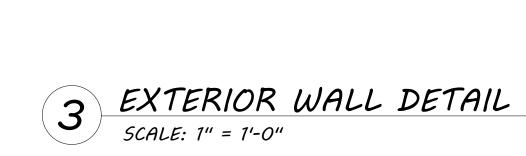
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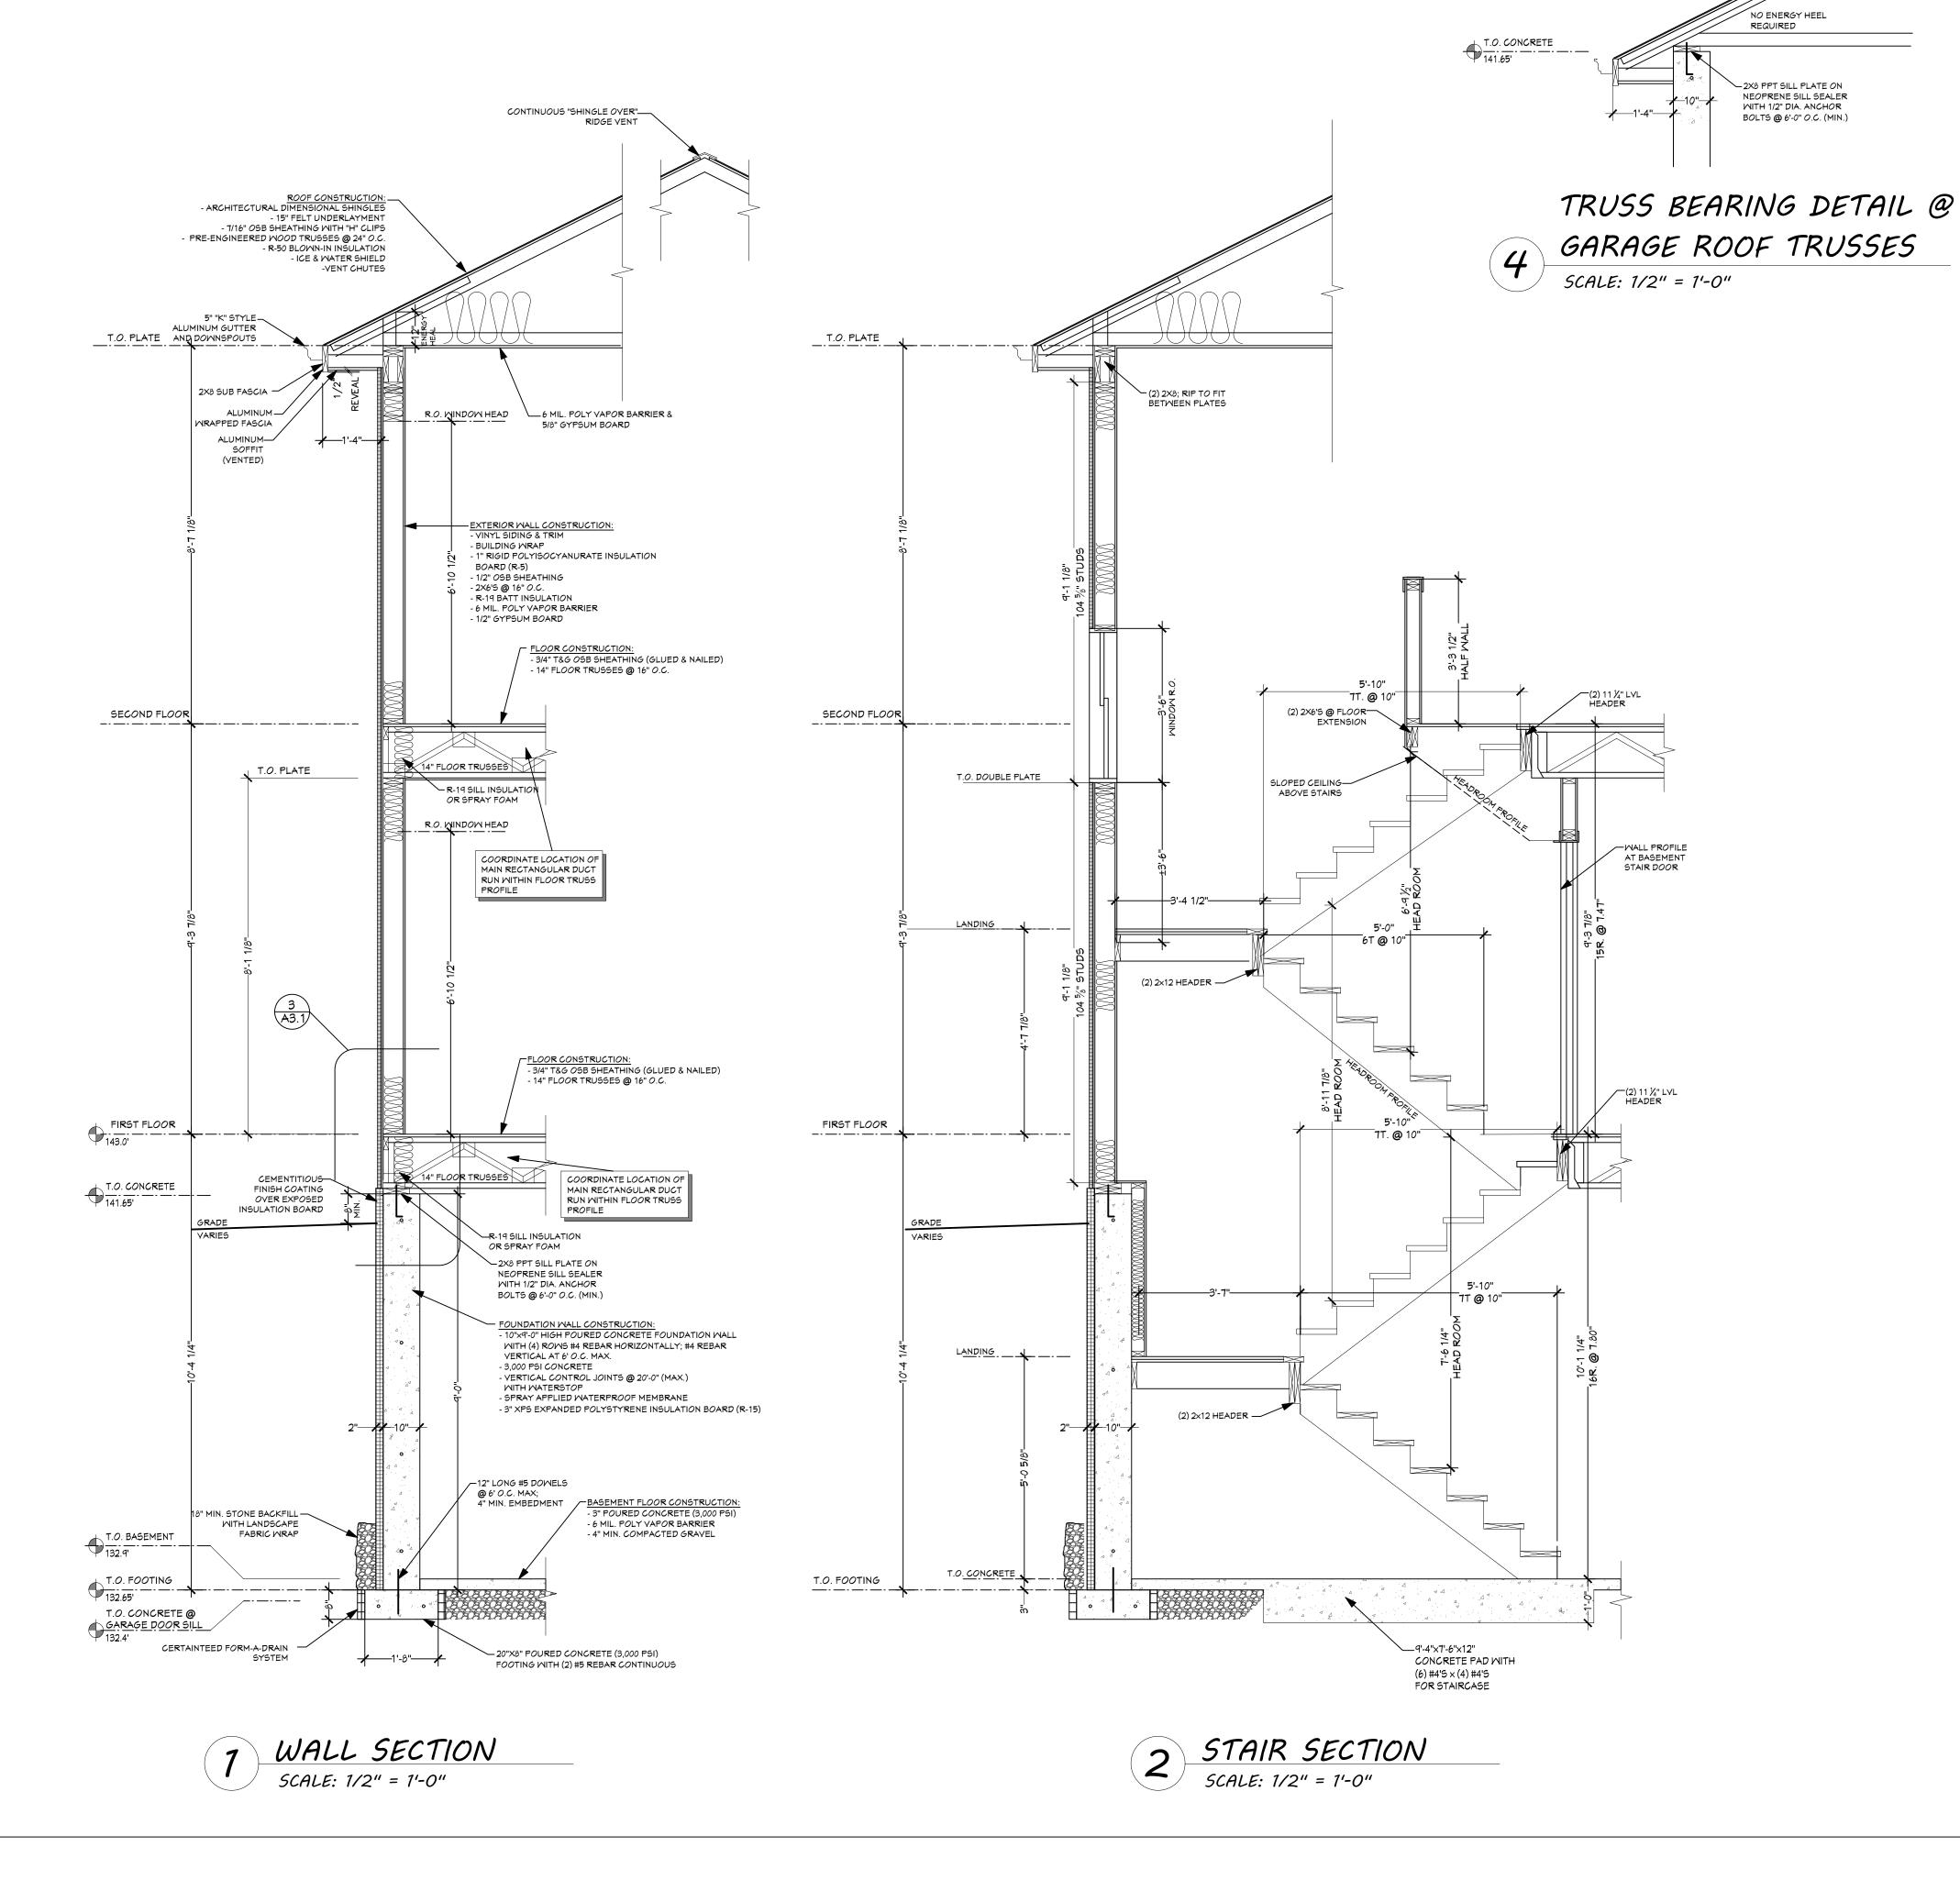
S = SMOKE DETECTOR

GENERAL NOTES:

- 1. THE ARCHITECT/ENGINEER MAINTAINS NO RESPONSIBILITY FOR THE GENERAL CONTRACTOR, SUBCONTRACTORS, OR THOSE WORKING IN SUCH CAPACITIES, FOR THE MEANS OR METHODS USED, OR LACK THEREOF, IN THE EXECUTION OF THE WORK AND SAFETY PROCEDURES AND PRECAUTIONS TAKEN AT THE PROJECT SITE.
- ALL CONSTRUCTION SHALL BE PERFORMED IN STRICT CONFORMANCE WITH ALL APPLICABLE STATE AND LOCAL BUILDING CODES.
- 3. CONTRACTORS SHALL COMPLY WITH THE LATEST (OSHA) OCCUPATIONAL SAFETY AND HEALTH ACT REQUIREMENTS.
- 4. CONTRACTORS SHALL ASSUME FULL RESPONSIBILITY UNRELIEVED BY REVIEW OF SHOP DRAWINGS NOR BY SUPERVISION OR PERIODIC OBSERVATION OF CONSTRUCTION FOR COMPLIANCE WITH THE CONTRACT DOCUMENTS - FOR DIMENSIONS TO BE CONFIRMED AND CORRELATED ON THE JOB SITE AND BETWEEN INDIVIDUAL DRAWINGS OR SETS OF DRAWINGS; FOR FABRICATION PROCESSES AND CONSTRUCTION TECHNIQUES (INCLUDING EXCAVATION, SHORING, BRACING, SCAFFOLDING, FORMWORK ERECTION, ETC.); FOR COORDINATION OF THE VARIOUS TRADES; FOR SAFE CONDITIONS ON THE JOB SITE; AND FOR PROTECTION OF THE PEOPLE AND PROPERTY AT THE JOB SITE.
- VARIATIONS IN FIELD CONDITIONS RELATIVE TO THE CONTRACT DOCUMENTS SHALL BE REPORTED TO THE ARCHITECT/ENGINEER. WORK SHALL NOT PROGRESS UNTIL WRITTEN PERMISSION FROM THE ARCHITECT/ENGINEER IS OBTAINED.
- 6. THE INFORMATION CONTAINED ON THE DRAWINGS IS IN ITSELF INCOMPLETE, AND VOID UNLESS USED IN CONJUNCTION WITH ALL THE SPECIFICATIONS, TRADE PRACTICES, APPLICABLE STANDARDS, CODES, ETC., INCORPORATED THEREIN BY REFERENCE, OF WHICH THE CONTRACTOR CERTIFIES KNOWLEDGE BY SIGNING THE CONTRACT.
- 7. UNLESS OTHERWISE NOTED, ALL DETAILS, SECTIONS AND NOTES ON THE DRAWINGS ARE INTENDED TO BY TYPICAL FOR SIMILAR SITUATIONS AND CONDITIONS ELSEWHERE.
- 8. DRAWINGS ARE NOT TO BE USED FOR SHOP DETAILING OR FOR CONSTRUCTION UNLESS SPECIFICALLY STAMPED BY THE ARCHITECT / ENGINEER ON THE DRAWINGS "FOR DETAILING" OR "FOR CONSTRUCTION". THESE DRAWINGS ARE NOT TO BE REPRODUCED FOR THE PURPOSE OF USING THEM AS SHOP DRAWINGS.
- ARCHITECT / ENGINEER'S REVIEW OF DRAWINGS PREPARED BY THE CONTRACTORS, SUPPLIERS, ETC., ARE ONLY FOR CONFORMANCE WITH THE DESIGN CONCEPT. CONSTRUCTION SHALL NOT START WITHOUT SAID REVIEW, AND ONLY SHOP DRAWINGS STAMPED BY THE ARCHITECT / ENGINEER WILL BE ALLOWED AT THE JOB SITE.
- 10. SEE ARCHITECTURAL, STRUCTURAL, MECHANICAL, ELECTRICAL, AND PLUMBING DRAWINGS FOR ADDITIONAL OPENINGS, SLEEVES, EQUIPMENT PADS, DEPRESSIONS, CURBS, INSERTS, FLOOR FINISHES AND OTHER EMBEDDED ITEMS.
- 11. UNLESS OTHERWISE NOTED OR SHOWN, THE GENERAL CONTRACTOR SHALL BE RESPONSIBLE FOR COORDINATING THE LOCATION AND PLACEMENT OF ANY INSERTS, HANGERS, ANCHOR BOLTS, HOLES OR PIPE SLEEVES THAT ARE REQUIRED BY THE MECHANICAL, ELECTRICAL OR PLUMBING EQUIPMENT.
- 12. ALL DIMENSIONS ON STRUCTURAL DRAWINGS ARE TO BE CHECKED BY THE CONTRACTORS AGAINST ARCHITECTURAL, MECHANICAL, ELECTRICAL AND PLUMBING DRAWINGS. CONTRACTORS SHALL BE FULLY RESPONSIBLE FOR CONFIRMING AND CORRELATING ALL DIMENSIONS ON THE JOB SITE AND BETWEEN INDIVIDUAL DRAWINGS AND RESPECTIVE
- 13. THIS PROJECT IS BEING DESIGNED AND CONSTRUCTED UTILIZING A DESIGN / BUILD DELIVERY PROCESS FOR THE MAJOR SUBCONTRACTOR TRADES OF MECHANICAL (HVAC), ELECTRICAL, PLUMBING AND FIRE PROTECTION SYSTEMS. EACH SUBCONTRACTOR IS RESPONSIBLE TO SUBMIT PLANS AND OBTAIN PERMITS FOR THEIR RESPECTIVE SPECIALTY TRADES. GENERAL CONTRACTOR AND SUBCONTRACTORS SHALL COORDINATE ALL WORK WITHIN THE SCOPE OF THIS PROJECT FOR SYSTEMS INSTALLATION, INTERFERENCE CONTROL AND PROJECT CONSTRUCTION SCHEDULE.
- 14. WINDOW DESIGNATIONS GIVEN ARE FOR UNIT SIZE ROUGH OPENINGS NOTED IN INCHES (MIDTH X HEIGHT). MATCH MINDOM SIZES AS CLOSELY AS POSSIBLE TO SELECTED MINDOM MANUFACTURER'S STANDARD SIZES.
- NEW WINDOWS SHALL MEET CODE REQUIREMENTS FOR LIGHT (8%) AND VENTILATION (3.5% IN ALL HABITABLE ROOMS; MEET EGRESS REQUIREMENTS FOR CLEAR OPENING OF 20" X 24" (EITHER WIDTH X HEIGHT OR HEIGHT X WIDTH).
- 16. INSTALL SMOKE ALARMS; INTERCONNECTED AND DIRECTLY WIRED TO THE DWELLING'S ELECTRICAL SERVICE WITH A BACK-UP BATTERY SUPPLY.
- 17. INSTALL COMBINATION SMOKE ALARM/CARBON MONOXIDE ALARM; INTERCONNECTED AND DIRECTLY MIRED TO THE DMELLING'S ELECTRICAL SERVICE MITH A BACK-UP BATTERY
- 18. THIS PROJECT INVOLVES INSTALLATION OF NEW ROOF TRUSSES. THE GENERAL CONTRACTOR SHALL BE RESPONSIBLE TO FIELD VERIFY THE TRUSS BEARING CONDITIONS, TRUSS LENGTH AND ROOF PITCH (WHEN MATCHING EXISTING ROOF PROFILES) PRIOR TO ORDERING AND INSTALLING THE NEW ROOF TRUSSES.









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Sheet Title: GENERAL NOTES, WALL SECTIONS & STAIR SECTION

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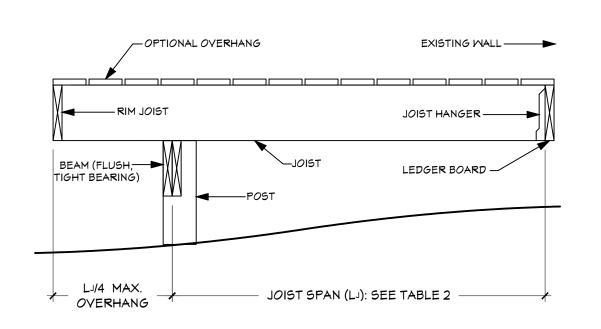
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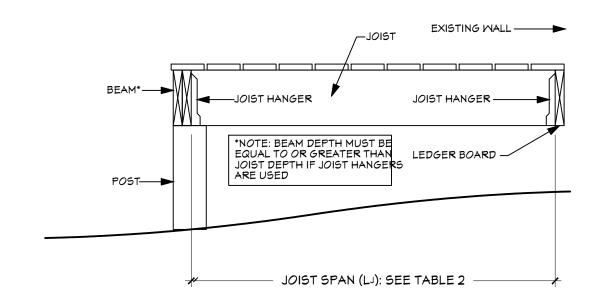
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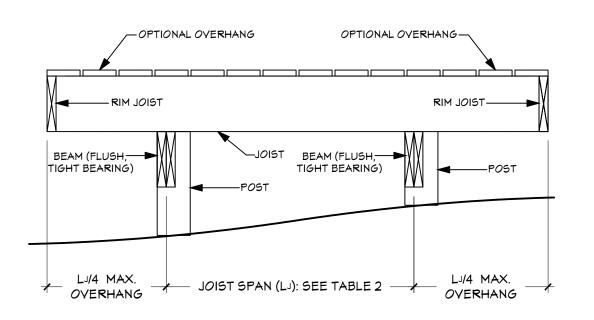
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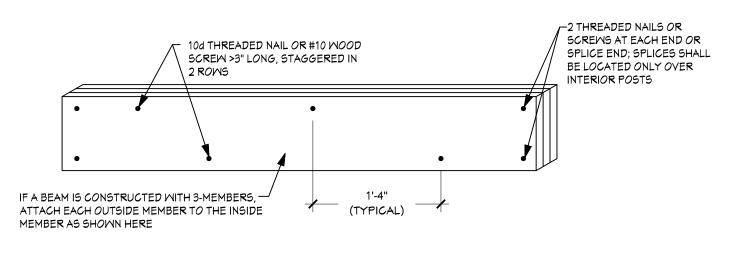
















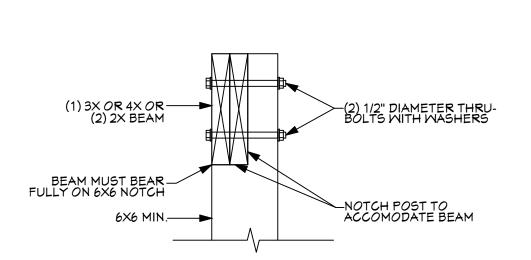


5 POST TO BEAM ATTACHMENT


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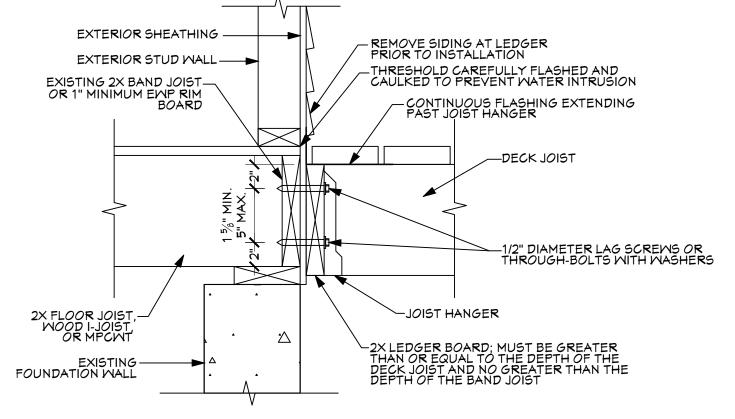


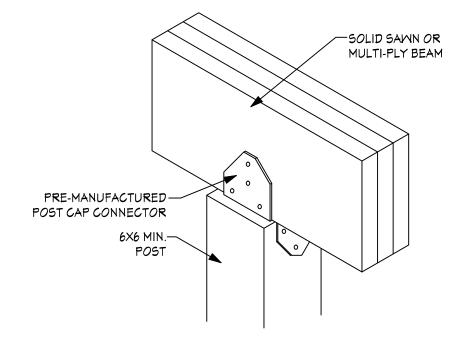ALTERNATE POST-TO-BEAM POST CAP ATTACHMENT

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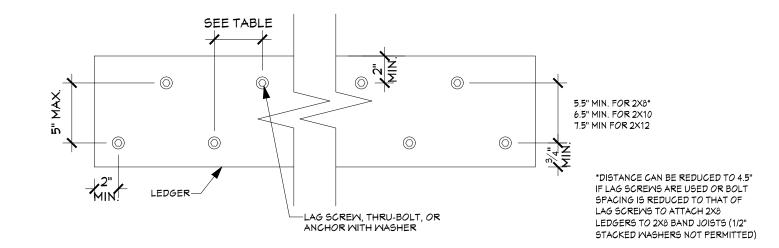




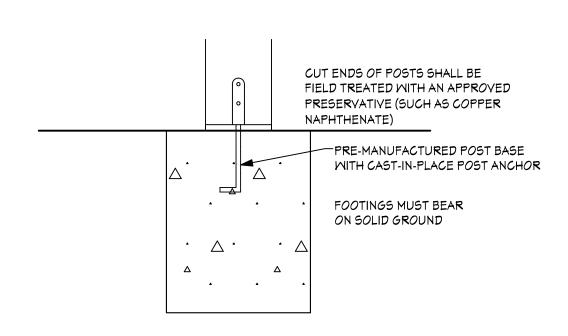

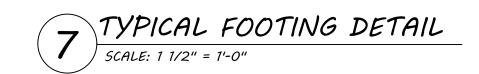GENERAL ATTACHMENT OF LEDGER BOARD 8 TO BAND JOIST OR RIM BOARD


SCALE: 1 1/2" = 1'-0"



(DECK LIVE LOAD = 40 PSF, DEC	K DEAD LOAD = 10 PS	F)						
JOIST SPAN	RIM BOARD OR BAND JOIST	6'-0" AND LESS	6'-1" T <i>O</i> 8'-0"	8'-1" T <i>O</i> 10'-0"	10'-1" T <i>O</i> 12'-0"	12'-1" T <i>O</i> 14'-0"	14'-1" T <i>O</i> 16'-0"	1
CONNECTION DETAILS	ON-CENTER SPACING OF FASTENERS							
1/2" DIAMETER LAG SCREW WITH 15/32" MAXIMUM SHEATHING	1" EMP 1-1/8" EMP 1-1/2" LUMBER	24" 28" 30"	18" 21" 23"	14" 16" 18"	12" 14" 15"	10" 12" 13"	9" 10" 11"	
1/2" DIAMETER BOLT WITH 15/32" MAXIMUM SHEATHING	1" EMP 1-1/8" EMP 1-1/2" LUMBER	24" 28" 36"	18" 21" 36"	14" 16" 34"	12" 14" 29"	10" 12" 24"	9" 10" 21"	
1/2" DIAMETER BOLT WITH 5/32" MAXIMUM SHEATHING AND 1/2" STACKED WASHERS	1-1/2" LUMBER	36"	36"	29"	24"	21"	18"	

(1) 3/8" DIAMETER -THRU-BOLT WITH WASHERS, TYPICAL

BRACING PARALLEL TO BEAM

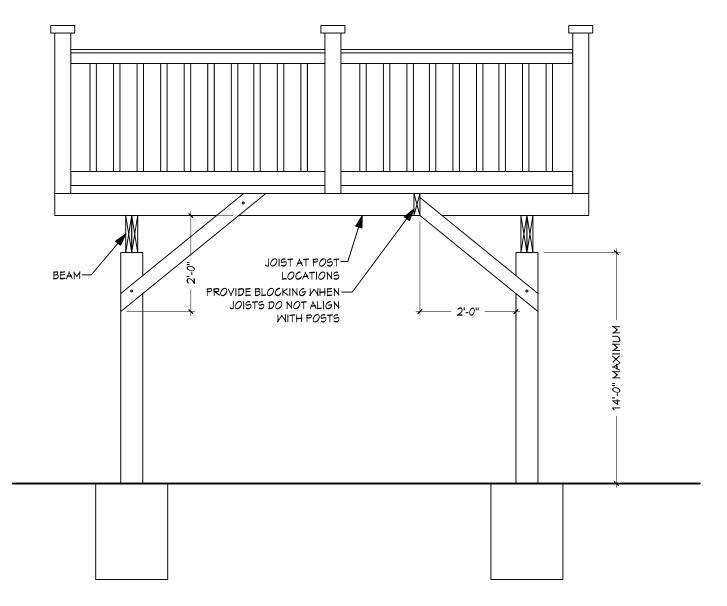

BRACING PERPENDICULAR TO BEAM

DIAGONAL BRACING REQUIREMENTS NOTE: DECKS GREATER THAN 2 FEET ABOVE GRADE SHALL BE PROVIDED WITH DIAGONAL BRACING

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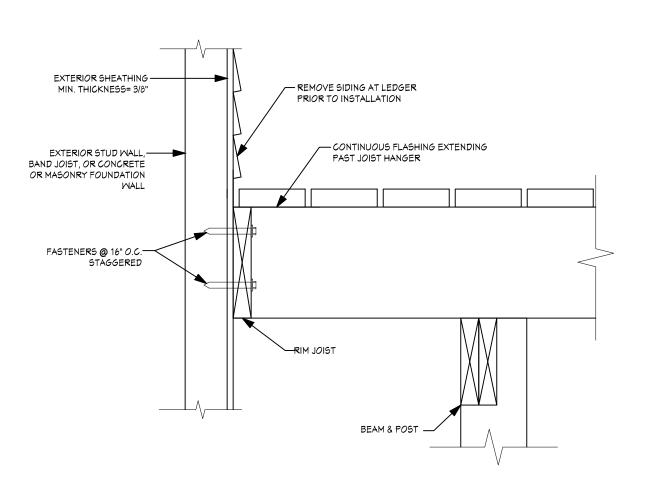
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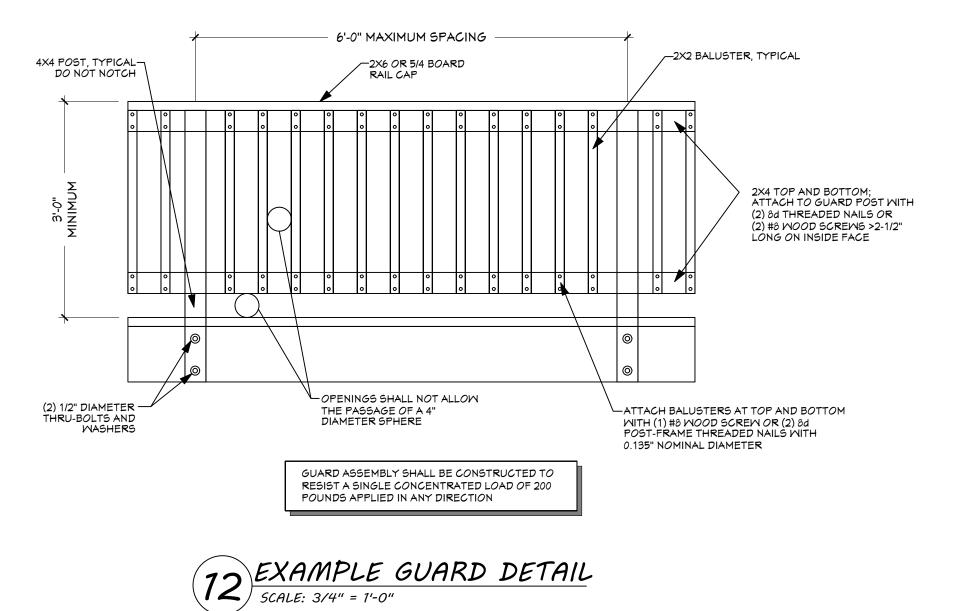
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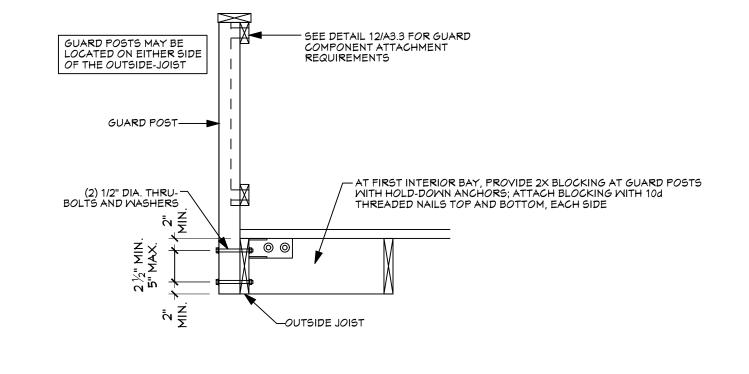
THE MAXIMUM GAP BETWEEN THE FACE OF THE LEDGER BOARD AND FACE OF THE WALL SHEATHING SHALL BE 1/2". LEDGERS SHALL BE FLASHED OR CAULKED TO PREVENT WATER FROM CONTACTING THE HOUSE BAND JOIST. LAG SCREWS AND BOLTS SHALL BE STAGGERED PER DETAIL 9.
DECK LEDGERS SHALL BE MINIMUM 2X8 PRESSURE-PRESERVATIVE-TREATED NO. 2 GRADE LUMBER, OR OTHER APPROVED MATERIALS AS ESTABLISHED BY STANDARD ENGINEERING PRACTICE. WHEN SOLID-SAWN PRESSURE-PRESERVATIVE-TREATED DECK LEDGERS ARE ATTACHED TO ENGINEERED WOOD PRODUCTS (MINIMUM 1" THICK WOOD STRUCTURAL PANEL BAND JOIST OR STRUCTURAL COMPOSITE LUMBER INCLUDING LAMINATED VENEER LUMBER), THE LEDGER ATTACHEMENT SHALL BE DESIGNED IN ACCORDANCE WITH ACCEPTED ENGINEERING PRACTICE. TABULATED VALUES BASED ON 300 LBS AND 350 LBS FOR 1" AND 1-1/8" EWP RIM BOARD, RESPECTIVELY. WOOD STRUCTURAL PANEL SHEATHING, GYPSUM BOARD SHEATHING, OR FOAM SHEATHING NOT EXCEEDING 1" THICKNESS SHALL BE PERMITTED. THE MAXIMUM DISTANCE BETWEEN THE FACE OF THE LEDGER BOARD AND FASTENER SPACING ALSO APPLIES TO SOUTHERN PINE, DOUGLAS FIR-LARCH, AND HEM-FIR BAND JOISTS. 9 LEDGER BOARD FASTENER SPACING AND CLEARANCES

SCALE: 1 1/2" = 1'-0"












13 GUARD POST TO OUTSIDE JOIST EXAMPLE SCALE: 3/4" = 1'-0"

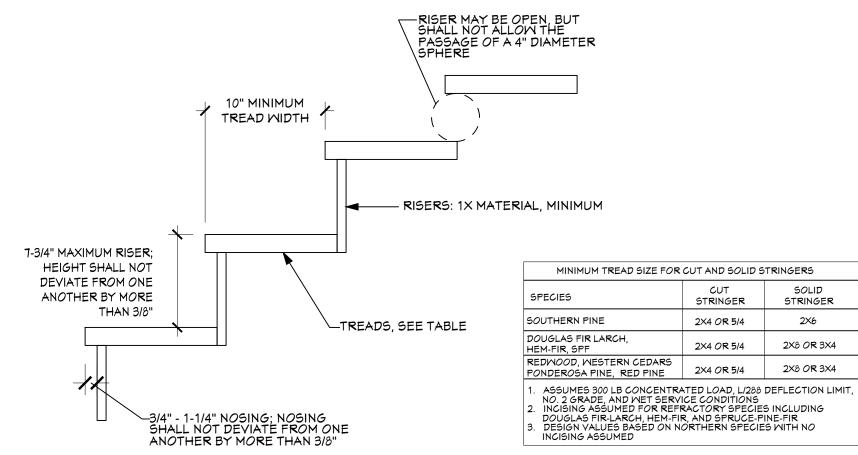


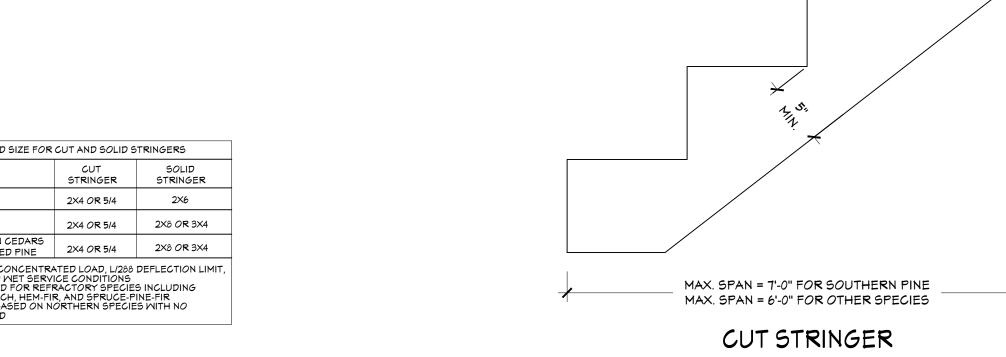

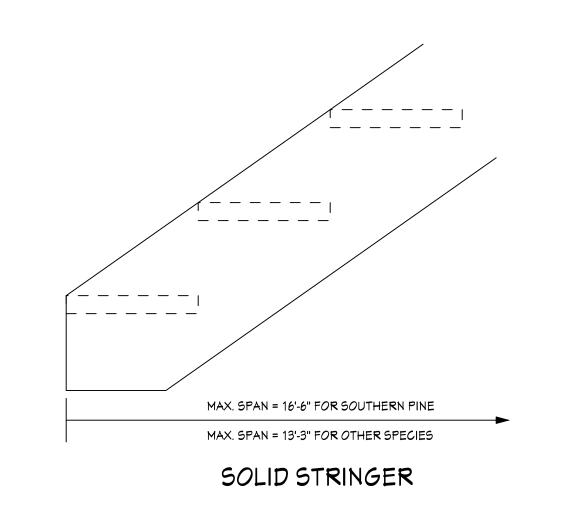






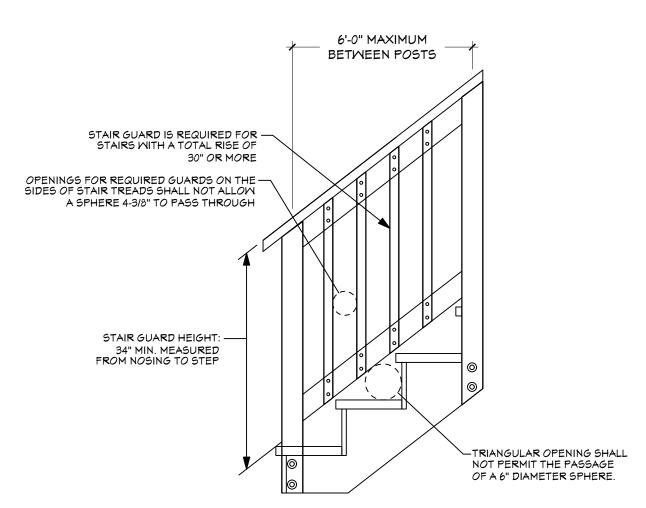


16 STAIR GUARD REQUIREMENTS

SCALE: 3/4" = 1'-0"

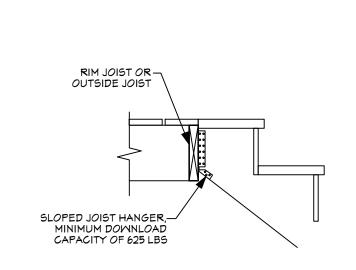

57 STAIR STRINGER ATTACHMENT DETAIL

SCALE: 3/4" = 1'-0"

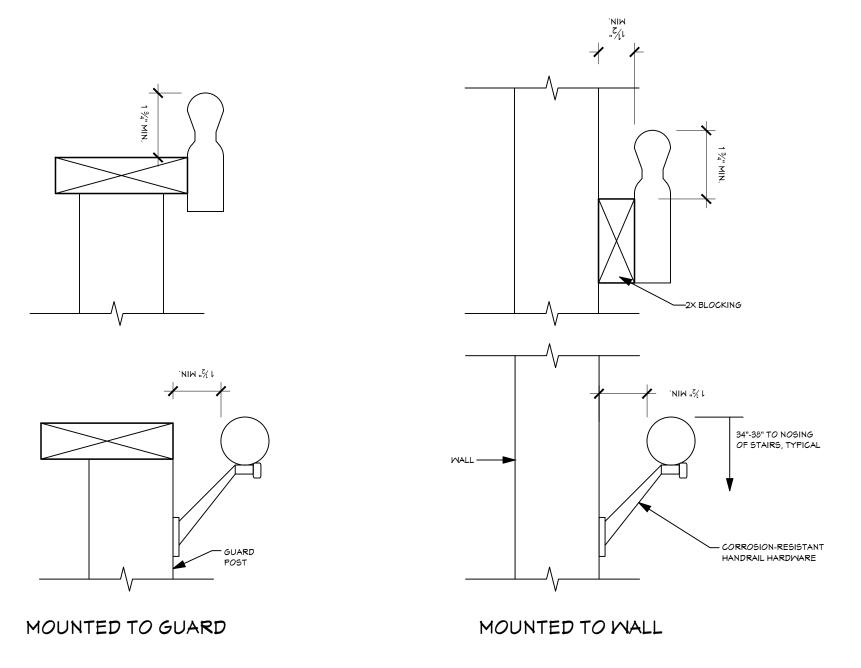

18 HANDRAIL MOUNTING EXAMPLES

SCALE: 3" = 1'-0"

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NEW SINGLE FAMILY RESIDENCE FOR HABITAT FOR HUMANITY

916 N. GRANDVIEW WAUKESHA, WISCO

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