

GENERAL NOTES:

1. Horizontal datum is NAD 1983/2011.

LEGEND

P0ST

UTILITY POLE

SEPTIC FACILITY

SEPTIC CLEANOUT

TV MANHOLE

INLET

WELL

(XXXXXX) RECORD DIMENSION

—OH— OVERHEAD POWER/UTILITY ——G——— UNDERGROUND GAS _____F____ UNDERGROUND ELECTRIC

_____C____ UNDERGROUND CABLE

— 1008 — EXISTING CONTOUR

——1008—— PROPOSED CONTOUR

FF 846.00 PROPOSED FLOOR GRADE

——SAN——— SANITARY SEWER ——ST——— STORM SEWER

----WM------ WATERMAIN

W ___x___ FENCE

GUY WIRE CULVERT UTILITY PEDESTAL ELECTRIC PEDESTAI

2. All site improvements and construction shown on the plans shall conform to the current City of Waukesha Design and Construction Manual. Where the plans do not comply, it shall be the sole responsibility and expense of the Developer to make revisions to the plans and/or constructed infrastructure to comply. Legend shown hereon in lue of call outs on individual sheets.

THE BOUNDARY & TOPOGRAPHIC SURVEY WAS PROVIDED BY CAPITOL SURVEY, INC. WHILE THIS INFORMATION IS BELIEVED TO BE RELIABLE. ITS ACCURACY AND COMPLETENESS CANNOT BE GUARANTEED NOR CERTIFIED TO.

GENERAL CONSTRUCTION SPECIFICATIONS:

All work shall be in accordance with the Standard Specifications for Highway and Structure Construction, State of Wisconsin, Latest Edition; the City of Waukesha Ordinances; and the State of Wisconsin Standard Specifications for Sewer and Water Construction in Wisconsin. All permits must be obtain by the DEVELOPER and CONTRACTOR prior to commencing work.

2. All erosion control measures specified on the project Erosion Control Plan shall meet the design criteria, standards and specifications as set forth in the Department of Natural Resources Wisconsin Technical Standards and City of Waukesha Ordinances.

3. All erosion control devices (i.e., silt fence, gravel entrance, etc.) shall be installed prior to commencing mass grading.

4. All activities on the site shall be conducted in a logical sequence to minimize the area of bare soil exposed at any one time. Haul off

excess topsoil. 5. The general contractor shall provide all surveying and construction staking for this contract. All contractors shall exercise care and

diligence in protecting the same.

6. The contractor shall notify Diggers Hotline, the local municipality and all government agencies that may be affected by the contractor's operations at least three (3) days before breaking ground.

7. Public roads shall not be closed to traffic at any time. All ingress and egress traffic to the project shall be limited to the gravel entrance to the property.

8. Contractor shall be responsible for maintaining the Public Roadways. The Public Roadways adjacent to this project shall be kept free of silt or dirt tracked from areas under construction by sweeping at the end of each work day or more often, as required. Dust generated by

construction activities shall be minimized by use of watering, construction scheduling or other appropriate methods. 9. Upon completion of the work as specified, respread gravel over all disturbed open space areas. 10. All disturbed areas shall be revegatated within 7 days of no disturbance. Highway mix #40 shall be used for seeding with an application

rate of 4.0 lbs/1000 sf. 11. All erosion control devices shall be routinely inspected every seven days or within 24 hours of a rainfall greater than 0.5 inches. (By CERTIFIED EROSION CONTROL INSPECTOR).

NOTES:

- 1. DISTURBED AREA = 13,070 S.F. (0.3 ACRES)
- 2. NET INCREASE IN IMPERVIOUS AREA = 0 S.F.
- 3. BASED ON THE ABOVE VALUES, STORM WATER MANAGEMENT IS NOT REQUIRED FOR THIS PROJECT.



MISCONSIN MARK R ELLENA E-24090 WALES, WI Mail Excens DATE: 11-01-25 Y: MARK R. ELLENA,PE

IRON & CITY

ENGIN

5

AINA


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RADIN

SCALE: 1" = 30'SHEET NUMBER

C100



Timothy Seidel Architect LLC

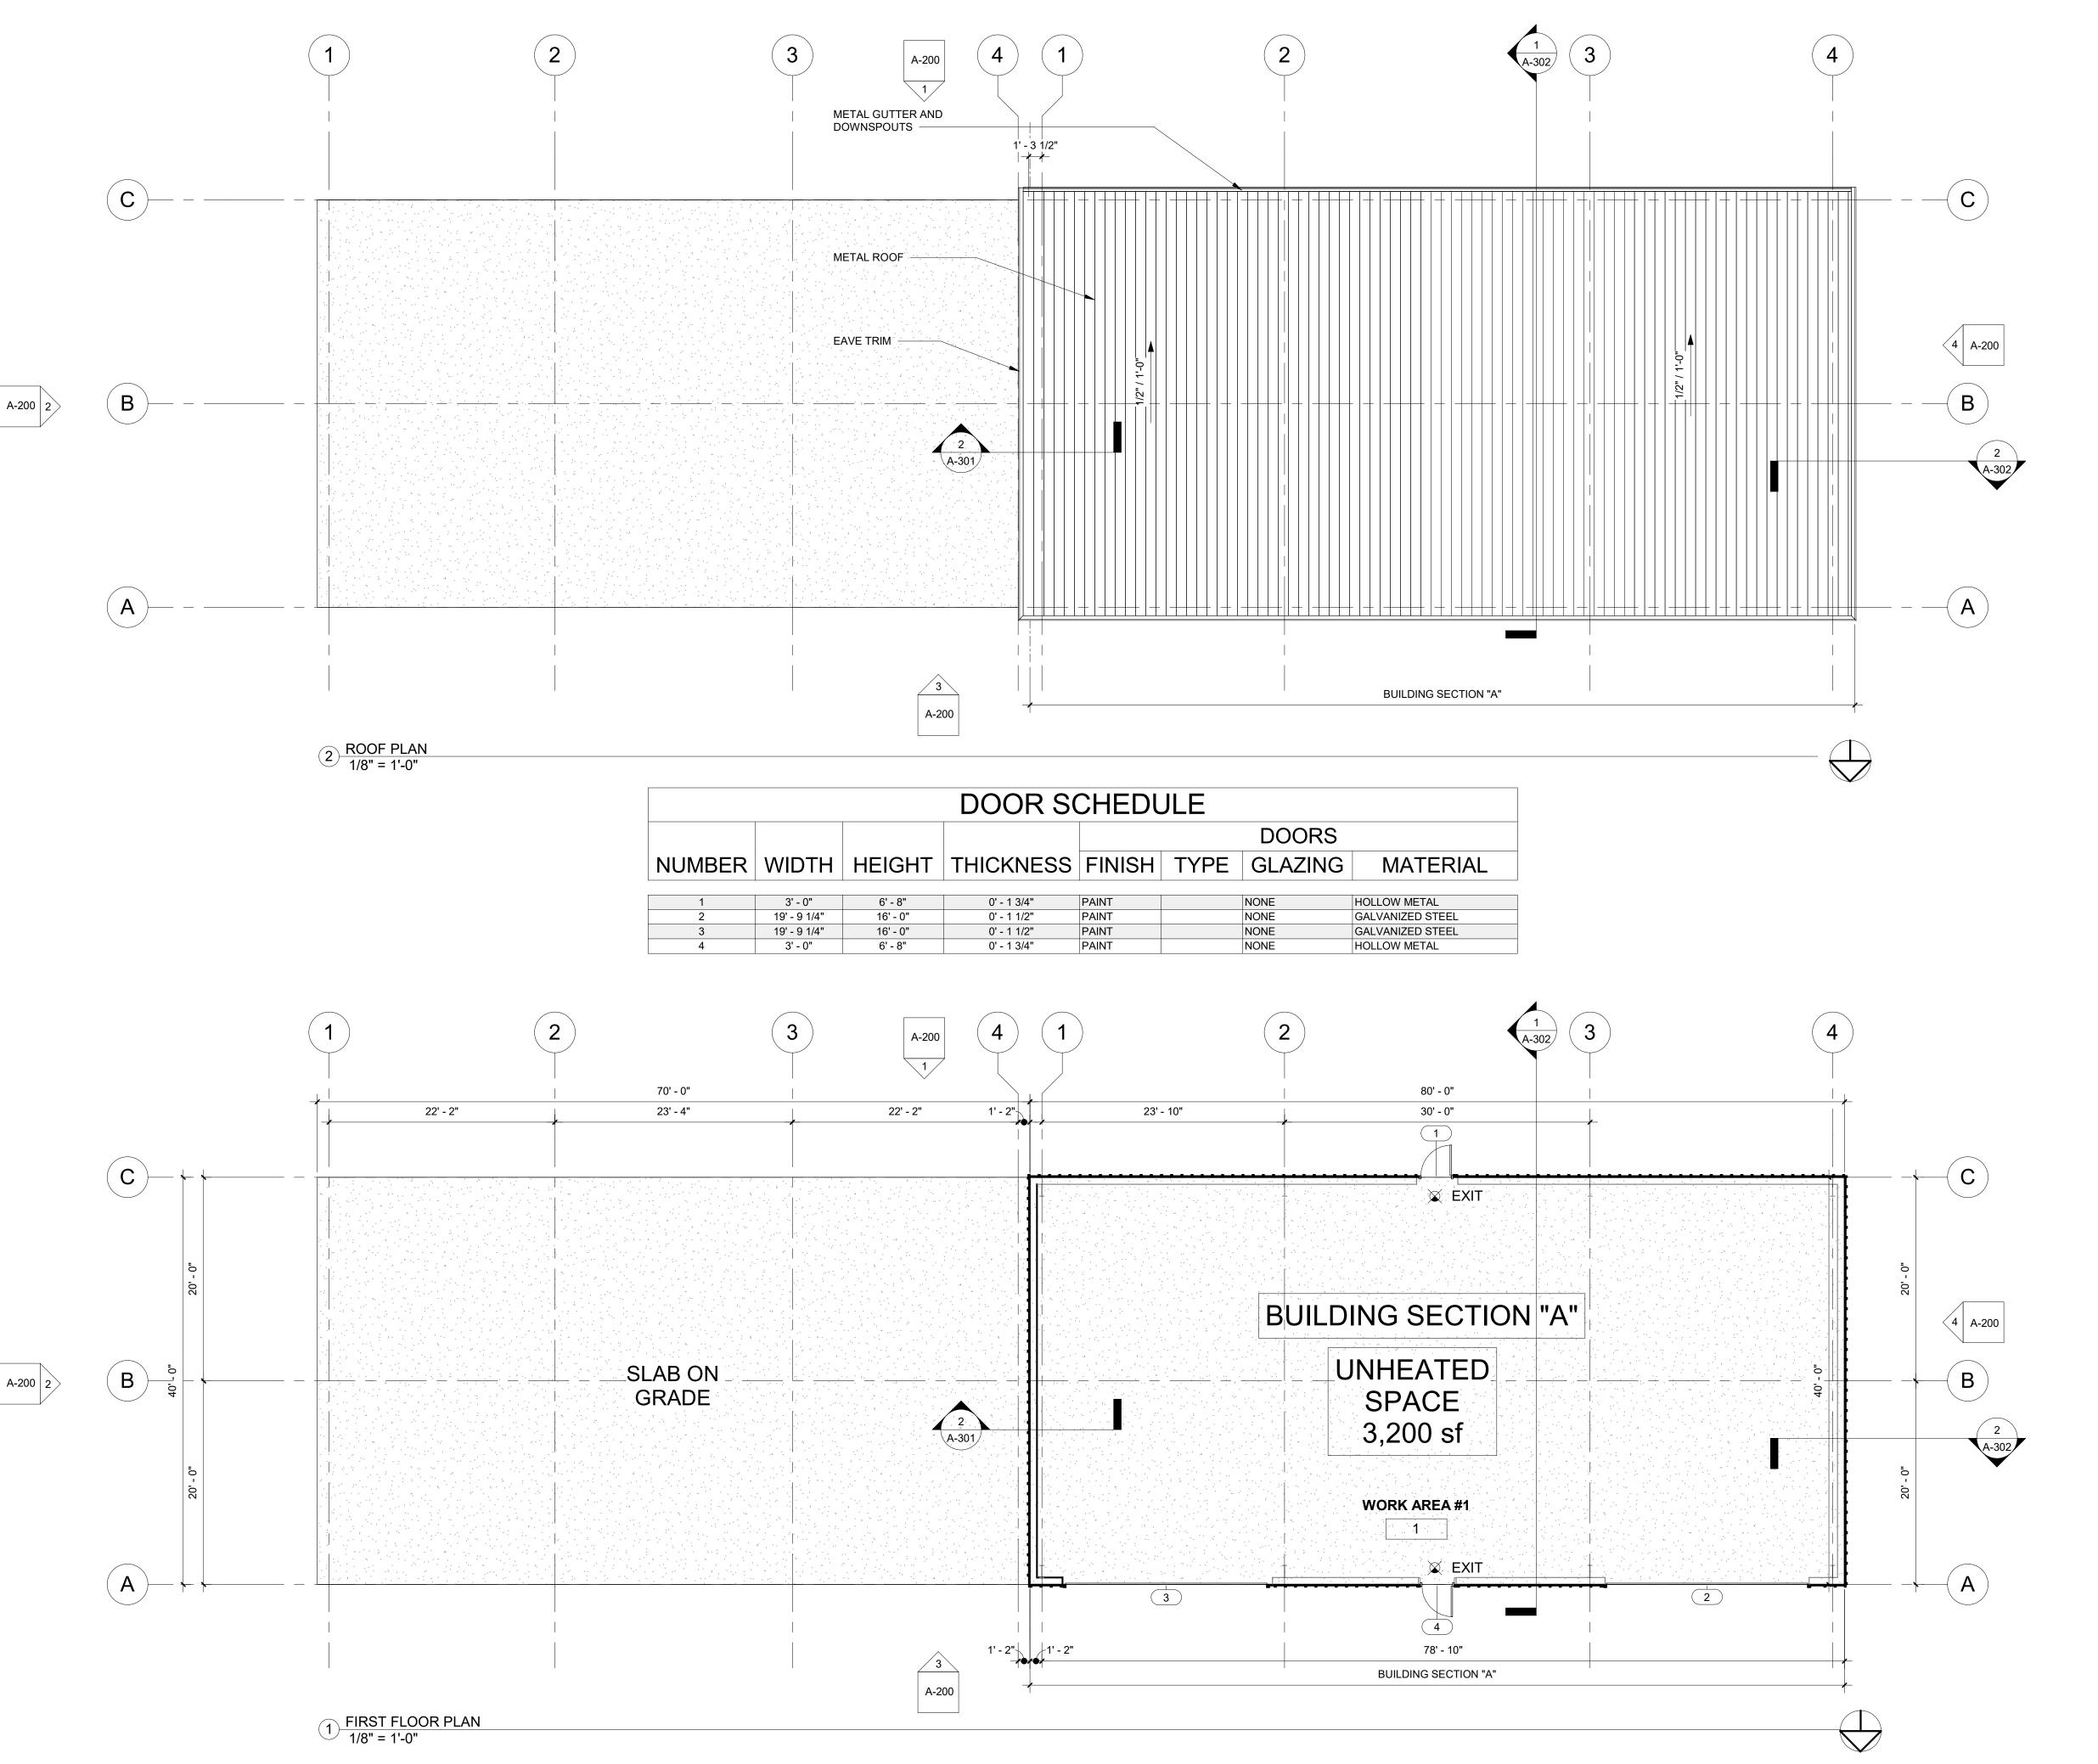530 Cymric Court Wales, WI 53183-9423

(262) 968-5580 office (262) 424-5795 direct tim@timseidelarchitect.com These Plans are the property of Timothy Seidel Architect LLC. Any unauthorized use or reproduction is a violation of the Copy Protection Act of 1990

Ford Construction Co., Inc. **General Contractors Construction Managers** 1419 Poplar Drive Waukesha, WI 53188

262-896-9370 262-896-9371 fax E-Mail: fordcon@tds.net

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REVISIONS: No. Description September 26, 2025 File Number: FINES Sheet Number :

A-101



Ford Construction Co., Inc. General Contractors Construction Managers

> 1419 Poplar Drive Waukesha, WI 53188 262-896-9370 262-896-9371 fax E-Mail: fordcon@tds.net

HAUKESHA IKON & METAL FINES BUILDING 1351 EAST MAIN STREET

RE	VISI	ONS :	
No.	Description		Date
Date :		September 26, 2025	
Scale :		As Noted	
File	Number	r: FINES	
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Project :		202504	
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SECTION THRU END WALL & SLAB ON

GRADE

3/8" = 1'-0"

HA IRON & METAL

ES BUILDING

AST MAIN STREET

(ESHA, WI 53186)

Timothy Seidel Architect LLC

530 Cymric Court
Wales, WI 53183-9423

(262) 968-5580 office
(262) 424-5795 direct
tim@timseidelarchitect.com

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Ford Construction Co., Inc.
General Contractors
Construction Managers

1419 Poplar Drive Waukesha, WI 53188

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Date: September 26, 2025

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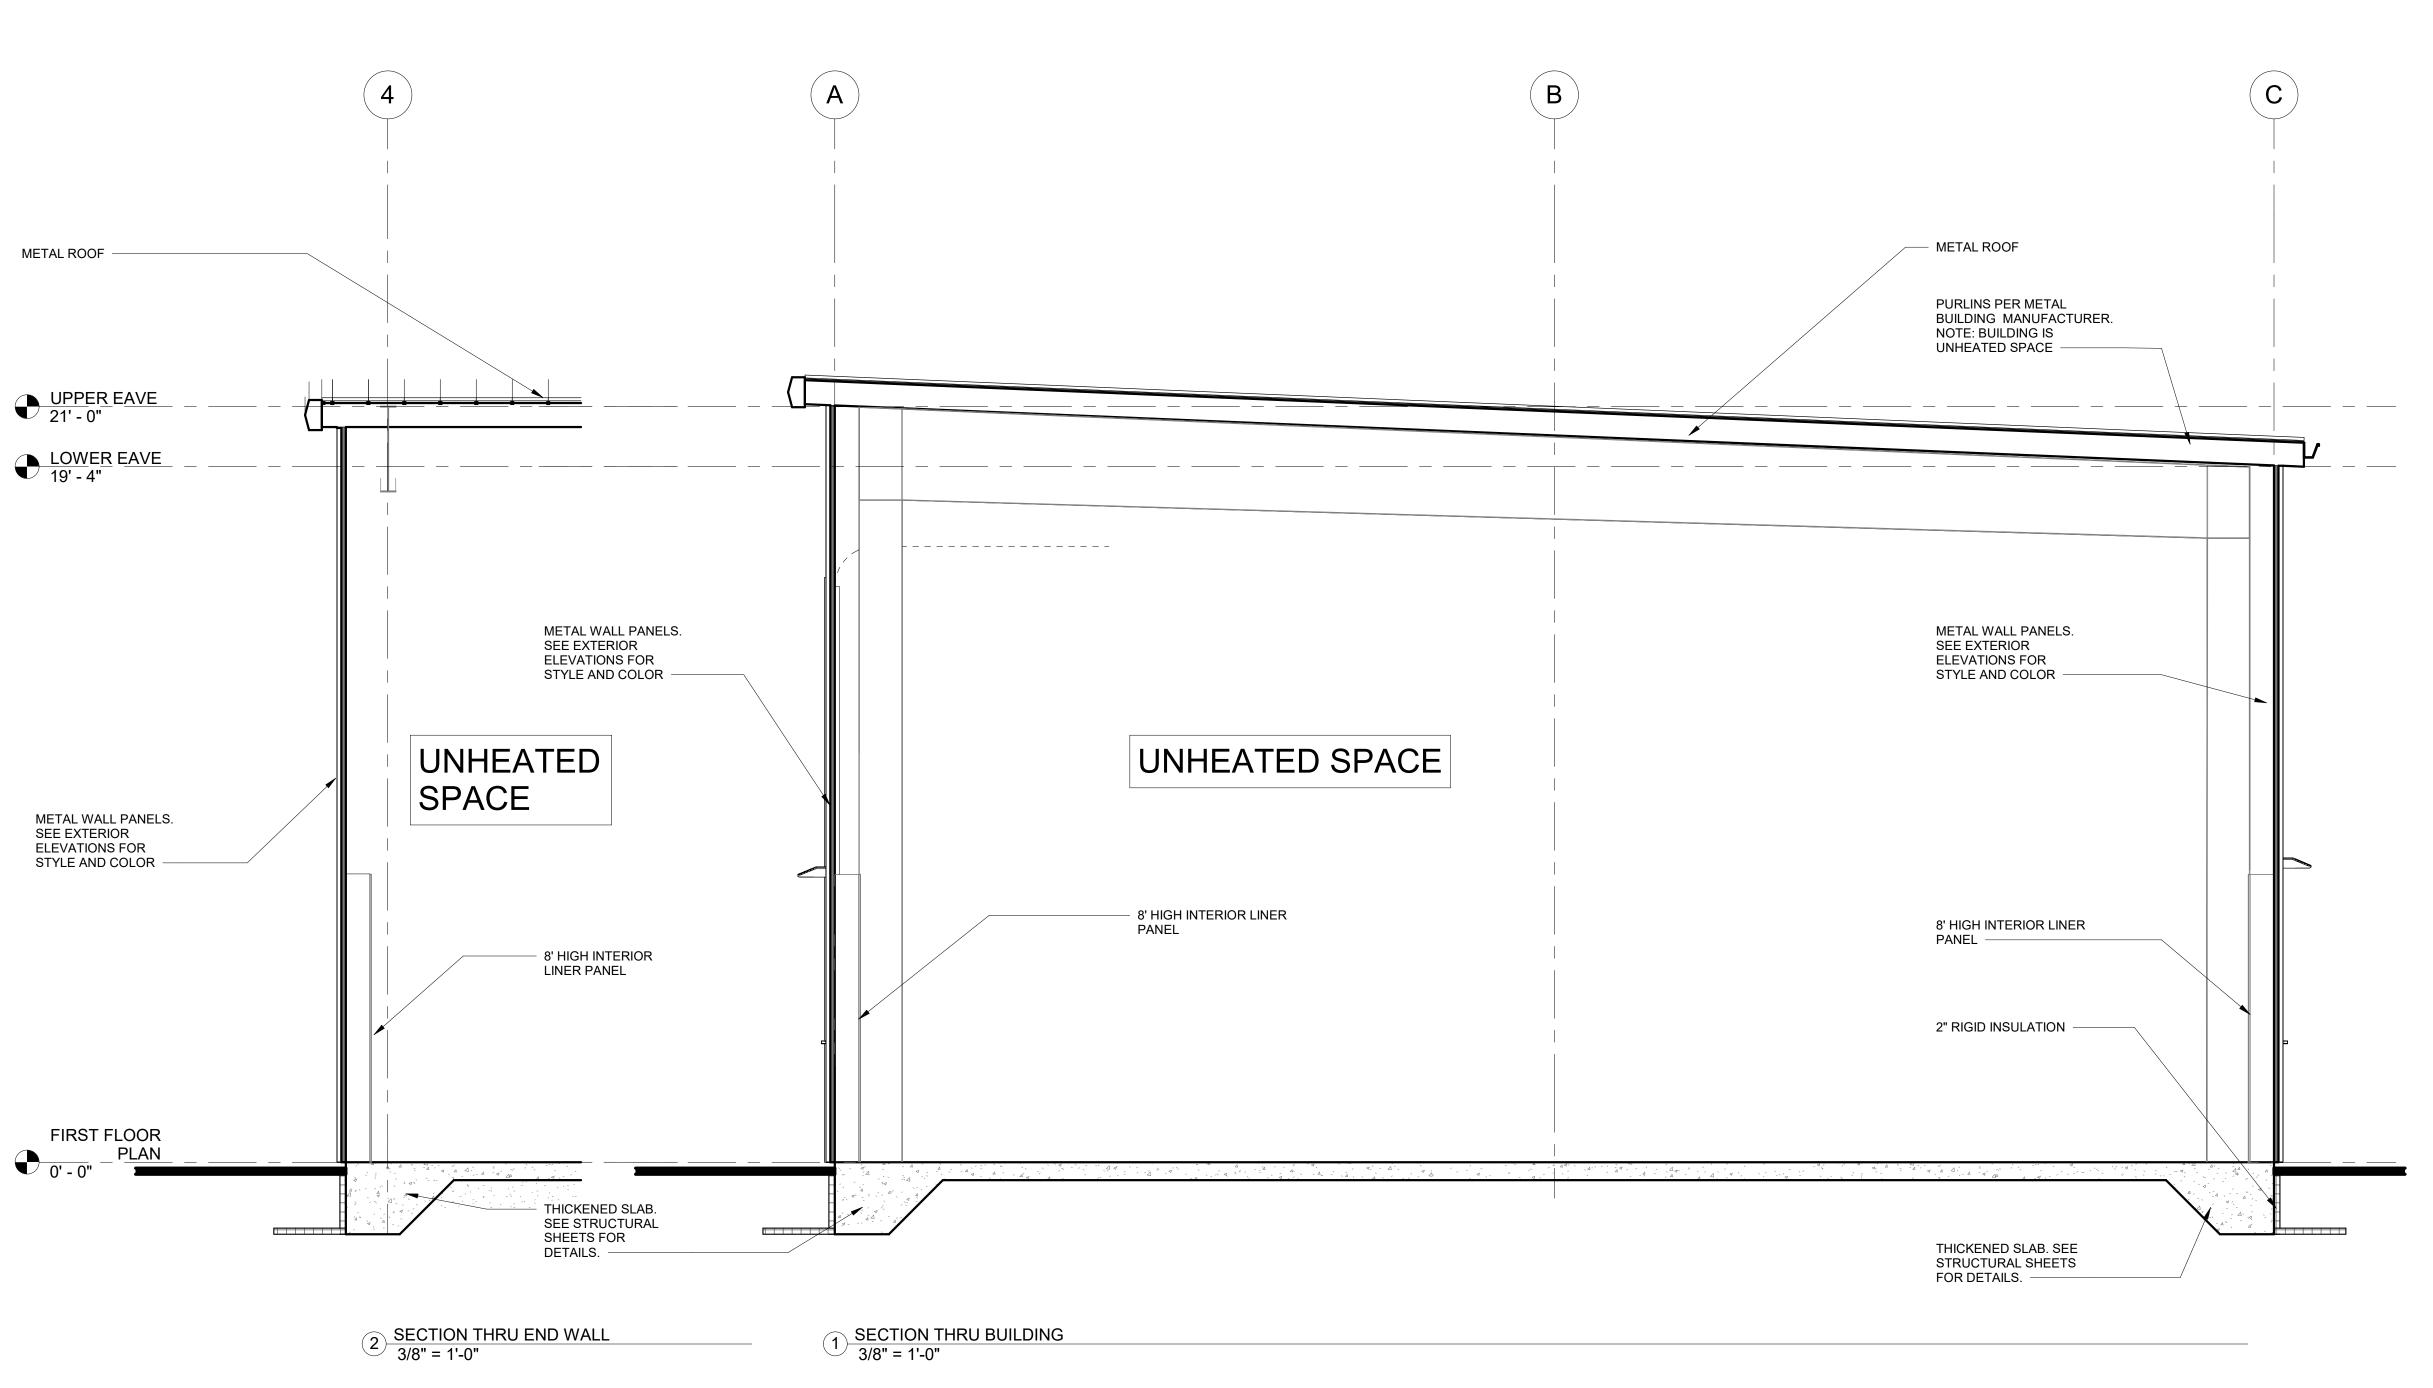
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Ford Construction Co., Inc. **General Contractors Construction Managers**

> 1419 Poplar Drive Waukesha, WI 53188 262-896-9370 262-896-9371 fax

E-Mail: fordcon@tds.net

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A-302

Sheet Number:

GENERAL NOTES

- 1. COMPLY WITH THE IBC 2009 & MODIFICATIONS SPECIFIED IN THE WISCONSIN COMMERCIAL BUILDING CODE CHAPTERS COMM. 61 & COMM. 62 AND ALL OTHER GOVERNING CODES.
- 2. THE CONTRACTOR SHALL VERIFY ALL EXISTING CONDITIONS AND DIMENSIONS AND SUBMIT TO THE ENGINEER FOR REVIEW A WRITTEN REPORT INDICATING ACTUAL FIELD CONDITIONS WHICH MAY VARY FROM INFORMATION INDICATED ON DRAWINGS.
- 3. SUBMIT ERECTION AND DETAIL DRAWINGS OF ALL STRUCTURAL MATERIALS AND CONNECTIONS FOR
- 4. THE FOLLOWING MATERIAL & METHODS OF CONSTRUCTION SHALL BE SUBJECT TO INSPECTION IN ACCORDANCE WITH IBC 2009:
 - 2. HIGH STRENGTH BOLTING
 - 3. STEEL FRAME JOINT DETAILS
- 5. REINFORCEMENT 6. PRE-FABRICATED WOOD STRUCTURAL ELEMENTS MASONRY

GENERAL FOUNDATION NOTES

- 1. ALL FOUNDATION FOOTINGS SHALL BE PLACED ON SOIL WITH A MINIMUM BEARING CAPACITY OF 3000 PSF AS VERIFIED AND ACCEPTED BY THE OWNER'S GEOTECHNICAL CONSULTANT.
- 2. ALL FOOTINGS TO BE PLACED 4'-0" MIN. BELOW ADJACENT EXTERIOR GRADE.

OWNER'S TESTING AGENCY AFTER REMOVAL OF WATER OR FROST.

CONCRETE

- 3. THE SUBGRADE FOR ALL FOOTINGS, WALLS AND SLABS SHALL BE INSPECTED AND ACCEPTED BY THE OWNER'S TESTING AGENCY IMMEDIATELY PRIOR TO PLACING FOUNDATION CONCRETE.
- 4. ALL UNSUITABLE MATERIALS SHALL BE REMOVED FROM SUBGRADE AND BACKFILL AREAS AND BACKFILLED WITH ACCEPTABLE FILL ACCORDING TO THE SPECIFICATION.
- 5. BACKFILL AGAINST WALLS EVENLY. ALL SUPPORTING SLABS SHOULD BE IN PLACE AND THE CONCRETE SHOULD HAVE THE 28 DAY DESIGN STRENGTH.
- 6. NO FOOTINGS, SLABS, OR MUD SLABS SHALL BE PLACED INTO OR AGAINST SUBGRADE CONTAINING FREE WATER, FROST OR ICE. SHOULD WATER OR FROST ENTER A FOOTING EXCAVATION AFTER SUBGRADE APPROVAL, THE SUBGRADE SHALL BE RE-INSPECTED BY THE
- 7. THE CONTRACTOR SHALL PROVIDE ALL NECESSARY MEASURES TO PREVENT ANY FROST OR ICE FROM PENETRATING ANY FOOTING, OR SLAB SUBGRADE BEFORE AND AFTER PLACING CONCRETE AND UNTIL SUCH SUBGRADES ARE FULLY PROTECTED BY THE PERMANENT BUILDING ENCLOSURE.
- 8. THE SLABS SHALL BE PLACE OVER A 6 MIL VAPOR BARRIER, LAPPED 12 INCHES AT SEAMS AND TAPED OVER 6 INCHES MINIMUM OF COMPACTED COARSE DRAINAGE MATERIAL. STONE SHALL COMPLY WITH THE RECOMMENDATIONS GIVEN IN THE GEOTECHNICAL REPORT PREPARED BY THE OWNER'S GEOTECHNICAL CONSULTANT.

EXCAVATION AND UNDERPINNING NOTES

- 1. ALL EXCAVATION SHALL COMPLY WITH OSHA REQUIREMENTS
- 2. GROUND WATER MAY BE ENCOUNTERED. PROVIDE DEWATERING AS NECESSARY.
- 3. THE PERIMETER OF THE GENERAL EXCAVATION SHALL BE RETAINED BY A TEMPORARY SOIL/ROCK RETENTION SYSTEM AS REQUIRED. THE DESIGN, INSTALLATION, MAINTENANCE AND REMOVAL (WHERE REQUIRED) SHALL BE THE COMPLETE AND SOLE RESPONSIBILITY OF THE CONTRACTOR. THE CONTRACTOR SHALL PROVIDE ALL MEASURES AND PRECAUTIONS NECESSARY TO PREVENT DAMAGE AND SETTLEMENT OF EXISTING OR NEW CONSTRUCTION INSIDE OR OUTSIDE OF THE PROJECT LIMITS. ANY DAMAGE TO NEW OR EXISTING CONSTRUCTION INSIDE OR OUTSIDE OF THE PROJECT LIMITS.CAUSED BY CONSTRUCTION TECHNIQUES OR MOVEMENTS OF THE SOIL RETENTION SYSTEM, IS THE RESPONSIBILITY OF
- 4. THE CONTRACTOR SHALL COORDINATE ALL ELEMENTS OF THE SOIL RETENTION SYSTEM WITH ALL ELEMENTS OF THE PERMANENT BUILDING.
- 5. ALL EXCAVATION SHALL BE BASED ON ENGINEERED DRAWINGS PREPARED BY A PROFESSIONAL ENGINEER REGISTERED IN THE STATE OF WISCONSIN AND RETAINED BY THE CONTRACTOR. THE DRAWINGS SHALL INCLUDE PLANS AND SECTIONS OF EXCAVATION SEQUENCES. THE EXCAVATION SEQUENCES SHALL BE CONTROLLED TO MATCH THE REQUIREMENTS OF THE DESIGN OF THE SOIL RETENTION SYSTEM. THE DESIGN EARTH AND HYDRAULIC PRESSURES WILL BE REVIEWED BY THE OWNER'S GEOTECHNICAL REPRESENTATIVE.
- 6. THE EXCAVATIONS FOR SPREAD FOOTINGS, GRADE BEAMS, PITS, ETC., SHALL BE EXCAVATED ON AN INDIVIDUAL, LOCALIZED BASIS DOWN FROM THE SUBGRADE LEVEL. EACH EXCAVATION SHALL BE A
- 7. THE CONTRACTOR SHALL PROVIDE POSITIVE PROTECTION (MAT/SHEET COVERINGS) FOR ALL EXCAVATION SLOPES TO PROTECT SLOPES FROM INSTABILITY AND DETERIORATION DUE TO RAIN, WIND OR SNOW.
- 8. THE CONTRACTOR SHALL PROVIDE SURFACE DRAINAGE CHANNELS, SUMPS AND SUMP PUMPS TO PROTECT ALL EXCAVATIONS FROM FLOODING. FLOODING OF ANY EXCAVATION AFTER APPROVAL OF THE SUBGRADE WILL BE CAUSE FOR COMPLETE REDOING OF THE SUBGRADE AND WILL REQUIRE APPROVAL OF THE SUBGRADE.
- 9. THE CONTRACTOR SHALL SUBMIT THE RETENTION SYSTEM DESIGN, EXCAVATION SEQUENCES AND TECHNIQUES AND DEWATERING SYSTEM FOR REVIEW BY THE OWNER'S GEOTECHNICAL ENGINEER.

STRUCTURAL CONCRETE NOTES

- 1. PROVIDE CAST-IN-PLACE CONCRETE OF THE TYPES AND MINIMUM 28-DAY COMPRESSIVE STRENGTHS AS SHOWN ON THE CONCRETE MATERIALS SCHEDULE, THIS SHEET.
- 2. STRUCTURAL CONCRETE SHALL CONTAIN A WATER REDUCING, PLASTICIZING ADMIXTURE. APPROVED, HIGH-RANGE WATER REDUCING ADMIXTURES MAYBE UTILIZED. ALL CONCRETE PERMANENTLY EXPOSED TO THE WEATHER (AND WITHIN 4 FEET OF FINISHED GRADE) SHALL CONTAIN AND AIR-ENTRAINING ADMIXTURE. THE MAXIMUM WATER ALL CONCRETE SHALL BE 0.5. CONTRACTOR TO SUBMIT A DESIGN MIX FOR EACH TYPE AND STRENGTH OF CONCRETE IN ACCORDANCE WITH ACI 318 FOR REVIEW AND APPROVAL OF THE ENGINEER.
- 3. ALL REINFORCING BARS SHALL BE NEW BILLET STEEL CONFORMING TO THE STANDARDS OF ASTM A615, GRADE 60.
- 4. ALL CONCRETE REINFORCEMENT SHALL BE DETAILED, FABRICATED, LABELED, SUPPORTED AND SPACED IN FORMS AND SECURED IN PLACE IN ACCORDANCE WITH THE PROCEDURES AND REQUIREMENTS OUTLINED IN THE LATEST EDITION OF THE "BUILDING CODE REQUIREMENTS FOR REINFORCED CONCRETE", ACI 318 AND THE "MANUAL OF STANDARD PRACTICE FOR DETAILING REINFORCED CONCRETE STRUCTURES", ACI 315.


- 5. CHECKED SHOP DRAWINGS SHOWING REINFORCING DETAILS, INCLUDING STEEL SIZES, AND PLACEMENT, SHALL BE SUBMITTED TO THE ENGINEER FOR REVIEW PRIOR TO FABRICATION.
- 6. THE CONTRACTOR SHALL SUBMIT DETAILED DRAWINGS SHOWING THE LOCATIONS OF ALL CONSTRUCTION JOINTS, CURBS, SLAB DEPRESSIONS, SLEEVES, OPENINGS, ETC.
- 7. REINFORCING SPLICES AND DEVELOPMENT LENGTHS SHALL CORRESPOND TO ACI 318, AS NOTED IN THE DRAWINGS AND AS LISTED AS A MINIMUM IN THE FOLLOWING TABLE:
- LAP SPLICE (IN) (MIN.) BAR SIZE LAP SPLICE (IN) (MIN.)

SURFACES SHALL BE PLASTIC TIPPED.


- 8. WHERE REQUIRED, DOWELS SHALL MATCH SIZE AND NUMBER OF MAIN REINFORCING.
- 9. PROVIDE ADDITIONAL BARS AROUND ALL FLOOR AND WALL OPENINGS. ALL WELDED WIRE FABRIC SHALL BE LAPPED TWO (2) FULL MESH PANELS AND TIED 10. ALL BAR SUPPORTS SHALL BE GALVANIZED. BAR SUPPORTS IN CONTACT WITH EXPOSED
- 11. BEAM AND SLABS SHALL NOT BE BOXED OUT OR SLEEVED OR HAVE THE REINFORCING
- INTERRUPTED EXCEPT AS SHOWN ON THE STRUCTURAL DRAWINGS.

12. ALL WELDED WIRE FABRIC SHALL CONFORM TO THE STANDARDS OF ASTM A185.

- 14. ALL CONSTRUCTION JOINTS SHALL BE CLEANED AND MOISTENED IMMEDIATELY PRIOR TO PLACING NEW CONCRETE. REFER TO ARCHITECTURAL DRAWINGS FOR WATER STOP AND WATERPROOFING DETAILS.
- 15. SEE ARCHITECTURAL DRAWINGS FOR TYPE AND LOCATION OF ALL FLOOR FILL FINISHES, FLOOR DEPRESSIONS AND CURBS.
- 16. PLACE SLABS-ON-GRADE IN ACCORDANCE WITH ACI 302 "GUIDE FOR CONCRETE FLOOR AND SLAB CONSTRUCTION.
- 17. SEE ARCHITECTURAL, HVAC, ELECTRICAL AND PLUMBING DRAWINGS FOR SLAB OPENINGS.
- 18. SEE ARCHITECTURAL DRAWINGS FOR ALL WATERPROOFING/DAMPROOFING DETAILS.
- 19. THE CONTRACTOR SHALL INSTRUMENT CHECK ALL FORMWORK FOR COMPLIANCE WITH ACI SPECIFIED TOLERANCES PRIOR TO PLACEMENT OF THE CONCRETE THEREON.
- 20. GROUT SHALL BE NON-SHRINK, NON-METALLIC, "FIVE STAR GROUT" BY U.S. GROUT, OR EQUAL.
- 21. "CAST-IN-PLACE CONCRETE" TO BE: SLAB ON GRADE 4000 PSI 145 PCF FIBERGLASS 3000 PSI 145 PCF FOOTINGS
- INTERIOR CONCRETE FILL AND 3000 PSI 115 PCF MISCELLANEOUS CONCRETE
- 22. MECHANICAL BAR SPLICERS, COUPLING AND HALF COUPLING SHALL DEVELOP 125% Fy TIMES THE AREA OF THE ATTACHED BAR.
- 23. BEAMS ARE EQUALLY SPACED BETWEEN COLUMN LINES, UNLESS OTHERWISE NOTED.
- 24. SEE SPECIFICATION SECTION "CAST-IN-PLACE CONCRETE FOR ADDITIONAL REQUIREMENTS.
- 25. NO CALCIUM CHLORIDE SHALL BE USED IN ANY CONCRETE.

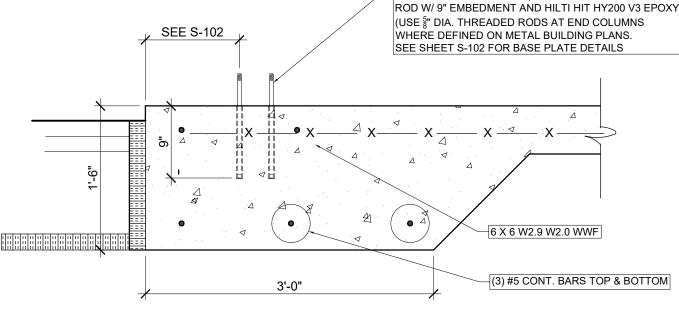

ANCHOR BOLT DETAIL Scale: 1" = 1'-0"

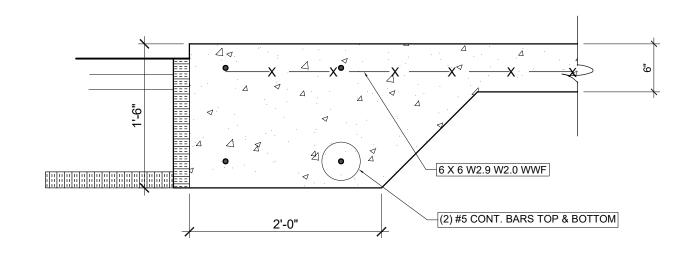

TYPICAL SLAB EDGE

Scale: 1" = 1'-0"

TYPICAL ANCHOR BOLT - $\frac{3}{4}$ " DIA. A36 STEEL THREADED

26. CONCRETE SEALER SHALL BE COMPATIBLE W/ APPROVED FLOOR FINISHES. <u>S-103</u> S-103 S-102 S-102 S-103/ S-102 \S-103/

FOOTING SCHEDULE

TYPICAL GRADE BEAM - 18" HIGH X 2'-0" WIDE (@ BOTTOM) 36" X 36" X 18" PAD FOOTING

36" X 72" X 18" PAD FOOTING

REINFORCEMENT (2) #5's CONT. REINF. BARS TOP & BOTTOM (4) #5's REINF. BARS TOP & BOTTOM (3) #5 BOTTOM BARS LONG DIRECTION & (6) #5 BOTTOM BARS SHORT DIRECTION AND

* NOTATION REFVERENCES COLUMN DETAILS - SEE S-102 FOR **ANCHOR BOLT & COLUMN DETAILS**

TOP LONG BARS TO BE (4) #5 PLUS (1) #5 U BAR TO WRAP AROUND ANCHOR BOLTS.

S-102 -(1) #5 BAR @ BUMPOUT FOOTING (TYP.) (4) #5's STRAIGHT TOP & BOTTOM -(4) #5's STRAIGHT TOP & BOTTOM-BARS & (1) #5 U SHAPED TOP & BARS & (1) #5 U SHAPED TOP & BOTTOM BARS BEHIND ANCHOR BOLTS. EXTEND TOP BARS OUT 48" BOTTOM BARS BEHIND ANCHOR S-102 BOLTS. EXTEND TOP BARS OUT 48" \S-103/ BEYOND FACE OF FOOTING. BEYOND FACE OF FOOTING. (1) #5 BAR @ BUMPOUT FOOTING (TYP.) -(4) #5's STRAIGHT TOP & BOTTOM — -(4) #5's STRAIGHT TOP & BOTTOM-\S-103 BARS & (1) #5 U SHAPED TOP & BARS & (1) #5 U SHAPED TOP & -(1) #5 BAR @ BUMPOUT FOOTING BOTTOM BARS BEHIND ANCHOR BOTTOM BARS BEHIND ANCHOR \S-102/ BOLTS. EXTEND TOP BARS OUT 48' BOLTS. EXTEND TOP BARS OUT 48" BEYOND FACE OF FOOTING. BEYOND FACE OF FOOTING. -(1) #5 BAR @ BUMPOUT FOOTING (1) #5 BAR @ BUMPOUT FOOTING 5 S-102 9 S-102/ S-102 \S-102/ S-103 S-103/ \S-103/ S-103

FOUNDATION PLAN



CITY OF WAUKESHA SUBMITTAL - 9.26.2025

Timothy Seidel

Architect LLC

530 Cymric Court

(262) 424-5797 direct

tim@timseidelarchitect.cor

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CONSTRUCTION

Ford Construction Co., Inc.

General Contractors

Construction Managers

1419 Poplar Drive

Waukesha, WI 53188

262-896-9370 262-896-9371 fax

E-Mail: fordcon@tds.net

Wales, WI 53183-9423


(262) 968-5580 office

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202504 Project: Sheet Number S-101



Timothy Seidel
Architect LLC
530 Cymric Court
Wales, WI 53183-9423
(262) 968-5580 office
(262) 424-5797 direct
tim@timseidelarchitect.com

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Ford Construction Co., Inc.
General Contractors
Construction Managers

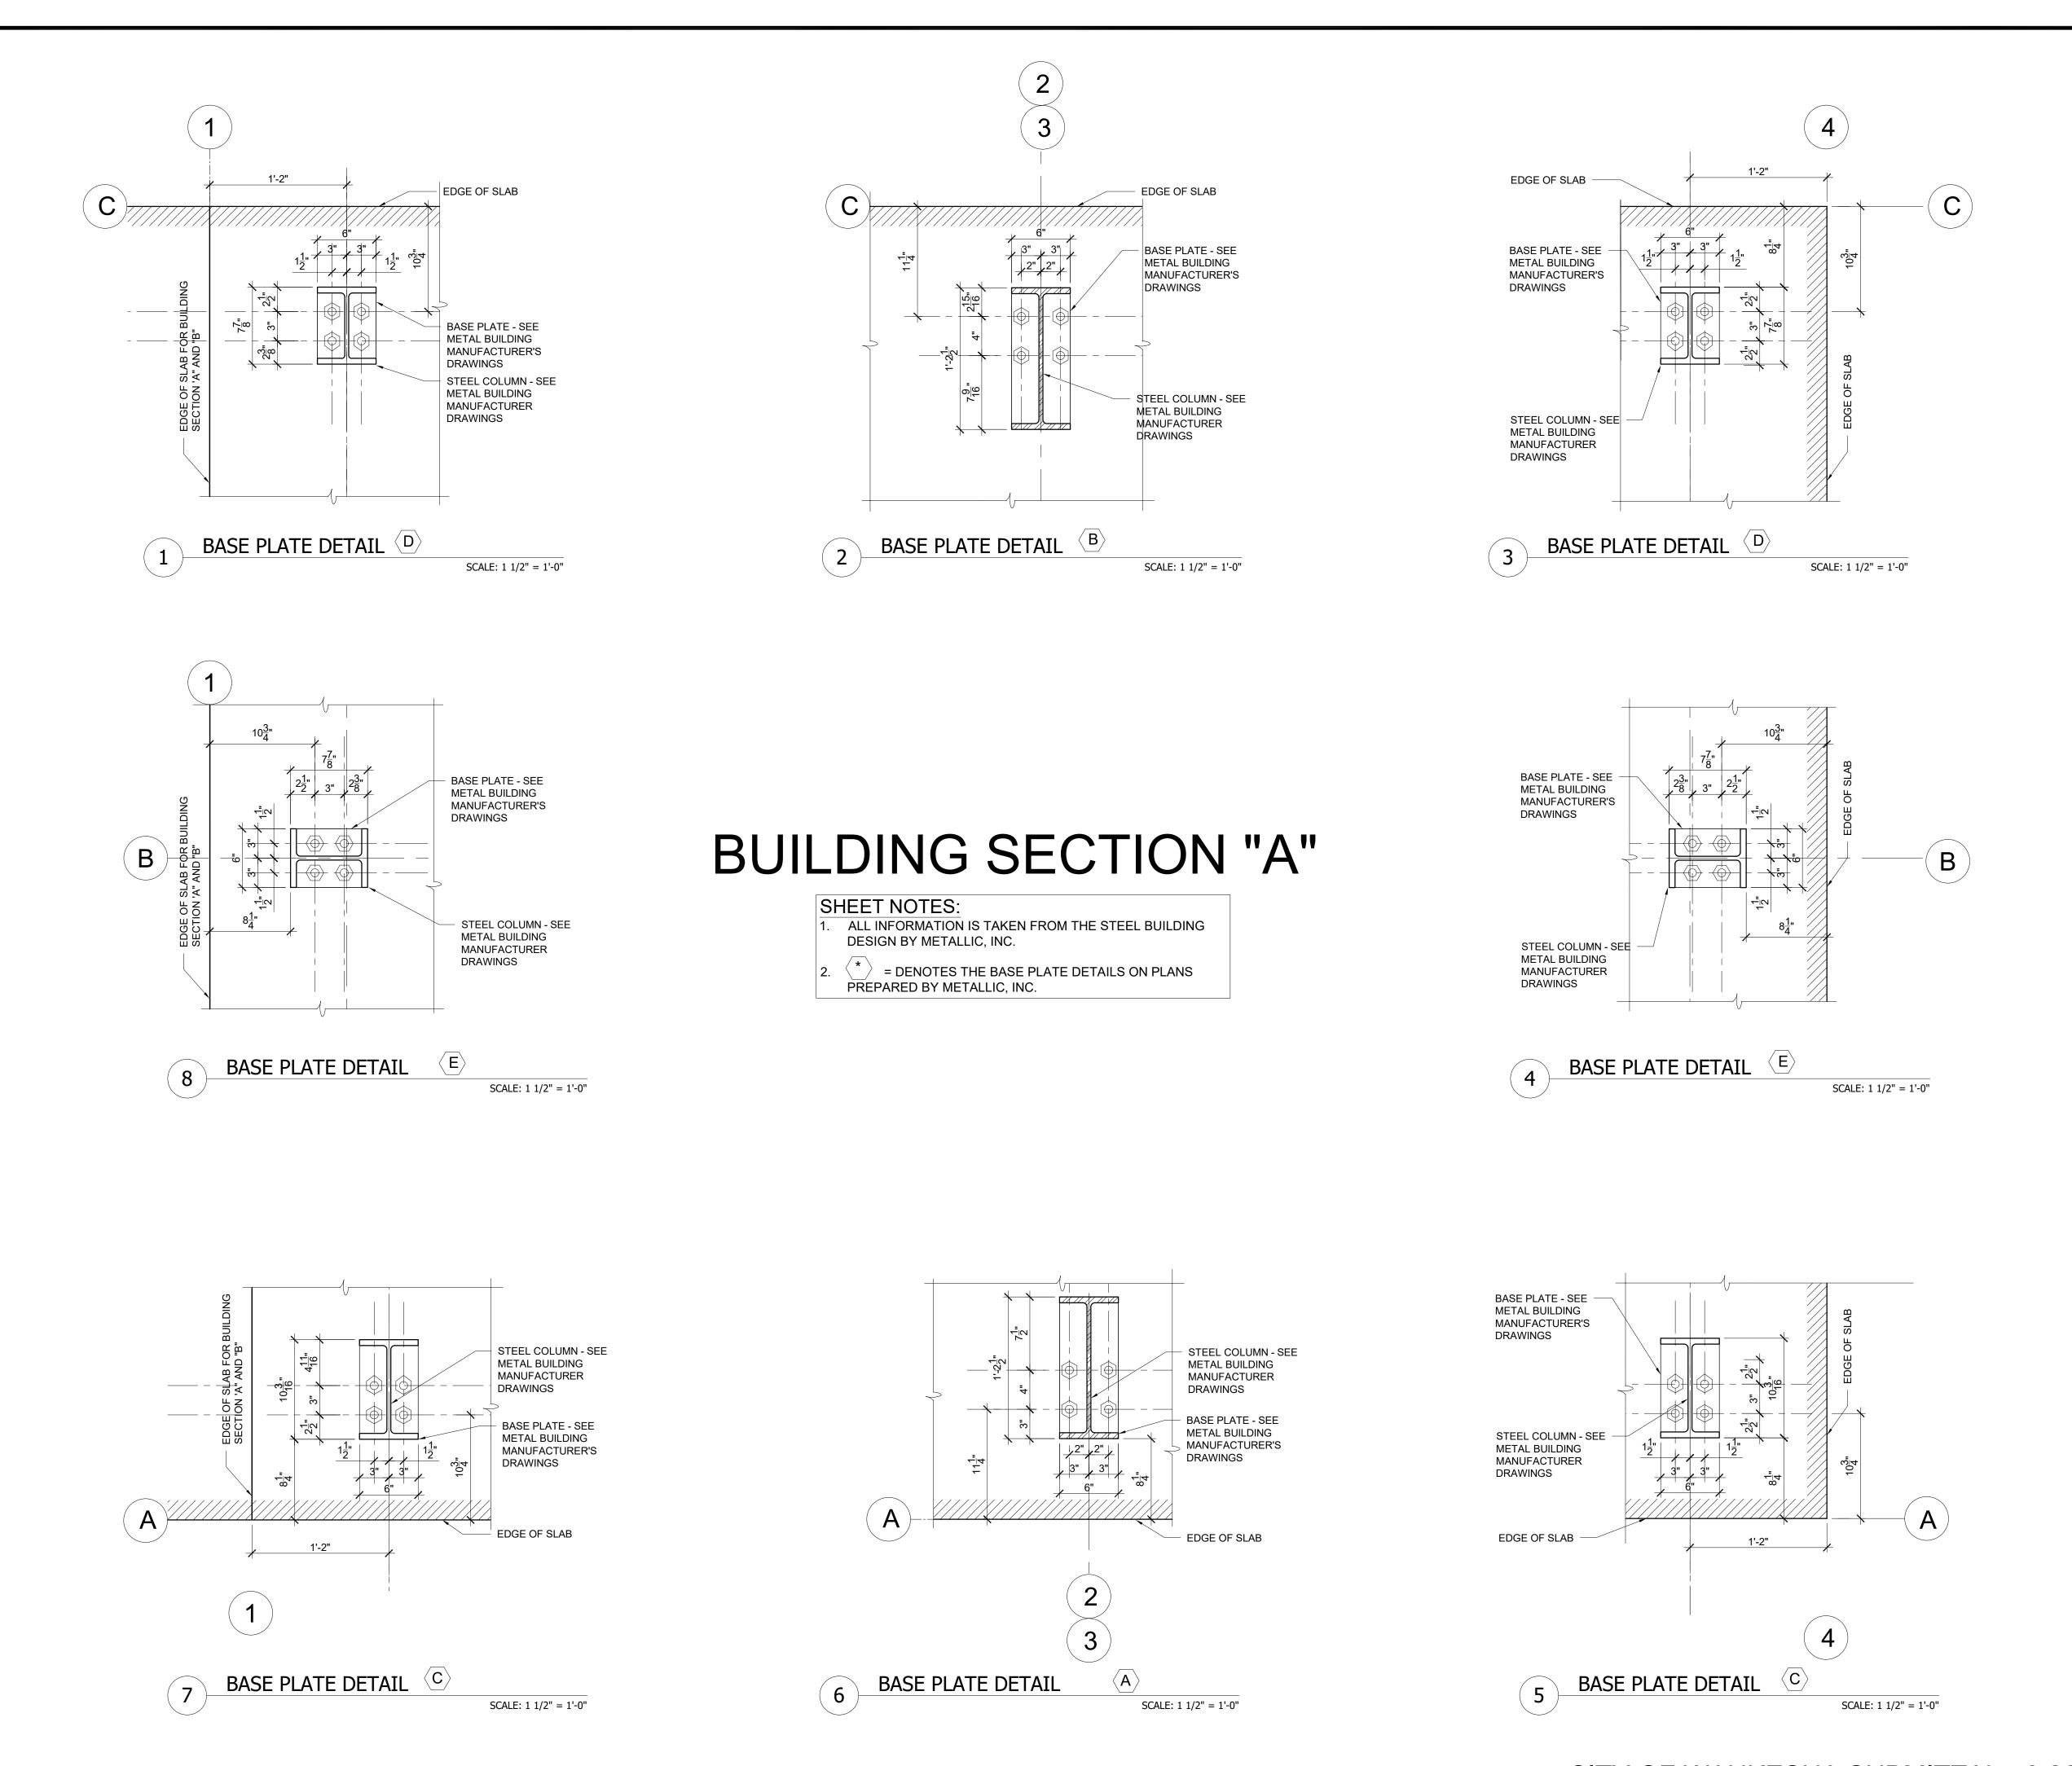1419 Poplar Drive
Waukesha, WI 53188

262-896-9370
262-896-9371 fax

E-Mail: fordcon@tds.net

AUKESHA IRON & METAL FINES BUILDING

REVISIONS:

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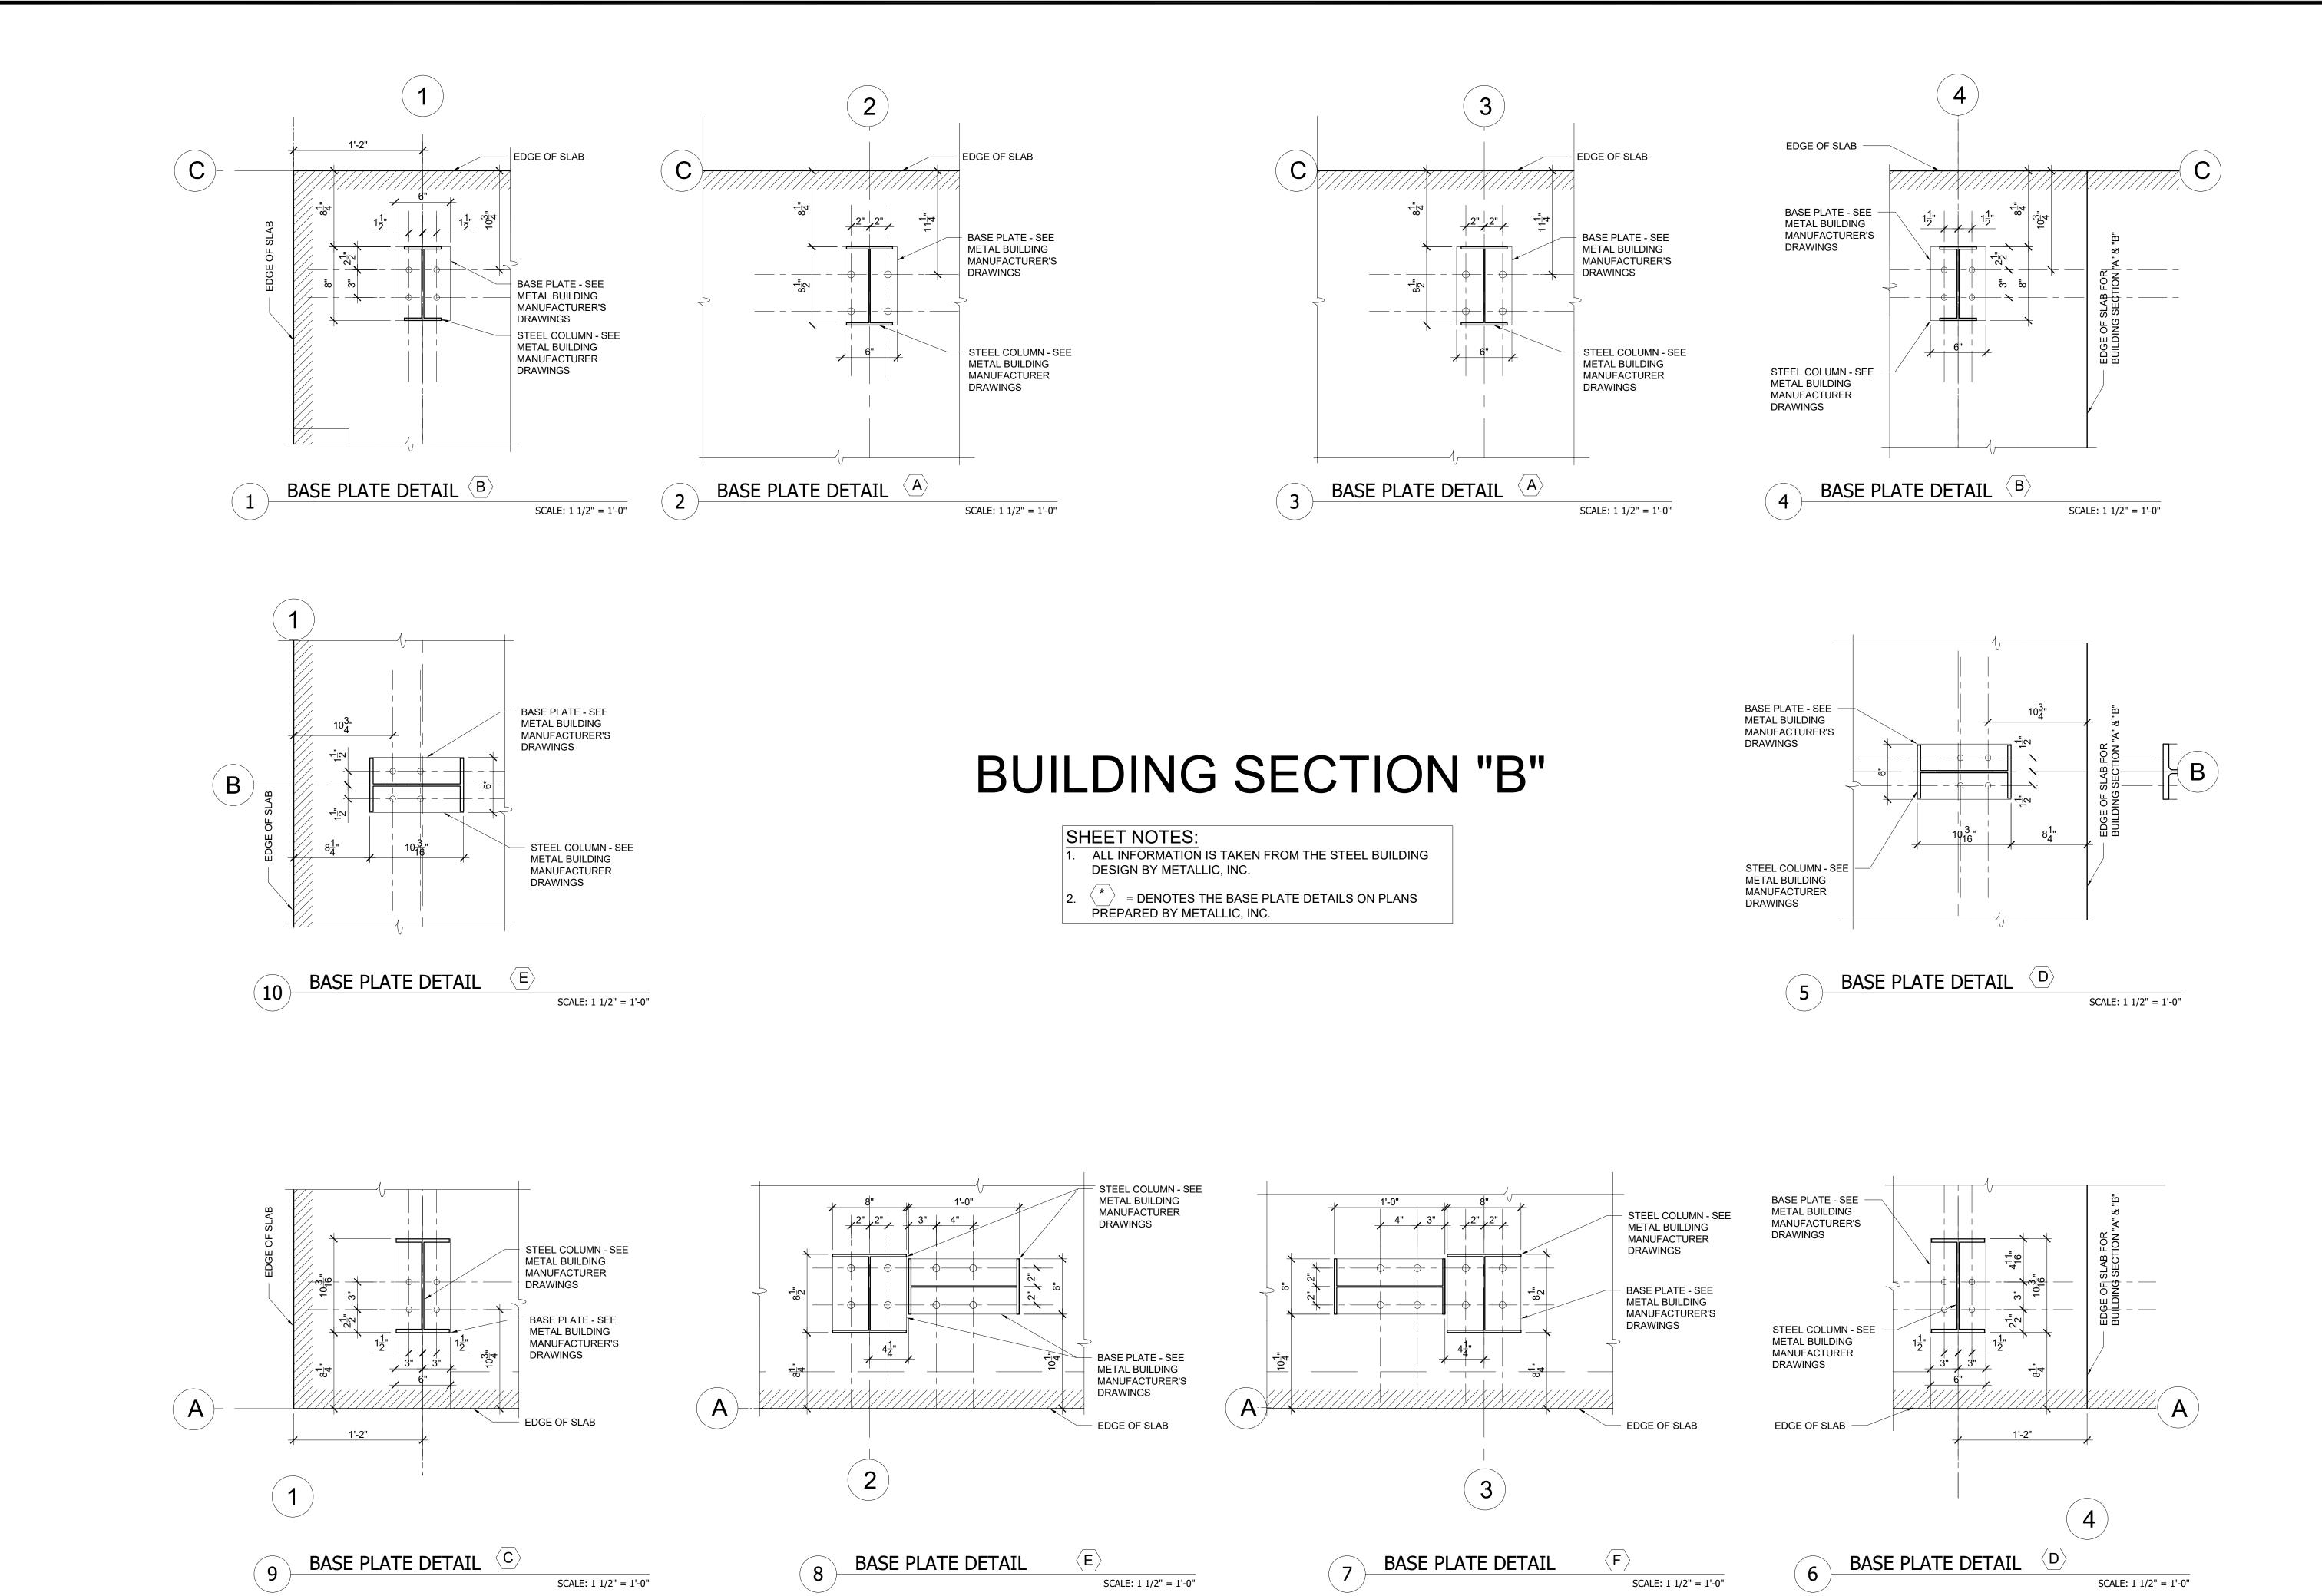
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S-102



Timothy Seidel
Architect LLC
530 Cymric Court
Wales, WI 53183-9423
(262) 968-5580 office
(262) 424-5797 direct
tim@timseidelarchitect.com


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General Contractors
Construction Managers

1419 Poplar Drive
Waukesha, WI 53188

262-896-9370
262-896-9371 fax
E-Mail: fordcon@tds.net

AUKESHA IRON & META FINES BUILDING 1351 EAST MAIN STREET

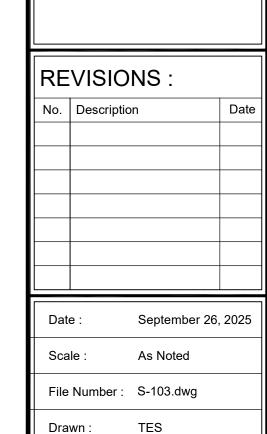

Project :

Sheet Number :

S-103