

Adding & Remodeling: Lifeway Foods, Inc 2101 Delafield Street Waukesha, Wisconsin

Bleck & Bleck Architects
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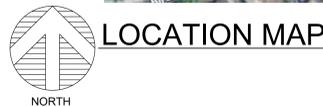
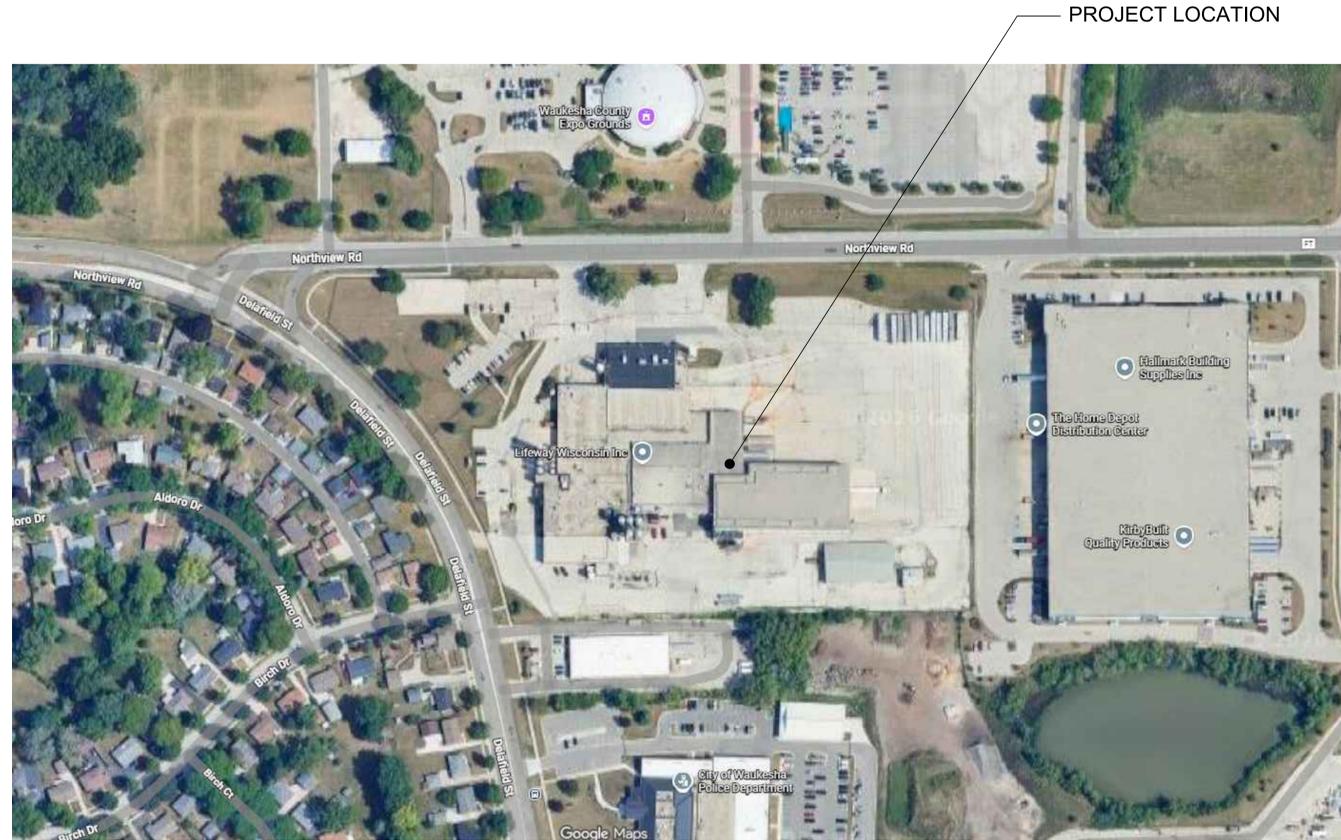
PROJECT
Lifeway Foods, Inc
2101 Delafield St
Waukesha, WI

GENERAL BUILDING INFORMATION

JURISDICTION CITY OF WAUKESHA, WISCONSIN
ZONING
CODES AND ORDINANCES: WISCONSIN COMMERCIAL BUILDING CODE
2021 IBC, INTERNATIONAL BUILDING CODE and AMENDMENTS
2021 INTERNATIONAL MECHANICAL CODE and AMENDMENTS
2021 WISCONSIN PLUMBING CODE and AMENDMENTS
2017 NFPA 70 NATIONAL ELECTRICAL CODE with AMENDMENTS SPS 316
2021 INTERNATIONAL ENERGY CONSERVATION CODE and AMENDMENTS
2021 INTERNATIONAL FUEL GAS CODE

BUILDING USE GROUP CLASSIFICATION: USE GROUP "F-2" LOW HAZARD FACTORY INDUSTRIAL (BEVERAGES =< 16% ALCOHOL CONTENT)
CONSTRUCTION TYPE: TYPE IIB, UNPROTECTED, NON-COMBUSTIBLE, FULLY SPRINKLERED, 2-STORY
HEIGHT LIMITATIONS: 4-STORY, 75 FT.
AREA LIMITATIONS: UNLIMITED AREA BUILDING W/ 60' MIN. PERIMETER YARD
AREA CALCULATION:
1ST FLOOR BUILDING AREA (LOT COVERAGE): 126,901 S.F. (EXISTING)
GARAGE: 8,801 S.F. (EXISTING)
UTILITY BUILDING: 1,204 S.F. (EXISTING)
+ 1-STORY ADDITION: 46,707 S.F. (PROPOSED)
= 183,613 S.F. (PROPOSED)

MAX. EXIT TRAVEL DISTANCE (WITH SPRINKLER SYSTEM BONUS) PER IBC 2021: ALLOWABLE: 400' MAX. WITH SPRINKLER BONUS
EGRESS WIDTH (USE GROUP R, WITH SPRINKLER) PER IBC 2021:
OTHER EGRESS COMPONENTS:
DOORS: 32" MIN. CLEAR OPENING WITH DOOR OPEN 90 MEASURED FROM FACE OF DOOR TO OPPOSITE STOP
CORRIDORS: 34" CLEAR PROVIDED (3'-0" EXIT DOORS, INCLUDING UNIT ENTRANCE DOORS IN CORRIDORS)
42" MIN WIDE AS AN ACCESSIBLE MEANS OF EGRESS; 66" WIDTH PROVIDED
STAIRWAYS PER 1009.1: 36" IF SERVING OCCUPANT LOAD <50; 44" WIDTH PROVIDED
NUMBER OF EXITS REQUIRED: 2 REQUIRED; >2 PROVIDED
PER IBC 2021:
BASED ON OCCUPANT LOAD 1-500



LOCATION MAP

CONTRACTOR



4125 TERMINAL DR.
Suite 100
McFarland, WI 53558

Plotted: Feb. 19, 26

For Permit:
Date: February 19, 2026

Revisions:

FIRE RESISTIVE RATINGS OF STRUCTURE ELEMENTS TABLE 601:

FIRE RESISTIVE RATINGS OF STRUCTURE ELEMENTS TABLE 601 - CONSTRUCTION TYPE IIB UNPROTECTED

BUILDING ELEMENT	TYPE I		TYPE II		TYPE III		TYPE IV		TYPE V	
	A	B	A	B	A	B	A	B	A	B
Primary structural frame (see Section 202)	3 ^h	2 ^h	1 ^h	0	0	0	HT	1 ^h	0	0
Sealing walls										
Exterior ¹	3	2	1	0	2	2	2	1	0	0
Interior ²	3 ^h	2 ^h	1	0	1	0	1HT	1	0	0
Nonbearing walls and partitions Exterior	See Table 602									
Nonbearing walls and partitions Interior ³	0	0	0	0	0	0	0	0	0	0
Floor construction and associated secondary members (see Section 202)	2	2	1	0	1	0	HT	1	0	0
Roof construction and associated secondary members (see Section 202)	1 ^{1/2} ^h	1 ^h	1 ^h	0 ^h	1 ^h	0	HT	1 ^h	0	0

TABLE 1017.2 EXIT ACCESS TRAVEL DISTANCE¹

OCCUPANCY	WITHOUT SPRINKLER SYSTEM (ft)	WITH SPRINKLER SYSTEM (ft)
A, E, F, I, M, R, S-1	200 ^a	250 ^a
I-1	Not Permitted	250 ^a
B	200	350 ^a
F-1, S-2, U	300	400 ^a
H-1	Not Permitted	75 ^a
H-2	Not Permitted	100 ^a
H-3	Not Permitted	150 ^a
H-4	Not Permitted	175 ^a
H-5	Not Permitted	200 ^a
I-2, I-3	Not Permitted	200 ^a
I-4	150	200 ^a

For SI: 1 foot = 304.8 mm.
a. See the following sections for modifications to exit access travel distance requirements:
Section 402.8.2 For the distance limitation in walls.
Section 407.4 For the distance limitation in Group I-2.
Section 408.1.1 and 408.1.2 For the distance limitation in Group I-3.
Section 411.2 For the distance limitation in special amusement areas.
Section 412.3 For the distance limitation in aircraft manufacturing facilities.
Section 1009.2.2.2 For the distance limitation in refrigeration machinery rooms.
Section 1009.3.4 For buildings with one exit.
Section 1012.2.2 For increased distance limitation in Group F-1 and D-1.
Section 1032.7 For increased limitation in assembly seating.
Section 1034.4 For temporary structures.
Section 1034.5 For pedestrian walkways.
b. Building equipped throughout with an automatic sprinkler system in accordance with Section 903.3.1.1 or 903.3.1.2. See Section 903 for occupancies where automatic sprinkler systems are permitted in accordance with Section 903.3.1.2.
c. Building equipped throughout with an automatic sprinkler system in accordance with Section 903.3.1.1.
d. Group H occupancies equipped throughout with an automatic sprinkler system in accordance with Section 903.2.5.1.
e. Group I-3 and I-4 buildings equipped throughout with an automatic sprinkler system in accordance with Section 903.3.1.3. See Section 903.2.8 for occupancies where automatic sprinkler systems are permitted in accordance with Section 903.3.1.3.

ABBREVIATIONS

AFF ABOVE FINISHED FLOOR
AFLR ACCESS FLOOR
AT2X2 ACOUSTIC LAY-IN TILE, 2'X2'
ANDD ACOUSTIC LAY-IN TILE, 2'X4'
AL ALUMINUM
AP ACOUSTIC PANEL
ANDZ ANODIZED
AT2X4 ACOUSTIC TILE, "2" SPLINE
ATZ ACOUSTIC WALL PANEL
AWP BRICK
B BRICK
BD BOARD
BOT BOTTOM
BLDG BUILDING
CAB CABINET
CPT CARPET
CB CATCH BASIN
CMT CERAMIC MOSAIC TILE
CONC CONCRETE MASONRY UNIT
CONC CONSTRUCTION
CONT CONTINUOUS
GLZD GLAZED CERAMIC TILE
CJ CONTROL JOINT
CL CENTERLINE
CLC CEILING
COL COLUMN
DOL DOUBLE
DN DOWN
DF DRINKING FOUNTAIN
DW DRYWALL
DWG DRYWALL, MOISTURE RESISTANT "GREENBOARD"
EWC ELECTRIC WATER COOLER
EPI EXPANSION JOINT
EXTR EXTRUDED
EX EXISTING
EXP EXPOSED
EQ EQUAL
FLR FLOOR
FD FLOOR DRAIN
FIN FINISH
FY FIELD VERIFY
FEC FIRE EXTINGUISHER CABINET
FDN FOUNDATION
GALV GALVANIZED
GL GLASS
GYP GYPSUM
HC HOLLOW CORE
HM HOLLOW METAL
HDW HARDWARE
HIW HIGH IMPACT WALL COVERING
HWAC HEATING VENTILATING AND AIR CONDITIONING
JT JOINT
IG INSULATING GLASS
INSUL INSULATION
LAM LAMINATE
LP LIGHTING PANEL
LNO LINOLEUM
MB MARKER BOARD
MFR MANUFACTURER
MTL METAL
MO MASONRY OPENING
MATL MATERIAL
MH MAN HOLE
NOM NOMINAL
N/A NOT APPLICABLE
NIC NOT IN CONTRACT
NW NO WORK
OC ON CENTER
PE HEART LATH & PLASTER
PTD PAINTED
PL PLASTIC LAMINATE
PP POWER PANEL
PSC SEMI COAT PLASTER, 3/16" THICK
PWF POLYCHROMATIC WALL FINISH "ZOLOTONE"
QUARY QUARRY TILE
RT RUBBER TILE
RTR RUBBER TREADS AND RISERS
RB RUBBER BASE
RM ROOM
SIM SIMILAR
SC SOLID CORE
SLR SEALER
STL STEEL
SV STAIN AND VARNISH
SCT STRUCTURAL GLAZED TILE
TAP TACKABLE ACOUSTIC PANEL
TECT TECTUM
TG TEMPERED GLASS
T&B TOP AND BOTTOM
T&G TONGUE AND GROOVE
TERR TERRAZZO
THK THICK
TYP TYPICAL
UNLESS NOTED OTHERWISE
VCT VINYL COMPOSITION TILE
VSG VINYL SHEET GOOD
VF VINYL FABRIC
VB VINYL BASE-CONTINUOUS RUBBER ROLE
VCP VITRIFIED CLAY PIPE
WC WATER CLOSET
W/W WELDED WIRE FABRIC
W/ WITH
W/O WITHOUT
"WONDERBOARD" OR "DUR-ROK"
WG WIRE GLASS
WD WOOD
WF WOOD
WP WEATHER PROOF

DRAWING LEGEND

100'-0" FLOOR ELEVATION LEVEL LINE
ROOM NAME - SEE ROOM FINISH SCHEDULE.
ROOM NUMBER - SEE ROOM FINISH SCHEDULE.
WALL TYPE. SEE WALL TYPE DETAIL SHEET.
FLOOR PLAN NOTE.
DOOR NUMBER. SEE DOOR SCHEDULE.
REVISION NUMBER.
COLUMN GRID LINE.
DETAIL NUMBER.
SHEET WHERE DETAIL IS DRAWN.
DETAIL LETTER OR NUMBER.
SHEET WHERE DETAIL IS DRAWN.
SECTION OR ELEVATION LETTER.
SHEET WHERE SECTION OR ELEVATION IS DRAWN.
MATCH LINE
CONCRETE MASONRY
BRICK
DW & WOOD STUD
NEW DOOR
DEMOLITION OF WALL OR DOOR
STRUCTURAL STEEL
WOOD FRAMING OR BLOCKING
WOOD TRIM FINISHED
PLYWOOD
CONCRETE
RIGID INSULATION
BATT INSULATION

DRAWING INDEX

ARCHITECTURAL (14 SHEETS):

CS-1 COVER SHEET
DD-1.1 EXTERIOR RENDERINGS
A-0 PARKING & AREA CALCULATIONS PLAN
A-0.1 OVERALL FACILITY PLAN
A-1.0 OVERALL EXIT PLAN
A-1.0.1 ENLARGED EXIT PLAN (ADDITION)
A-1.1 ENLARGED PLAN (ADDITION)
A-1.2 ROOF PLAN
A-1.3 ROOF DETAILS
A-2.1 ELEVATIONS
A-3.1 BUILDING SECTIONS
A-3.2 BUILDING SECTIONS
A-4.1 TYP. STAIR SECTIONS & DETAILS
L1.0 Landscape Plan

PLAT OF SURVEY BY BIRRENKOTT SURVEYING (1 SHEET):
1 PLAT OF SURVEY

CIVIL BY JAHNKE & JAHNKE ASSOC. (6 SHEETS):
C1.0 Existing Conditions and Demolition Plan
C2.0 Proposed Site Plan-1
C3.0 Proposed Site Plan-2
C4.0 Erosion Control Plan
C5.0 Proposed Site Plan-1
C6.0 Proposed Site Plan-1

LANDSCAPE PLAN BY David Heller (3 SHEETS):
L1 Overall Landscape Plan
L2 Enlarged Landscape Plan
L3 Landscape Details, Notes, & Schedules

ELECTRICAL:
E-101 SITE PHOTOMETRIC




Cover Sheet

Sheet: CS-1
of: 14

Project No. 4123



982 Northview Rd
BEFORE

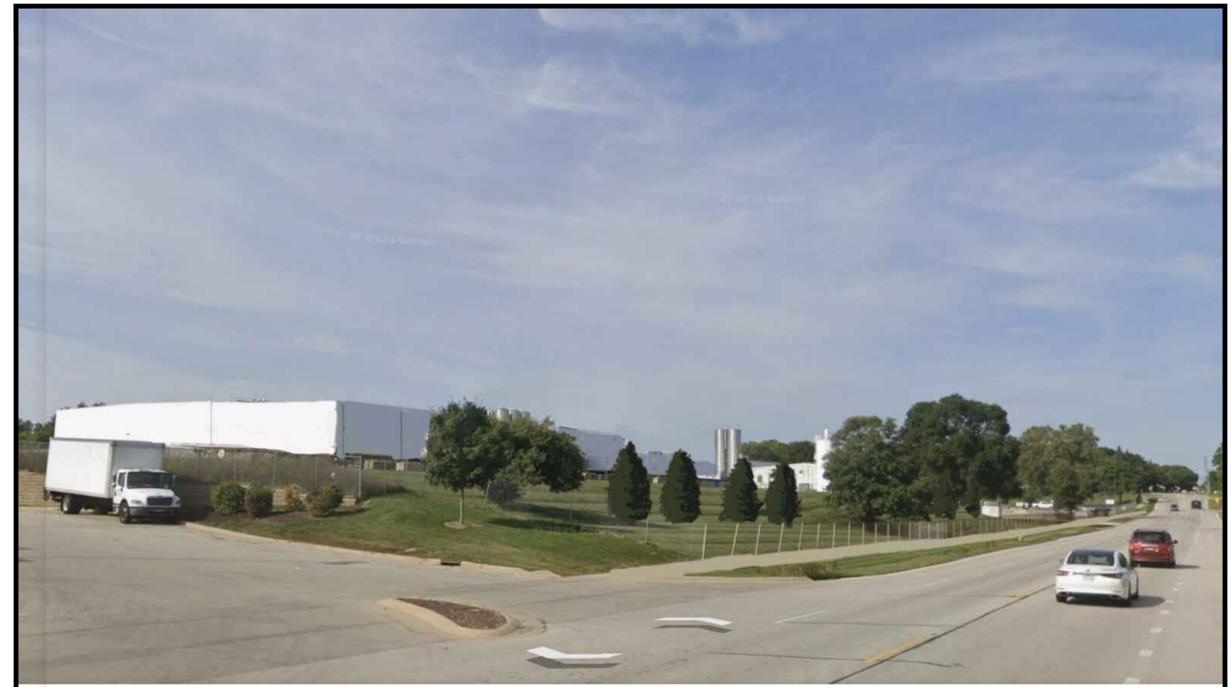

982 Northview Rd
AFTER

1
DD-1.1
EXTERIOR RENDERING
SCALE: NOT TO SCALE




1129 County Road FT
BEFORE



1129 County Road FT
AFTER

1
DD-1.1
EXTERIOR RENDERING
SCALE: NOT TO SCALE



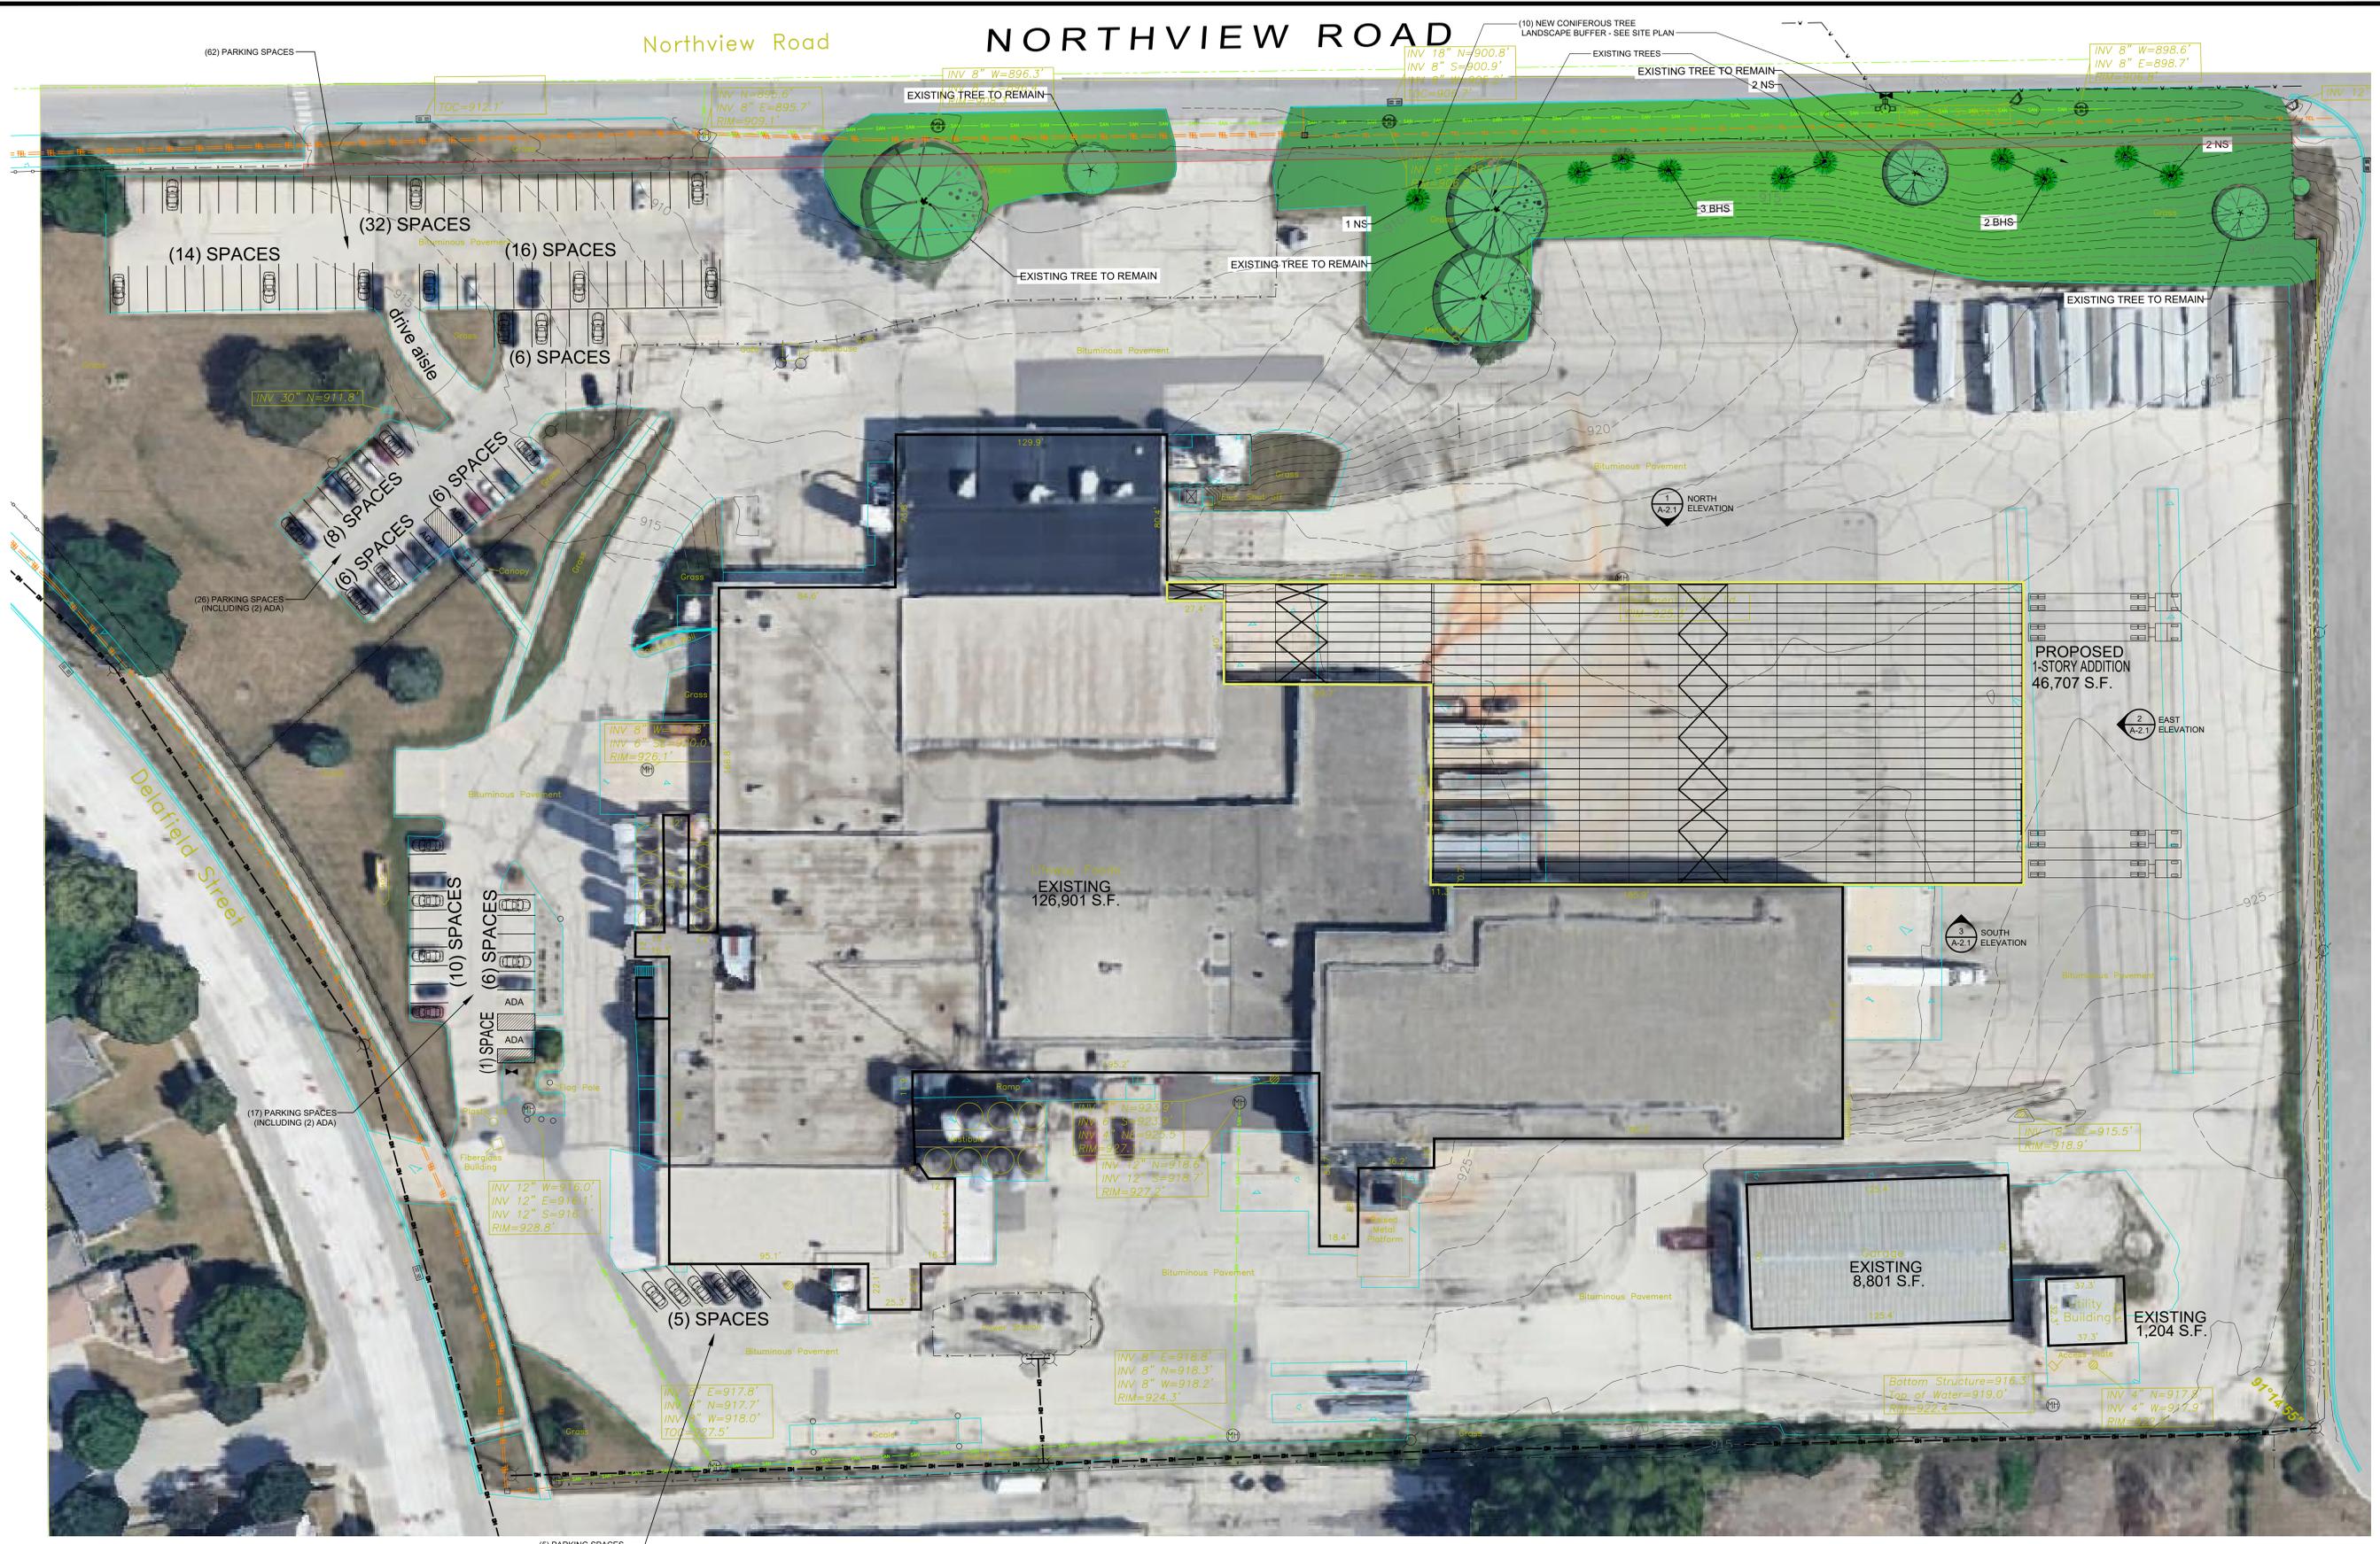

PARKING & AREA CALCULATION PLAN
SCALE: 1" = 30 FT

EXISTING PARKING CALCULATION:
 (62) PARKING SPACES
 (26) PARKING SPACES
 (17) PARKING SPACES
 + (5) PARKING SPACES
 = (110) PARKING SPACES PROVIDED (INCLUDING (4) ACCESSIBLE SPACES)

AREA CALCULATION:
1ST FLOOR BUILDING AREA (LOT COVERAGE): 126,901 S.F. (EXISTING)
GARAGE: 8,801 S.F. (EXISTING)
UTILITY BUILDING: 1,204 S.F. (EXISTING)
 + **1-STORY ADDITION:** 46,707 S.F. (PROPOSED)
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12 GAUGE

CONSTRUCTION, LLC

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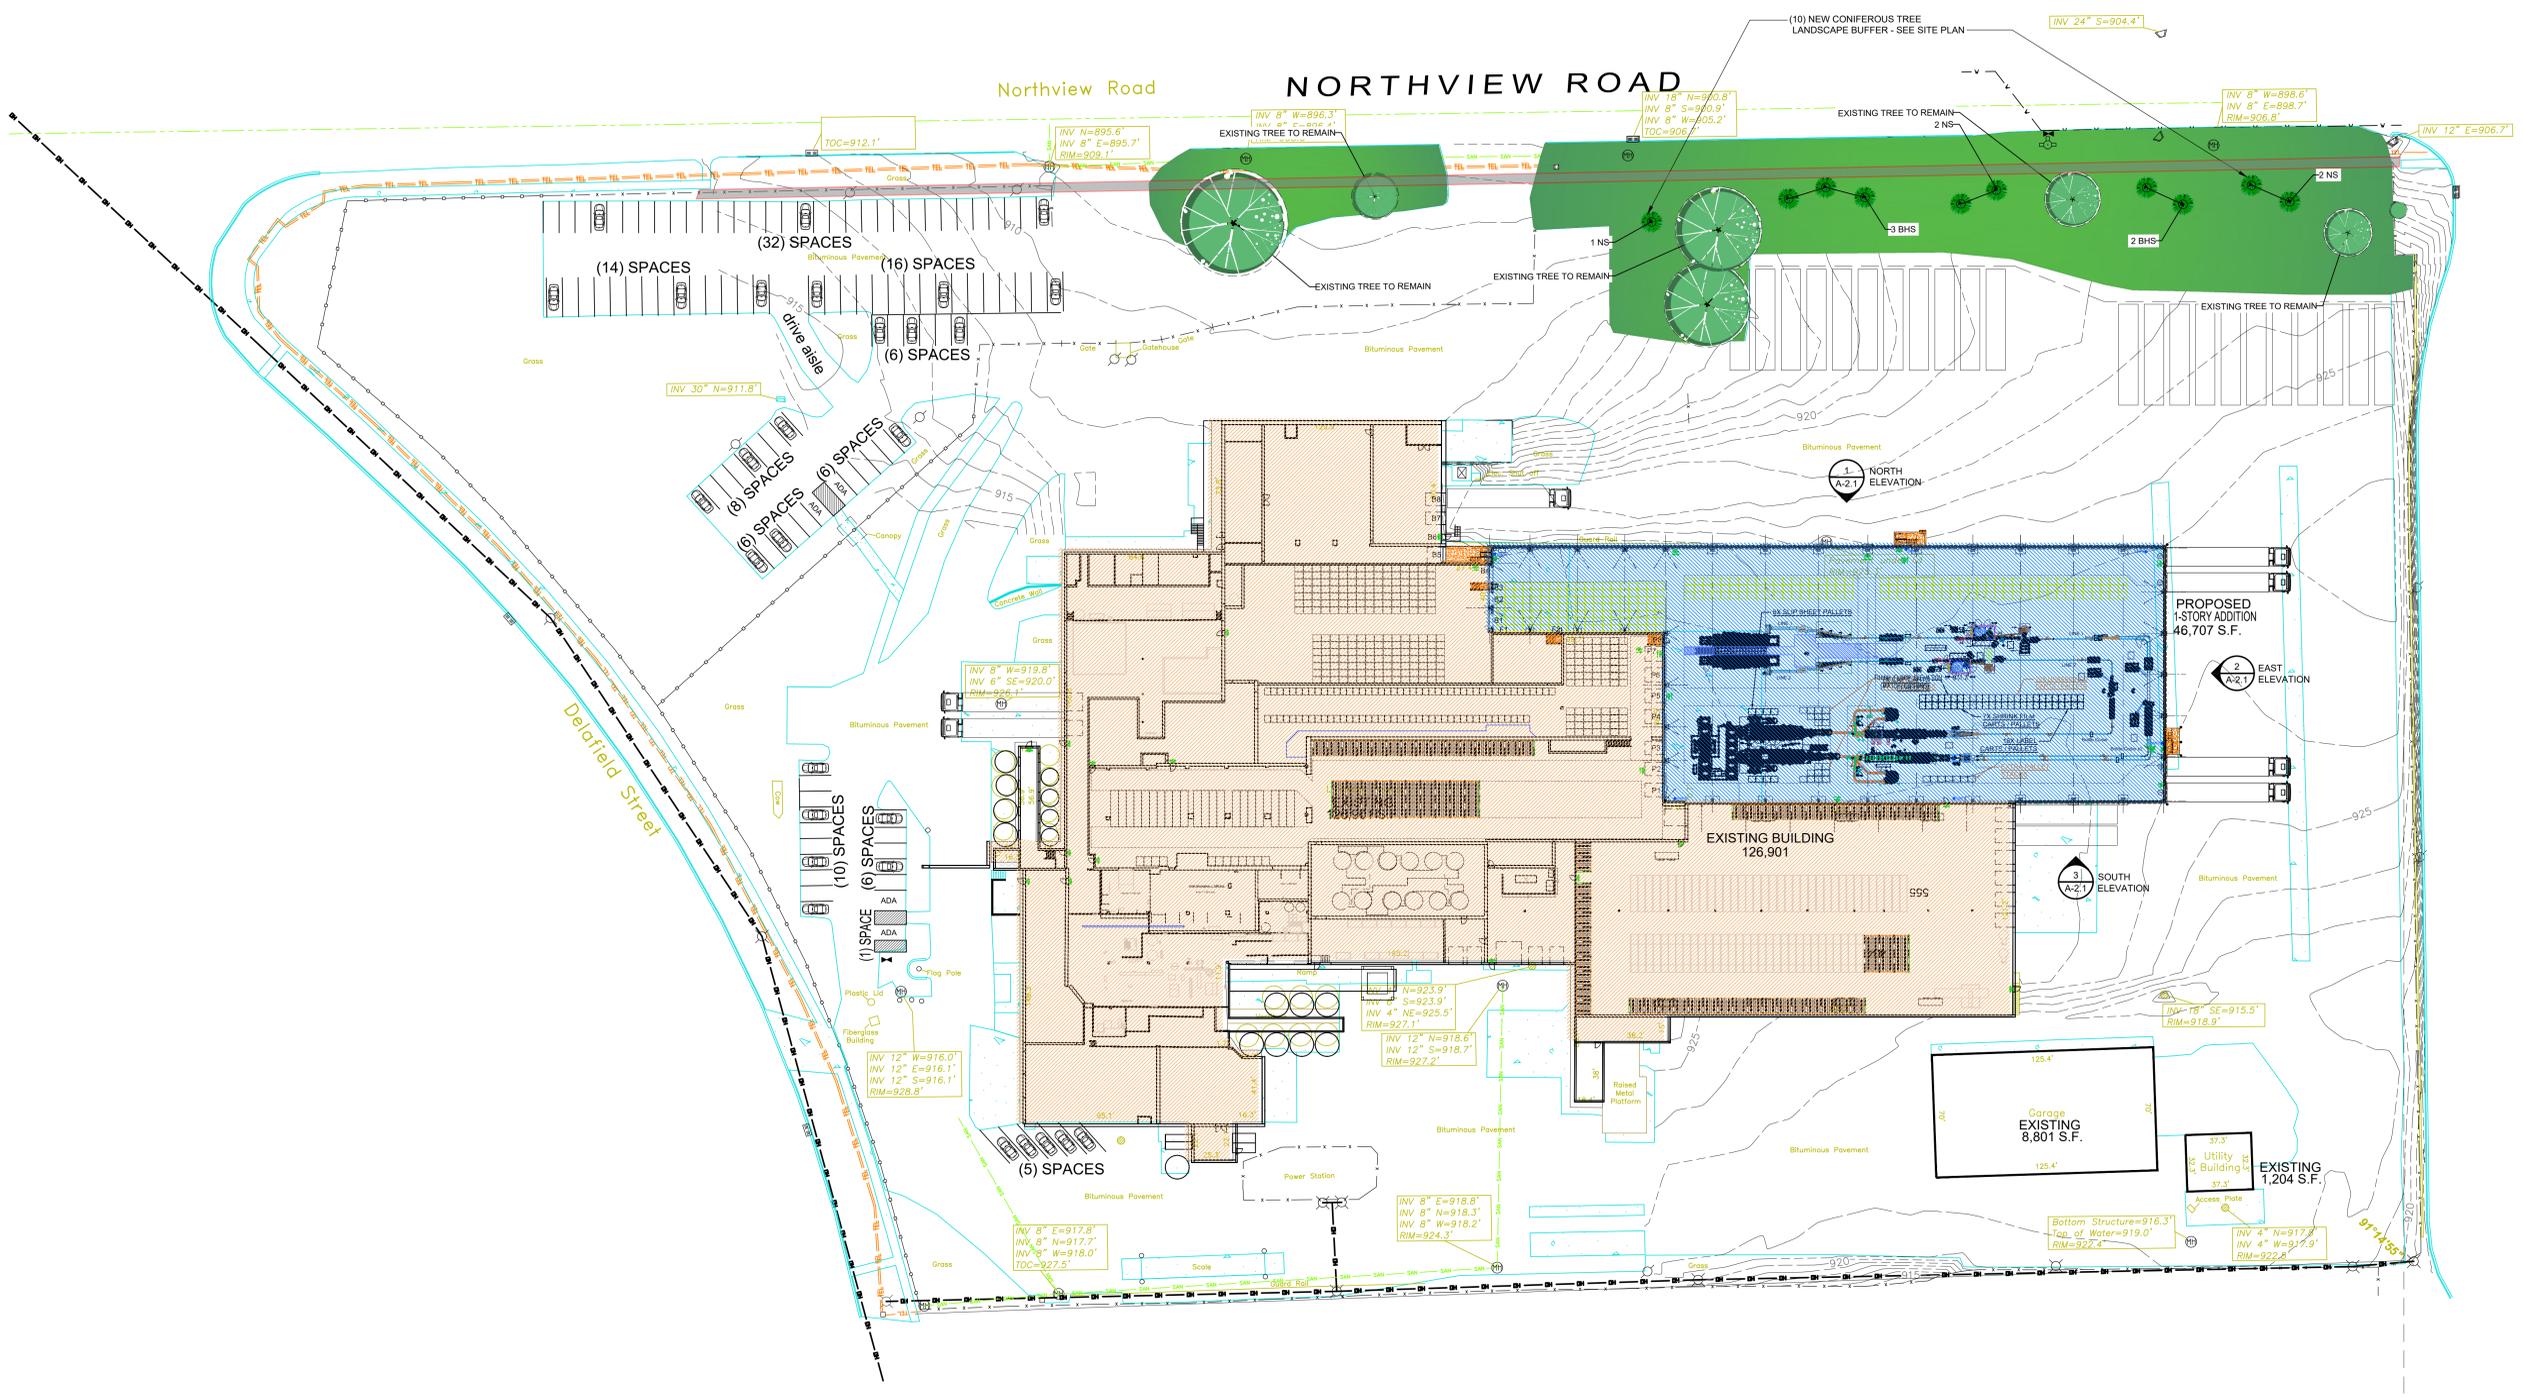
For Permit:
Date: February 19, 2026

Revisions:

PARKING & AREA CALCS.

Sheet: **A-0**
of: 14

Project No. 4123



1 OVERALL FACILITY PLAN
A0.1 SCALE: 1" = 40 FT.

SEE ENLARGED PLAN SHEET A1.1




LEGEND

- SMFE = SURFACE MOUNTED (HOOK OR BRACKET) FIRE EXTINGUISHER
- ⚡ EMERGENCY LIGHT / EXIT SIGN COMBO FIXTURE W/ RED LENS, 90 MIN. NICAD BATTERY, ALUM. BODY, ONE OR TWO-SIDED W/ DIRECTIONAL ARROWS PER PLAN & REMOTE HEAD AT EXTERIOR DOOR LOCATIONS

GENERAL NOTES:

1. FIRE EXTINGUISHERS SHALL BE 10 LB. MULTI-PURPOSE DRY CHEMICAL TYPE, ABC RATED AS MANUFACTURED BY POTTER-ROEMER #3010. ALL EXTINGUISHERS TO HAVE A CURRENT SERVICE TAG.
2. FIRE EXTINGUISHER CARBON DIOXIDE SHALL BE 10 LB. BC RATED WITH HOSE RZ AND HORN AS MANUFACTURED BY POTTER-ROEMER NO. 3410.
3. ALL FIRE EXTINGUISHERS TO HAVE A 3D SIGN MOUNTED AT 80" A.F.F.

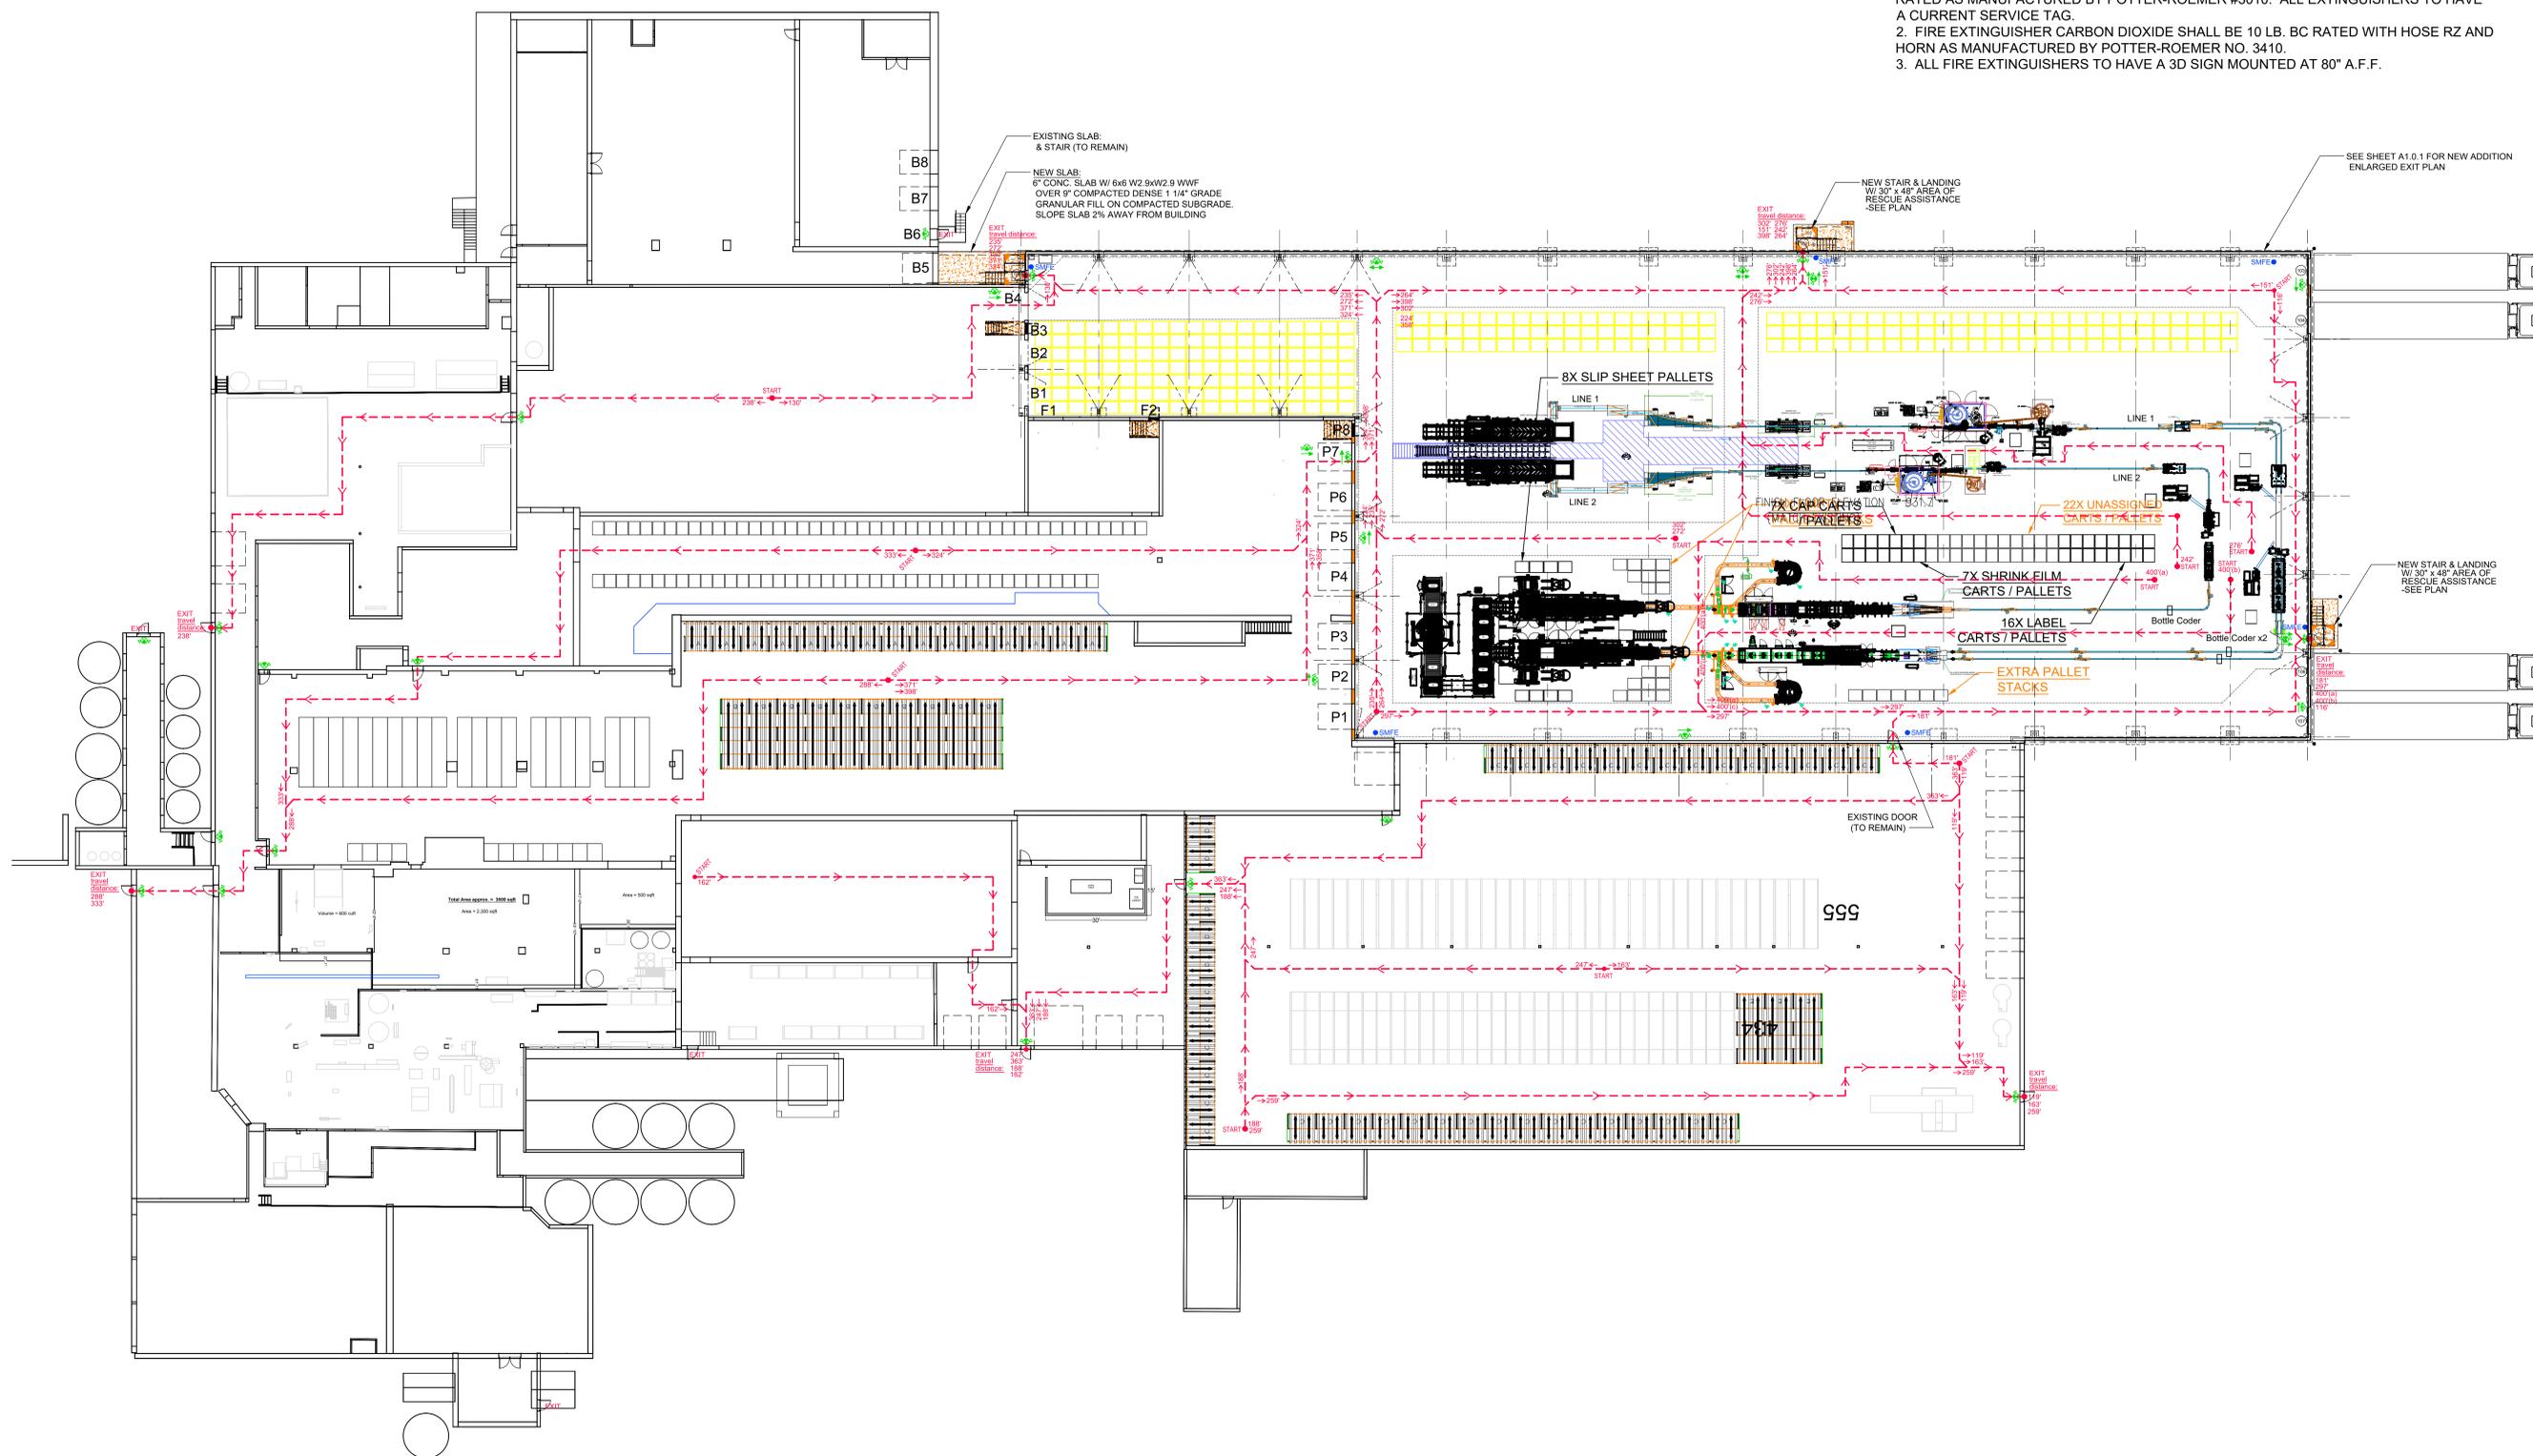

OVERALL EXIT PLAN
SCALE: 1" = 20 FT.

NOTE: ALL LIFE SAFETY ELEMENTS TO BE IN PLACE BUT NOT LIMITED TO: FIRE SPRINKLERS, FIRE ALARM, EXITS, EXIT SIGNS, EMERGENCY LIGHTING AND FIRE EXTINGUISHERS






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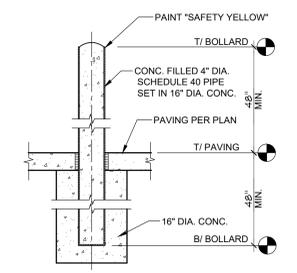
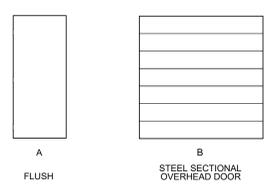
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ENLARGED EXIT PLAN (ADDITION)
SCALE: 3/32" = 1'-0"


DOOR SCHEDULE

OPENG NO.	TYPE	WIDTH	HEIGHT	MATL.	FINISH	FRAME	CLOSER	LABEL	THRESHOLD	REMARKS	HARDWARE SET	PANIC DEVICE	
101	A	3'-0"	7'-0"	H.M.	PTD.	H.M.	PTD.	YES	-	YES	INSULATED HOLLOW METAL DOOR + ALUM. THRESHOLD W/ THERMAL BREAK (2.7 MIN. R-VALUE) W/ doorbell, badge access, and electric strike	A	YES
102	A	3'-0"	7'-0"	H.M.	PTD.	H.M.	PTD.	YES	-	YES	INSULATED HOLLOW METAL DOOR + ALUM. THRESHOLD W/ THERMAL BREAK (2.7 MIN. R-VALUE) W/ doorbell, badge access, and electric strike	A	YES
103	B	8'-0"	9'-0"	STEEL	PTD.	STEEL	PTD.	-	-	NO	MOTORIZED STEEL OVERHEAD DOOR W/ LIGHT + WEATHER GUARD DOCK SEAL & BUMPERS + SAFETY HOOK VEHICLE RESTRAINT + DOCK LEVELER (0.14 U-VALUE) WAYNE-DALTON THERMOSPAN 150	-	-
104	B	8'-0"	9'-0"	STEEL	PTD.	STEEL	PTD.	-	-	NO	MOTORIZED STEEL OVERHEAD DOOR W/ LIGHT + WEATHER GUARD DOCK SEAL & BUMPERS + SAFETY HOOK VEHICLE RESTRAINT + DOCK LEVELER (0.14 U-VALUE) WAYNE-DALTON THERMOSPAN 150	-	-
105	A	3'-0"	7'-0"	H.M.	PTD.	H.M.	PTD.	YES	-	YES	INSULATED HOLLOW METAL DOOR + ALUM. THRESHOLD W/ THERMAL BREAK (2.7 MIN. R-VALUE) (PANIC DEVICE ONLY, NO HARDWARE SET)	-	YES
106	B	8'-0"	9'-0"	STEEL	PTD.	STEEL	PTD.	-	-	NO	MOTORIZED STEEL OVERHEAD DOOR W/ LIGHT + WEATHER GUARD DOCK SEAL & BUMPERS + SAFETY HOOK VEHICLE RESTRAINT + DOCK LEVELER (0.14 U-VALUE) WAYNE-DALTON THERMOSPAN 150	-	-
107	B	8'-0"	9'-0"	STEEL	PTD.	STEEL	PTD.	-	-	NO	MOTORIZED STEEL OVERHEAD DOOR W/ LIGHT + WEATHER GUARD DOCK SEAL & BUMPERS + SAFETY HOOK VEHICLE RESTRAINT + DOCK LEVELER (0.14 U-VALUE) WAYNE-DALTON THERMOSPAN 150	-	-

DOOR HARDWARE:
 DOOR CLOSERS: LCN 4110 SERIES PARALLEL ARM HANDICAPPED ACCESSIBLE CLOSER.
 DOOR LEVERS: SCHLAGE "L" SERIES TYPE 12 LEVER HANDICAPPED ACCESSIBLE. BRUSHED NICKEL FINISH
 DOOR HARDWARE SET: (LOCKABLE LATCH SET TO BE SCHLAGE ND73PD OR SIMILAR)
 SET A SET B SET C SET D SET E SET F SET G SET H
 4 HINGES
 LOCKSET STORAGE LOCK PRIVACY MECH RM PASSAGE DUMMY LEVERS CLASSROOM LOCK PUSH, PULL, & KICK PLATES
 NOTES:
 1. USE SAFETY GLASS WHERE REQUIRED BY CODE
 2. USE WEATHER STRIPPING & DOOR SWEEPS AT EXTERIOR DOORS AND VESTIBULE DOORS
 3. DOORS USED FOR ASSEMBLY OF MORE THAN 50 OCCUPANTS SHALL BE EQUIPPED WITH PANIC HARDWARE.
 4. VERIFY LOCKSET REQUIREMENTS W/ OWNER

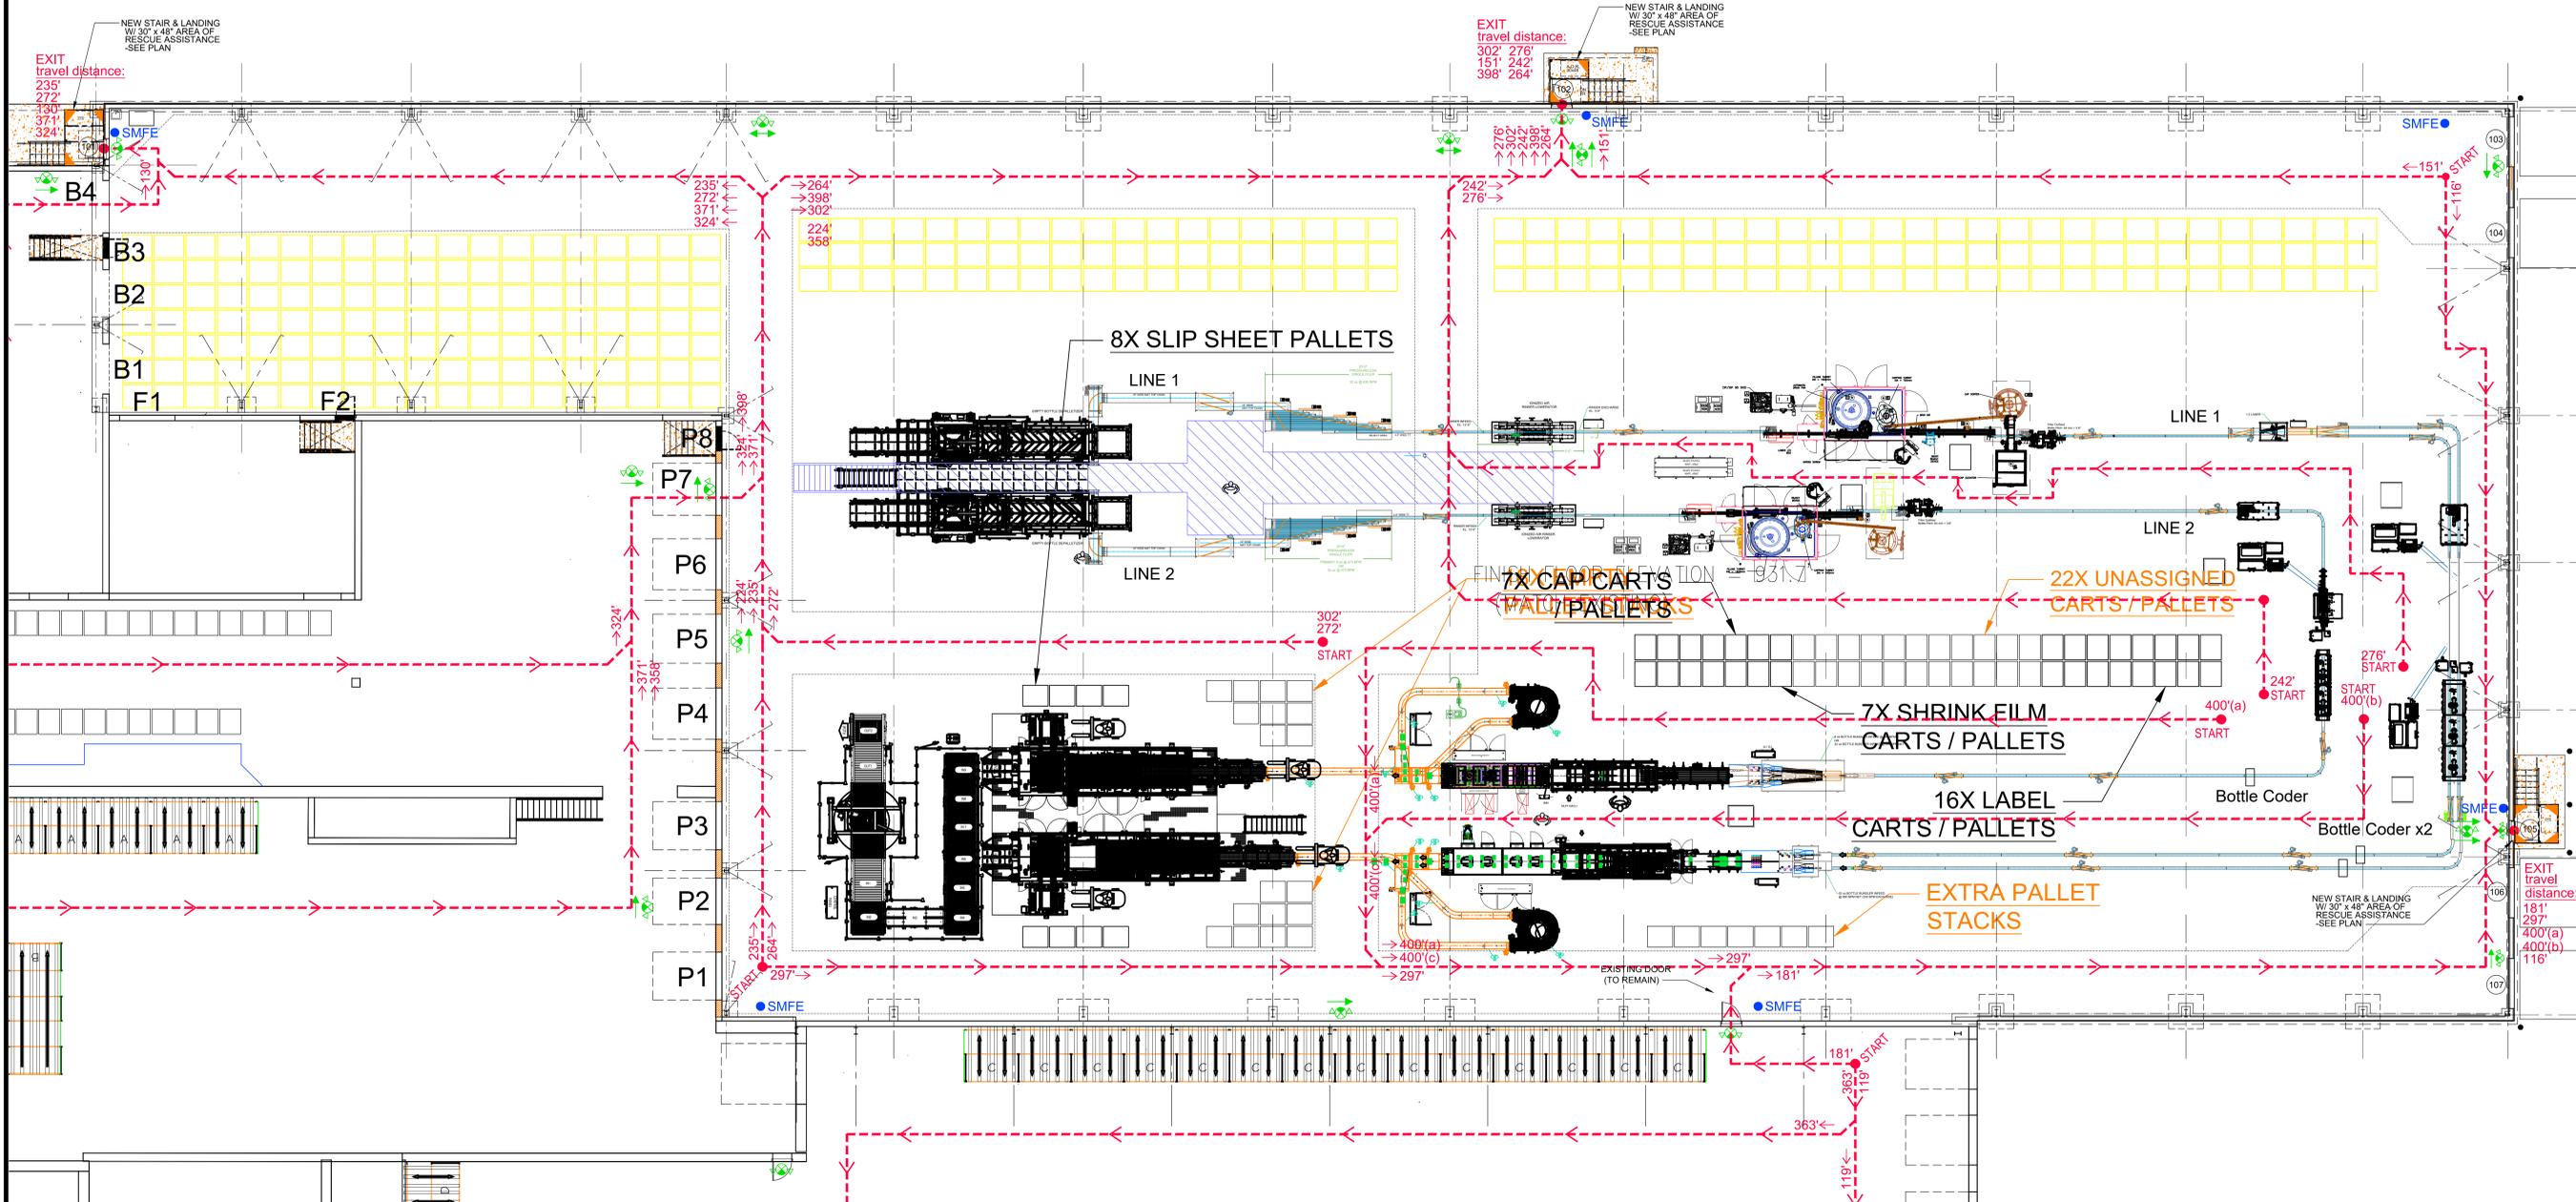


STEEL BOLLARD DETAIL
 SCALE: 3/4" = 1'-0"

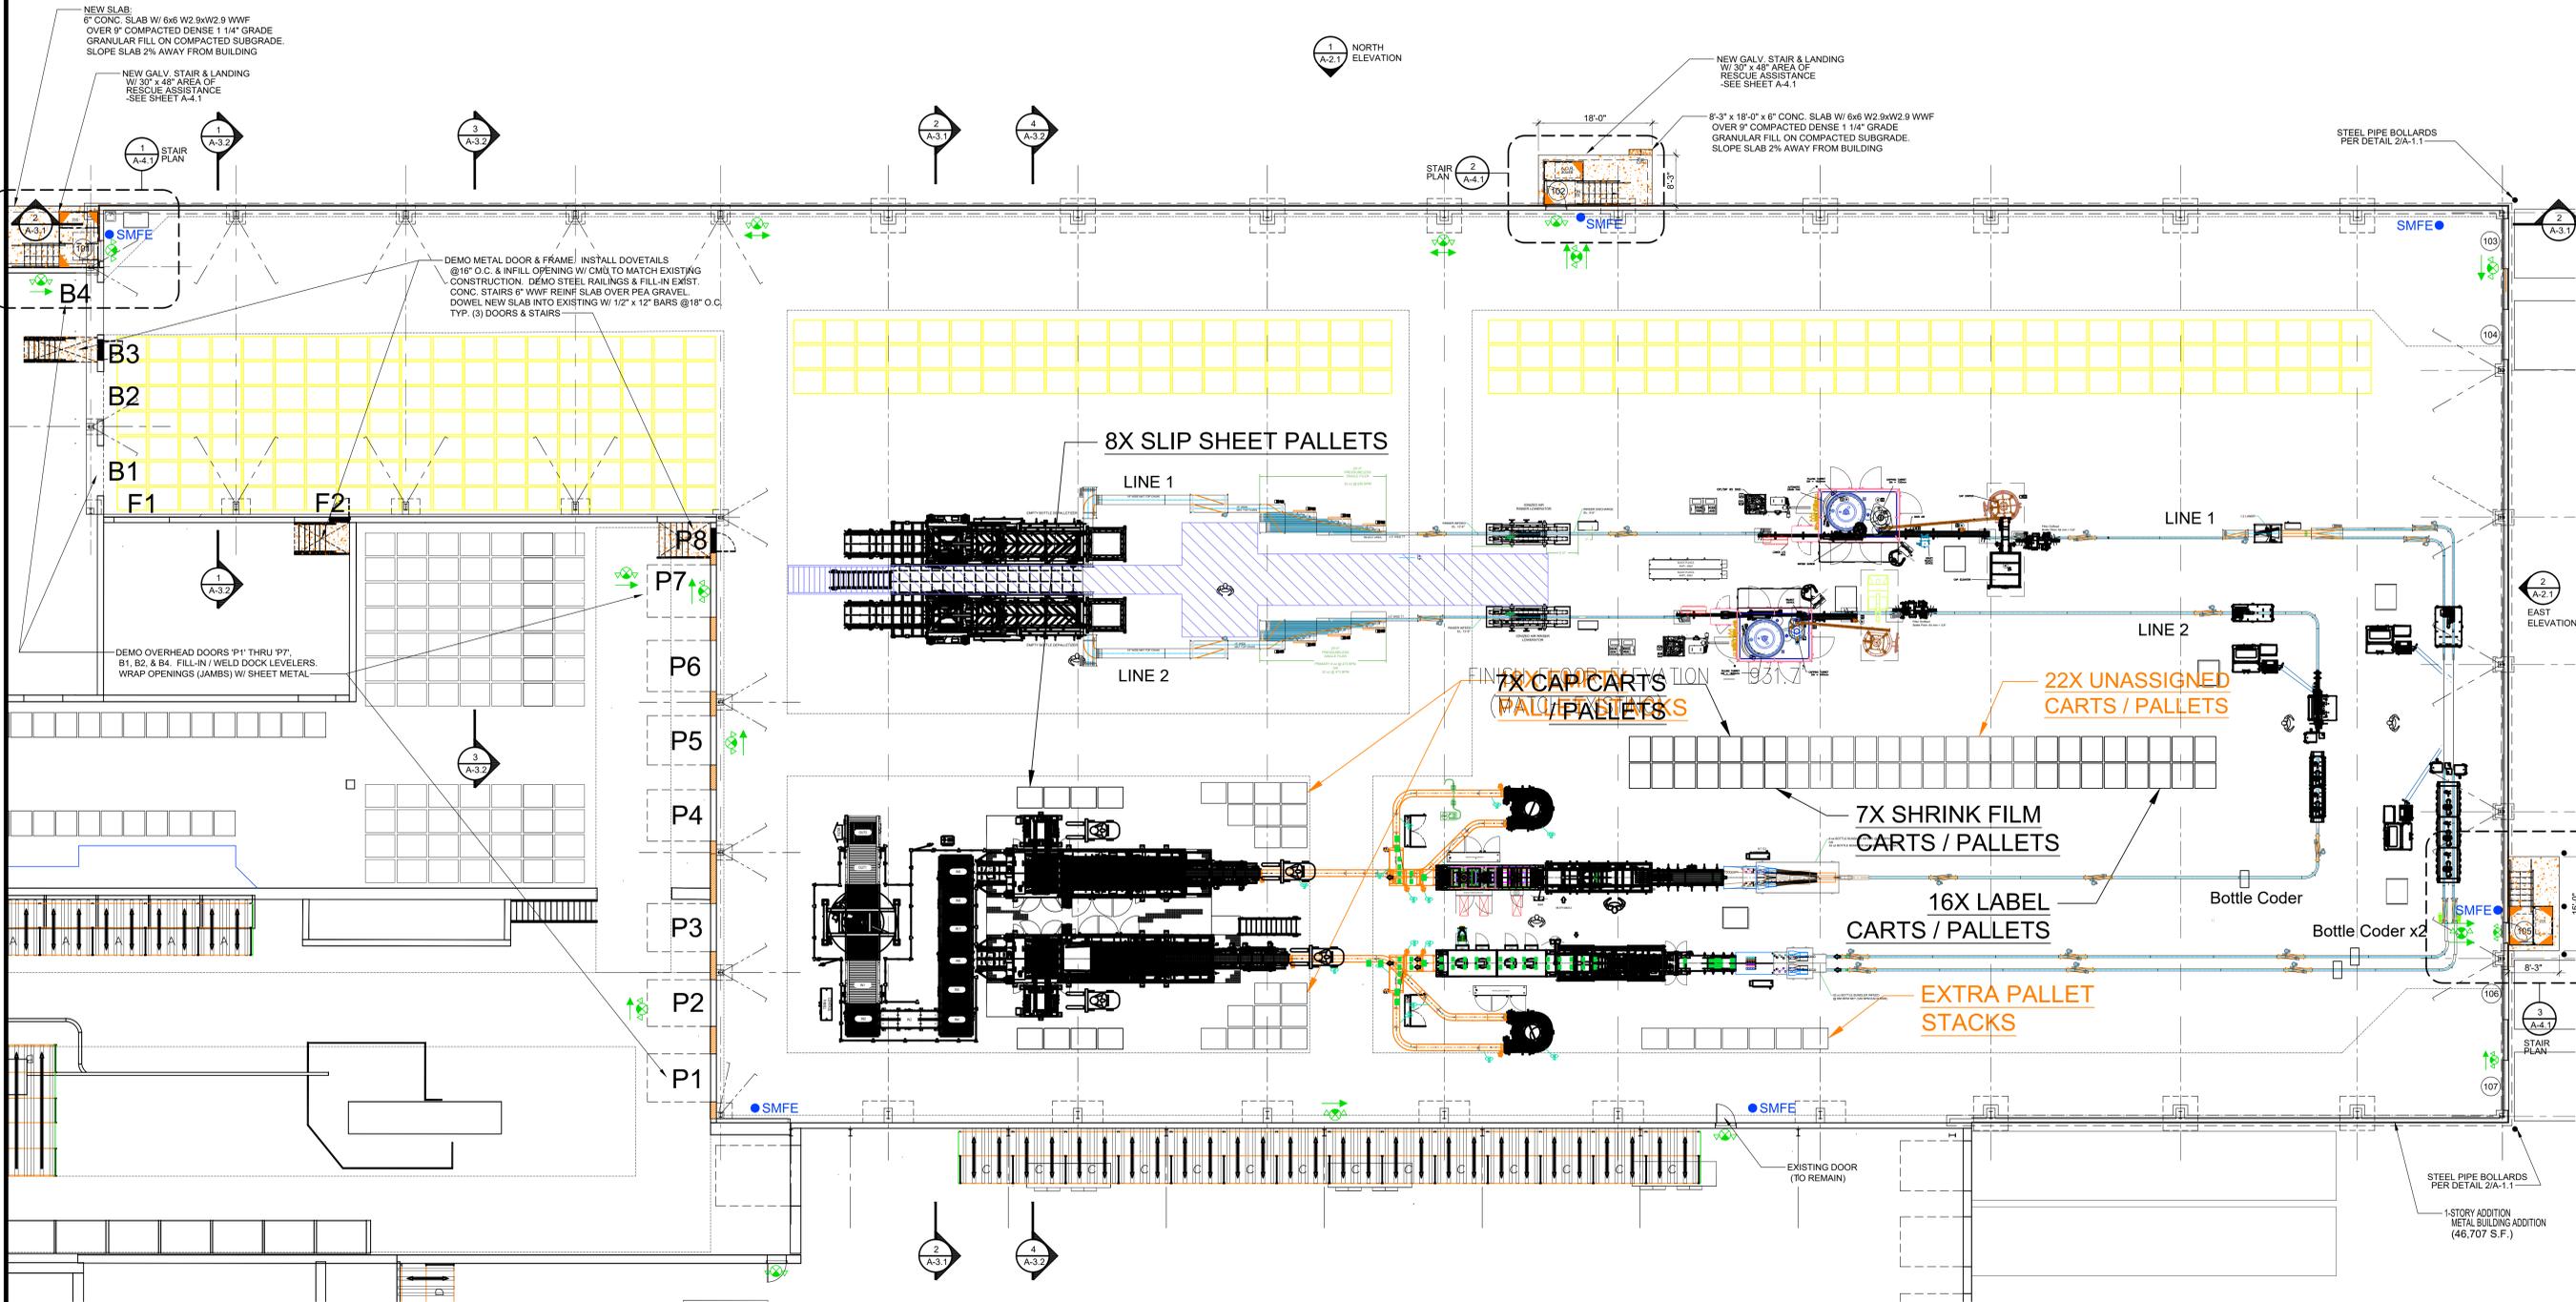


ENLARGED PLAN (ADDITION)
 SCALE: 3/32" = 1'-0"


3 SOUTH ELEVATION

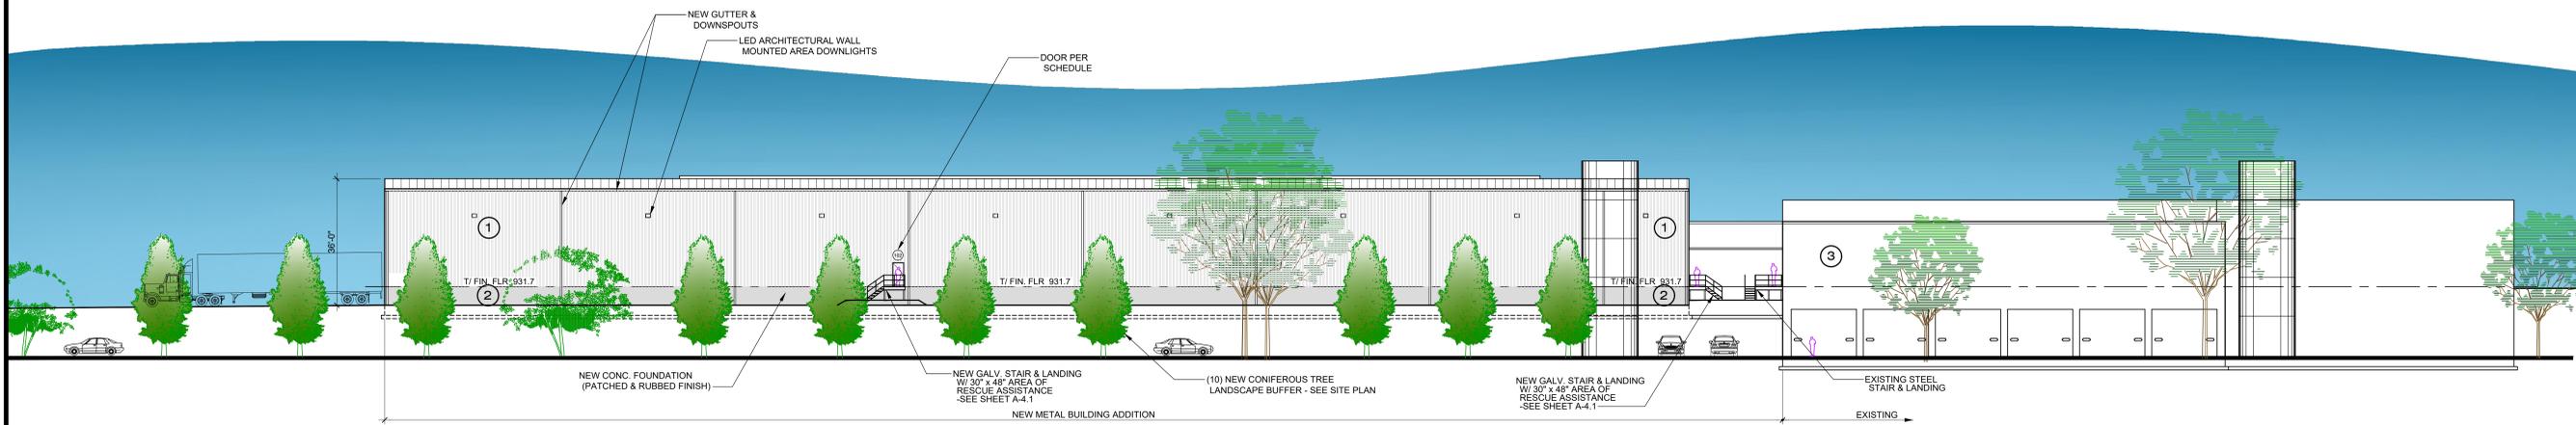

1 NORTH ELEVATION
A-2.1 SCALE: 1" = 20'

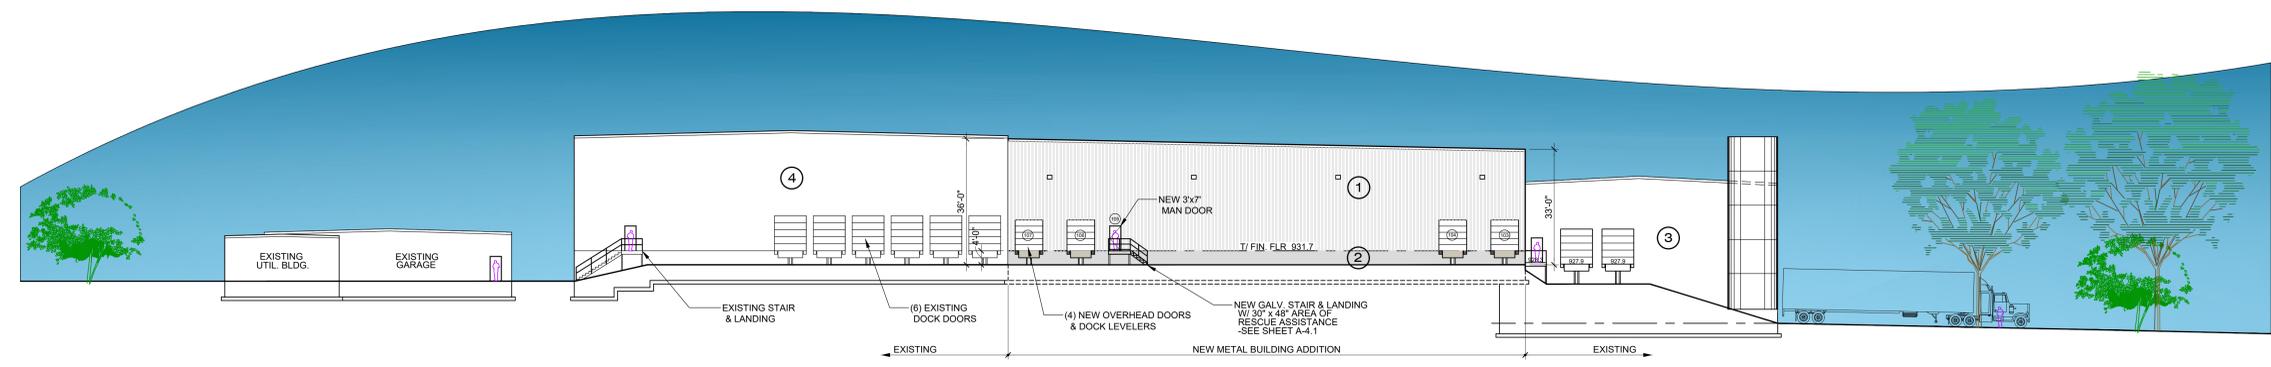

2 EAST ELEVATION
A-2.1 SCALE: 1" = 20'

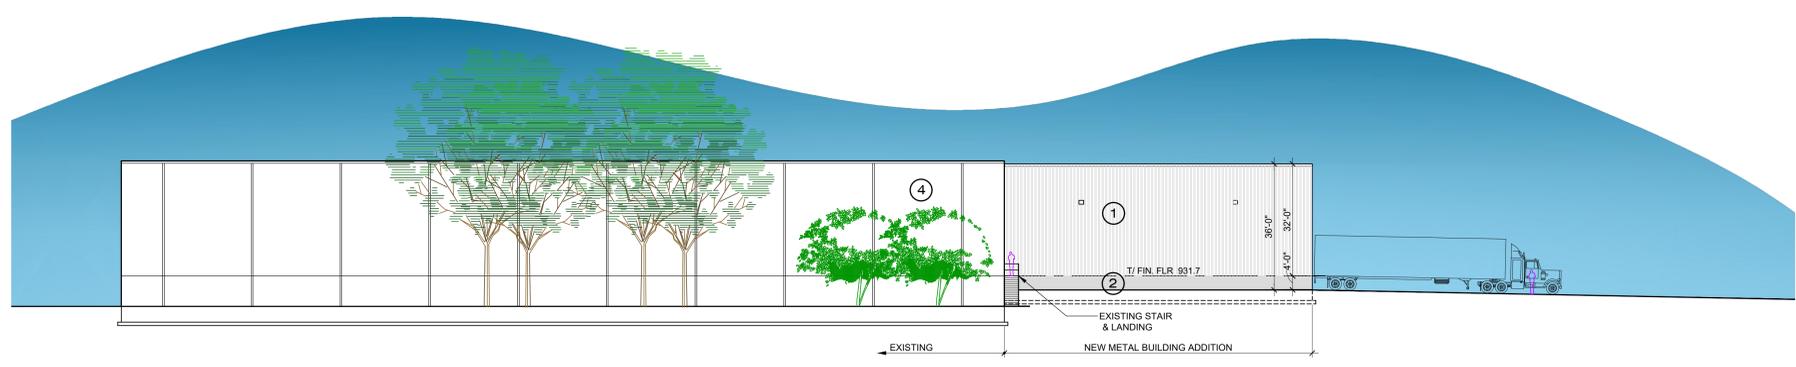

3 PARTIAL SOUTH ELEVATION
A-2.1 SCALE: 1" = 20'

MATERIALS LEGEND:


- ① NEW PBR SIDING (PURLIN BEARING RIB) WALL & ROOFING PANELS COLOR: WHITE TO MATCH EXISTING PLANT
- ② NEW CONCRETE WALL (PATCHED & RUBBED FIN.)
- ③ EXISTING CMU (BLOCK) PAINTED
- ④ EXISTING INSULATED METAL PANEL

NOTE: FINAL METAL BUILDING DRAWINGS TO BE SUBMITTED BY FOREMOST BUILDINGS, INC.

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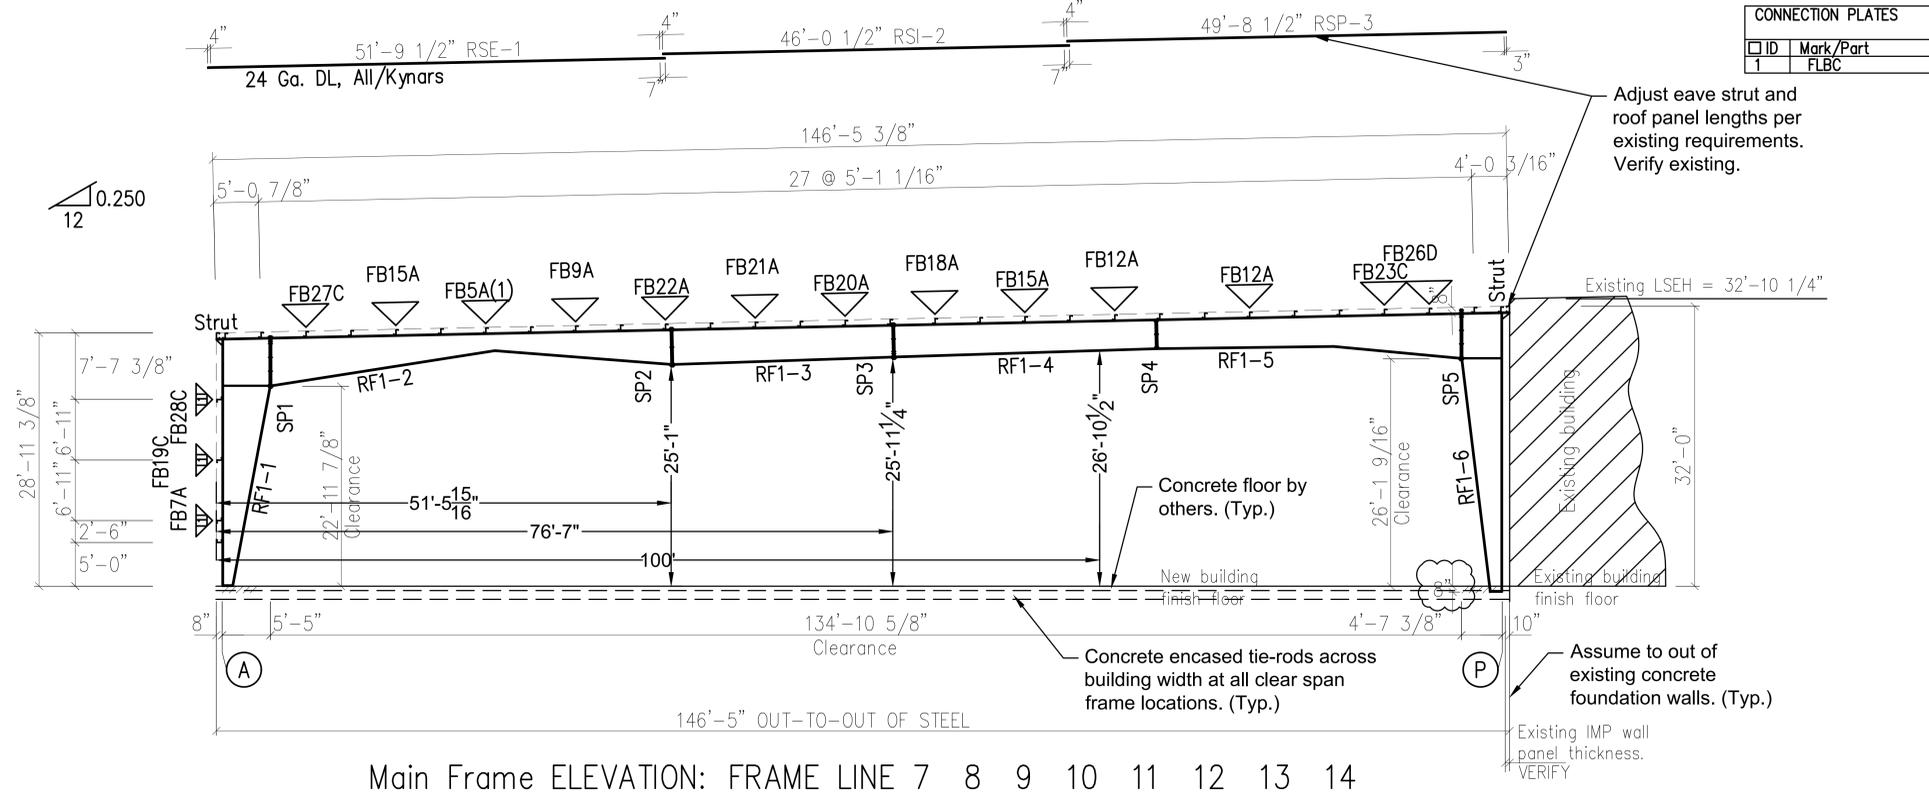


EAST-WEST METAL BUILDING SECTION (LOOKING NORTH)
SCALE: 1/16" = 1'-0"

SPLICE BOLT TABLE							
Mark	Qty	Top	Bot	Int	Type	Dia	Length
SP2	4	4	2	A325	1"	2 1/2"	
SP3	4	8	2	A325	3/4"	2 1/4"	
SP4	2	2	2	A325	3/4"	2"	
SP5	8	4	4	A325	1 1/4"	3"	

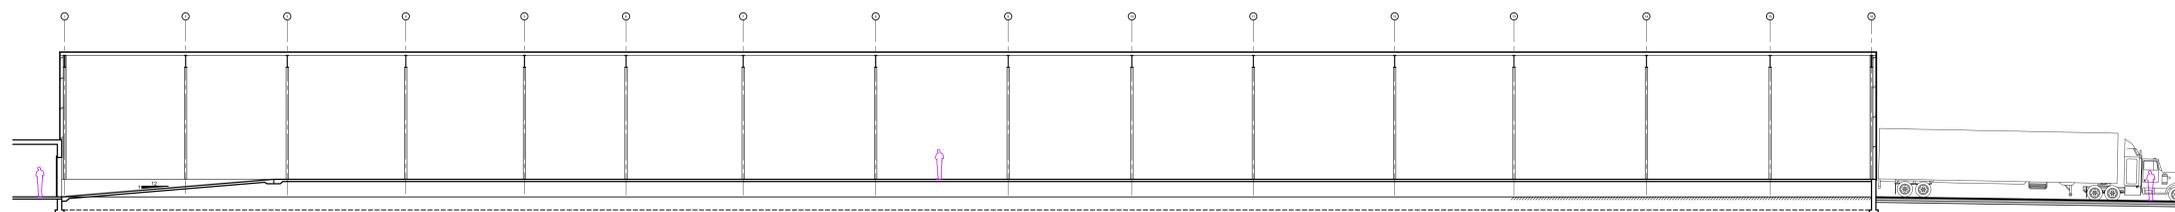FLANGE BRACES: Both Sides(U.N.)
FBxxA(1)
A - L1.5x1/8
C - L2x2x1/8
D - L2.5x3/16

MEMBER TABLE							
Mark	Web Depth		Web Plate		Outside Flange		Inside Flange
	Start	End	Thick	Length	W x Thk	x Length	W x Thk x Length
RF1-1	12.0	35.0	0.224	120.5	8 x 1/4"	x 338.7	8 x 3/4" x 276.7
	35.0	58.1	0.224	120.5	8 x 5/16"	x 72.3	
	58.1	64.0	0.250	30.9			
RF1-2	64.0	64.0	0.313	68.2	8 x 5/16"	x 63.3	8 x 3/4" x 186.9
	64.0	55.1	0.250	64.7	8 x 1/4"	x 241.0	8 x 5/8" x 121.6
	55.1	38.6	0.224	120.5	8 x 1/2"	x 120.5	8 x 1/4" x 241.2
	38.6	22.0	0.179	120.5	8 x 5/8"	x 119.5	
	22.0	34.0	0.179	120.5			
RF1-3	34.0	45.9	0.179	119.5	8 x 3/4"	x 300.0	8 x 5/16" x 120.5
	45.9	46.0	0.224	120.5	8 x 3/8"	x 179.5	
	46.0	44.4	0.224	120.5			
	44.4	42.8	0.224	120.5			
RF1-4	42.8	42.0	0.224	59.0	8 x 3/4"	x 241.0	8 x 3/8" x 120.5
	42.0	40.6	0.224	120.5	8 x 5/16"	x 120.5	8 x 1/4" x 115.2
	40.6	39.3	0.224	120.5	10 x 5/16"	x 120.5	10 x 5/8" x 119.5
RF1-5	39.3	38.0	0.179	115.2	10 x 3/8"	x 174.2	10 x 3/4" x 174.1
	38.0	39.0	0.179	120.5			
	39.0	40.0	0.224	119.5			
RF1-6	40.0	53.9	0.224	120.5	10 x 3/8"	x 64.4	12 x 1" x 198.7
	53.9	60.0	0.250	53.7	12 x 3/8"	x 383.0	
	60.0	54.0	0.375	65.3			
	54.0	44.4	0.224	76.6			
	44.4	29.2	0.224	120.5			
	29.2	14.0	0.224	120.5			



METAL BUILDING SECTION (LOOKING NORTH)
SCALE: 1/8" = 1'-0"

FOREMOST BUILDINGS, INC.				
PROJECT		RIGID FRAME ELEVATION		
ID		DESIGN:	DRAFT:	CHECK:
PROJECT		DATE: 1/15/26	SHEET: 7 OF 10	
ADDRESS		DO NOT SCALE DRAWING	ISSUE: A	



4125 TERMINAL DR.
Suite 100
McFarland, WI 53558

Plotted: Feb. 19, 26


For Permit:
Date: February 19, 2026

Revisions:


BUILDING SECTION

Sheet: A3.1
of: 14


Project No. 4123

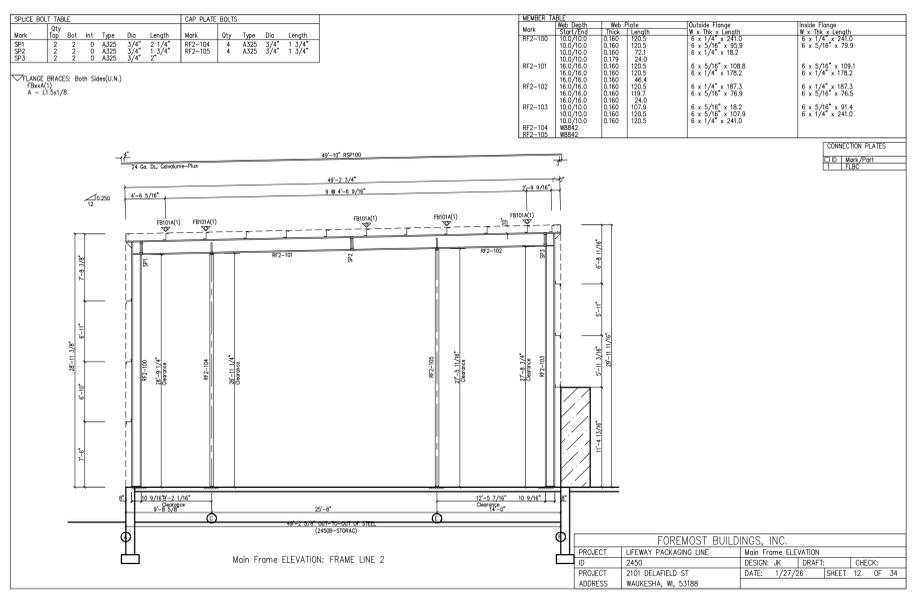


1 NORTH-SOUTH BUILDING SECTION
SCALE: 1/8" = 1'-0"

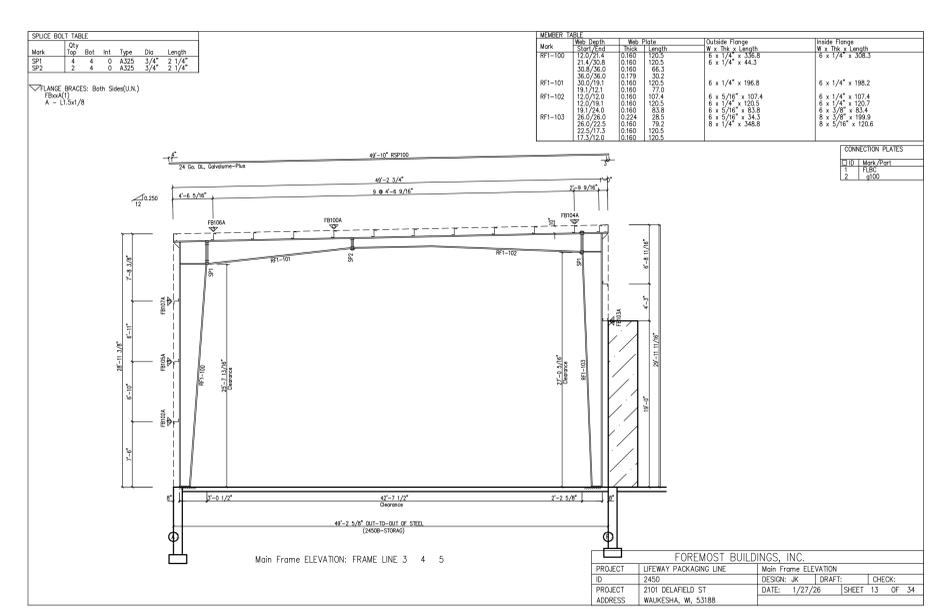

2 NORTH-SOUTH BUILDING SECTION
SCALE: 1/8" = 1'-0"

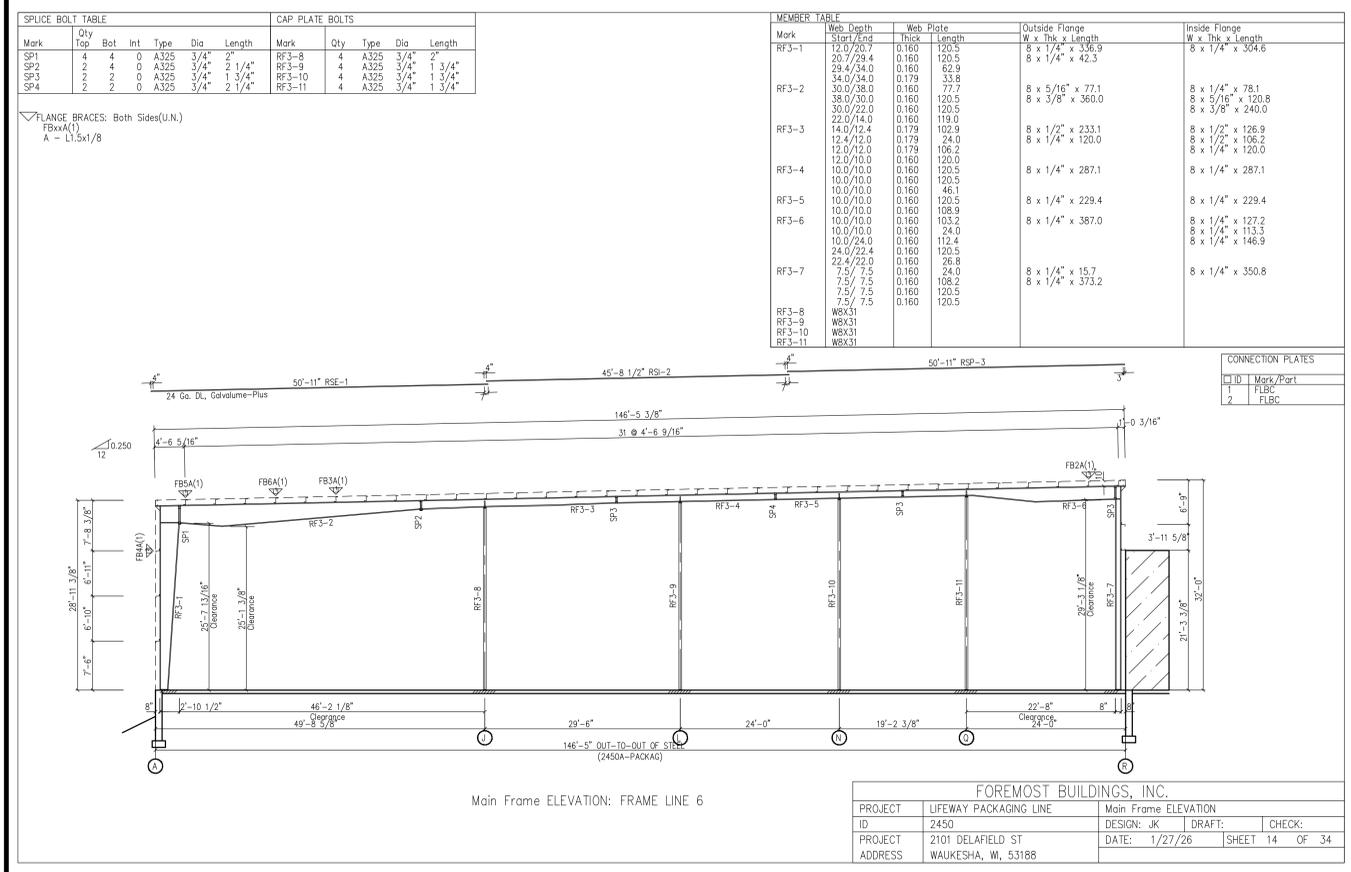


3 NORTH-SOUTH BUILDING SECTION
SCALE: 3/32" = 1'-0"

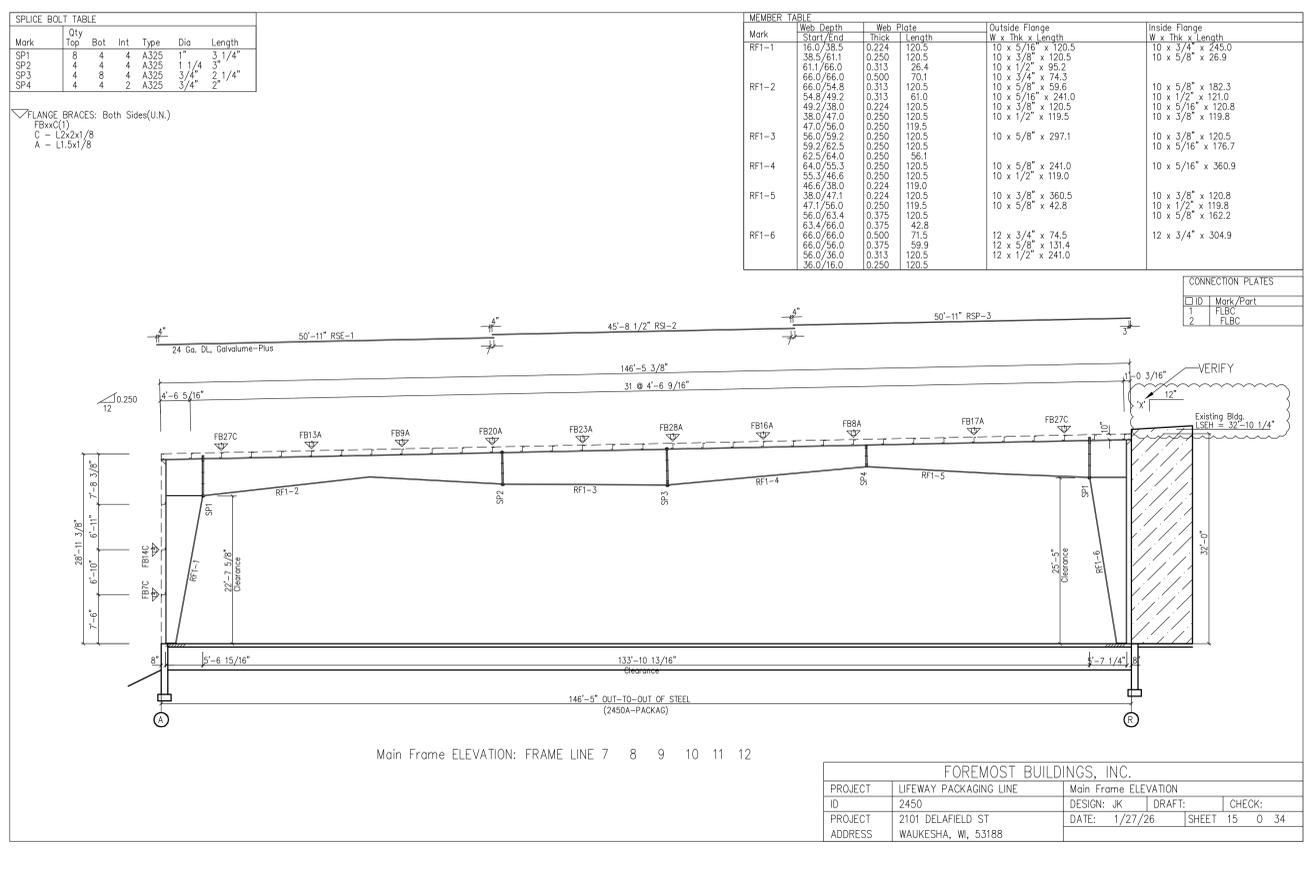


4 NORTH-SOUTH BUILDING SECTION
SCALE: 3/32" = 1'-0"


NOTE: FINAL METAL BUILDING DRAWINGS TO BE SUBMITTED BY FOREMOST BUILDINGS, INC.

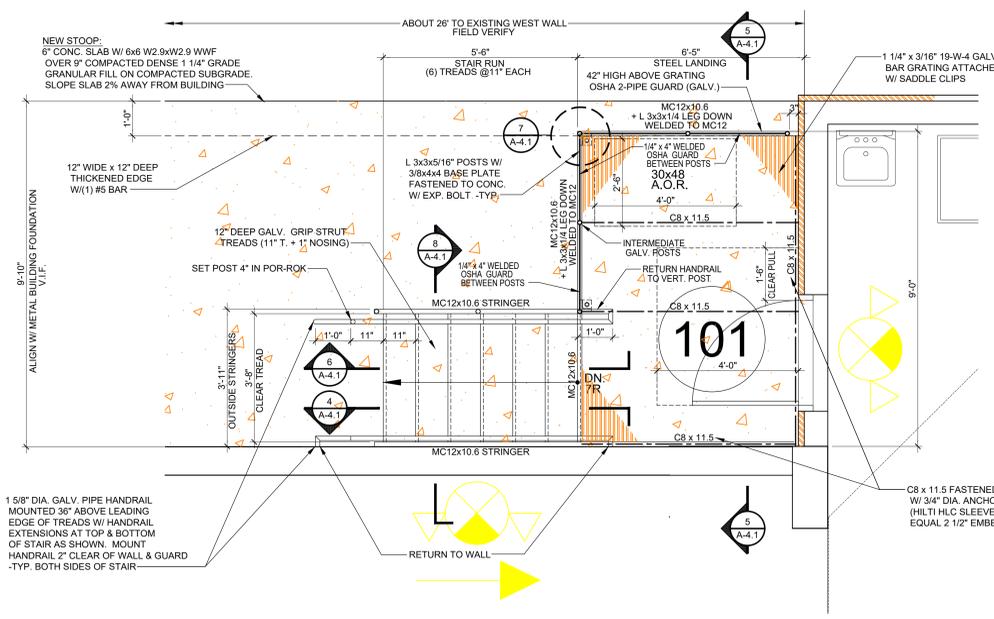


1 ENLARGED STAIR PLAN
SCALE: 1/2" = 1'-0"

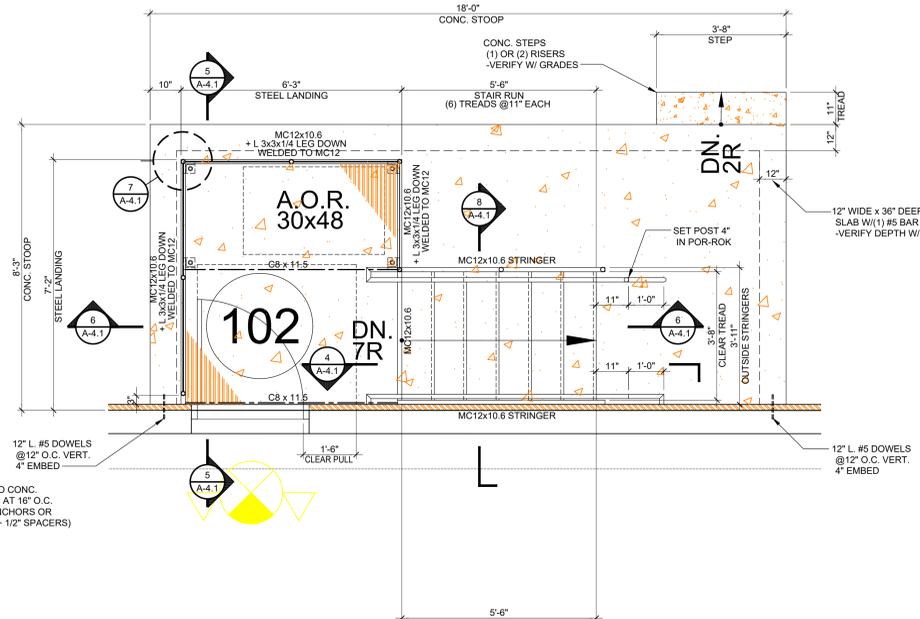


2 ENLARGED STAIR PLAN
SCALE: 1/2" = 1'-0"

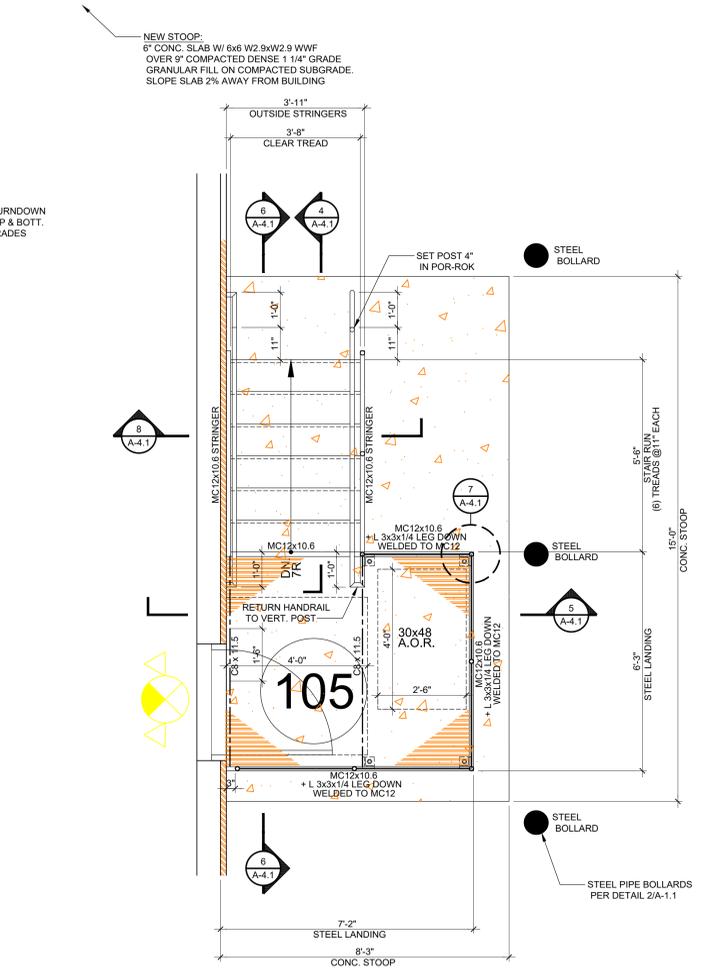


3 ENLARGED STAIR PLAN
SCALE: 1/2" = 1'-0"

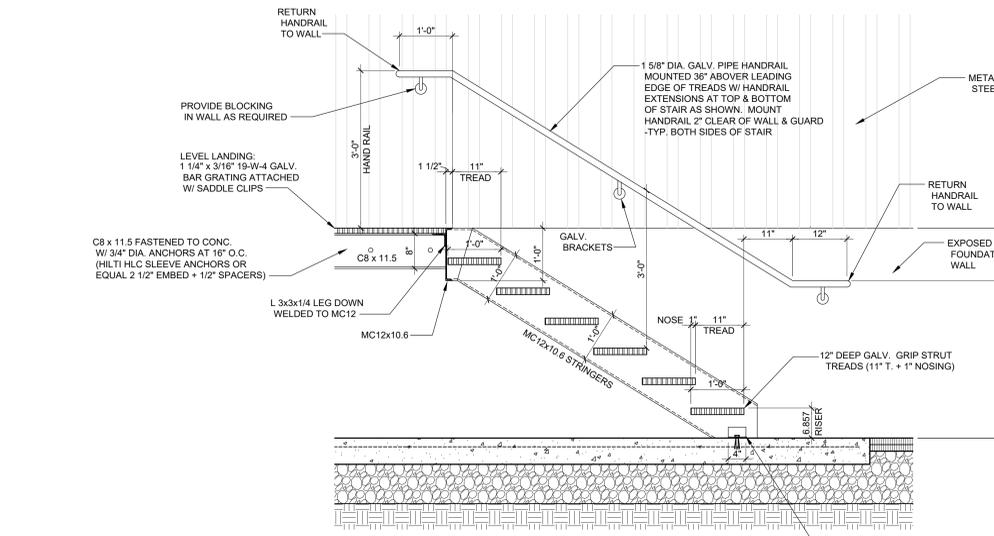


4 STAIR / LANDING DETAIL
SCALE: 3/4" = 1'-0"

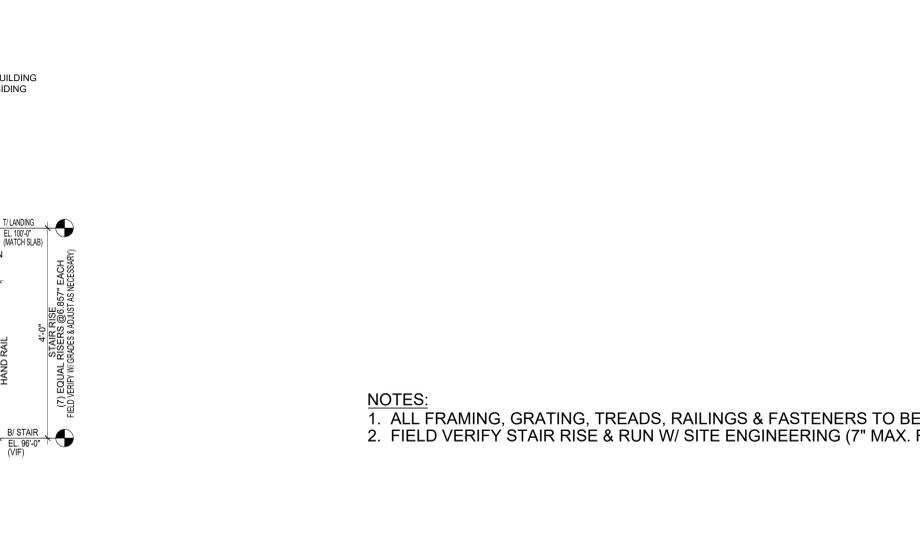


5 STAIR / LANDING DETAIL
SCALE: 3/4" = 1'-0"

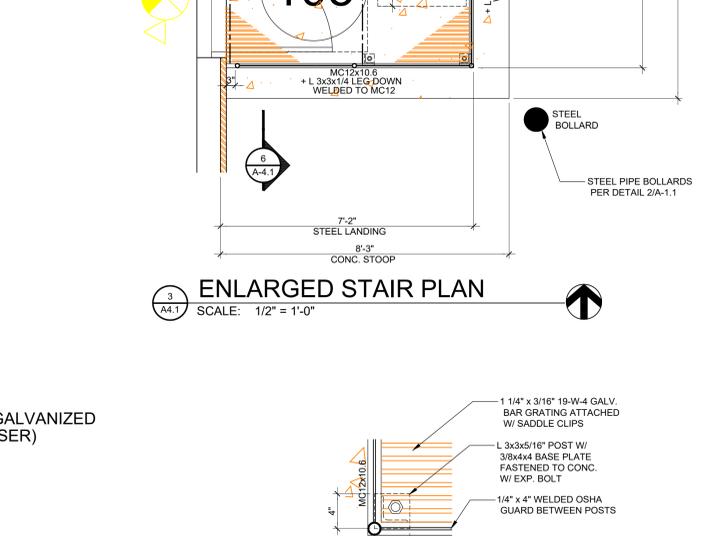


6 STAIR / LANDING DETAIL
SCALE: 3/4" = 1'-0"

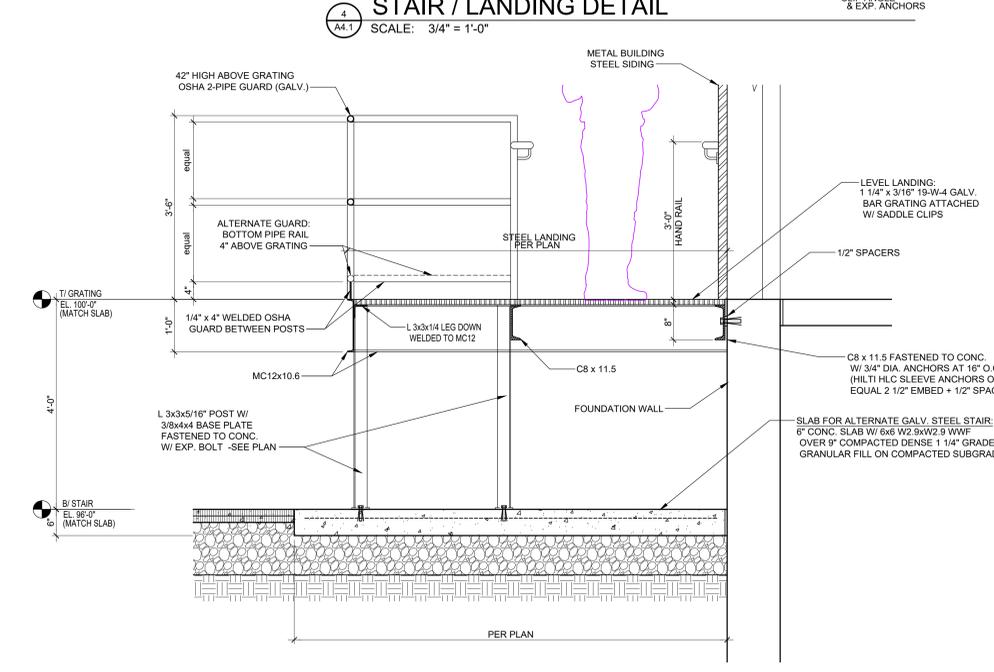

7 STAIR / LANDING DETAIL
SCALE: 3/4" = 1'-0"

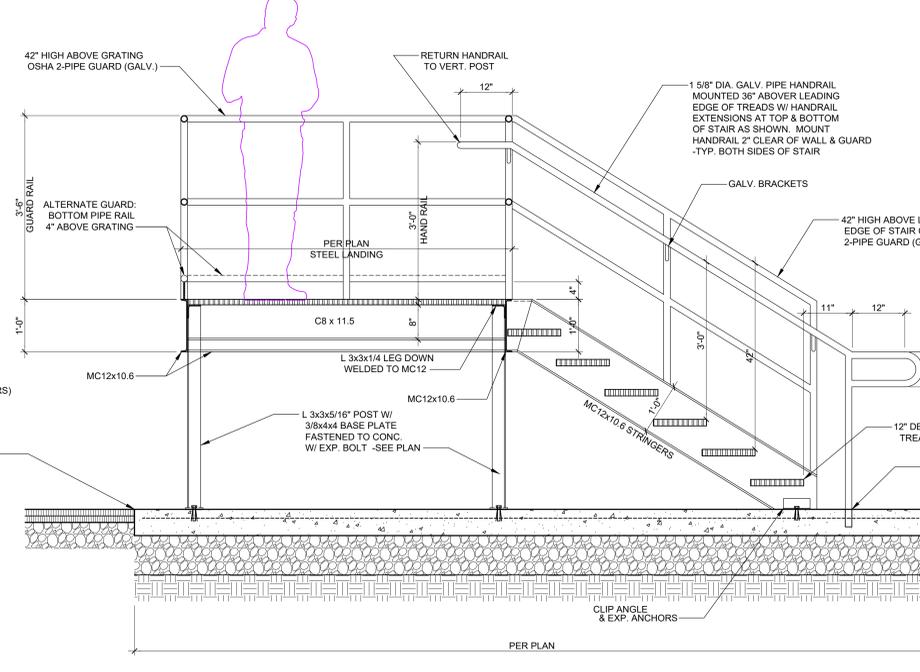


8 STAIR / LANDING DETAIL
SCALE: 3/4" = 1'-0"

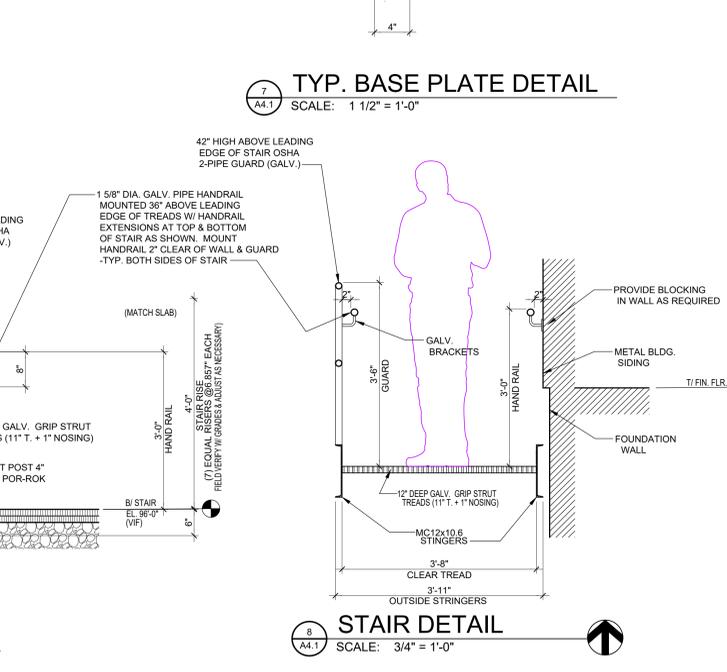

7 TYP. BASE PLATE DETAIL
SCALE: 1 1/2" = 1'-0"



8 STAIR / LANDING DETAIL
SCALE: 3/4" = 1'-0"

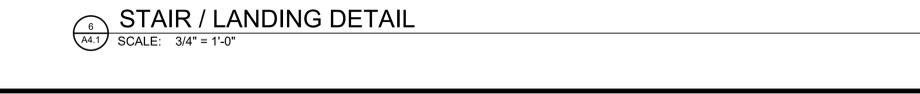

9 STAIR / LANDING DETAIL
SCALE: 3/4" = 1'-0"



8 STAIR DETAIL
SCALE: 3/4" = 1'-0"

NOTES:
1. ALL FRAMING, GRATING, TREADS, RAILINGS & FASTENERS TO BE GALVANIZED
2. FIELD VERIFY STAIR RISE & RUN W/ SITE ENGINEERING (7" MAX. RISER)

NOTE: ALL STAIR & LANDING STEEL TO BE GALVANIZED