- A. ALL FURNITURE AND EQUIPMENT SHOWN ON PLAN TO BE DEMO'D, IS THE RESPONSIBILITY OF THE OWNER TO BE REMOVED AND/OR RELOCATED
- B. WHERE WALLS, CEILING AND/OR PLUMBING FIXTURES ARE TO BE REMOVED; TERMINATE ASSOCATED ELECTRICAL, DATA/PHONE, PLUMBING, HVAC, ETC. TO MOST APPROPRATE POINTS AS DETERMINED IN THE FIELD.
- C. EXISTING HVAC AND FIRE PROTECTION IN AREAS TO BE DEMO'D TO BE MODIFED FOR NEW LAYOUT.

SHEET NOTES - DEMO FLOOR PLAN(S)

NOTE: THESE NOTES APPLY ONLY TO THIS SHEET DESCRIPTION

- 01 DEMOLISH WINDOW AND FRAME SYSTEM IN ENTIRETY DEMOLISH CEDAR BATTENS, HARDI BOARD, AND PLYWOOD SUBSTRATE TO EXPOSE EXISTING INSULATIONA DN STUD FRAMING.
- 03 DEMOLISH DOOR, FRAME AND HARDWARE IN ENTIRETY
- 04 DEMOLISH PLUMBING FIXTURE IN ENTIRETY
- 05 DEMOLISH INTERIOR WALL IN ENTIRETY 06 DEMOLISH EXISTING CASEWORK
- ALTERNATE 1: ALL WORK SHOWN IN BLUE BOUNDRY SHALL BE A1 ASSOCIATED WITH THE DEMOLITION REQUIRED TO EXPAND THE FRONT ENTRY.



DESIGNBUILD

MSI GENERAL CORPORATION W215 E. WISCONSIN AVE. NASHOTAH, WI 53058 262.367.3661 | MSIGENERAL.COM

SINGLE SOURCE RESPONSIBILITY

DESIGNING EXCELLENCE. BUILDING TRUST TM MILESTONE ISSUE DATES PRELIMINARY SET: 05/05/2025 BUDGET SET: 06/03/2025 CAL DESIGN REVIEW SET: ROPOSAL SET: RMIT SET: ONSTRUCTION SET:

REVISIONS:



EMERGENCY24

2021 SPRINGDALE RD

WAUKESHA, WISCONSIN 53186

ALL WORK TO BE COMPLETED AS SHOWN, AND IN ACCORDANCE WITH THE LATEST EDITION OF THE MSI GENERAL MASTER SPECIFICATION


CIVIL ENGINEER: REVIEWED BY

AMH

FIRST FLOOR DEMOLITION PLAN

AD-111

PROJECT NUMBER: P13689

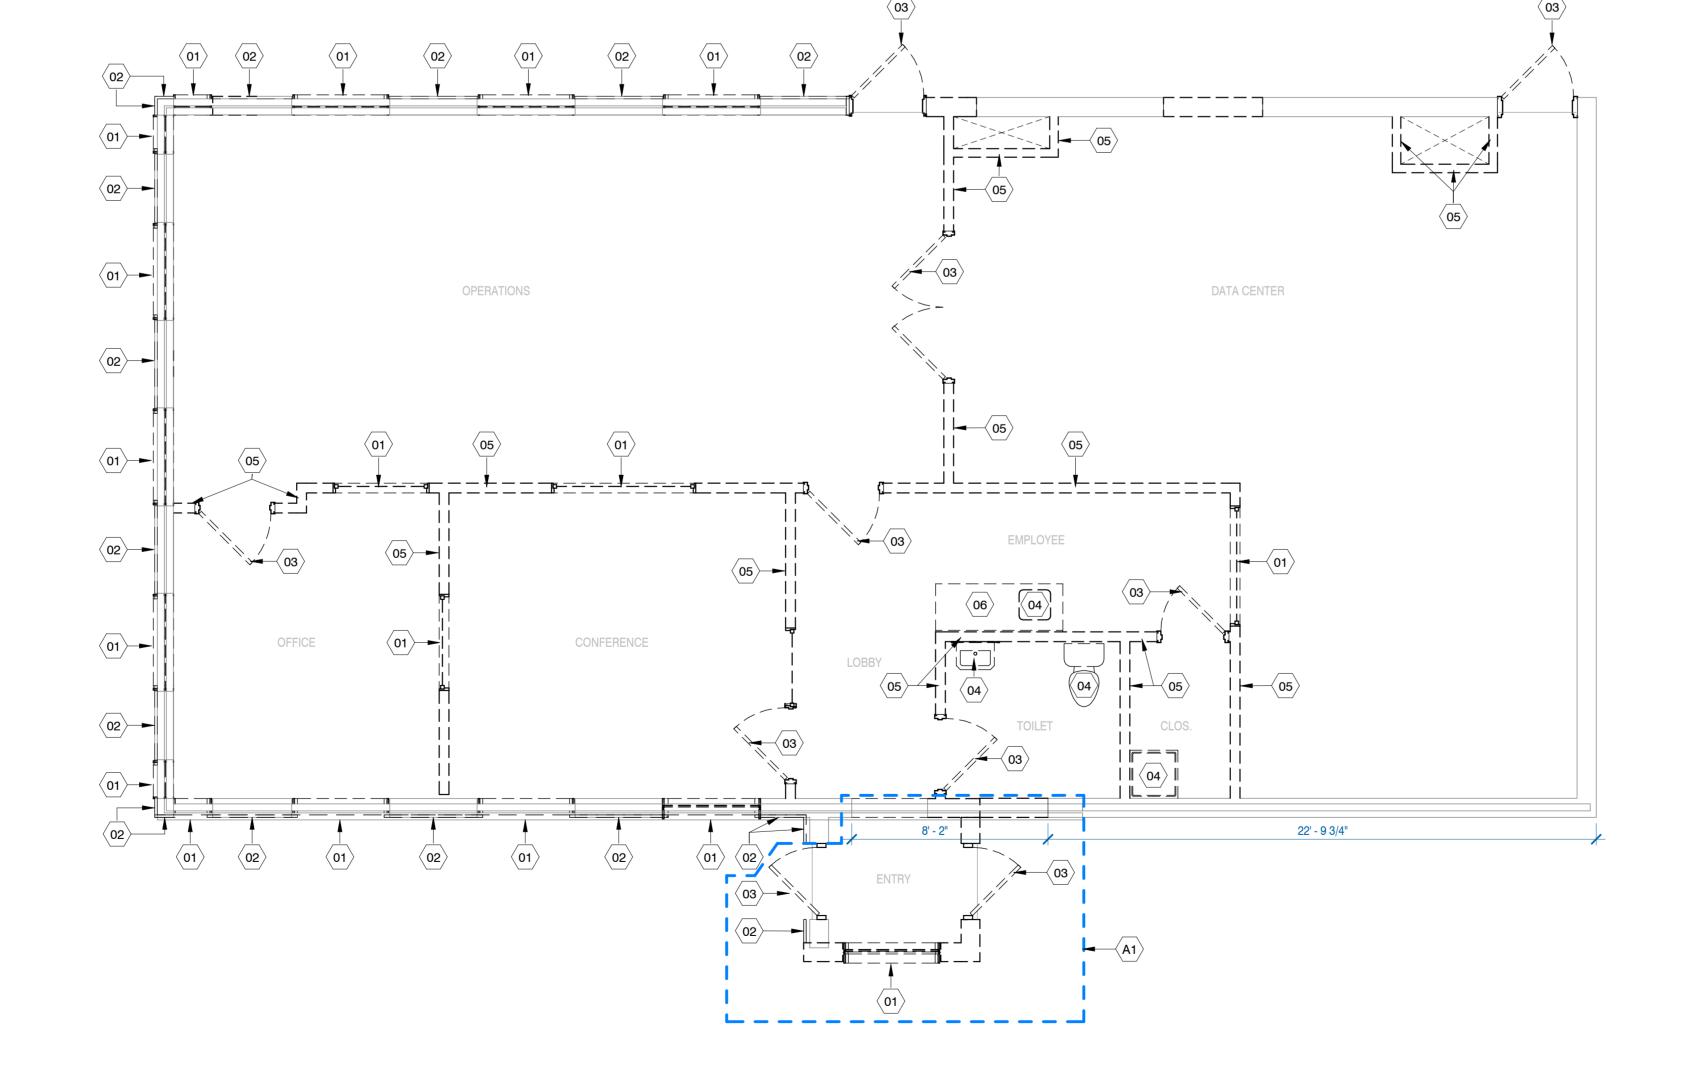

MSI GENERAL CORPORATION

REVISIONS:

ш


ENGINE

ALL WORK TO BE COMPLETED AS SHOWN, AND

CIVIL ENGINEER: REVIEWED BY AMH

SHEET NUMBER: A-111

P13689

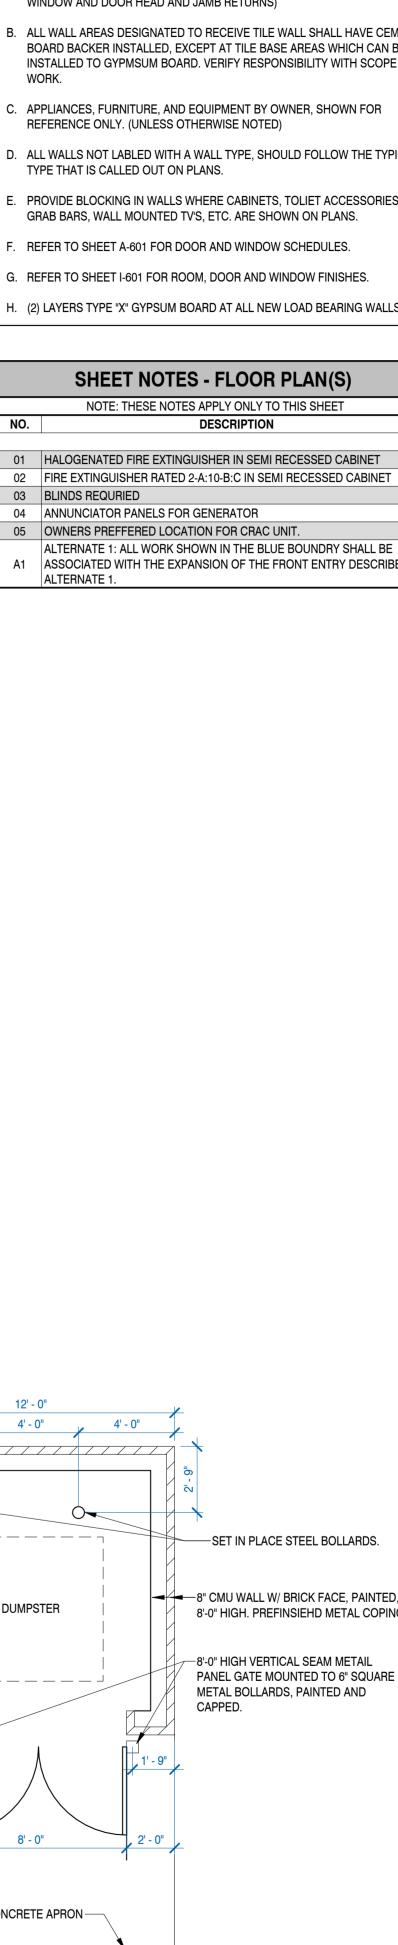

2 A-201

-SET IN PLACE STEEL BOLLARDS. 8" CMU WALL W/ BRICK FACE, PAINTED, DUMPSTER 8'-0" HIGH. PREFINSIEHD METAL COPING HEAD. 8'-0" HIGH VERTICAL SEAM METAIL PANEL GATE MOUNTED TO 6" SQUARE METAL BOLLARDS, PAINTED AND —CONCRETE APRON—


NOTE SEE CIVIL PLANS FOR LOCATION

4' - 0"

DUMPSTER ENCLOSURE

1/4" = 1'-0"



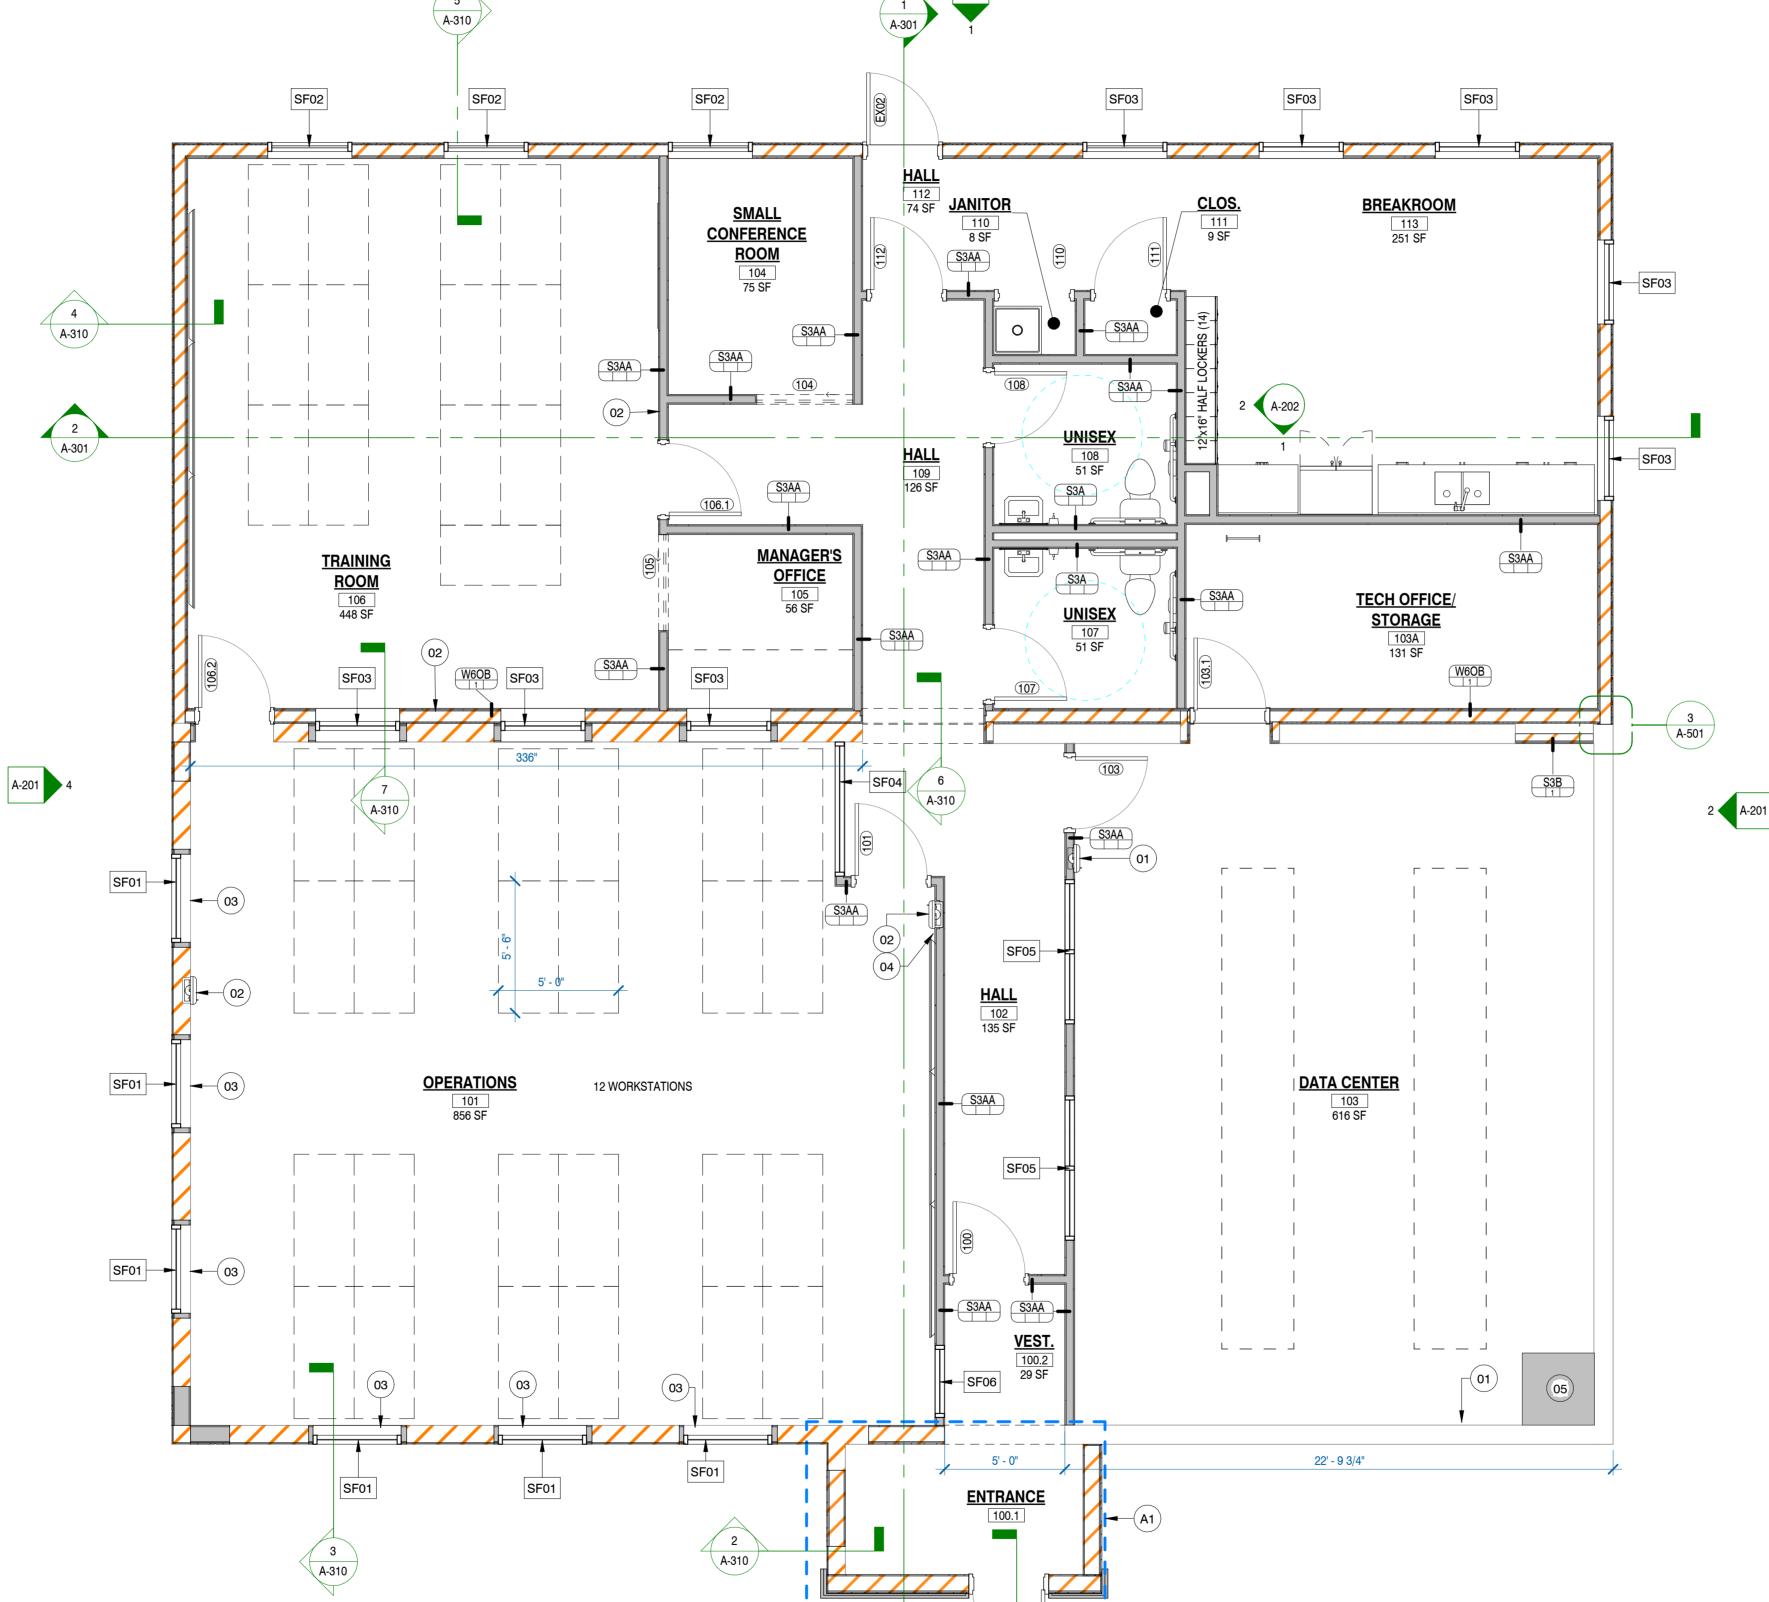

FIRST FLOOR PLAN

1/4" = 1'-0"

. MOISTURE RESISTANT GWB AT ALL LOCATIONS EXPOSED TO MOISTURE (BATHROOMS, JANITOR/PLUMING ROOMS, KITCHENS, ETC. AND EXTERIOR

WINDOW AND DOOR HEAD AND JAMB RETURNS) B. ALL WALL AREAS DESIGNATED TO RECEIVE TILE WALL SHALL HAVE CEMENT

GENERAL NOTES - FLOOR PLAN(S)

BOARD BACKER INSTALLED, EXCEPT AT TILE BASE AREAS WHICH CAN BE INSTALLED TO GYPMSUM BOARD. VERIFY RESPONSIBILITY WITH SCOPE OF

C. APPLIANCES, FURNITURE, AND EQUIPMENT BY OWNER, SHOWN FOR REFERENCE ONLY. (UNLESS OTHERWISE NOTED)

D. ALL WALLS NOT LABLED WITH A WALL TYPE, SHOULD FOLLOW THE TYPICAL

PROVIDE BLOCKING IN WALLS WHERE CABINETS, TOLIET ACCESSORIES, GRAB BARS, WALL MOUNTED TV'S, ETC. ARE SHOWN ON PLANS.

F. REFER TO SHEET A-601 FOR DOOR AND WINDOW SCHEDULES.

G. REFER TO SHEET I-601 FOR ROOM, DOOR AND WINDOW FINISHES.

H. (2) LAYERS TYPE "X" GYPSUM BOARD AT ALL NEW LOAD BEARING WALLS.

SHEET NOTES - FLOOR PLAN(S) NOTE: THESE NOTES APPLY ONLY TO THIS SHEET DESCRIPTION 01 HALOGENATED FIRE EXTINGUISHER IN SEMI RECESSED CABINET

05 OWNERS PREFFERED LOCATION FOR CRAC UNIT. ALTERNATE 1: ALL WORK SHOWN IN THE BLUE BOUNDRY SHALL BE A1 ASSOCIATED WITH THE EXPANSION OF THE FRONT ENTRY DESCRIBED IN

EMERGENCY24

PROJECT DESCRIPTION ADDITION

2021 SPRINGDALE RD

WAUKESHA, WISCONSIN 53186

IN ACCORDANCE WITH THE LATEST EDITION OF THE MSI GENERAL MASTER SPECIFICATION LANDSCAPE DESIGN

FIRST FLOOR PLAN

P13689

LEADERS

ENGINEER

CONTRACTORS

ARCHITECT

P13689

SINGLE SOURCE RESPONSIBILITY

DESIGNING EXCELLENCE. BUILDING TRUST TM MILESTONE ISSUE DATES PRELIMINARY SET: 05/05/2025 06/03/2025 BUDGET SET: CAL DESIGN REVIEW SET:

REVISIONS:

NSTRUCTION SET:

MIT SET:

GENERAL NOTES - EXT. ELEVATION(S)

SHEET NOTES - EXT. ELEVATIONS

NOTE: THESE NOTES APPLY ONLY TO THIS SHEET

1" TEMPERED GLASS STOREFRONT SYSTEM. LOWER GLAZING TO
03 RECIEVE FRIT AND BURGLER RESISTANT FILM, UPPER GLAZING TO BE

CONCRETE FOOTING AND FOUNDATION, SEE STRUCTURAL PLANS FOR

LP SMARTSIDE SMOOTH FACE PANEL SYSTEM OR APPROVED EQUAL WITH 1/2 PREFINISHED METAL TRIM SYSTEM REVEALS

13 PREFINISHED METAL CAP OVER PRESSURE TREATED BLOCKING.

19 SEE STRUCTRUAL FOR CMU FOUNDATION WALL AND CONCRETE FOOTING.

14 GATE MOUNTED TO SQUARE METAL BOLLARD, PAINTED.

PREFINISHED VERTICAL SEAM METAL SIDING WITH PREFINSIHED METAL

01 CLASS A FIRE RETARADANT DIMENSIONAL ASPHALT SHINGLE

02 PREFINSIHED BREAK METAL FASCIA AND GUTTER

04 HOLLOW METAL DOOR AND FRAME

08 BACKLIT SIGNAGE BY OWNER. 09 PREFINSIHED METAL AWNING

15 BRICK FASCADE, PAINTED

18 5" CONCRETE SLAB AND APRON

10 EXISTING EXTERIOR WALL TO BE PAINTED

11 NEW CLASS A FIRE RETARDANT FLAT ROOF 12 VERTICAL SEAM METAL GATE AND LOCK

16 MESH WEEPS AND FLASHING AT BRICK BASE.

17 HALF COURSE CMU EXPOSED AT BASE, PAINTED.

DESCRIPTION

A. FOOTINGS ON ELEVATIOSN ARE REPRESENATIVE ONLY (SEE STRUCTURAL PLANS FOR FOOTING ELEVATIONS)

B. XXX

IN ACCORDANCE WITH THE LATEST EDITION OF THE MSI GENERAL MASTER SPECIFICATION

CIVIL ENGINEER: REVIEWED BY


AMH

EXTERIOR ELEVAITONS


SHEET NUMBER: A-201


PROJECT NUMBER:
P13689



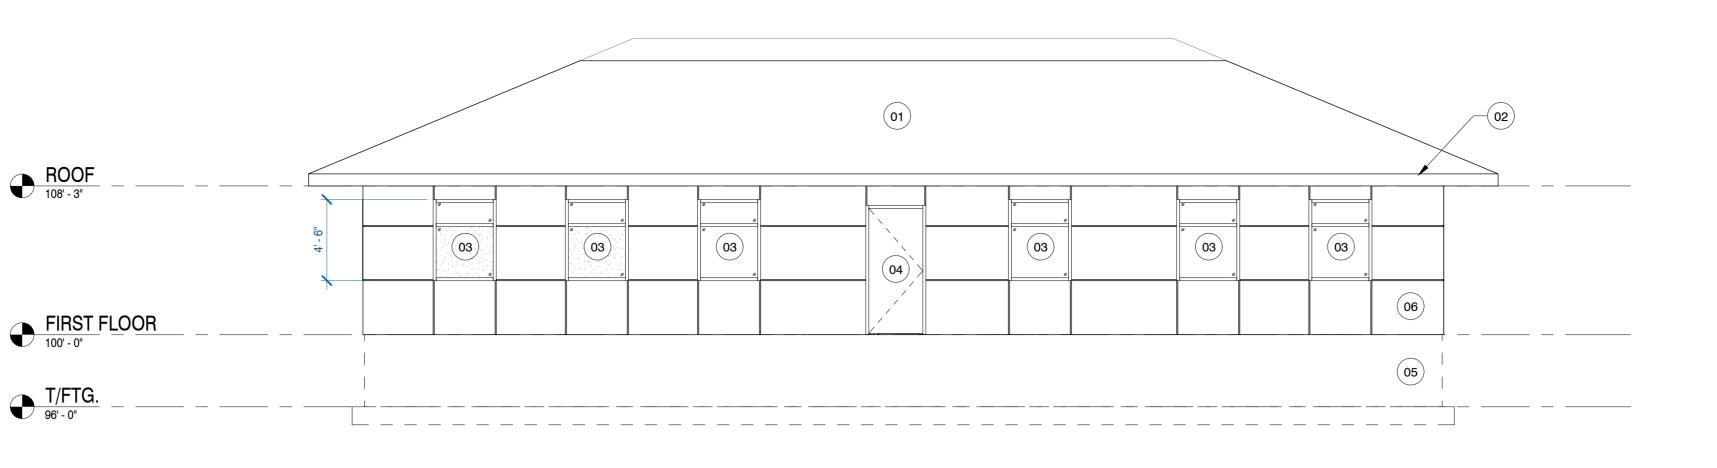


NORTH ELEVATION 3/16" = 1'-0"

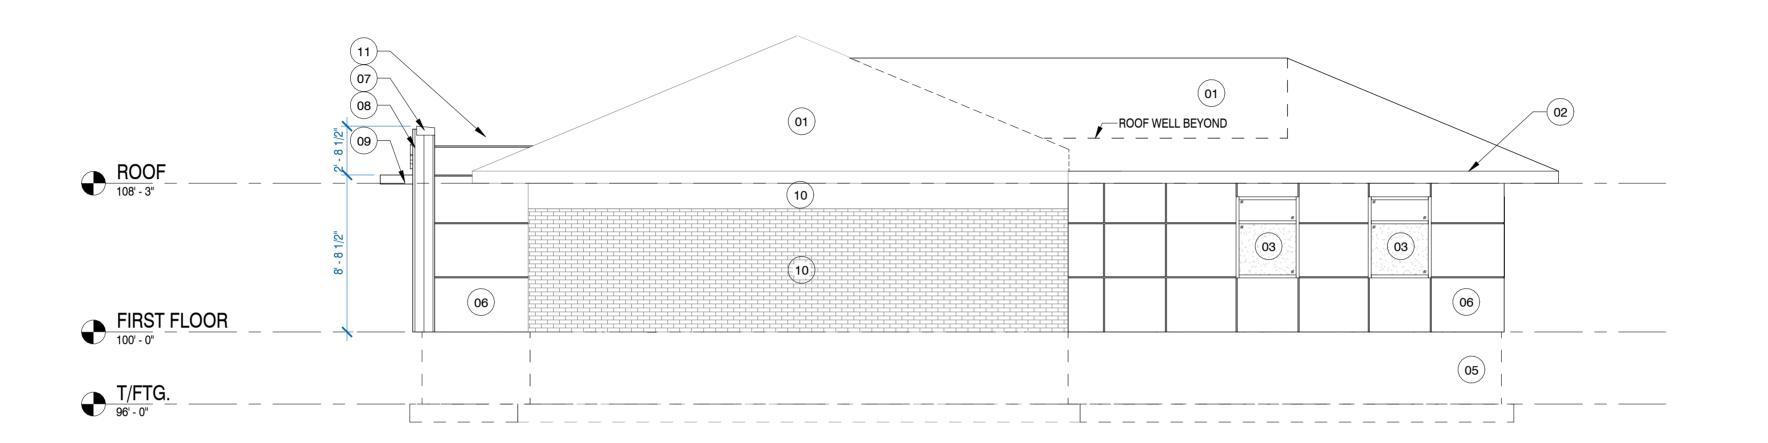

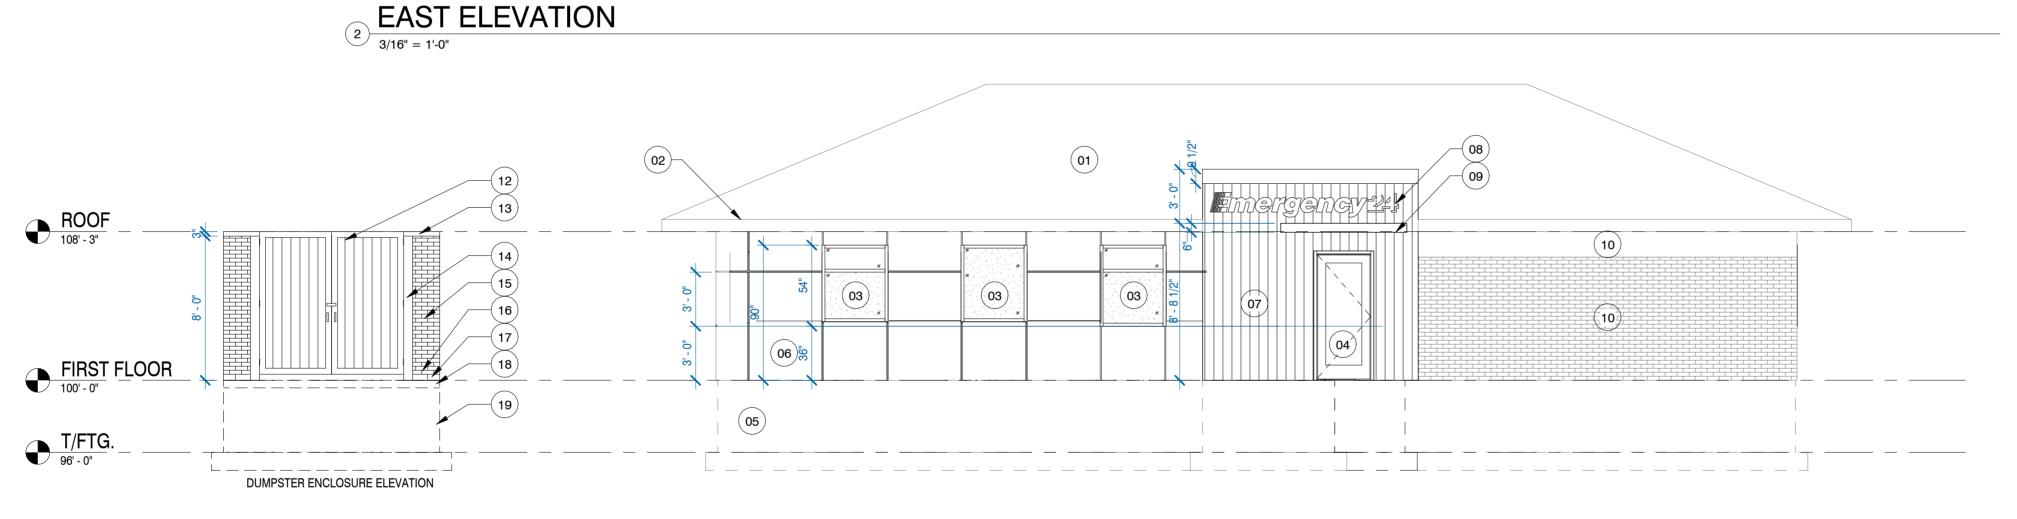

3 SOUTH ELEVATION 3/16" = 1'-0"

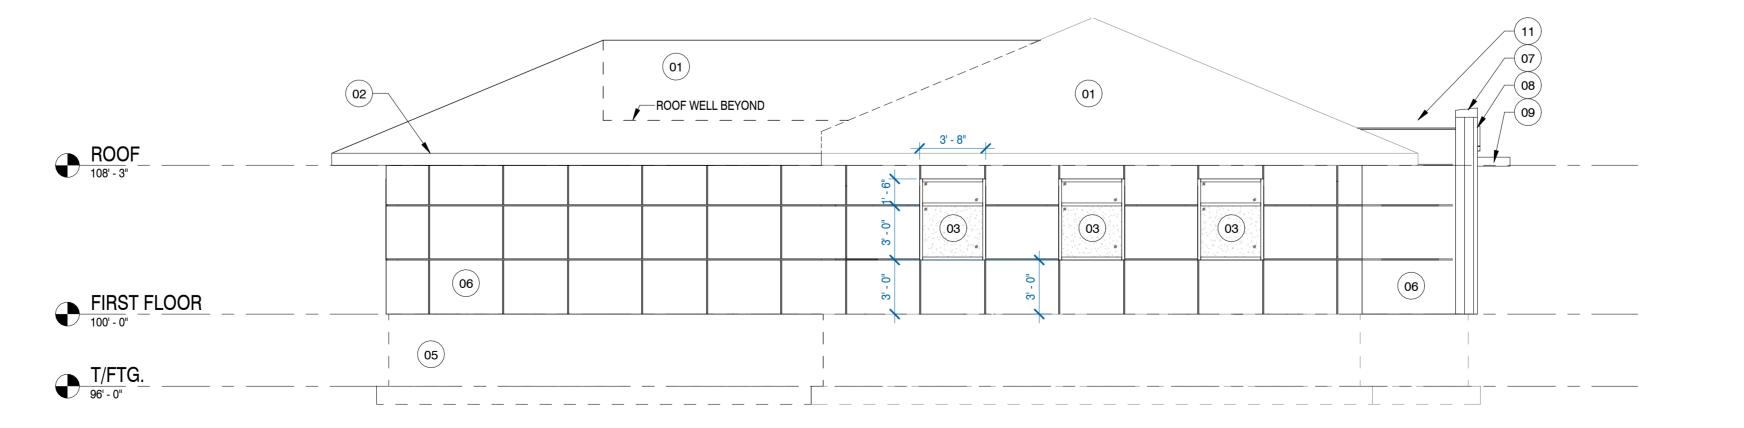

ENGINEER

CONTRACTORS

ARCHITECTS

POSAL SET: NSTRUCTION SET:

SHEET NOTES - FLOOR PLAN(S)

NOTE: THESE NOTES APPLY ONLY TO THIS SHEET

DESCRIPTION

REVISIONS:

EMERGENCY24

PROJECT DESCRIPTION ADDITION

2021 SPRINGDALE RD

WAUKESHA, WISCONSIN 53186


ALL WORK TO BE COMPLETED AS SHOWN, AND IN ACCORDANCE WITH THE LATEST EDITION OF THE MSI GENERAL MASTER SPECIFICATION

STRUCTURAL ENGINEER DJS CIVIL ENGINEER: REVIEWED BY

AMH

ROOF PLAN

A-141

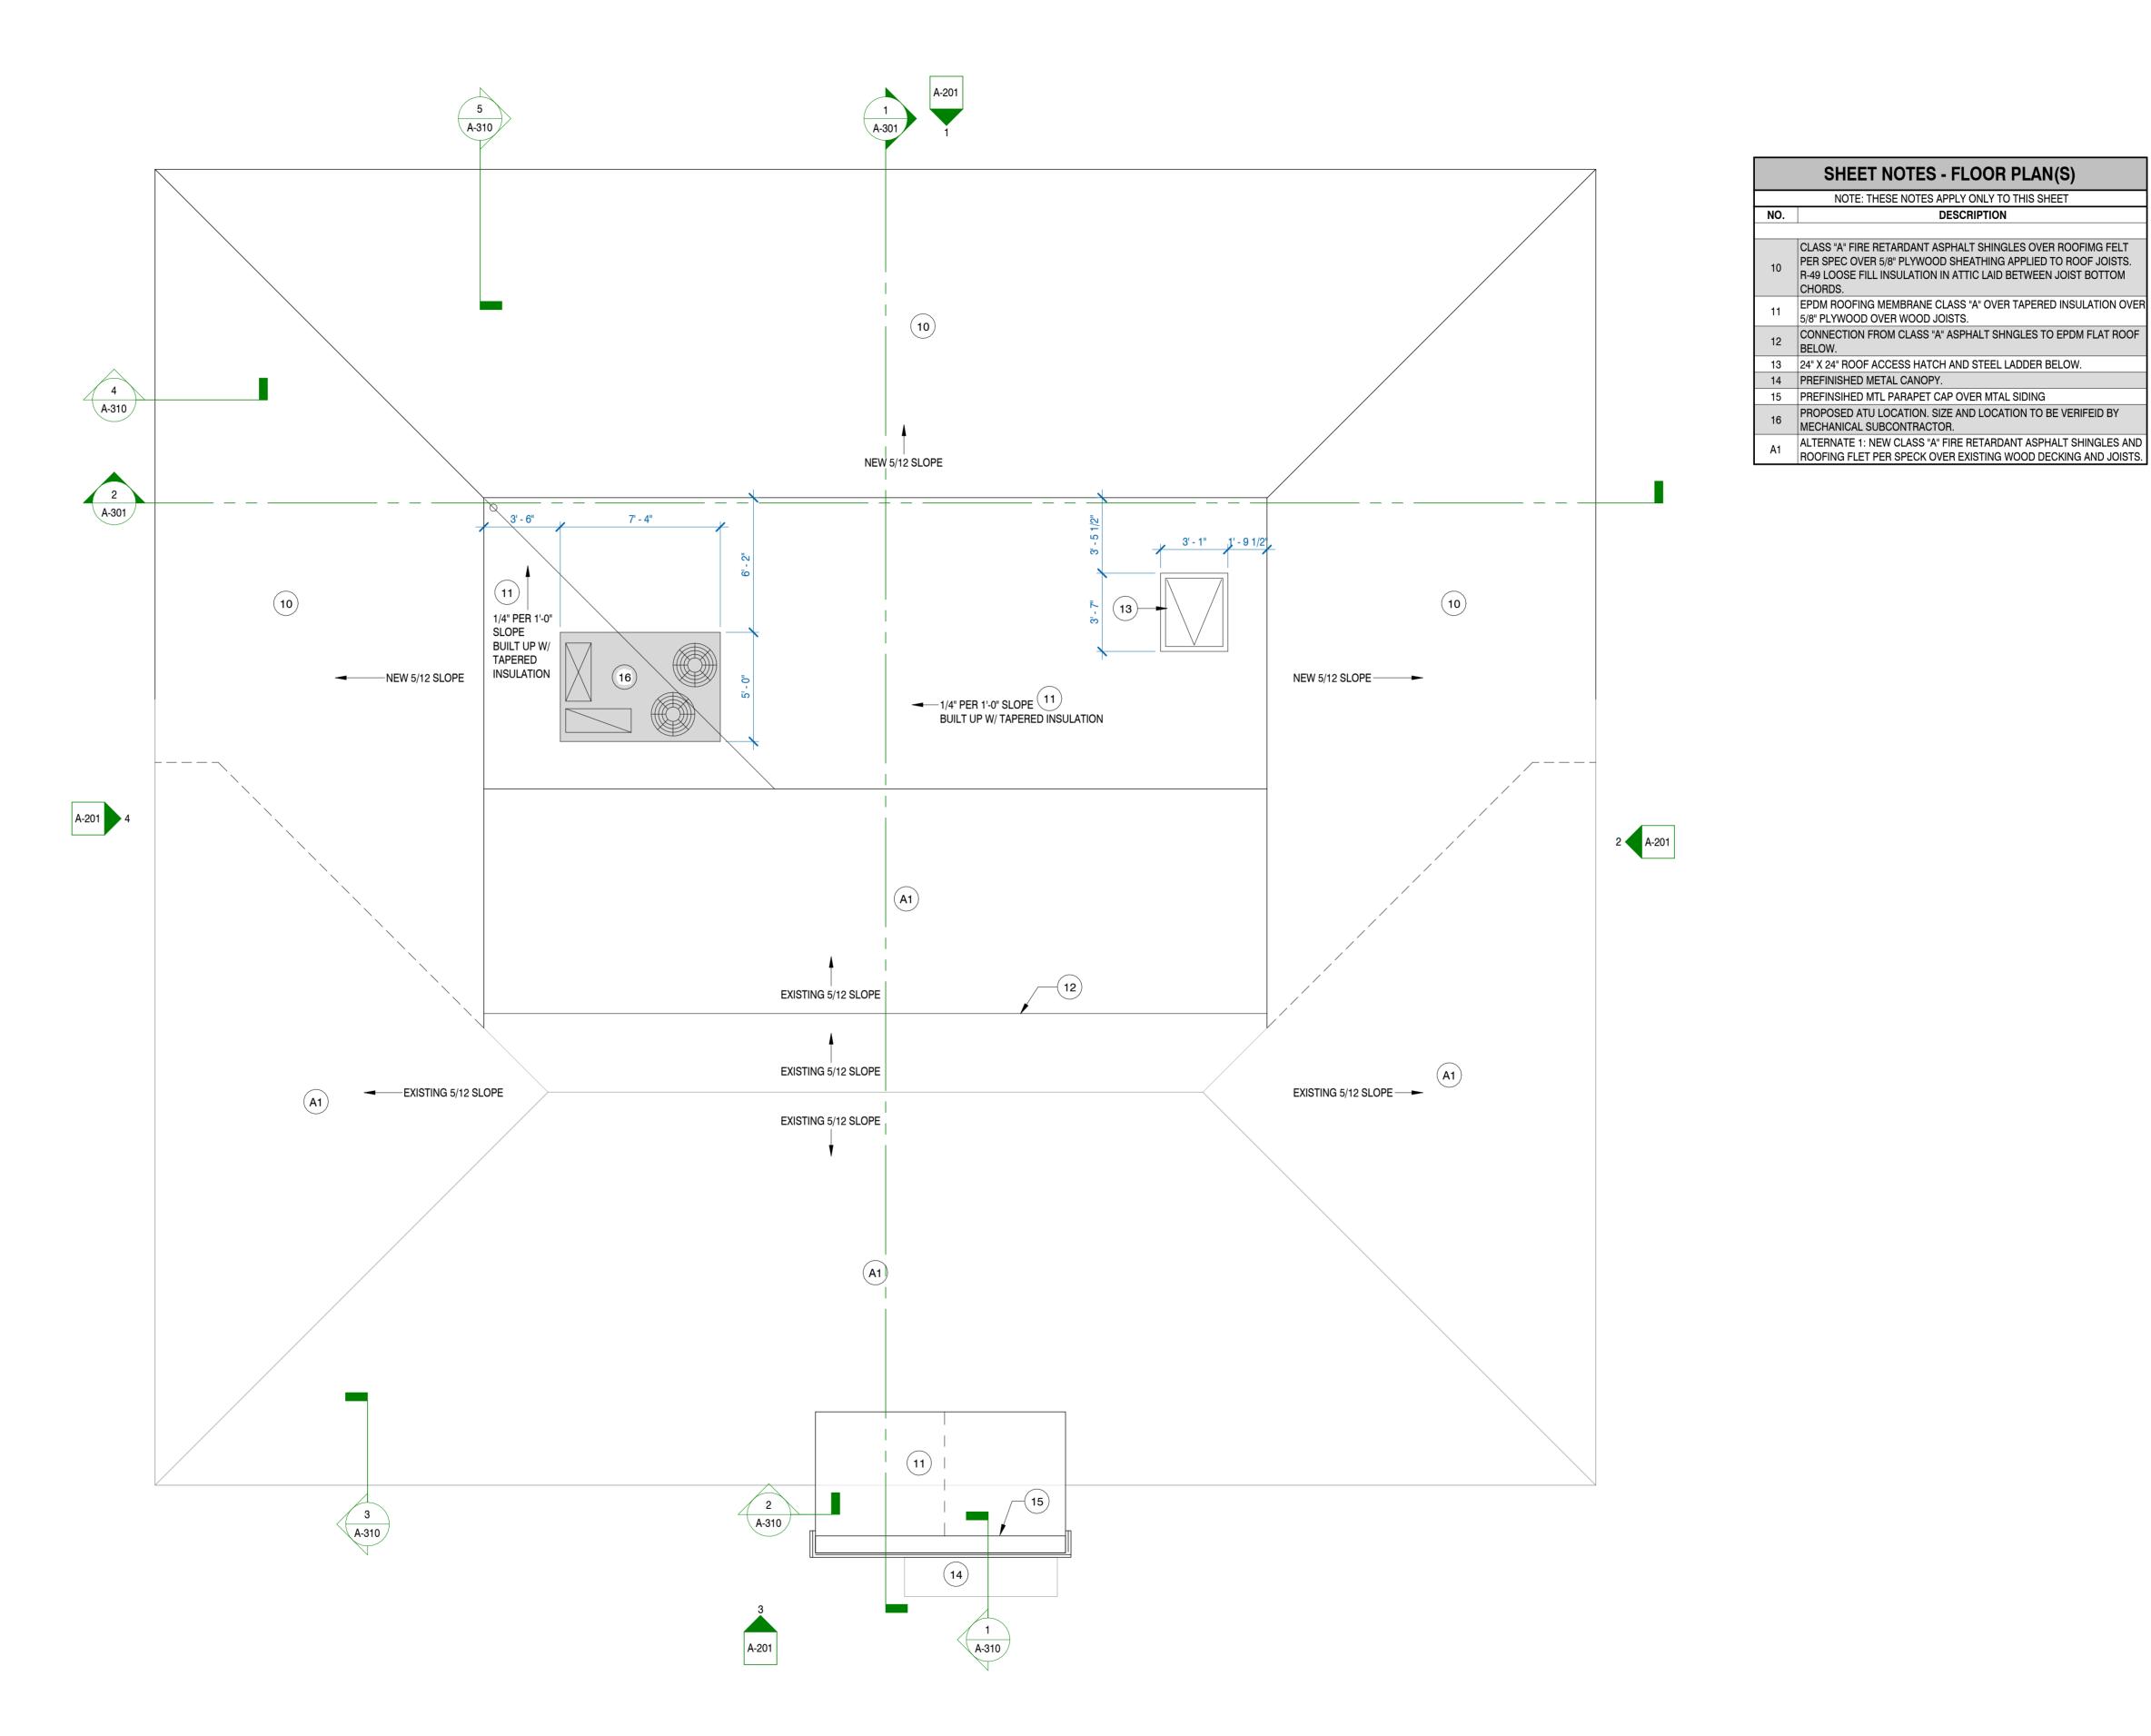

1) ROOF PLAN
1/4" = 1'-0"